



VA NORTHERN CALIFORNIA HEALTH CARE SYSTEM

Design of Building 650 Elevator Replacement

DVA Project No. 612A4-12-211

MEI Project No. 114

100% CD Documents

June 14, 2013

ABBREVIATIONS

A	And	I.D.	Inside Diameter
∠	Angle	INC.	Incandescent
@	At	INFO.	Information
⊕	Centerline	INSUL.	Insulation
Ø	Diameter		Interior
#	Pound or Number	INT.	Joint
(E)	Existing		
(N)	New	KIT.	Kitchen
(RL)	Relocated Existing		
A.B.	Anchor Bolt	LAB.	Laboratory
ACOUST.	Acoustical	LAM.	Laminate
ADD.	Additional	LAT.	Light
ADJ.	Adjustable	MAT.	Material
A.F.F.	Above Finished Floor	MAX.	Maximum
A.P.	Access Panel	M.D.F.	Medium Density Fiberboard
ARCH.	Architectural	MECH.	Mechanical
		MET.	Metal
		MFR.	Manufacturer
BD.	Board	MIN.	Minimum
BKG.	Backing	MISC.	Miscellaneous
BLDG.	Building	MR.	Magnetic Resonance
BLK.	Block	MTO.	Imaging
BKG.	Block		Mounted
BM.	Beam		
BOT.	Bottom	N.	North
CAB.	Cabinet	N.I.C.	Not In Contract
CEM.	Cement	NO. or #	Number
CER.	Ceramic	NOM.	Nominal
C.G.	Corner Guard	N.R.	Non Rated
C.J.	Construction Joint	N.T.S.	Not To Scale
C.L.G.	Ceiling	O.A.	Overall
C.L.O.	Close	O.C.	On Center
C.L.R.	Clear	O.D.	Outside Diameter
CNTR.	Counter	O.F.D.	Over Flow Drain
C.O.	Cased Opening	OFF.	Office
COL.	Column	O.H.	Opposite Hand
CONC.	Concrete	OPRG.	Opening
CONSTR.	Construction	OPP.	Opposite
CONT.	Continuous	O.F.C.I	Owner Furnished Contractor Installed
CORR.	Corridor		
CPT.	Carpet	PL	Plate
CTR.	Center	P. LAM.	Plastic Laminate
CTSK.	Countersunk	PLYWD.	Plywood
		PR.	Print
DET.	Detail	P.T.D.	Paper Towel Dispenser
DIA.	Diameter	PTN.	Partition
DM.	Dimension	QTY.	Quantity
DISP.	Dispenser	RAD.	Radius
DN.	Down	R.D.	Roof Drain
DR.	Door	REF.	Reference
DVA	Department of Veterans Affairs	REFR.	Refrigerator
DW	Domestic Water	RF	Radio Frequency
DWG.	Drawing	RGR.	Register
DS	Downspout	REINF.	Reinforced
E	East	REQ.	Required
E.A.	Each	RESIL.	Resilient
E.B.	Expansion Bolt	RM.	Room
E.J.	Expansion Joint	R.H.	Roze Hook
EL.	Elevation	R.O.	Rough Opening
ELEC.	Electrical		
ELEV.	Elevator		
EMER.	Emergency		
ENCL.	Enclosure		
ENGR.	Engineer	S.	South
E.P.B.	Electrical Panelboard	S.C.	Solid Core
EQ.	Equal	SCHED.	Schedule
EQPT.	Equipment	SECT.	Section
E.W.C.	Electric Water Cooler	SHR.	Shower
EXP.	Expansion	SHF.	Sheet
EXT.	Existing	SIM.	Similar
EXT.	Exterior	SPEC.	Specification
		SQ.	Square
F.A.	Fire Alarm	S.S.T.	Stainless Steel
F.D.	Fire Drain	STD.	Standard
FDN.	Foundation	STL.	Steel
F.E.	Fire Extinguisher	STOR.	Storage
F.E.C.	Fire Extinguisher Cabinet	STRL	Structural
F.H.C.	Fire Hose Cabinet		Suspended
FIN.	Finish		
FIXT.	Fixture	T.O.C.	Top of Curb
FL	Floor	TEL.	Telephone
FLUOR.	Fluorescent	THK.	Thick
F.O.F.	Face of Finish	THRES.	Threshold
F.O.S.	Face of Slabs	T.P.B.	Telephone Panelboard
FRP.	Firproof	TYP.	Typical
FRP	Fiberglass Reinforced		
	Plastic	U.O.N.	Unless Otherwise Noted
F.S.	Flavor Sink		
FT.	Foot or Feet	VERT.	Vertical
		VEST.	Vestibule
		V.I.F.	Verify In Field
GA.	Gauge	W.	West
GALV.	Galvanized	WI	With
G.B.	Grab Bar	W.C.	Water Closet
GL.	Glass	WD.	Wood
GYP.	Gypsum	W.O.	Where Occurs
H.C.	Hollow Core	W/O	Without
HDWD.	Hardwood		
HDWE.	Hardware	W.P.	Waterproof
HGT. or H.	Height	WT.	Weight
H.M.	Hollow Metal	W.R.	Water Resistant
HORIZ.	Horizontal		
HR.			

SYMBOLS

A2-1 → DRAWING NUMBER

→ GROUP NUMBER

→ DISCIPLINE PREFIX

DOOR SYMBOL

DOOR MARK

HARDWARE GROUP

DETAIL

DETAIL IDENTIFICATION

SHEET WHERE DETAIL IS DRAWN

EXTERIOR ELEVATION(S)

ELEVATION IDENTIFICATION (UNFOLD ELEVATIONS CLOCKWISE)

ELEVATION IDENTIFICATION

SHEET WHERE ELEVATION IS DRAWN

WALL SECTION

SECTION IDENTIFICATION

SHEET WHERE DETAIL IS DRAWN

INTERIOR ELEVATION(S)

ELEVATION IDENTIFICATION (UNFOLD ELEVATIONS COUNTERCLOCKWISE)

NO ARROWS MEANS ELEVATION NOT SHOWN

SHEET WHERE ELEVATION IS DRAWN

REVISION

CLOUD AROUND REVISION

OPTIONAL

OFFICE

ROOM IDENTIFICATION, TYPE 1

ROOM NAME

ROOM NUMBER

ROOM MATERIAL CODES

1ST NO.-FLOOR / BASE

2ND NO.-WALLS / WAINSCOT

3RD NO.-CEILING

OFFICE

ROOM IDENTIFICATION, TYPE 2

ROOM NAME

ROOM NUMBER

AREAS WHERE NO WORK IS TO BE DONE

EXISTING PARTITION

EXISTING CONSTRUCTION TO BE REMOVED

EXISTING DOOR TO BE REMOVED

EXISTING DOOR TO REMAIN

DIMENSION LINES

CENTERLINE OF COLUMN OR STUD

FACE OF FINISH

PROJECT TEAM

ARCHITECT

MEI ARCHITECTS
239 9TH STREET, SUITE 201
SAN FRANCISCO, CA 94103
TEL: (415) 682-7376
FAX: (415) 682-7339

STRUCTURAL ENGINEERS

PARADIGM STRUCTURAL ENGINEER
450 SANSOME STREET, 5TH FLOOR
SAN FRANCISCO, CA 94111
TEL: (415) 362-8944
FAX: (415) 362-8945


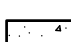

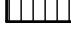
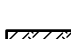



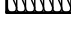




ELEVATOR CONSULTANT

EDGETT WILLIAMS CONSULTING GROUP, INC.
102 EAST BLITHEDALE AVE, SUITE #1
MILL VALLEY, CA 94941
TEL: (415) 388-1880
FAX: (415) 388-1890

FIRE LIFE SAFETY CONSULTANT

HUGHES ASSOCIATES, INC.
2551 SAN RAMON VALLEY BLVD, SUITE 205
SAN RAMON, CA 94583
TEL: (925) 314-7910
FAX: (925) 362-9750

MATERIALS

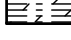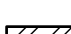	ACOUSTICAL PANEL
	CERAMIC TILE
	CONCRETE
	CONCRETE BLOCK
	EARTH
	GYPSUM BOARD
	BATT INSULATION
	RIGID INSULATION
	BULLET PROOF FIBERGLASS
	METAL
	PLASTER
	PLYWOOD
	WOOD

GENERAL NOTES

1. EXISTING COLUMN SPACINGS, DIMENSIONS, CONDITIONS, AND UTILITY SYSTEMS SHOWN ON DRAWINGS ARE APPROXIMATE AND ARE FOR INFORMATIONAL AND REFERENCE ONLY. CONTRACTOR SHALL OBTAIN THESE INFORMATION BY FIELD VERIFICATION.
2. LOCATIONS OF ALL UTILITY LINES (DUCTS, CONDUITS, AND OTHER OVERHEAD OBSTRUCTIONS) SHOWN ARE APPROXIMATE. COORDINATE ALL SUPPORT SYSTEMS SO AS TO NOT INTERFERE WITH ANY OTHER UTILITIES. CONTRACTOR SHALL BE RESPONSIBLE FOR NECESSARY TO COMPLETE THE INSTALLATION AT NO INCREASE TO THE CONTRACT SUM.
3. PROVIDE SUPPORTS AND BRACINGS AS REQUIRED FOR EXISTING UTILITIES PIPES, CONDUITS, DUCTS, ETC. EXISTING SUPPORTS WERE REMOVED DUE TO WORK UNDER THIS CONTRACT. NEW SUPPORTS AND BRACINGS SHALL MEET CURRENT CODE REQUIREMENTS.
4. IN ALL CONSTRUCTION AREAS, SEAL ALL EXISTING AND NEW PENETRATIONS INCLUDING DUCTS, PIPES, CONDUITS, ETC. AT FIRE RESISTIVE RATED PARTITIONS OR FLOOR/CEILING ASSEMBLIES. USE SEALANT TYPE TO MAINTAIN PROPER FIRE RESISTIVE RATING OF THE PENETRATED ASSEMBLIES. ALL PENETRATIONS AT FIRE RESISTIVE RATED PARTITIONS OR FLOOR/CEILING SHALL BE IN ACCORDANCE WITH THE APPROPRIATE U.L. APPROVED SYSTEMS.
5. FIRE PROTECTION AT FIRE RESISTIVE RATED PARTITIONS:
- A. NO ELECTRICAL BOXES SHALL BE LOCATED BACK TO BACK WITHIN 2'-0" HORIZONTALLY, ON FIRE RESISTIVE RATED PARTITION. IF LOCATED WITHIN 2'-0", EACH ELECTRICAL BOX SHALL BE PROTECTED WITH FIRE-RESISTIVE RATED GYPSUM BOARD AND RATED PARTITION.
 - B. ANY ELECTRICAL BOX LARGER THAN 16 SQUARE INCHES SHALL BE PROTECTED WITH FIRE-RESISTIVE RATED GYPSUM BOARD AROUND FIVE SIDES.
 - C. FOR ANY 100 SQUARE FEET OF FIRE-RESISTIVE RATED PARTITION AREA, THE ALLOWABLE AGGREGATED AREA FOR UTILITY BOXES SHALL NOT EXCEED 100 SQUARE INCHES.
6. IF CONTRACTOR PROPOSED ALTERNATE CONSTRUCTION DETAILS AND ARE REVIEWED BY DEPARTMENT OF VETERANS AFFAIRS, CONTRACTOR SHALL BE RESPONSIBLE FOR ALL COSTS AND TIME DELAYS RESULTING FROM CONTRACTOR'S PROPOSED ALTERNATE CONSTRUCTION DETAILS WHICH AFFECT OTHER PARTS OF THE WORK OR THE WORK OF SEPARATE CONTRACTORS.
7. WHEN INSTALLING DRILLED-IN ANCHORS AND/OR POWDER DRIVEN PINS IN EXISTING NON-PRESTRESS REINFORCED CONCRETE, USE CARE AND CAUTION TO AVOID CUTTING OR DAMAGING THE EXISTING REINFORCED BARS. MAINTAIN A MINIMUM CLEARANCE OF ONE INCH BETWEEN THE REINFORCEMENT AND THE DRILLED-IN ANCHOR AND PIN.

APPLICABLE CODE

THE WORK SHALL BE PERFORMED IN ACCORDANCE WITH APPLICABLE CODE REQUIREMENTS, AND APPLICABLE REQUIREMENTS OF ALL OTHER REGULATORY AGENCIES INCLUDING, BUT NOT LIMITED TO THE FOLLOWING:

- VA DIRECTIVES, DESIGN MANUALS, MASTER SPECIFICATIONS, VA NATIONAL CAD STANDARD APPLICATION GUIDE, AND OTHER GUIDANCE ON THE TECHNICAL INFORMATION LIBRARY (TIL)
- VA SEISMIC DESIGN REQUIREMENTS, H-18-8
- VA AMBULATORY CARE DESIGN GUIDELINES
- INTERNATIONAL BUILDING CODE (IBC)
- FEDERAL OCCUPATIONAL SAFETY AND HEALTH ADMINISTRATION (OSHA) STANDARDS
- NFPA 101 LIFE SAFETY CODE AND OTHERS ADOPTED BY TITLE 24 OF CCR
- NFPA NATIONAL FIRE CODES WITH THE EXCEPTION OF NFPA 5000 AND NFPA 900
- NATIONAL ELECTRICAL CODE (NEC)
- NATIONAL STANDARD PLUMBING CODE (NSPC)
- ASME BOILER AND PRESSURE VALVE CODE
- ASME CODE FOR PRESSURE PIPING
- UNIFORM FEDERAL ACCESSIBILITY STANDARDS (UFAS) INCLUDING VA SUPPLEMENT, BARRIER FREE DESIGN GUIDE
- BUILDING CODE REQUIREMENT FOR REINFORCED CONCRETE, AMERICAN CONCRETE INSTITUTE AND COMMENTARY (ACI 318)
- MANUAL OF STEEL CONSTRUCTION, LOAD AND RESISTANCE FACTOR DESIGN SPECIFICATIONS FOR STRUCTURAL STEEL BUILDINGS, AMERICAN INSTITUTE OF STEEL CONSTRUCTION (AISC)
- ENERGY POLICY ACT OF 2005 (EPAct)
- FEDERAL LEADERSHIP IN HIGH PERFORMANCE AND SUSTAINABLE BUILDINGS: MEMORANDUM OF UNDERSTANDING (MOU)
- VENTILATION FOR ACCEPTABLE INDOOR AIR QUALITY - ASHRAE STANDARD 62.1-2004
- SAFETY STANDARD FOR REFRIGERATION SYSTEM - ASHRAE STANDARD 15-2007

UNLESS OTHERWISE SPECIFIED, SPECIFIC REFERENCES TO CODES, REGULATIONS, STANDARDS, MANUFACTURER'S INSTRUCTIONS, OR REQUIREMENTS OF REGULATORY AGENCIES, WHEN USED TO SPECIFY REQUIREMENTS FOR MATERIALS OF DESIGN ELEMENTS SHALL MEAN THE LATEST EDITION OF EACH IN EFFECT AT THE DATE OF SUBMISSION OF BIDS, OR THE DATE OF THE CHANGE ORDER OR FIELD ORDER, AS APPLICABLE.

IF THERE IS A CONFLICT BETWEEN CODES, THE MOST RESTRICTIVE SHALL APPLY.

PROJECT DATA

BUILDING 650 INFORMATION

CONSTRUCTION TYPE: SINGLE STORY TYPE I-000 PER 2009 ed. NFPA 5000, OR TYPE II-B PER IBC TABLE 503

THREE STORY TYPE I-111 PER NFPA 5000, OR TYPE 11-A PER IBC

OCCUPANCY CLASSIFICATION: BUSINESS OCCUPANCY AND CLINIC SPACE

BUILDING HEIGHT: THREE STORY

BUILDING GROSS AREA:

PROJECT AREA:

CODE EDITION: INTERNATIONAL BUILDING CODE

SPRINKLERS: FIRE SPRINKLERED


PROJECT DESCRIPTION: ELEVATOR MODERNIZATION

DRAWING INDEX

ARCHITECTURAL

AS0-1	COVER SHEET
AS2-1	OVERALL FIRST FLOOR PLAN, AREA OF WORK, ACCESSIBLE PATH OF TRAVEL
AS2-2	(E) AND DEMOLITION PLANS, RCP; (N) PLANS, RCP, ELEVATIONS, AND DETAILS

LOCATION MAP

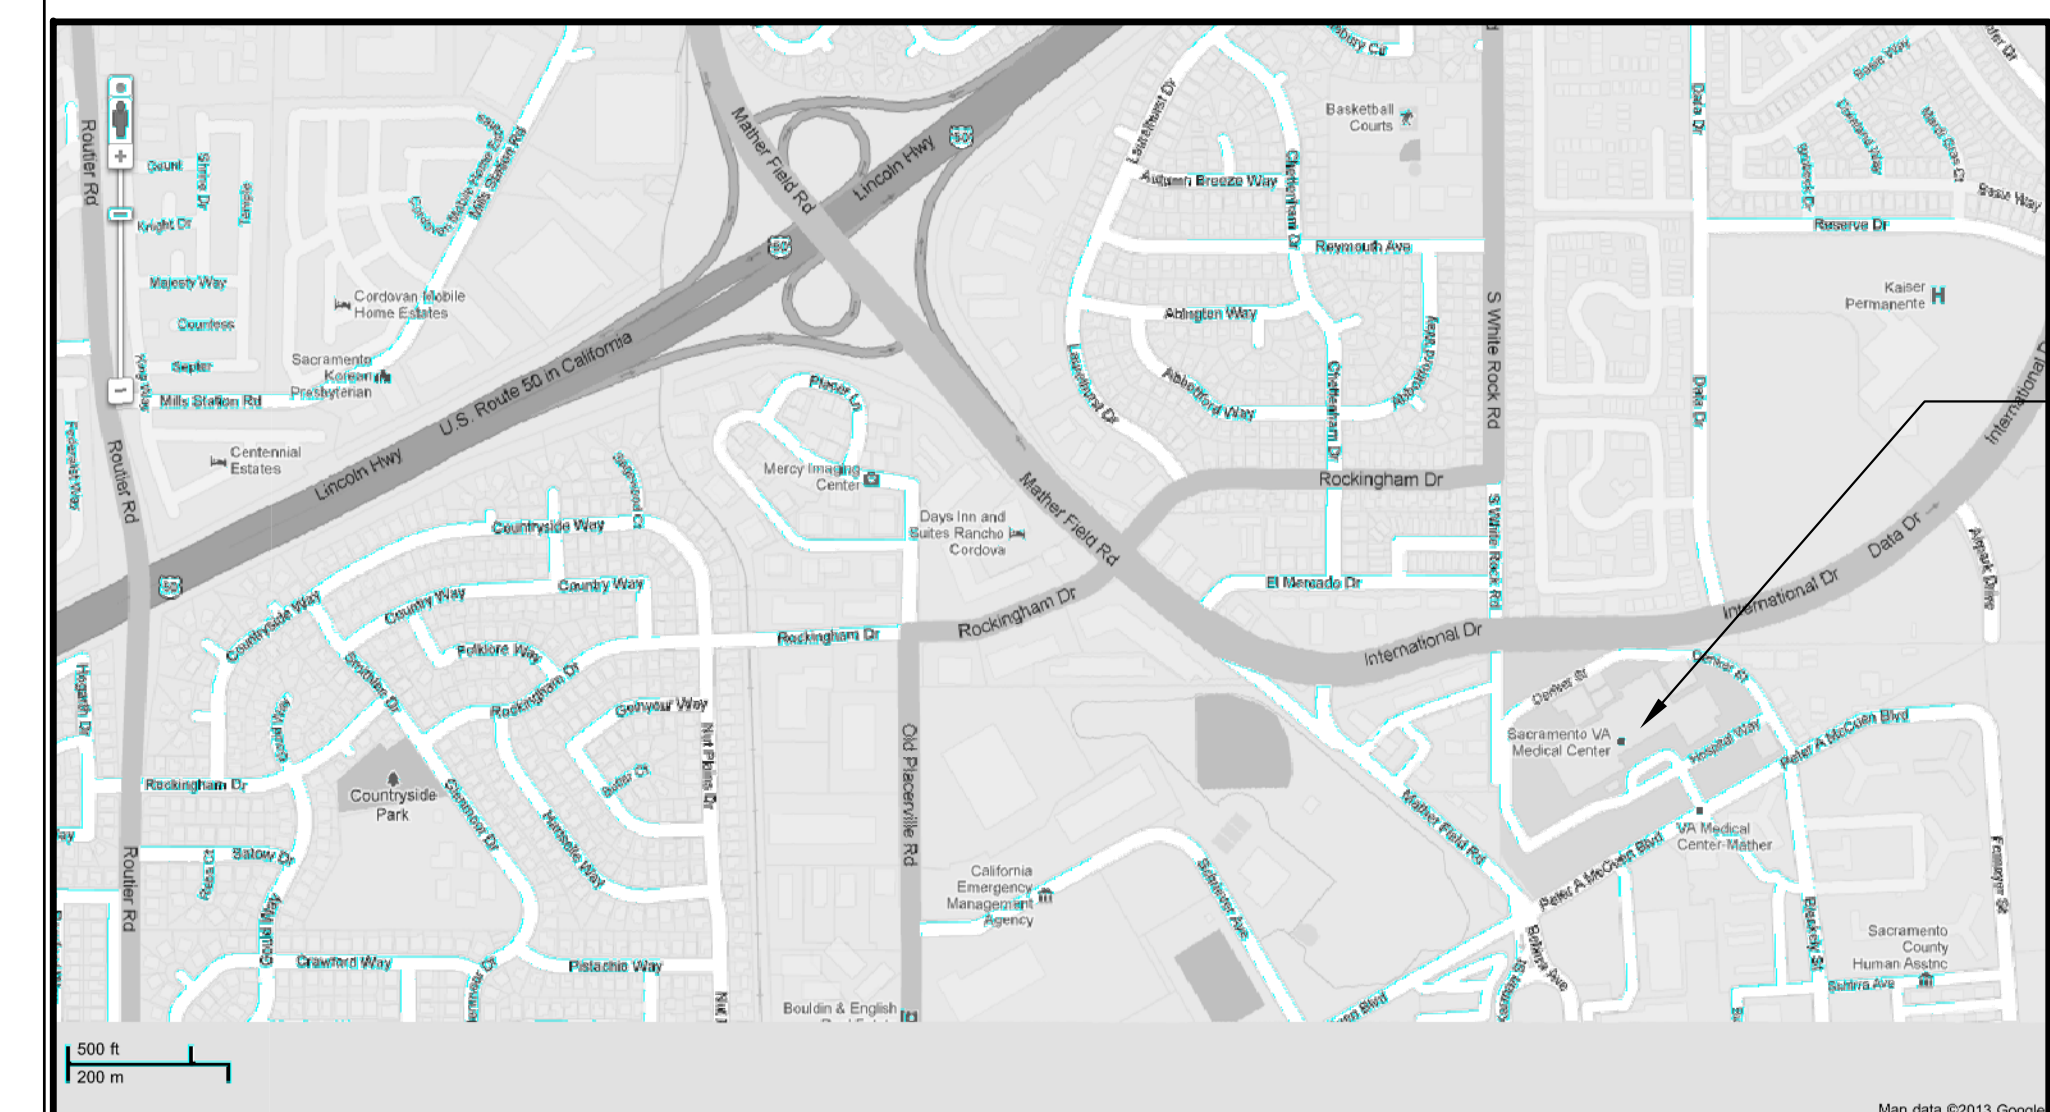

Project Site:
VA Northern California
Health Care System
Building 650
10535 Hospital Way
Mather, CA 95655



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three inches = one foot
one and one half inches = one foot
one inch = one foot
three quarters inch = one foot
one half inch = one foot
three eighths inch = one foot
one quarter inch = one foot
one eighth inch = one foot

TO ADA PARKING

TO ADA PARKING

AREA OF WORK

TO ADA PARKING

TO ADA PARKING

ACCESSIBLE PATH OF TRAVEL


AREA OF WORK

1 OVERALL FIRST FLOOR PLAN

1/16"=1'-0"

CONSULTANTS:

ARCHITECT/ENGINEERS:

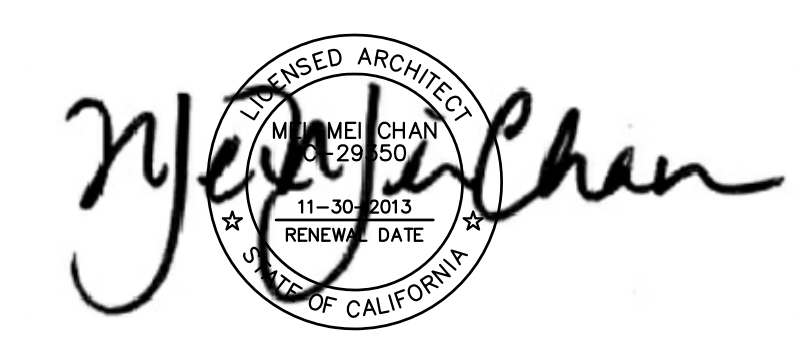

Drawing Title
OVERALL FIRST FLOOR PLAN
AREA OF WORK
ACCESSIBLE PATH OF TRAVEL

Approved: Project Director

Project Title
Design of Building 650
Elevator Replacement

Location
10535 Hospital Way Mather, CA 95655

Date
June 14, 2013

Checked
-

Drawn
DNg

Project Number
612A4-12-211


Building Number
650

Drawing Number


AS2-1
Dwg. of --

Office of
Facilities
Management




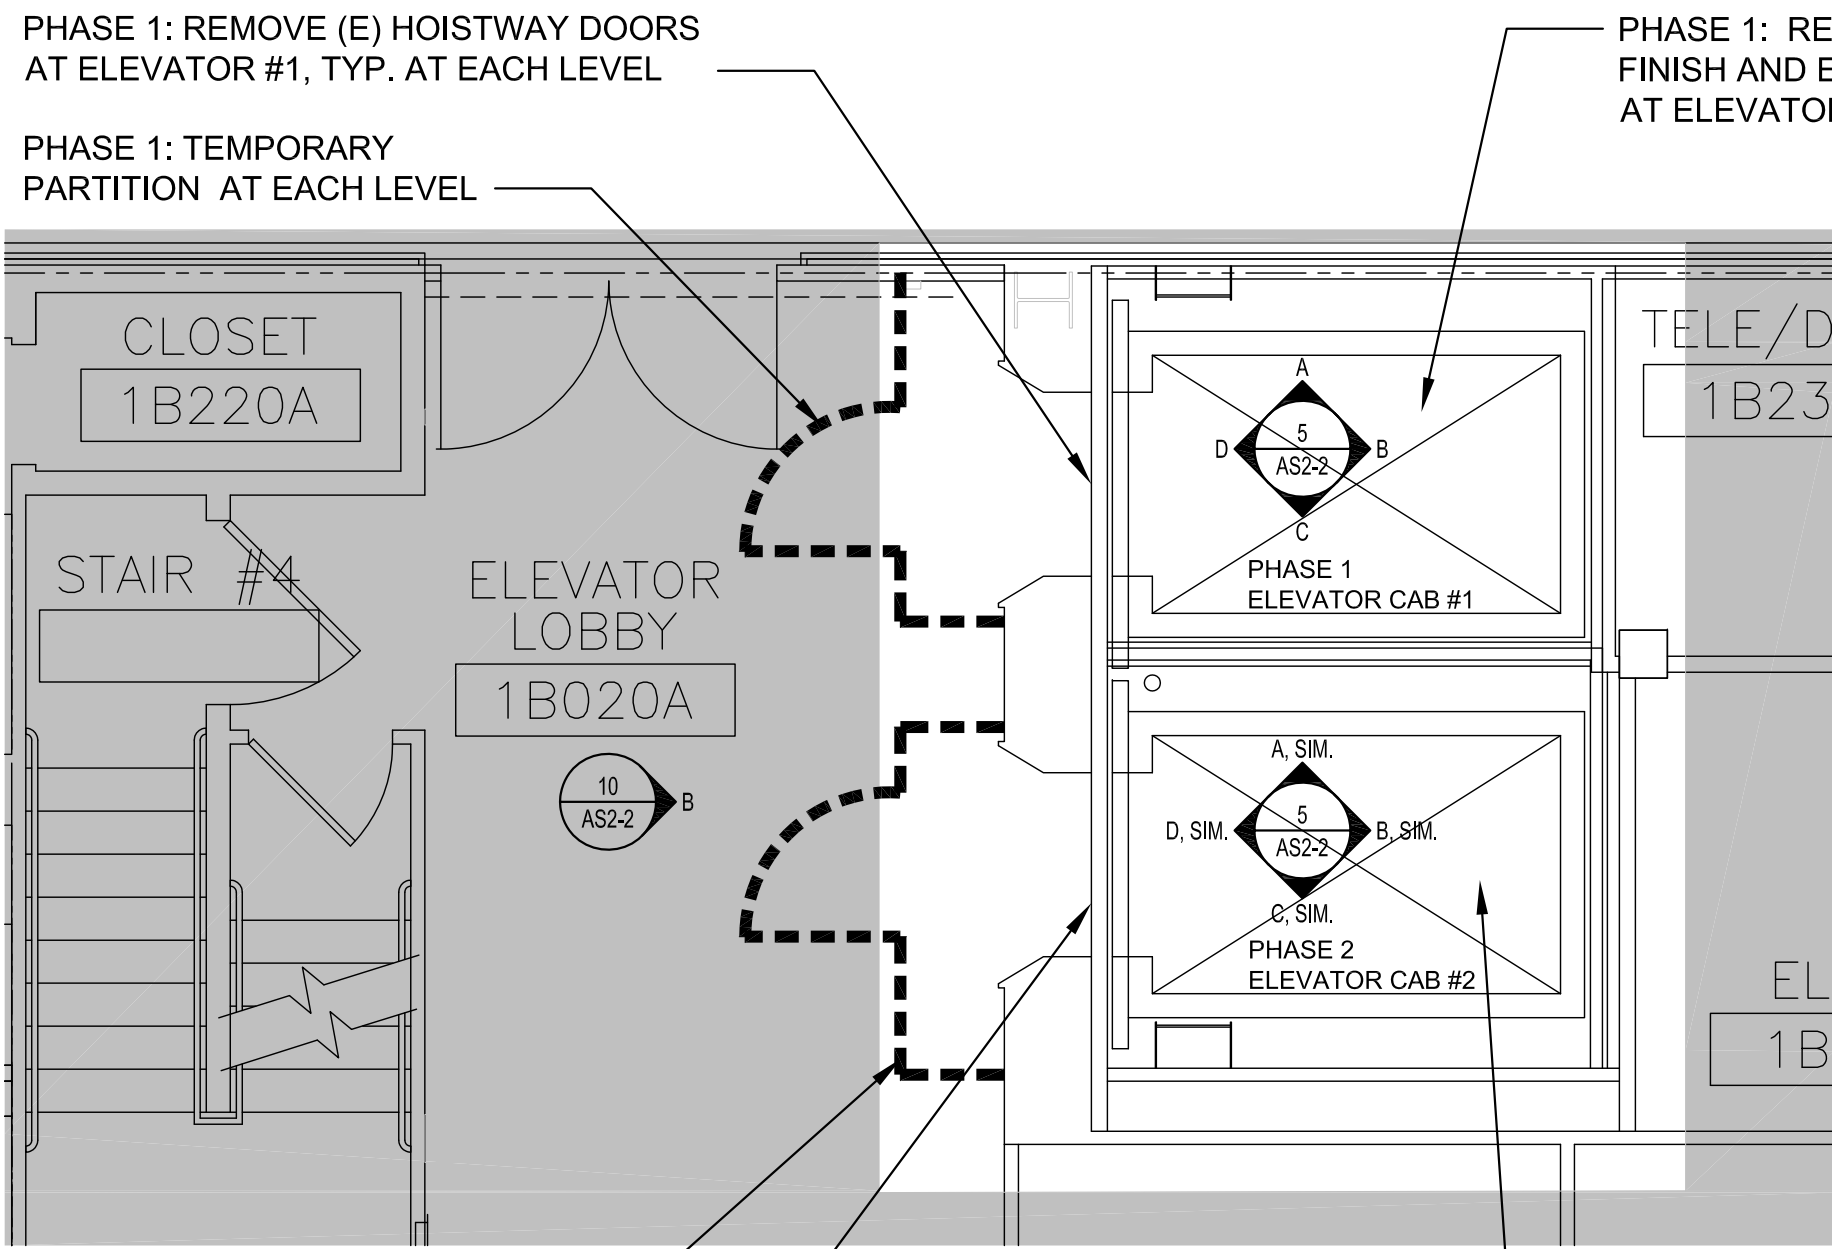

1 (E) PARTIAL FIRST FLOOR DEMOLITION PLAN
1/4" = 1'-0"

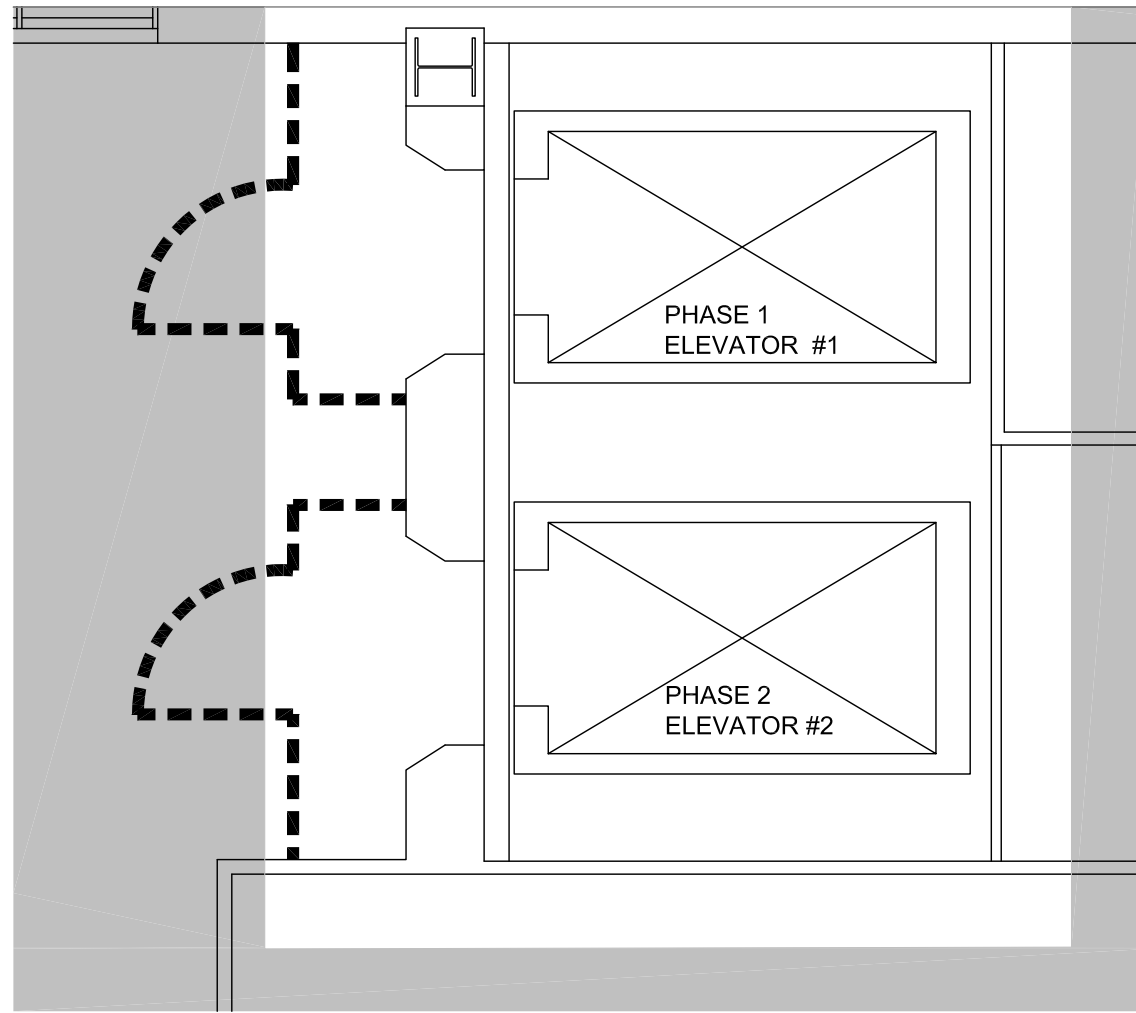

2 (E) PARTIAL SECOND FLOOR PLAN
1/4" = 1'-0"

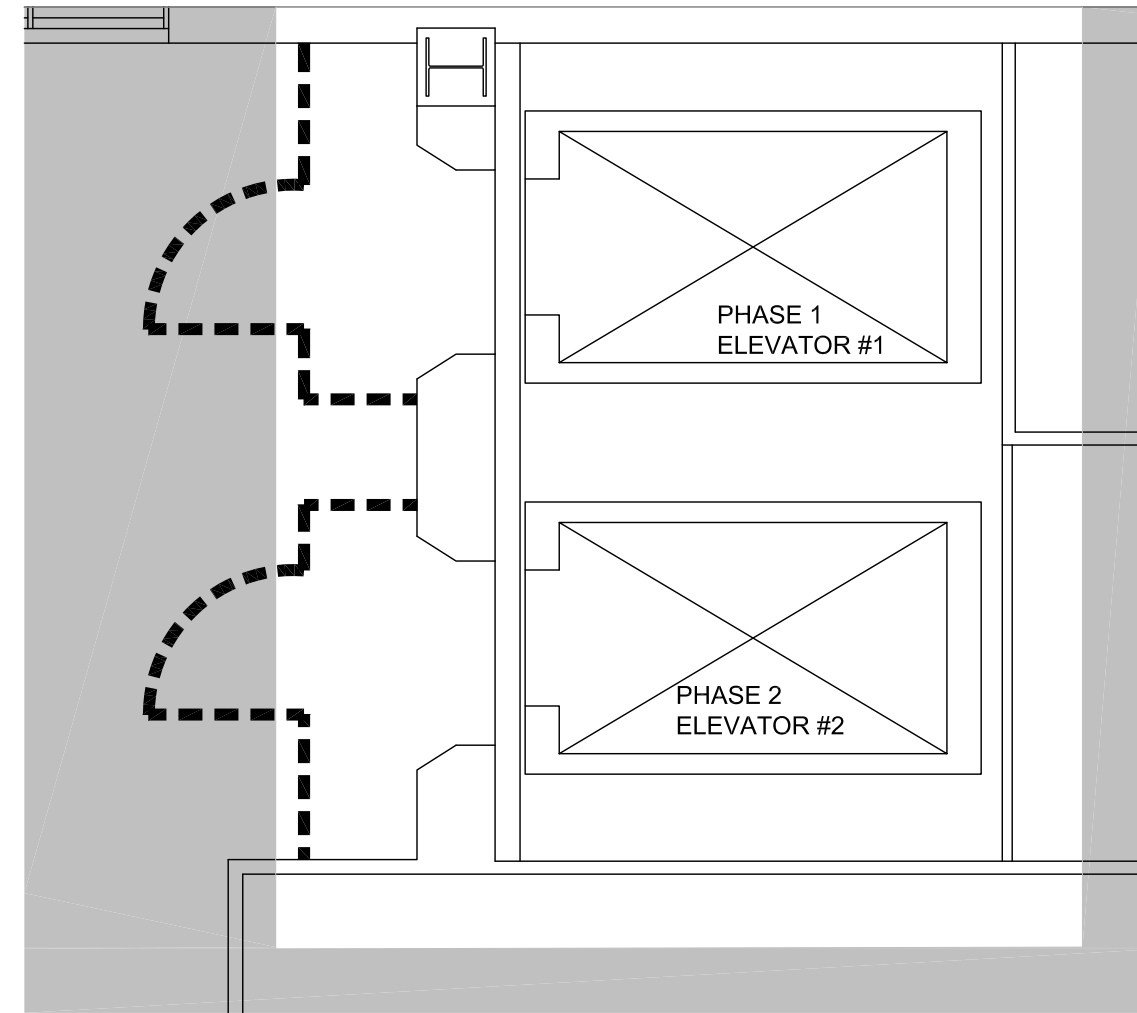

3 (E) PARTIAL THIRD FLOOR PLAN
1/4" = 1'-0"

PHASING:

PHASE 1 - ELEVATOR CAB AND HOISTWAY #1

1. CONSTRUCT TEMPORARY PARTITIONS AT EACH LEVEL AT ELEVATOR #1 HOISTWAY
2. REMOVE (E) HOISTWAY DOORS AND HALL LANTERNS AT EACH LEVEL
3. REMOVE (E) INTERIOR FINISHES, CONTROL PANEL, CONTROL BUTTONS, CAB DOORS, AND IN-CAR LANTERN
4. REMOVE (E) LIGHT COVE AND METAL CEILING
5. INSTALL (N) FINISHES, (N) HOISTWAY DOORS AT EACH LEVEL, (N) CAB DOORS, (N) CONTROL PANELS AND BUTTONS, (N) FLOOR LEVEL DESIGNATION PLATES, (N) HALL LANTERNS

DURING PHASE 1 REMODEL OF ELEVATOR CAB AND HOISTWAY #1, ELEVATOR AND HOISTWAY #2 SHALL REMAIN OPERATIONAL.

PHASE 2 - ELEVATOR CAB AND HOISTWAY #2

1. CONSTRUCT TEMPORARY PARTITION AT EACH LEVEL AT ELEVATOR #2
2. REMOVE (E) HOISTWAY DOORS AND HALL LANTERNS AT EACH LEVEL
3. REMOVE (E) INTERIOR FINISHES, CONTROL PANEL, CONTROL BUTTONS, CAB DOORS, AND IN-CAR LANTERN
4. REMOVE (E) LIGHT COVE AND METAL CEILING
5. INSTALL (N) FINISHES, (N) HOISTWAY DOORS AT EACH LEVEL, (N) CAB DOORS, (N) CONTROL PANELS AND BUTTONS, (N) FLOOR LEVEL DESIGNATION PLATES, (N) HALL LANTERNS
6. AT THE END OF PHASE 2, REMOVE (E) HALL CALL BUTTONS AT EACH FLOOR, PATCH AND REPAIR TO MATCH (E), INSTALL (N) CALL BUTTONS, TO BE COORDINATED WITH MINIMAL DISRUPTION TO ELEVATOR SERVICE

DURING PHASE 2 REMODEL OF ELEVATOR CAB AND HOISTWAY #2, ELEVATOR AND HOISTWAY #1 SHALL REMAIN OPERATIONAL.


*PROVIDE DUPLICATE CORRIDOR OPERATING DEVICES DURING EACH PHASE, TEMPORARILY.

GENERAL NOTE:


THE CAB WEIGHT SHALL NOT INCREASE MORE THAN 5% WITH THE NEW FINISHES

INTERIOR FINISH AND COLOR SCHEDULE


SYMBOL	MANUFACTURER	MODEL NO. / COLOR	DESCRIPTION/ LOCATION
SS-1	BRUSHED STAINLESS STEEL	ANY	FINISH: BRUSHED
RS-1	LINOLEUM FLOORING	ARMSTRONG	STYLE: MARMORETTE LINOLEUM COLOR: OAK BROWN/ LP066
PL-1	PLASTIC LAMINATE	WILSONART	WILLIAMSBURG CHERRY WITH AEON FINISHES/ 7936K-07
SS-2	SEASTONE FINISH STAINLESS STEEL BACKING	FORMS & SURFACES	STYLE: NONE FINISH: SEASTONE
MP-1	STAINLESS STEEL PANEL	RIGIDIZED METALS	STYLE: 6-WL FINISH: SATIN (#4)

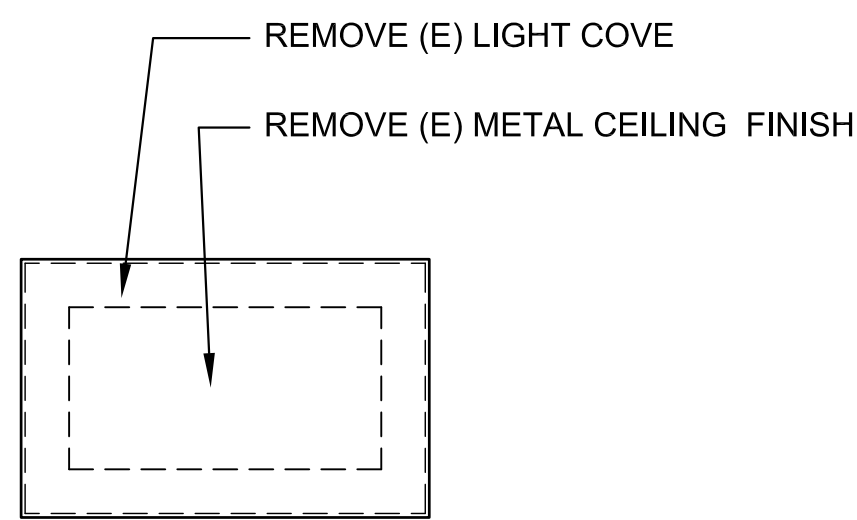



4 RCP - (E) ELEVATOR CAB DEMOLITION, TYP.
1/4" = 1'-0"

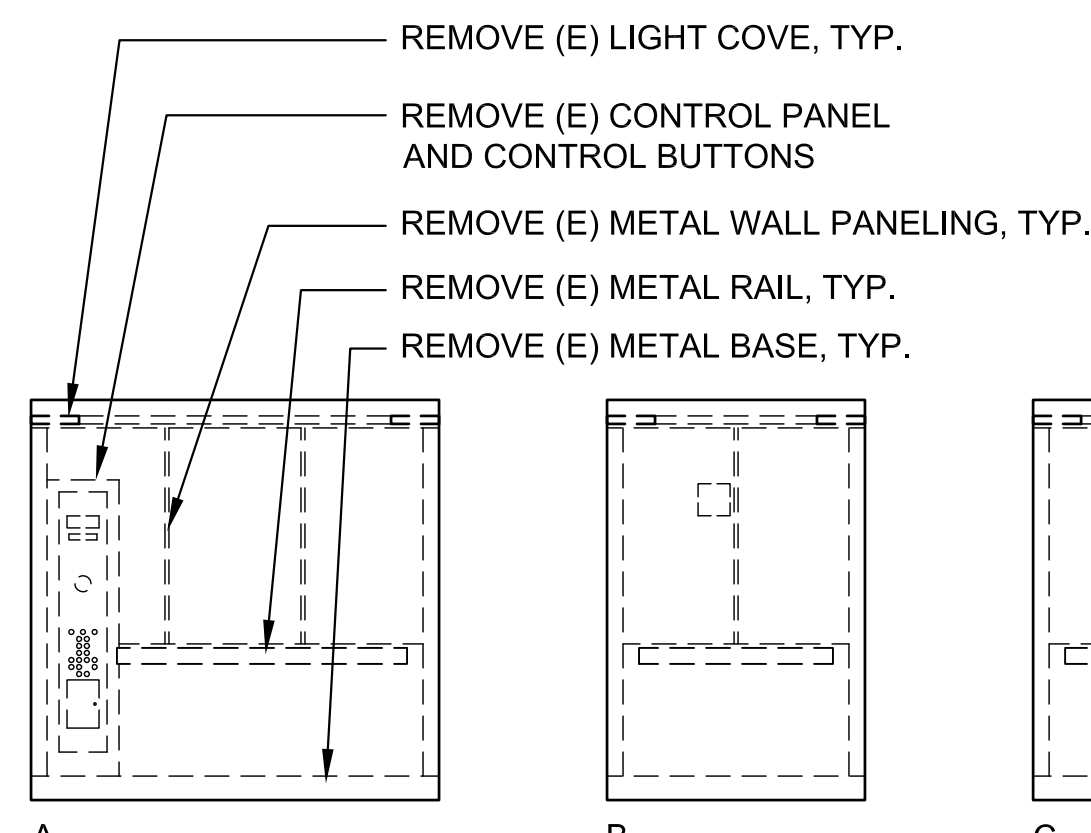


5 INT. ELEVATIONS - (E) ELEVATOR CAB DEMOLITION, TYP.
1/4" = 1'-0"

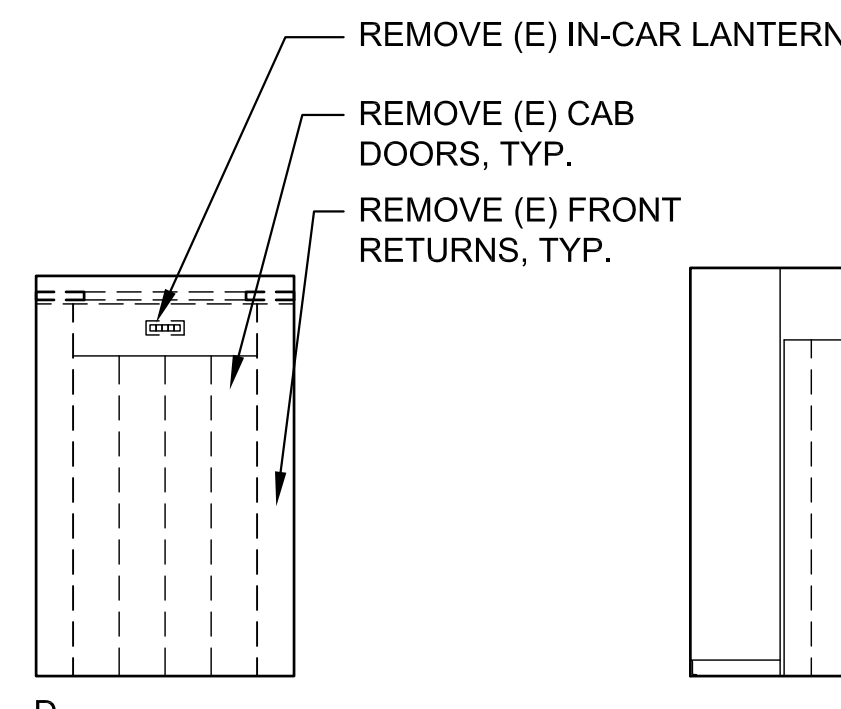


6 INT. ELEVATION - ELEVATOR LOBBY DEMOLITION, TYP.
1/4" = 1'-0"

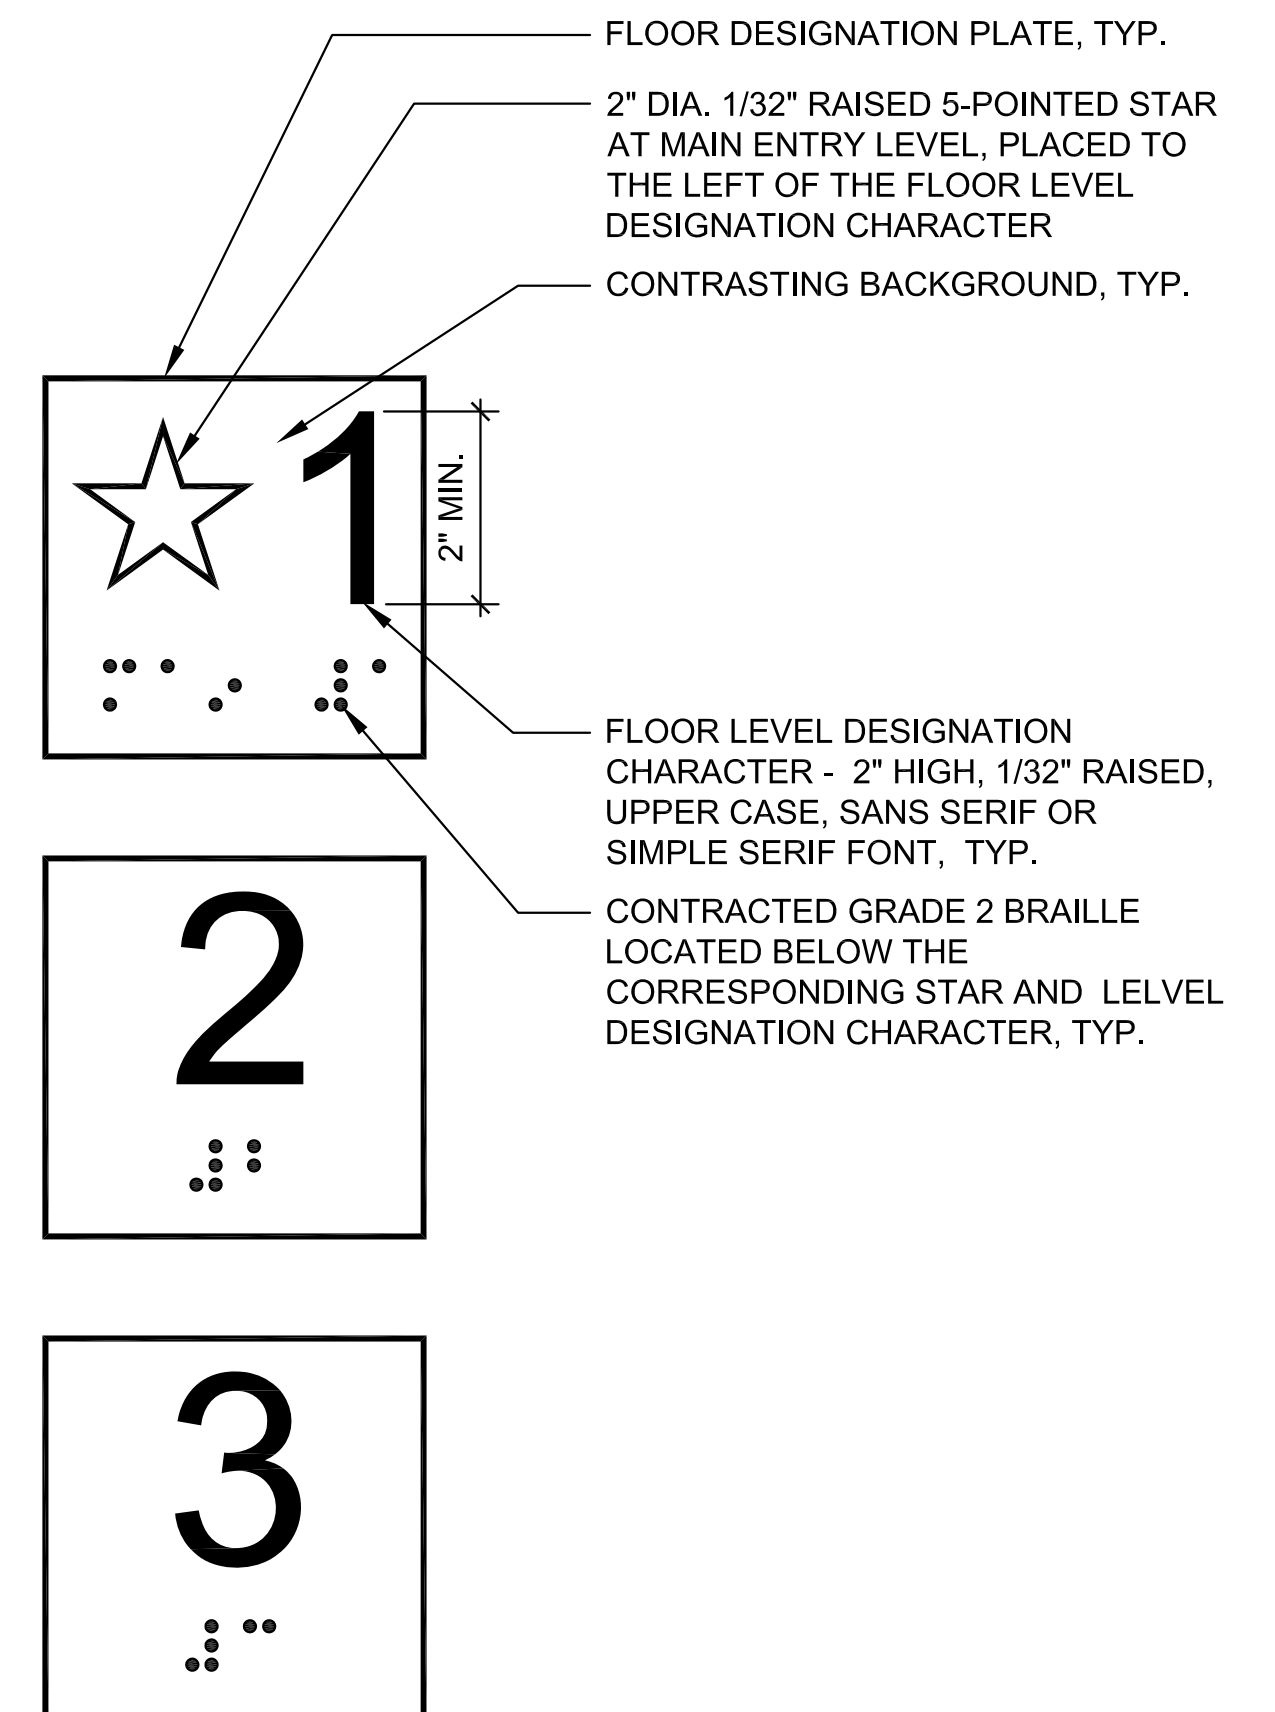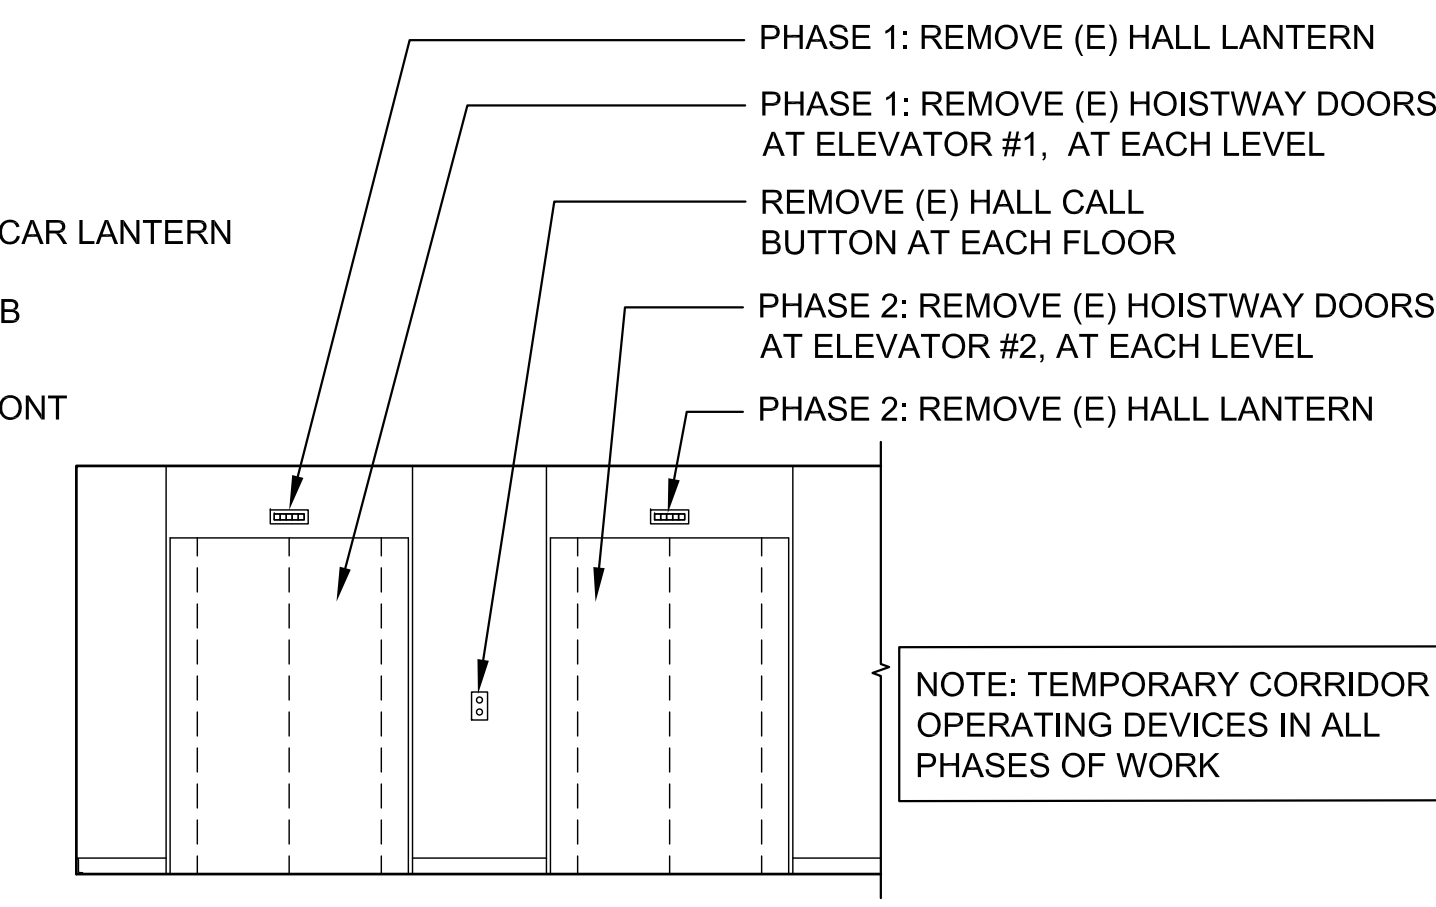


11 DETAIL - FLOOR LEVEL DESIGNATION PLATES
6" = 1'-0"

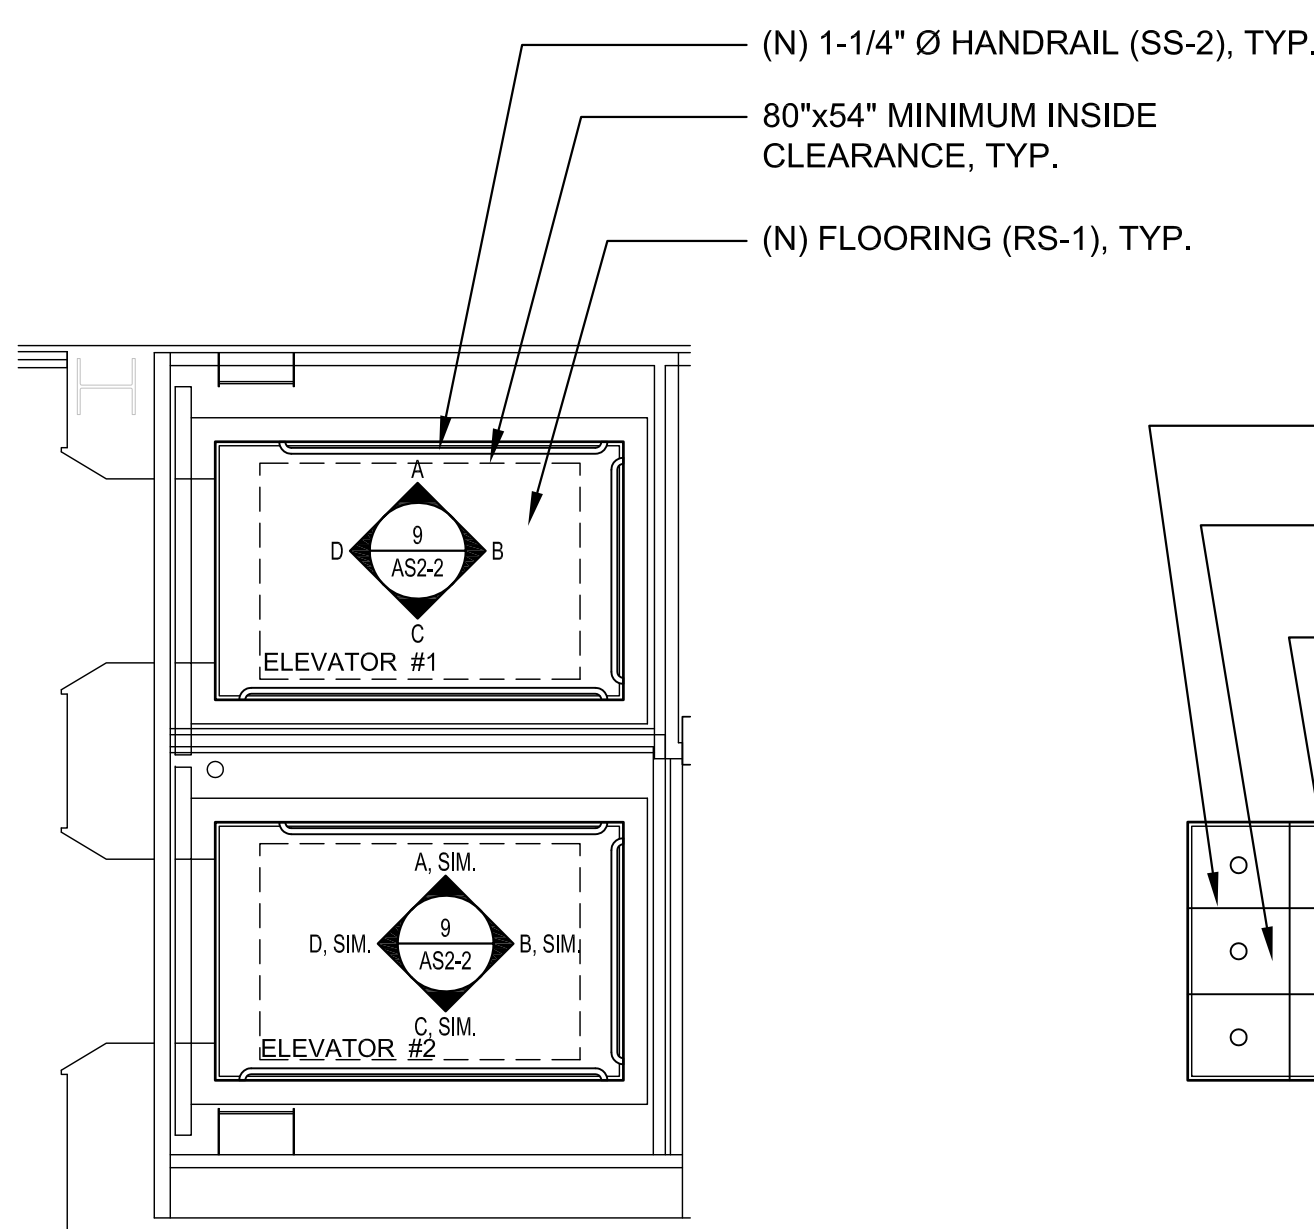



7 PARTIAL PLAN AT ELEVATORS, TYP.
1/4" = 1'-0"

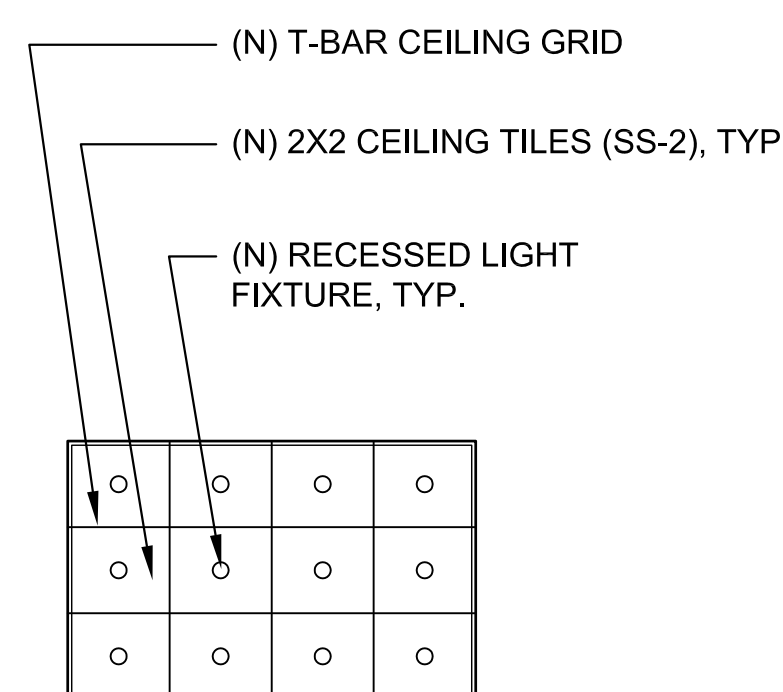

8 RCP - ELEVATOR CAB, TYP.
1/4" = 1'-0"

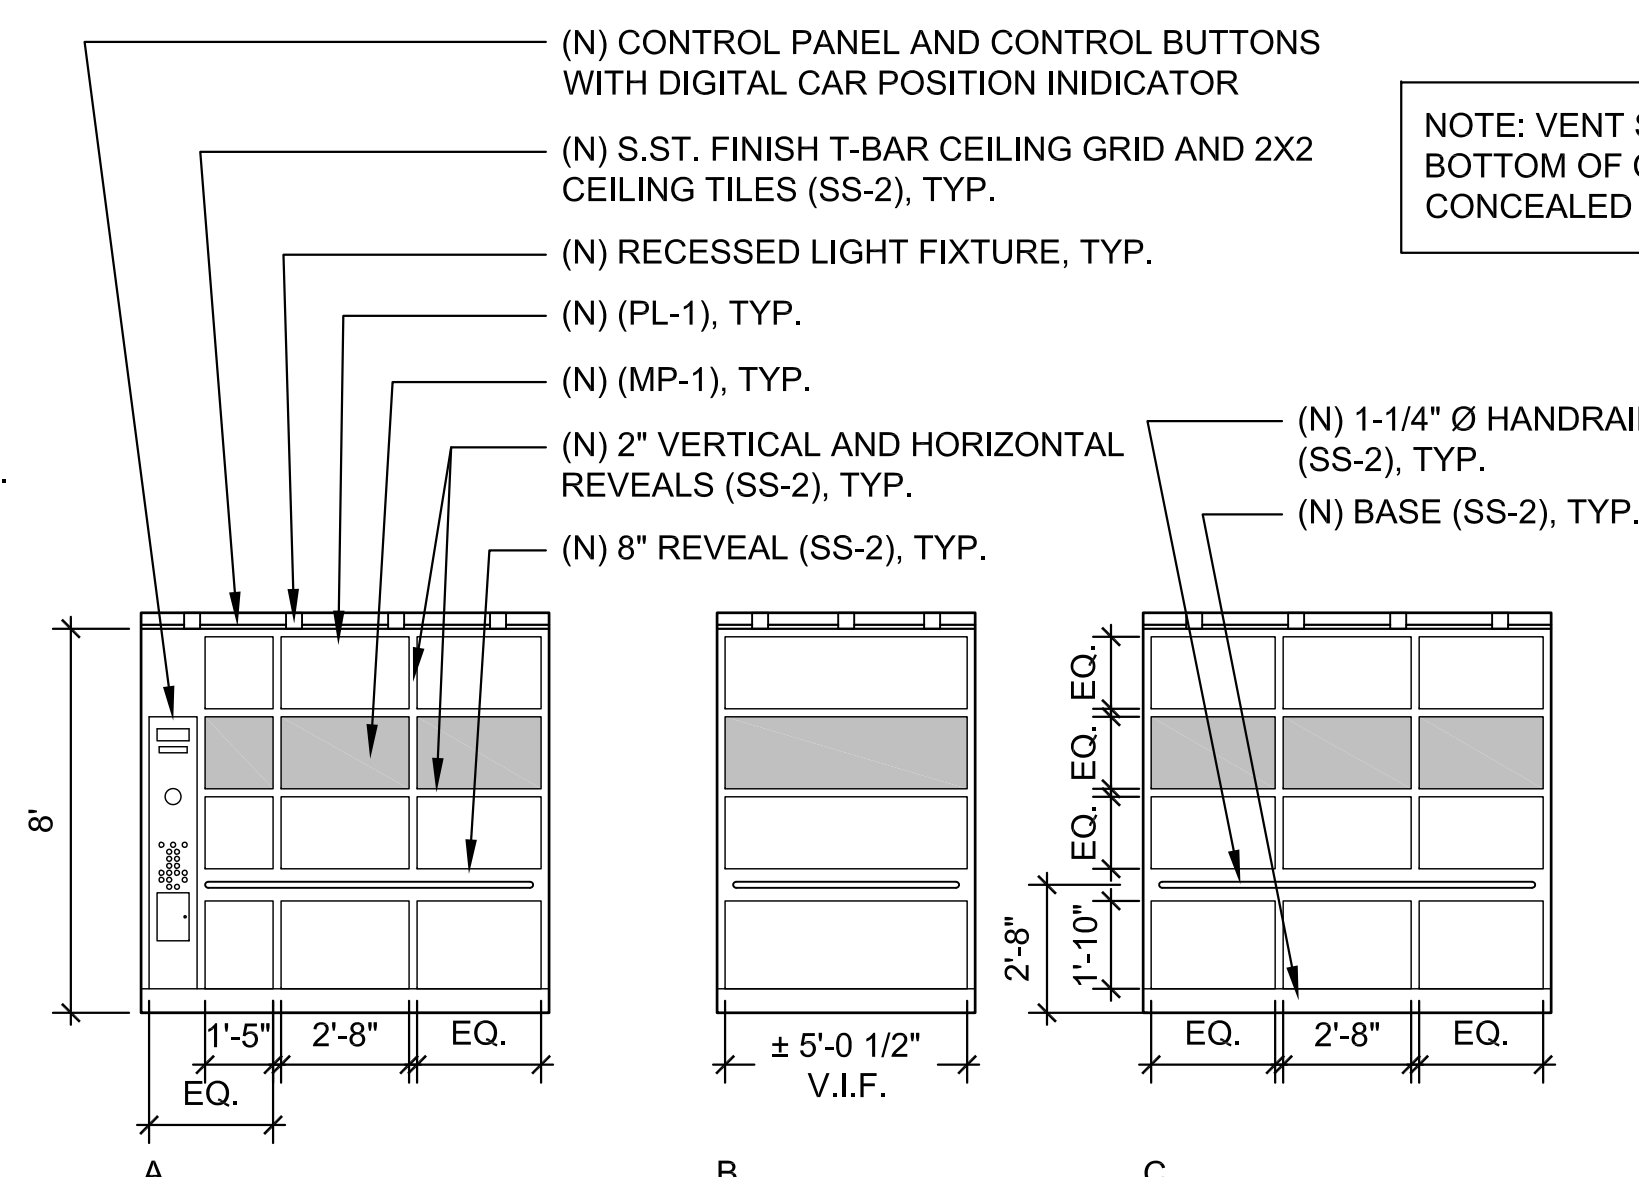

9 INT. ELEVATIONS - ELEVATOR CAB, TYP.
1/4" = 1'-0"

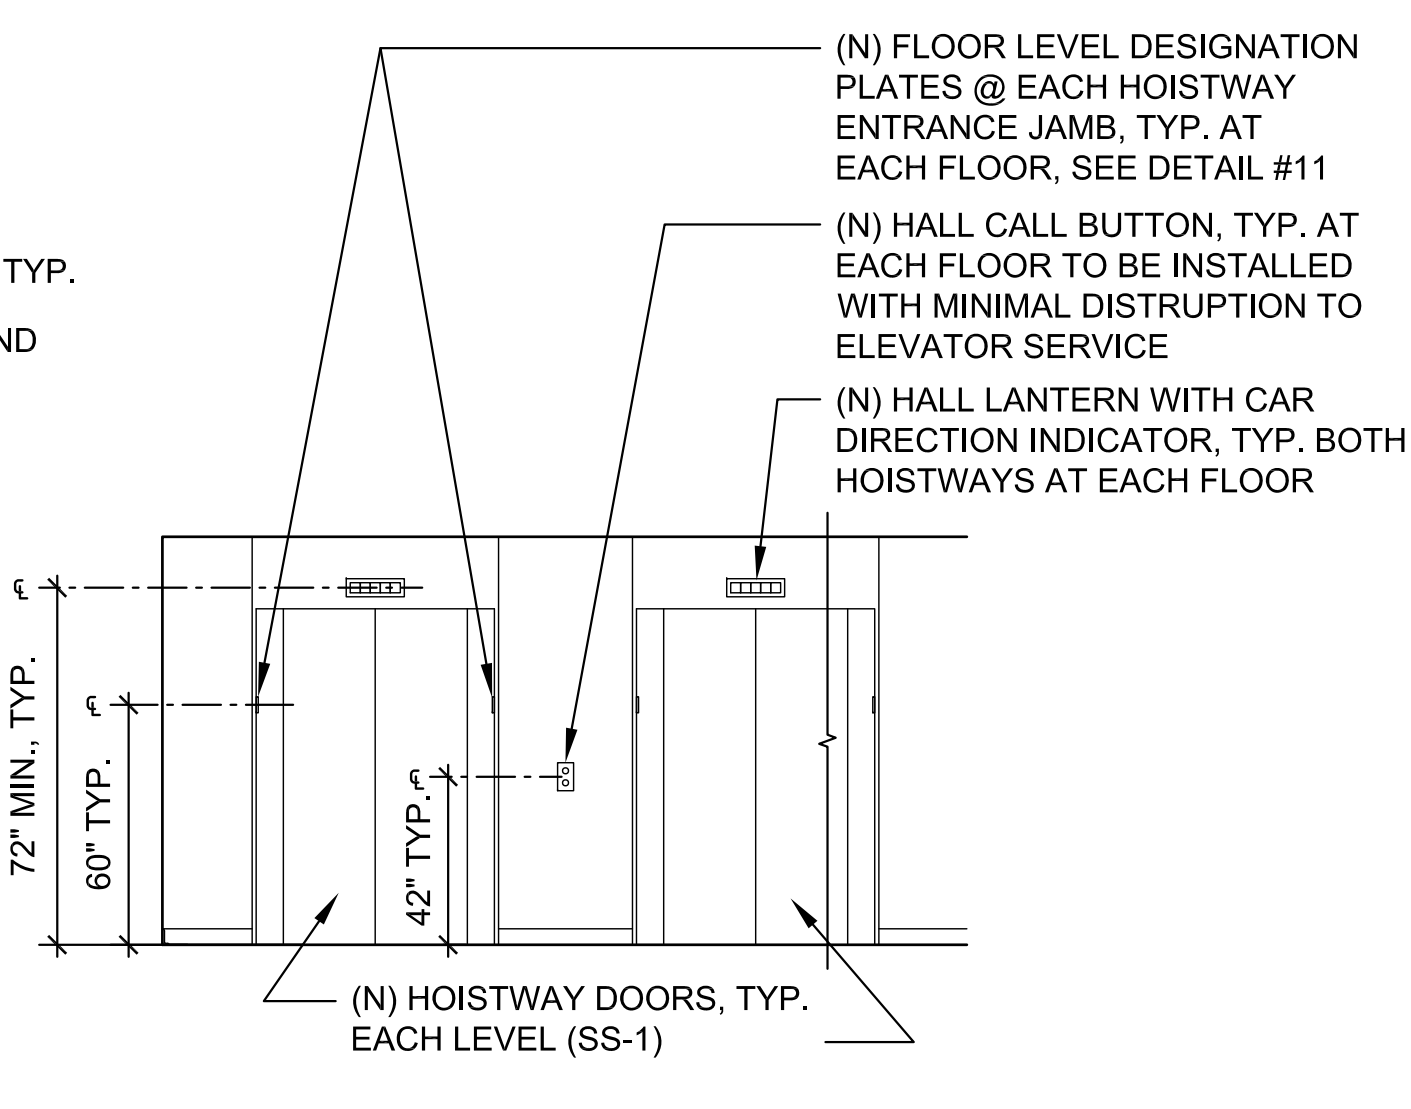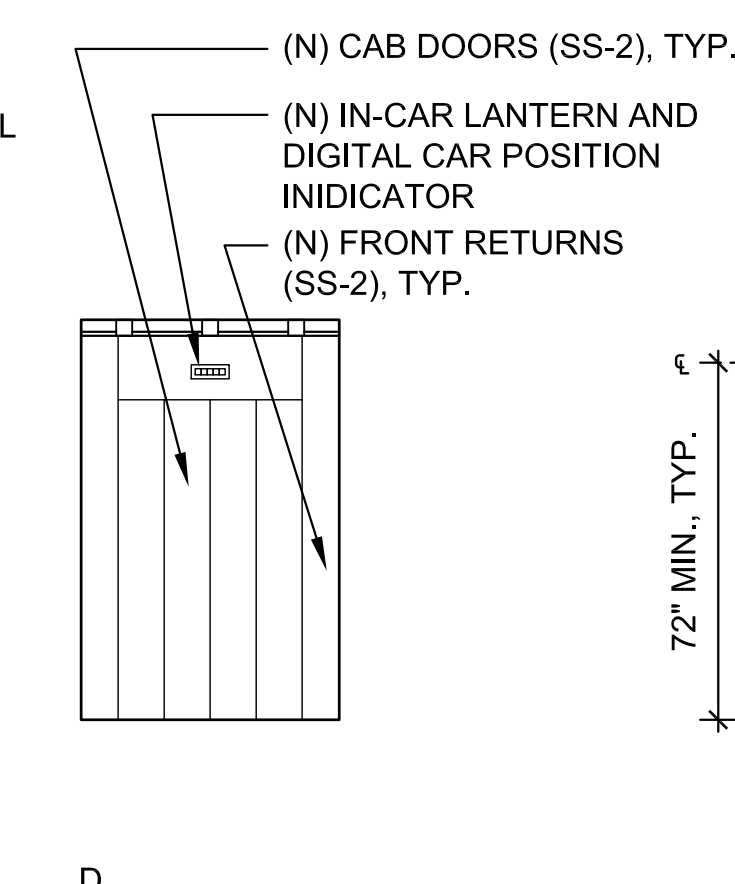

10 INT. ELEVATIONS - ELEVATOR LOBBY, TYP.
1/4" = 1'-0"

CONSULTANTS:		ARCHITECT/ENGINEERS:		Drawing Title (E) AND DEMOLITION PLANS, RCP, AND ELEVATIONS (N) PLANS, RCP, ELEVATIONS, AND DETAILS		Project Title Design of Building 650 Elevator Replacement		Project Number 612A4-12-211		Office of Facilities Management			
Issue Title Revisions:		230 9TH STREET, SUITE 201 SAN FRANCISCO, CA 94103 TEL: 415.685.0275 FAX: 415.685.0273 WWW.MEIA-ARCHITECTURE.COM		Approved: Project Director		Location 10535 Hospital Way Mather, CA 95655		Building Number 650					
xx/xx/xx Date						Date June 14, 2013		Checked -		Drawn DNG		Drawing Number AS2-2 Dwg. of --	