

Department of

VETERANS AFFAIRS

VA MEDICAL CENTER DURHAM, NORTH CAROLINA

RENOVATE BUILDING 6 FOR RESEARCH AND ANCILLARY SUPPORT

ARCHITECT:

RGG ARCHITECTS, PLLC DURHAM, NORTH CAROLINA

PME ENGINEER:

EDMONDSON ENGINEERS, P.A. DURHAM, NORTH CAROLINA

PHASING REQUIREMENTS

GENERAL CONTRACTOR SHALL USE THE FOLLOWING INFORMATION TO DEVELOP A DETAILED PHASING PLAN INDICATING START AND COMPLETION DATES FOR ALL CRITICAL ACTIVITIES.

PHASE 1

- PHASE 2, BASEMENT SHOPS, AND FREEZER ROOM WILL REMAIN OCCUPIED DURING PHASE 1 CONSTRUCTION.
 CONSTRUCT NEW ENTRY SPACE AND DOORWAY TO FREEZER ROOM 1118 TO PROVIDE USER ACCESS DURING PHASE 1 CONSTRUCTION.
- REROUTE WASTE AND SUPPLY PLUMBING LINES TO ALLOW EXISTING FIRST FLOOR TOILET ROOMS IN PHASE 2 TO REMAIN OPERATIONAL DURING CONSTRUCTION OF PHASE 1.
- LOCATE ALL POWER, LIGHTING, AND SECURITY CARD READER CIRCUITS SUPPLYING PHASE 2, EXISTING FREEZER ROOM 1118 & BASEMENT SHOPS. REROUTE CIRCUITS AND PROVIDE TEMPORARY PANELS AS REQUIRED TO MAINTAIN ALL SERVICES IN REFERENCED AREAS DURING PHASE 1 CONSTRUCTION.
- PROVIDE TEMPORARY CHWS/CHWR PIPING AND TEMPORARY POWER ACROSS ROOF TO MAINTAIN EXISTING MECHANICAL UNIT SUPPLYING PHASE 2.
- FIRST FLOOR, AND ROOF TOP MECHANICAL WORK.
 PROVIDE TEMPORARY ROOF DRY-IN WHERE EXISTING ROOF TOP EQUIPMENT AND DUCTS ARE REMOVED.

- COMPLETE ALL ABATEMENT, DEMOLITION AND NEW CONSTRUCTION AS INDICATED IN PHASE 1 BASEMENT

- INSTALL NEW ELECTRICAL FEEDER FROM STEAM PLANT TO BUILDING 6 AS INDICATED.

- PHASE 2 WILL NOT BEGIN UNTIL PHASE 1 IS COMPLETED AND FULLY OCCUPIED. PROVIDE ALL TEMPORARY CIRCUITS, PANELS, AND TIE-INS AS REQUIRED TO MAINTAIN ALL SERVICES IN PHASE 1 DURING PHASE 2 CONSTRUCTION.
 - COMPLETE ALL ABATEMENT, DEMOLITION, AND CONSTRUCTION AS INDICATED IN BASEMENT, FIRST FLOOR, & ROOF.
 - NEW ROOF AND ASSOCIATED ROOF WORK WILL BE INSTALLED AFTER ALL ABANDONED CURBS, AND EQUIPMENT IS REMOVED, AND AFTER ALL NEW CURBS, ROOF DECK INFILL, EQUIPMENT, AND PIPING IS INSTALLED. TEMPORARY DRY-INS ARE REQUIRED TO MAINTAIN BUILDING WATER TIGHT AT ALL TIMES.

GENERAL NOTES:

- 1. CONTRACTOR MUST OBTAIN HOT WORK PERMITS DAILY FOR WELDING, SOLDERING, TORCH CUTTING AND BURNING FROM THE VA MEDICAL CENTER FIRE & SAFETY OFFICE BEFORE BEGINNING WORK OF THIS TYPE. FIRE WATCH IS REQUIRED. CONTRACTOR TO FURNISH FIRE EXTINGUISHERS.
- 2. NO SMOKING EXCEPT IN DESIGNATED AREAS OUTSIDE OF BLDG.
- 3. ALL DIMENSIONS SHALL BE VERIFIED CAREFULLY AND ANY DISCREPANCIES BROUGHT TO THE IMMEDIATE ATTENTION OF THE VA CHIEF ENGINEER.
- 4. GENERAL CONTRACTOR SHALL PROTECT EXISTING CORRIDORS, ELEVATORS, DOORS, ETC. AND REPAIR ANY DAMAGE RESULTING FROM RENOVATION, DEMOLITION OR TRANSPORTATION OF MATERIALS ASSOCIATED WITH THIS PROJECT.
- 5. ANY CEILING TILE, GRID SYSTEM, LIGHT FIXTURE, AIR GRILLES, ETC. REMOVED BY THE CONTRACTOR TO FACILITATE THE WORK SHALL BE REPLACED IN THE ORIGINAL CONDITION AT THE CONCLUSION OF THE WORK. THIS IS IN AREAS EITHER ADJACENT TO THE PROJECT AND/OR IN AREAS WHERE THERE IS NO
- NOTIFY THE VA CHIEF ENGINEER PRIOR TO ANY CORE DRILLING. THIS MUST BE SCHEDULED 7 DAYS IN ADVANCE.
- WOOD BLOCKING IS NOT ACCEPTABLE AS A SUBSTITUTE FOR SHEET METAL BLOCKING.
- WHEN REPAIRING WALLS, MATCH EXISTING CONDITIONS, UNLESS OTHERWISE NOTED.

THE VA CHIEF ENGINEER SHALL BE GIVEN THREE WEEKS NOTICE, IN WRITING,

- BEFORE ANY UTILITY SYSTEM SHUTDOWN IS REQUIRED.

 10. REPAIR OR REPLACE ALL PROPERTY OF THE OWNER DAMAGED BY
- CONSTRUCTION, INCLUDING BUT NOT LIMITED TO: EQUIPMENT, FLOORS BASES, CEILING TILES, AND WALLS.

 11. IT WILL BE THE RESPONSIBILITY OF THE CONTRACTOR TO IMMEDIATELY
- REPAIR ANY DAMAGED FIRE SPRINKLER PIPING DURING DEMOLITION AND CONSTRUCTION.
- 12. TEMPORARY LIGHTING WILL BE THE RESPONSIBILITY OF THE CONTRACTOR DURING DEMOLITION AND CONSTRUCTION.
- 13. THE DRAWINGS AND SPECIFICATIONS ARE INTENDED TO BE FOR ASSISTANCE AND GUIDANCE, BUT EXACT LOCATIONS, DISTANCES, LEVELS, QUANTITIES SHALL BE GOVERNED BY ACTUAL CONDITIONS FOUND AT THE JOB SITE AND MUST BE VERIFIED BY THE CONTRACTOR. THE CONTRACTOR SHALL FIELD VERIFY ALL DIMENSIONS AND BECOME FAMILIAR WITH ALL AREAS OF THE EXISTING BUILDING AFFECTED BY THE WORK, PRIOR TO COMMENCING THE WORK.
- 14. CONTRACTOR SHALL LEGALLY REMOVE AND DISPOSE OF ALL DEBRIS.

LIST OF DRAWINGS

T1.0 TITLE SHEET, LIST OF DRAWINGS, & SITE PLAN PBAB-1 BASEMENT - ASBESTOS ABATEMENT

PBAB-1 BASEMENT - ASBESTOS ABATEMENT
PBAB-2 FIRST FLOOR - ASBESTOS ABATEMENT

LS1.1 BASEMENT FLOOR LIFE SAFETY PLAN

LS1.2 FIRST FLOOR LIFE SAFETY PLANS
A0.1 BASEMENT - DEMOLITION PLAN

A0.2 FIRST FLOOR - DEMOLITION PLAN

A1.1 BASEMENT - CONSTRUCTION PLAN

A1.2 FIRST FLOOR - CONSTRUCTION PLAN

A1.3 TOILET ROOMS - BASEMENT AND FIRST FLOOR CONSTRUCTION PLAN, ELEVATIONS & SECTIONS

A2.1 BASEMENT - NEW REFLECTED CEILING PLAN

A2.2 FIRST FLOOR NEW REFLECTED CEILING PLAN

A3.1 EXTERIOR ELEVATIONS

A4.1 BUILDING SECTIONS & DETAILS DOOR & FRAME ELEVATIONS & SCHEDULES

A4.2 SECTIONS AND DETAILS

R1.1 PHASE 2 - ROOF DEMOLITION PLAN LEGEND AND ABBREVIATIONS

R1.2 PHASE 2 - ROOF PLAN TYPICAL SYSTEMS

R2.1 SECTIONS AND DETAILS

R2.2 TYPICAL SYSTEMS SECTIONS

S1.1 STRUCTURAL PLANS, NOTES, AND DETAILS

S2.1 FRONT ENTRY PLANS AND DETAILS

P1.1 BASEMENT PLUMBING DEMOLITION PLAN

P1.2 FIRST FLOOR PLUMBING DEMOLITION PLAN
P2.1 BASEMENT PLUMBING RENOVATION PLAN

P2.2 FIRST FLOOR PLUMBING RENOVATION PLAN

FP1.1 BASEMENT FIRE PROTECTION DEMOLITION PLAN

FP1.2 FIRST FLOOR FIRE PROTECTION DEMOLITION PLAN

FP2.1 BASEMENT FIRE PROTECTION RENOVATION PLAN

FP2.2 FIRST FLOOR FIRE PROTECTION RENOVATION PLAN

M0.1 HVAC LEGEND & ABBREVIATIONS

M0.2 HVAC EQUIPMENT SCHEDULES

M1.1 BASEMENT HVAC DEMOLITION PLAN
M1.2 FIRST FLOOR HVAC DEMOLITION PLAN

M1.3 HVAC DEMOLITION ROOF PLAN

M1.4 FIRST FLOOR HVAC PIPING DEMOLITION PLAN

M2.1 BASEMENT HVAC RENOVATION PLAN

M2.2 FIRST FLOOR HVAC RENOVATION PLAN


M2.3 ROOF HVAC RENOVATION PLAN

8.1 HVAC DETAILS

LIST OF DRAWINGS

- E1.1 BASEMENT ELECTRICAL DEMOLITION PLAN
 E1.2 FIRST FLOOR ELECTRICAL DEMOLITION PLAN
- E1.3 ROOF ELECTRICAL DEMOLITION PLAN
- E2.1 BASEMENT POWER & COMMUNICATION PLAN
- E2.2 BASEMENT LIGHTING PLAN
- E2.3 FIRST FLOOR POWER & COMMUNICATION PLAN
- E2.4 FIRST FLOOR LIGHTING PLAN
- E2.5 BASEMENT FIRE ALARM RENOVATION PLAN
- E2.6 FIRST FLOOR FIRE ALARM RENOVATION PLAN
- E2.7 FIRST FLOOR MECHANICAL POWER PLAN
- E2.8 ROOF ELECTRICAL RENOVATION PLAN
- E3.1 ELECTRICAL PANEL SCHEDULES
- E3.2 ELECTRICAL RISERS & DETAILS
- E3.3 DATA RISER DIAGRAM
- E3.4 ELECTRICAL DETAILS
- PME1.0 FIRE STOP DETAILS


SITE PLAN

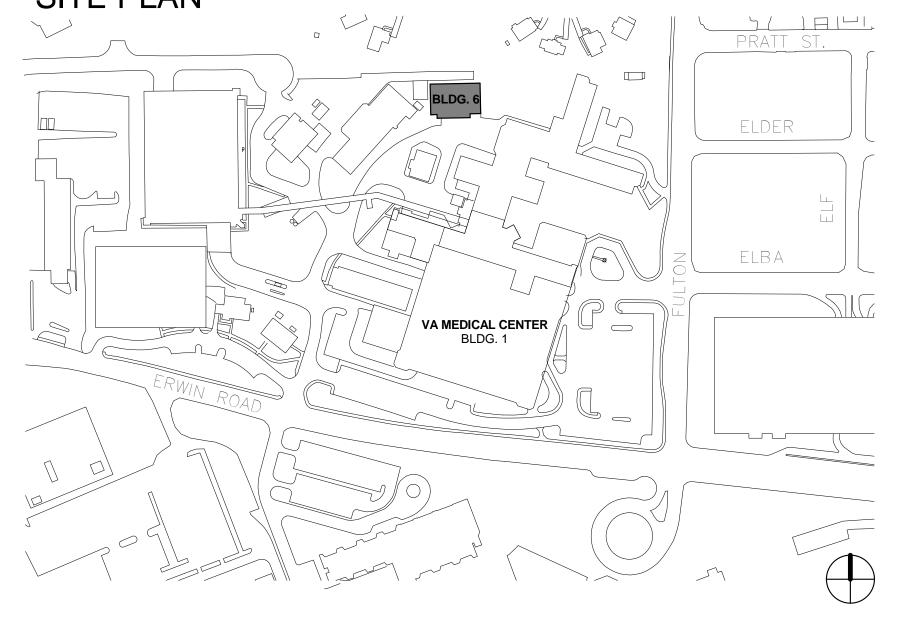

CONSTRUCTION DOCUMENTS

DESTROY ALL

DESTROY ALL

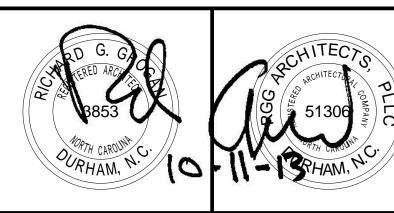

Architects

RGG Architects, PLLC

1002 Broad Street

Durham, North Carolina

27705

919.286.5700

				Drawing Title:
REV.			DATE	TITLE SHE
RECOMMEN	IDED A	APPROVAL		
Requestor:	Date	Chief of Staff:	Date	
				Approved: Chief, E
Chief of Service:	Date	Asst. Med. Ctr. Dir.	Date	
APPROVED BY:			Date	Approved: Infectio
MEDICAL CENTER DIRECTOR				

Project Title:

RENOVATE BUILDING 6 FOR RESEARCH AND ANCILLARY SUPPORT

RESEARCH AND ANCILLARY SUPPORT

Froject Drawing No. 13-E-0X


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Stion Control

Location

VA Medical Center Durham, NC

Sheet 1 of 15

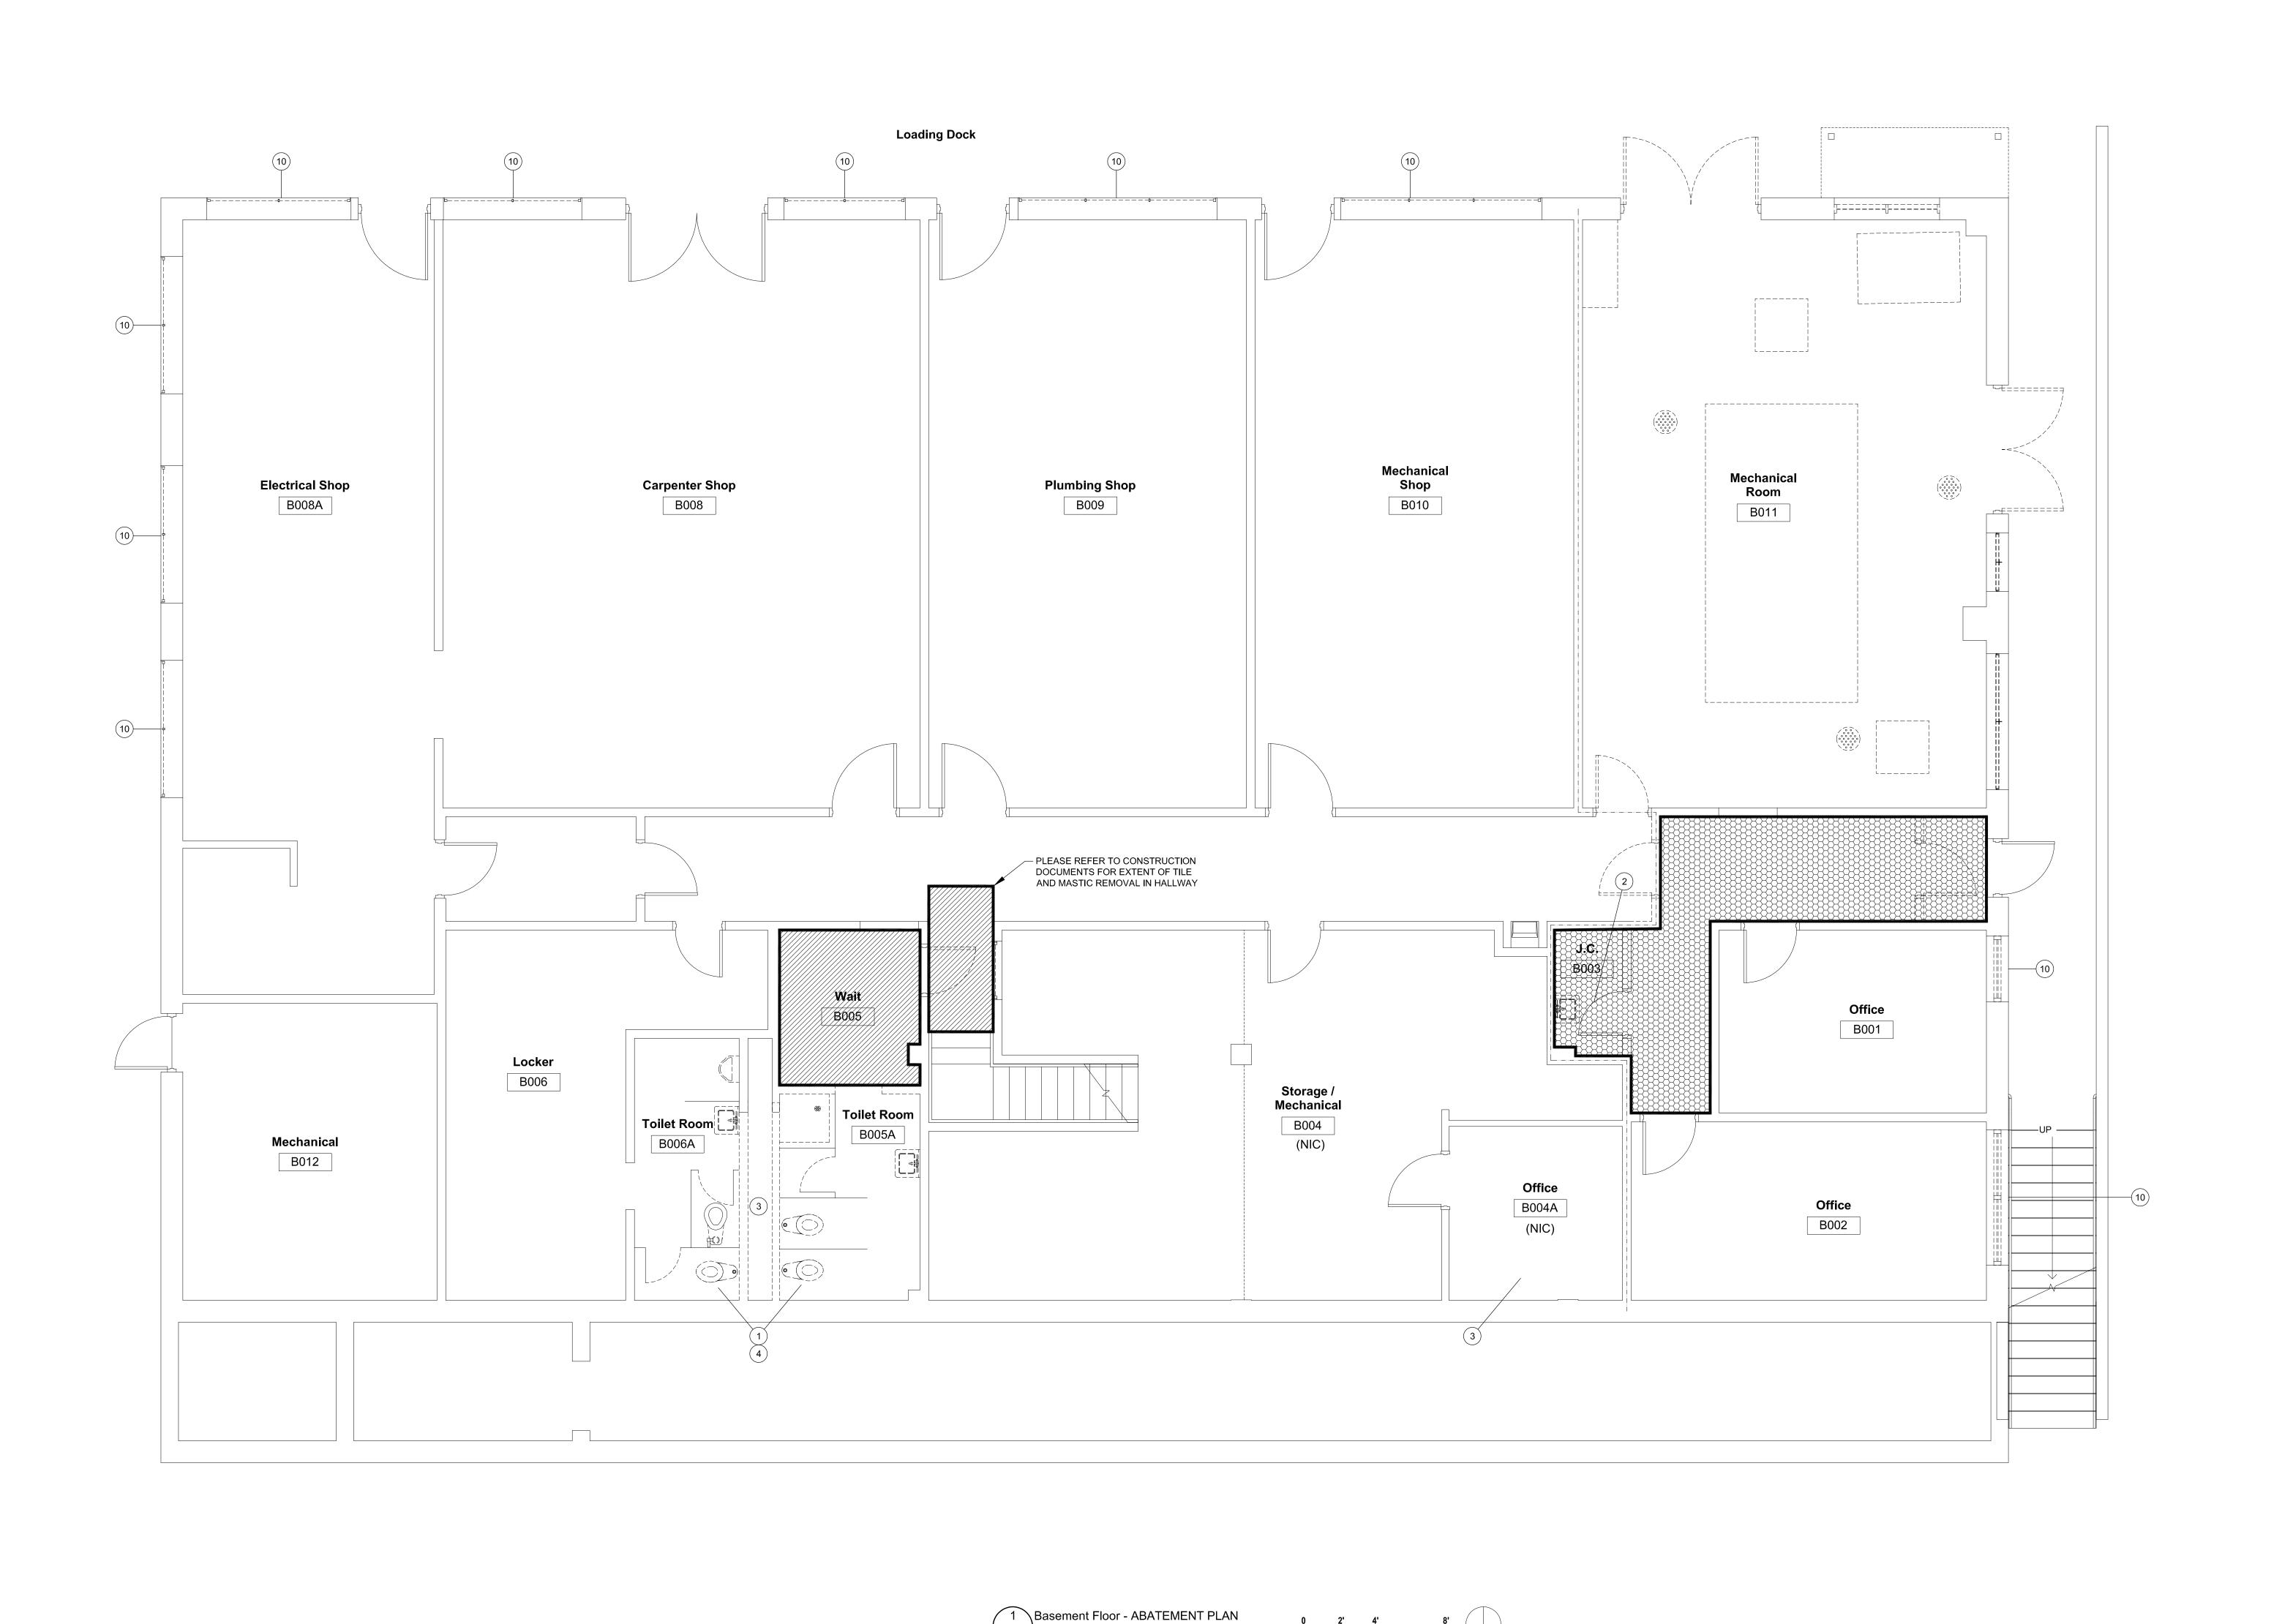

PBAB-1

1/4" = 1'-0"

LEGEND

REMOVE AND DISPOSE OF ASBESTOS-CONTAINING DUCT MASTIC USING NON-FRIABLE, NON-REGULATED REMOVAL TECHNIQUES. (REFER TO SPECS FOR

FOR QUANTITIES)

QUANTITIES)

REMOVE AND DISPOSE OF LEAD CONTAINING TOILETS,

2 REMOVE AND DISPOSE OF LEAD CONTAINING TOILETS AND SINKS. (REFER TO SPECS FOR QUANTITIES)

REMOVE AND DISPOSE OF ASBESTOS-CONTAINING PIPE INSULATION USING GLOVEBAG REMOVAL TECHNIQUES. WALL DEMOLITION IS NECESSARY IN BATHROOMS B005A AND B006A TO ACCESS PIPE INSULATION LOCATED IN CHASE BETWEEN BATHROOMS. (REFER TO SPECS FOR QUANTITIES)

SINKS AND CERAMIC BASEBOARDS. (REFER TO SPECS

- REMOVE AND DISPOSE OF ASBESTOS-CONTAINING PIPE INSULATION USING GLOVEBAG REMOVAL TECHNIQUES. HEPA VACUUM DEBRIS LOCATED ON TOP OF DUCT AND WALL IN BATHROOM B005A. (REFER TO SPECS FOR QUANTITIES)
- REMOVE AND DISPOSE OF EXTERIOR WINDOW AND STOREFRONT CAULKING USING NON-FRIABLE, NON-REGULATED REMOVAL TECHNIQUES. (REFER TO SPECS FOR QUANTITIES)


SCOPE OF WORK

- THIS DRAWING ACCOMPANIES ASBESTOS FLOOR TILE AND MASTIC SPECIFICATIONS (02 82 13.19), ASBESTOS GLOVEBAG ABATEMENT SPECIFICATIONS (02 82 13.13) AND LEAD-BASED PAINT REMOVAL AND DISPOSAL TECHNICAL SPECIFICATIONS (02 83 33.13).
- ASBESTOS ABATEMENT MUST BE PERFORMED INSIDE BOUNDARIES INDICATED ON THIS DRAWING.
- 3. THE ABATEMENT CONTRACTOR SHALL BE RESPONSIBLE FOR INSPECTING THE SITE PRIOR TO BIDDING TO CONFIRM THE SCOPE OF THE WORK. BOUNDARIES AND LOCATIONS ARE APPROXIMATE. ANY QUANTITIES LISTED BY THE DESIGNER IN THE PLANS AND SPECIFICATIONS ARE DONE SO AS APPROXIMATIONS. THE ACTUAL QUANTITIES OF ASBESTOS-CONTAINING MATERIAL TO BE ENCOUNTERED ARE THE RESPONSIBILITY OF THE ABATEMENT CONTRACTOR.
- 4. THE SCOPE OF WORK FOR THIS PROJECT INCLUDES THE REMOVAL AND DISPOSAL OF ASBESTOS-CONTAINING FLOOF TILE, FLOOR TILE MASTIC, DUCT MASTIC, PIPE INSULATION, PIPE INSULATION DEBRIS, SINK MASTIC, WALL CAULKING, WINDOW CAULK, ROOF FLASHING MASTIC AND LEAD CONTAINING MATERIALS.
- SEE ARCHITECTURAL DRAWINGS FOR DEFINITION OF ALTERNATE BID ITEMS IF APPLICABLE.

CONSTRUCTION DOCUMENTS

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MATRIX Health & Safety Consultants, L.L.C.	BAA					Drawing Title:	Project Title				Date 10/11/2013
Health & Safety Consultants, L.L.C.	KGG	REV.			DATE	BASEMENT - ASBESTOS ABATEMENT		ENOVATE E RCH AND A		6 FOR Y SUPPORT	Project No. 130948
		RECON	MMENDED A	APPROVAL			1				Project Drawing No.
	Architects	Requestor:	Date	Chief of Staff:	Date						
	RGG Architects, PLLC &					Approved: Chief, Engineering Service	Building No.	Designed By:	Drawn By:	Checked By:	DRAWING NO.
	1002 Broad Street 2 Durham, North Carolina	Chief of Service:	Date	Asst. Med. Ctr. Dir.	Date		6	MATRIX	ACS	MATRIX	PBAB-1
GREGG HEPPERT	27705 27 919.286.5700 <u>2</u>	APPROVED BY:			Date	Approved: Infection Control	Location	VA M	edical Cent	ter	
N.C. ASBESTOS DESIGNER NO 40357		MEDICAL CENTER DIREC	CTOR					Du	ırham, NC		Sheet 1 Of 2

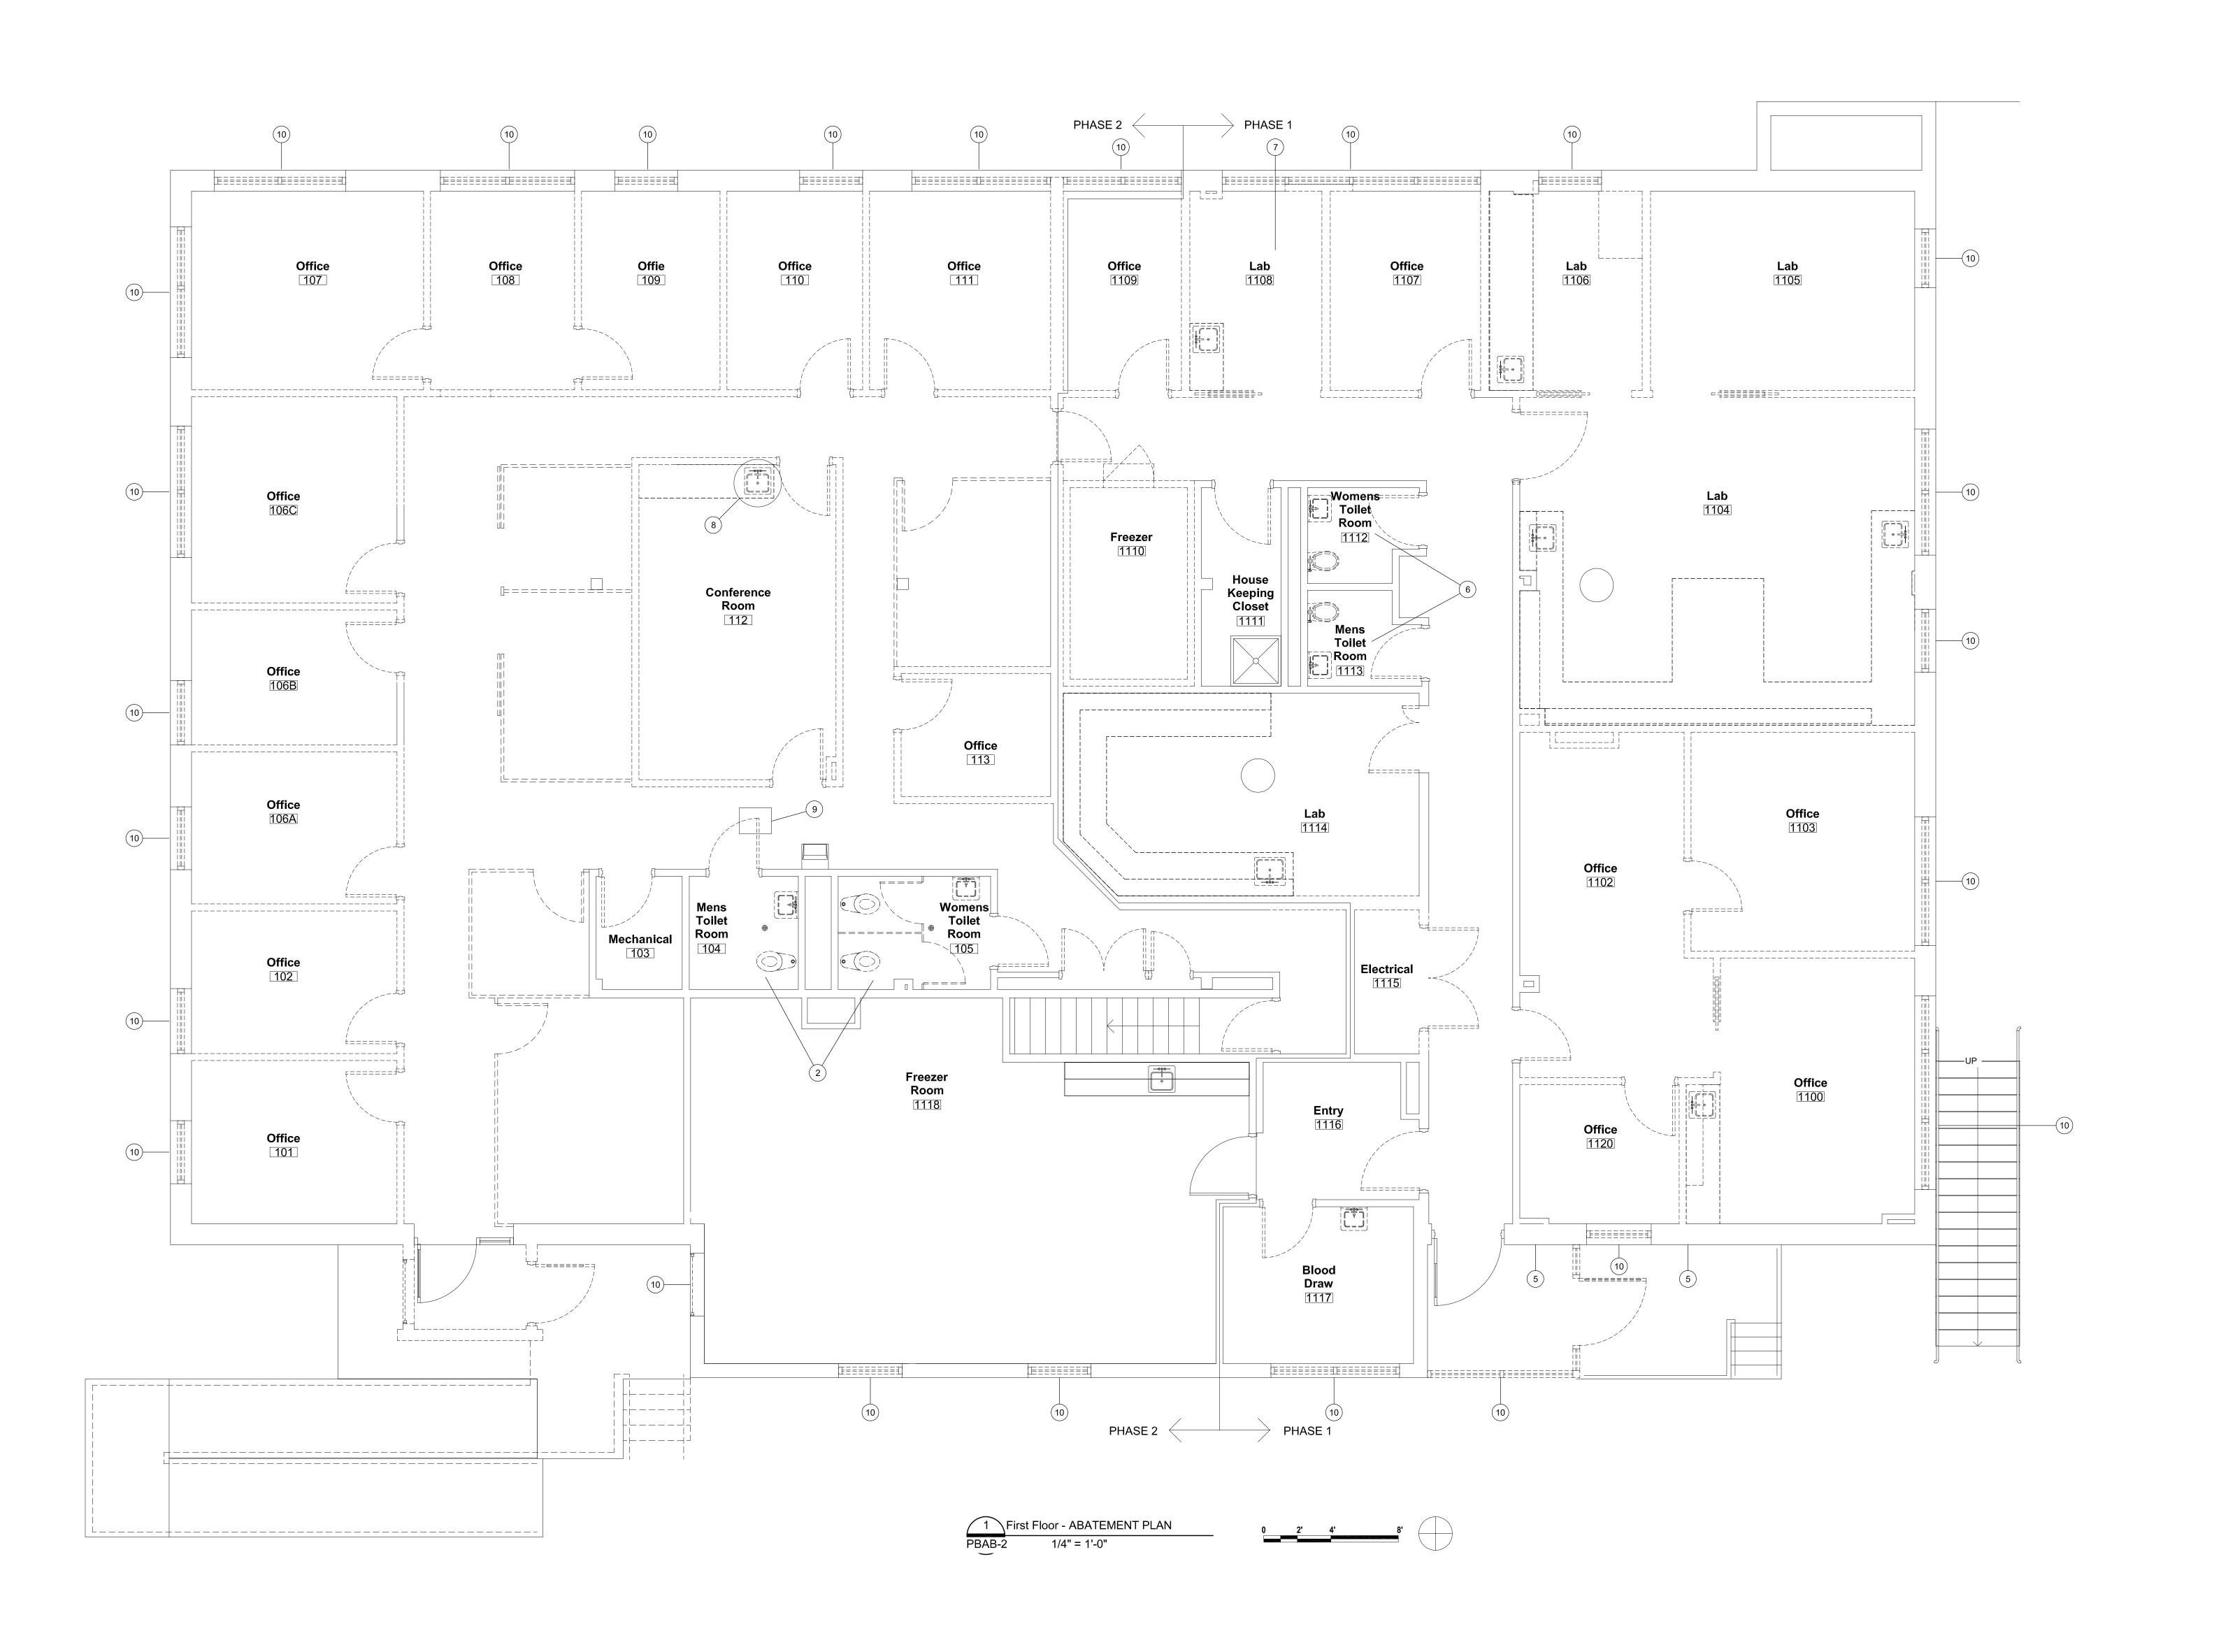

LEGEND

- REMOVE AND DISPOSE OF LEAD CONTAINING TOILETS AND SINKS. (REFER TO SPECS FOR QUANTITIES)
- REMOVE ASBESTOS-CONTAINING GRAY WALL CAULKING USING NON-FRIABLE, NON-REGULATED REMOVAL TECHNIQUES. (REFER TO SPECS FOR QUANTITIES)
- REMOVE AND DISPOSE OF LEAD CONTAINING TOILETS, SINKS AND CERAMIC WALLS. (REFER TO SPECS FOR OLIANTITIES)
- REMOVE AND DISPOSE OF LEAD CONTAINING CERAMIC WALLS. (REFER TO SPECS FOR QUANTITIES)
- DISPOSE OF SINK WITH ASBESTOS-CONTAINING
 MASTIC USING NON-FRIABLE, NON-REGULATED
 REMOVAL TECHNIQUES. (REFER TO SPECS FOR

QUANTITIES)

- 9 REMOVE AND DISPOSE OF BLACK ROOFING MASTIC AT DUCT PENETRATING ROOF MASTIC USING NON-FRIABLE, NON-REGULATED REMOVAL TECHNIQUES. (REFER TO SPECS FOR QUANTITIES)
- REMOVE AND DISPOSE OF EXTERIOR WINDOW AND STOREFRONT CAULKING USING NON-FRIABLE, NON-REGULATED REMOVAL TECHNIQUES. (REFER TO SPECS FOR QUANTITIES)
- ROOF REMOVE AND DISPOSE OF ROOFING FLASHING MASTIC LOCATED AT PERIMETER OF ROOF AND ROOF PENETRATIONS USING NON-FRIABLE, NON-REGULATED REMOVAL TECHNIQUES. (REFER TO SPECS FOR QUANTITIES)


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CONSTRUCTION DOCUMENTS

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Health & Safety Consultants, L.L.C.	KGG	REV.			DATE	FIRST FLOOR - ASBESTOS ABATEMENT			BUILDING (ANCILLARY	3 FOR ′ SUPPORT	Project No. 130948
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	Architects	Requestor:	Date	Chief of Staff:	Date		ļ				
	RGG Architects PLLC ©					Approved: Chief, Engineering Service	Building No.	Designed By:	1		DRAWING NO.
	1002 Broad Street 2 Durham, North Carolina	Chief of Service:	Date	Asst. Med. Ctr. Dir.	Date		6	MATRIX	ACS	MATRIX	PBAB-2
GREGG HEPPERT	27705 27909 919.286.5700	APPROVED BY:	•	•	Date	Approved: Infection Control	Location		edical Cent	er	
N.C. ASBESTOS DESIGNER NO.40357		MEDICAL CENTER DIRE	CTOR					Du	rham, NC		Sheet 2 Of 2



Life Safety Plan Legend

1-Hour Fire Barrier

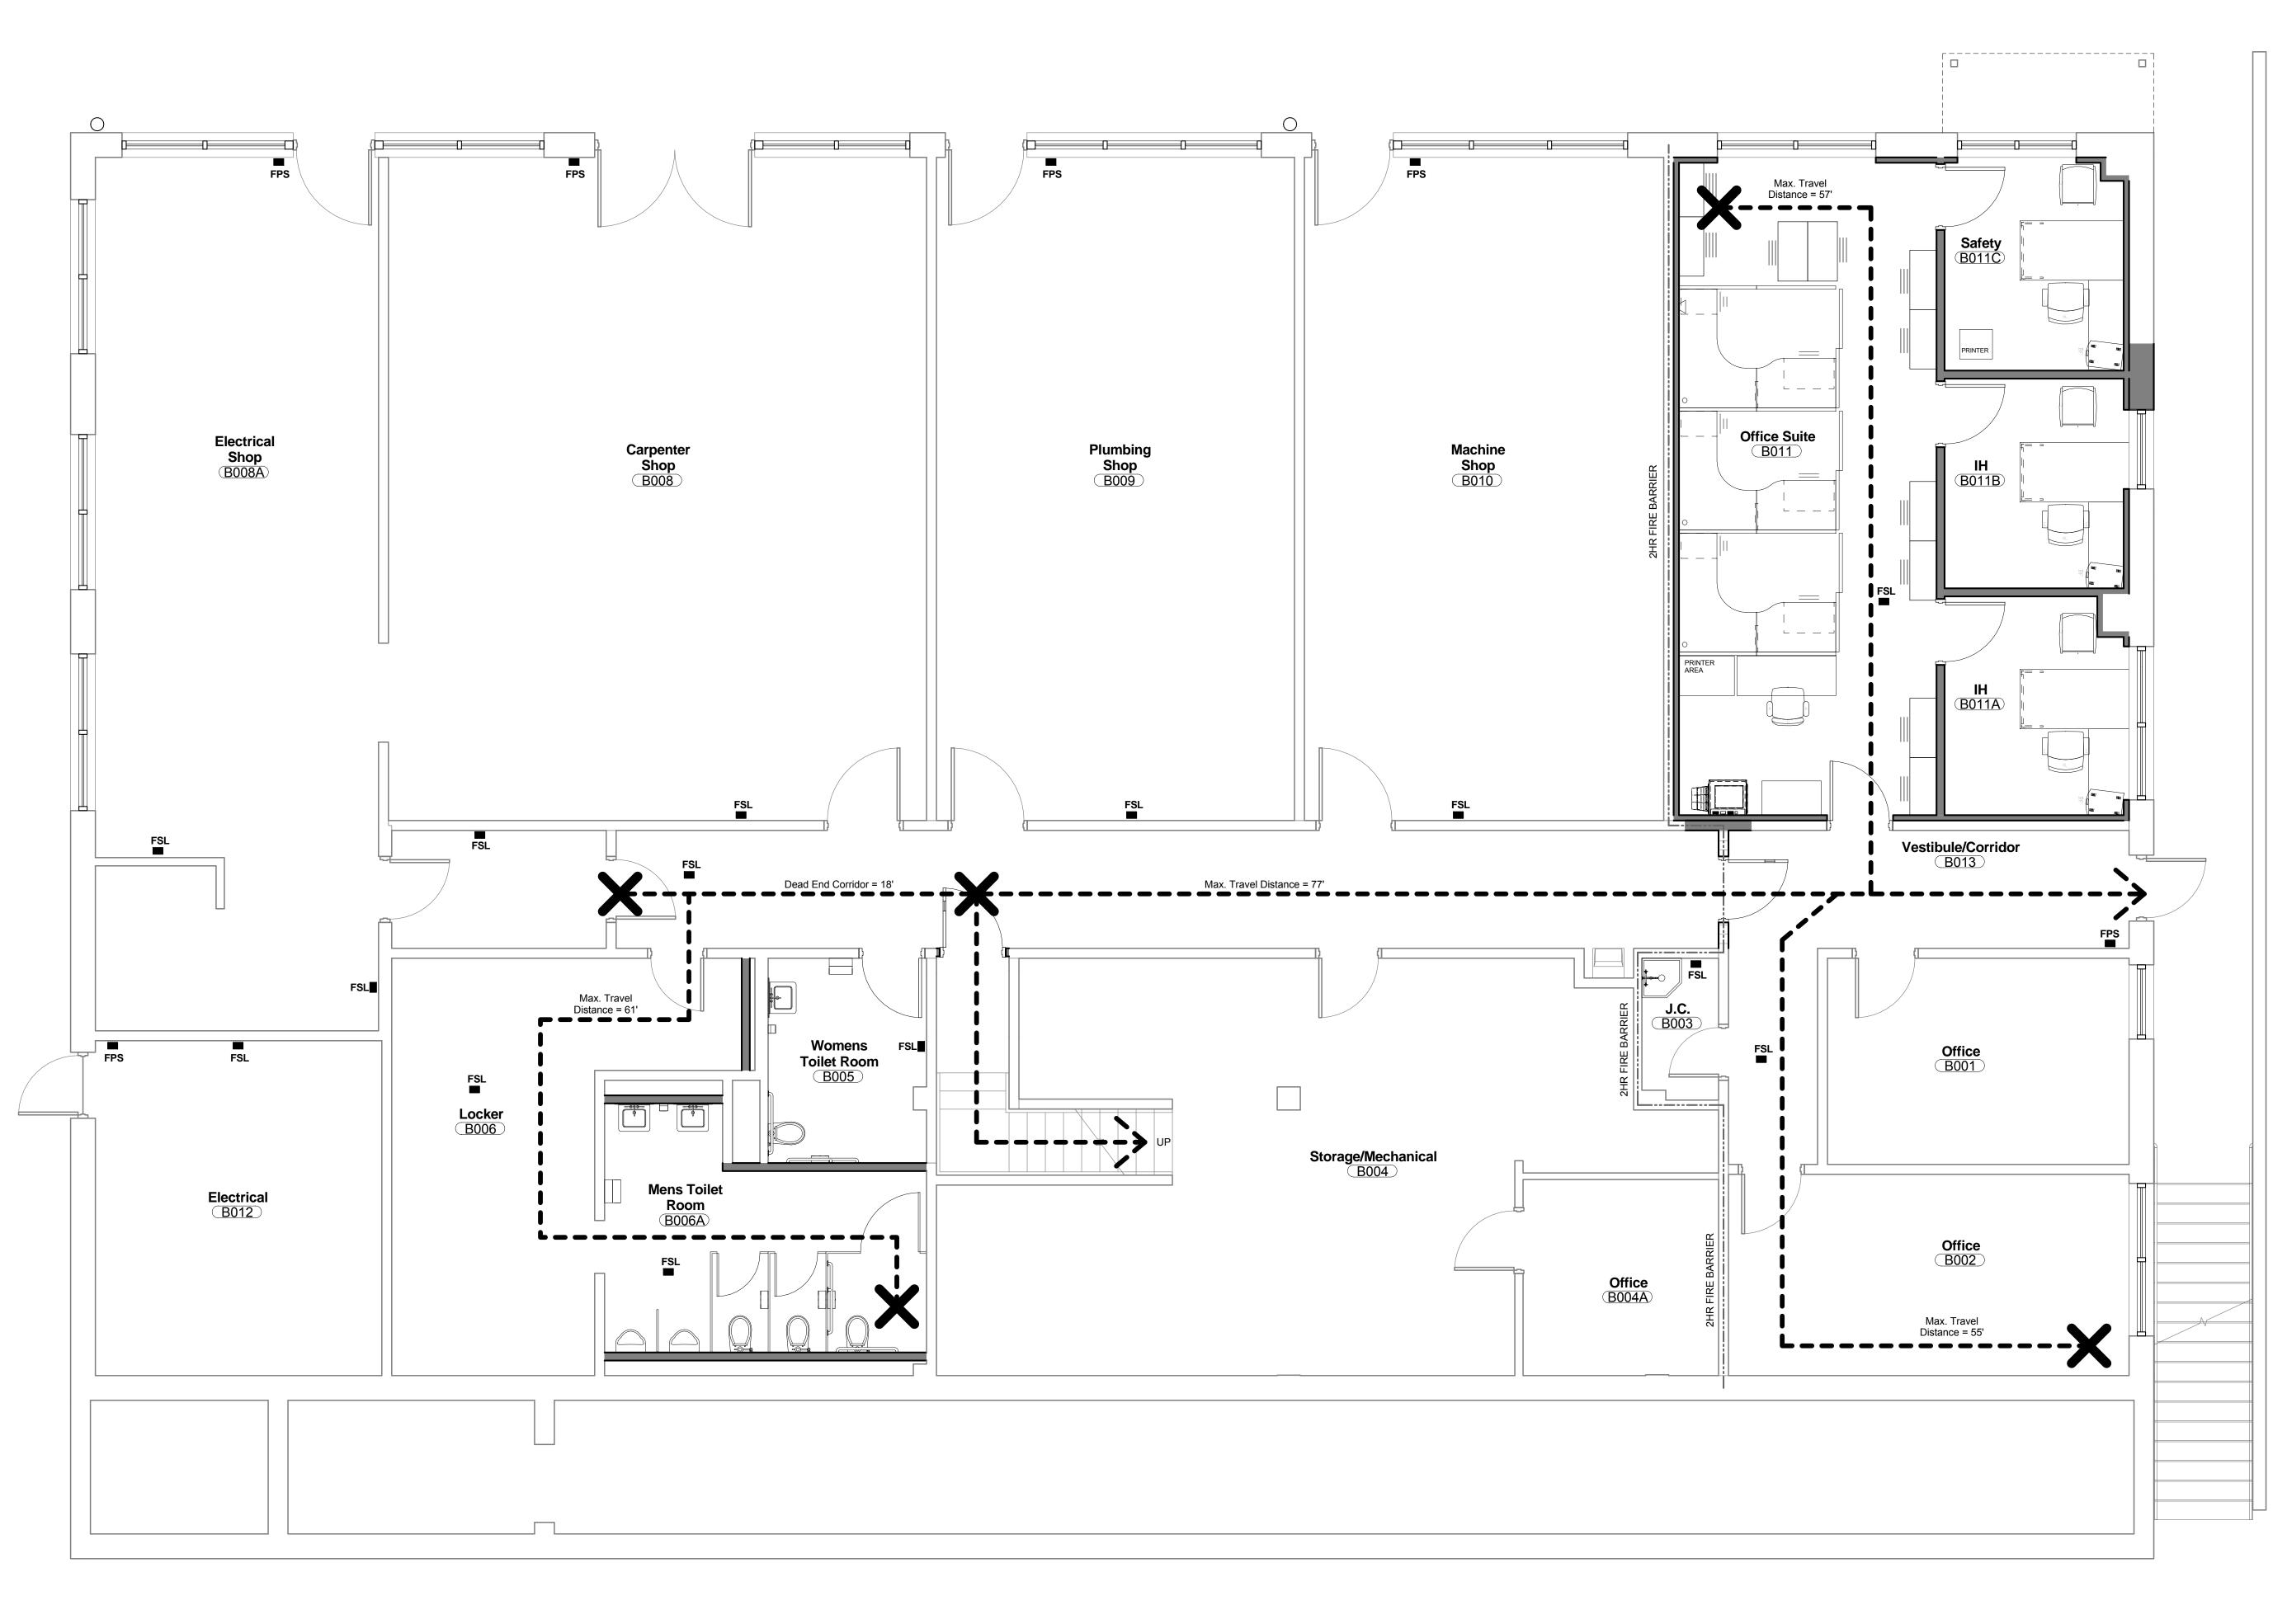2-Hour Fire Barrier

Egress Path

Egress Start/Finish

FEC Fire Extinguisher Cab.

FPS Fire Pull Station

FSL Max. Travel Distance

CODE SUMMARY

BUILDING TYPE: IIB SPRINKLED

MIXED USE: TYPE BUILDING MAX.
FIRST FLOOR B 6,677 S.F. 23,000 S.F.

BASEMENT B 1,584 S.F.
F-1 4,737 S.F. 15,000 S.F.

COMMON PATH OF TRAVEL MAX: 100 L.F. w/ SPRINKLERS

MAX. EXIT TRAVEL DISTANCE300 L.F. w/ SPRINKLERS


MAX. OCCUPANT LOAD FOR 1 EXIT (BASEMENT 'B'): 49 PERSONS ACTUAL OCCUPANCY: 16 PERSONS

EGRESS WIDTH:
BUSINESS 100 S.F./PERSON GROSS
6677 / 100 = 66.77 X 0.3" = 20.33"

1 Basement Floor - LIFE SAFETY PLAN
LS1.1 1/4" = 1'-0"

CONSTRUCTION DOCUMENTS

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	RECOMMENDED APPROVAL							
	Requestor:	Date	Chief of Staff:	Date				
,					Approved:			
. 12-1	Chief of Service:	Date	Asst. Med. Ctr. Dir.	Date				
	APPROVED BY:			Date	Approved:			
5	MEDICAL CENTER DIRECTOR							

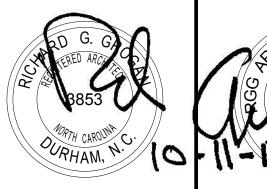Date

Date

Date

Approved: Chief, Engineering Service

Date

Date

Approved: Infection Control

Date

Approved: Infection Control

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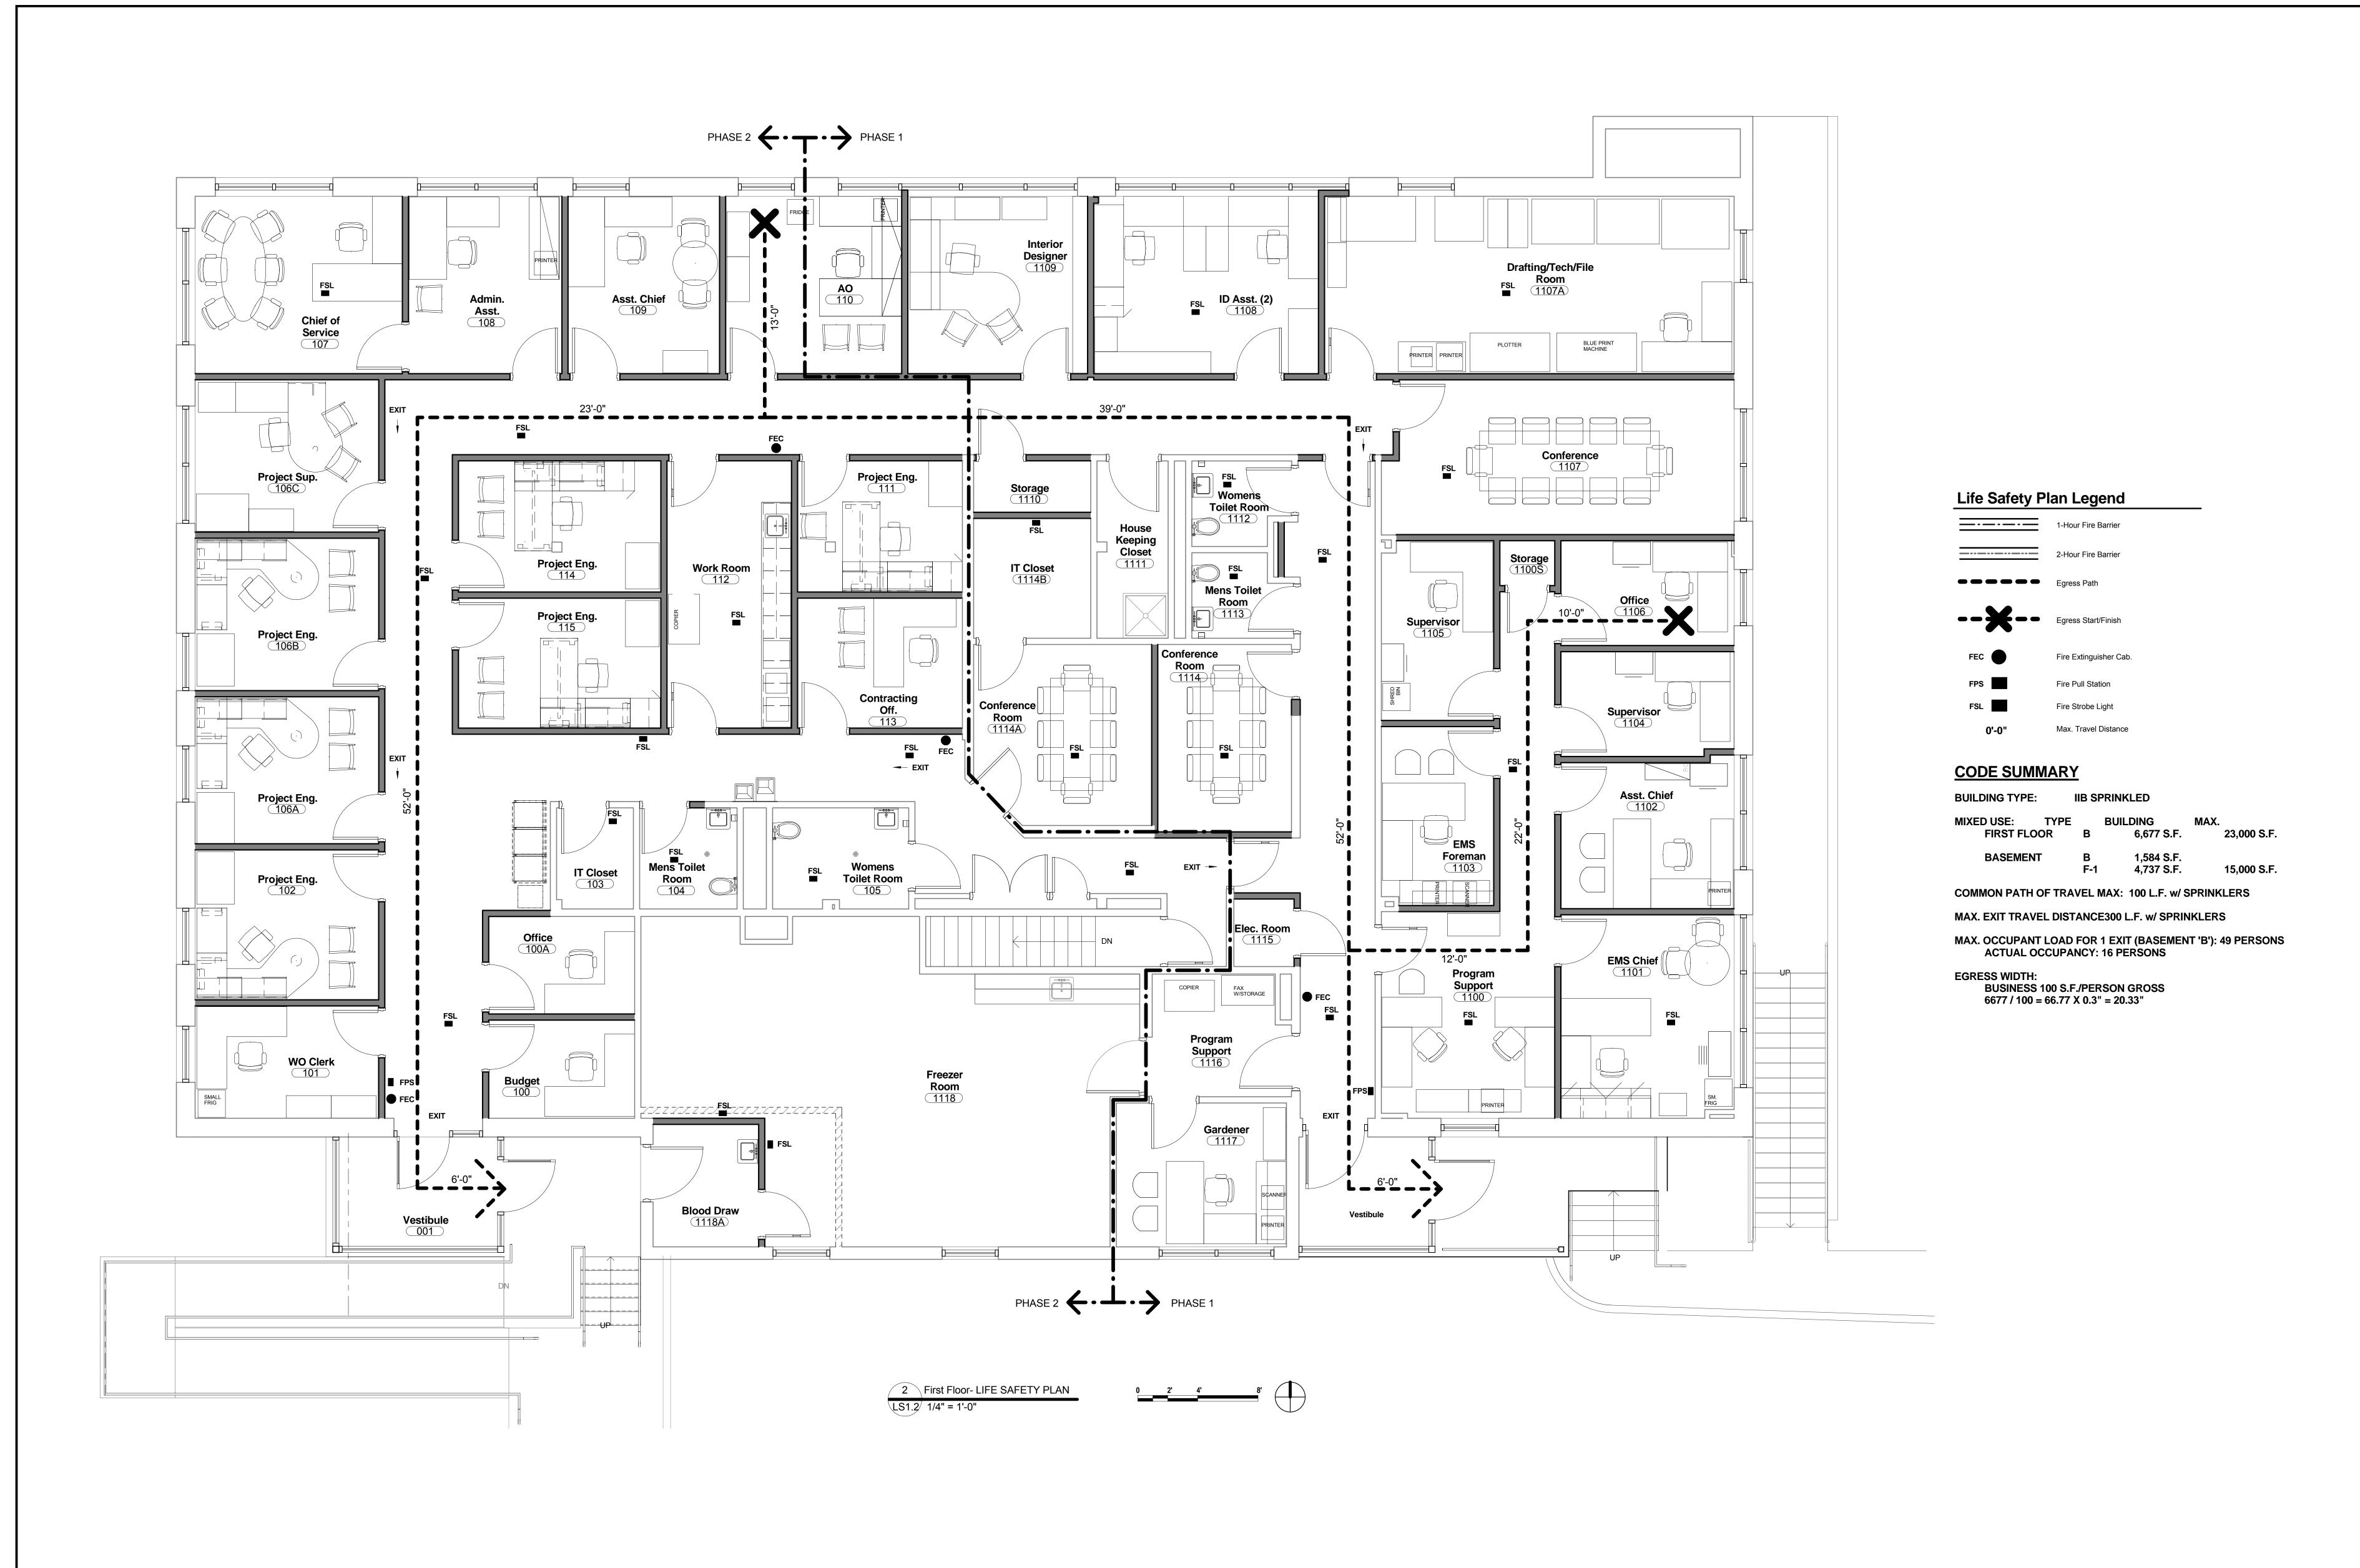
Approved: Infection Control

Date


Approved: Infection Control

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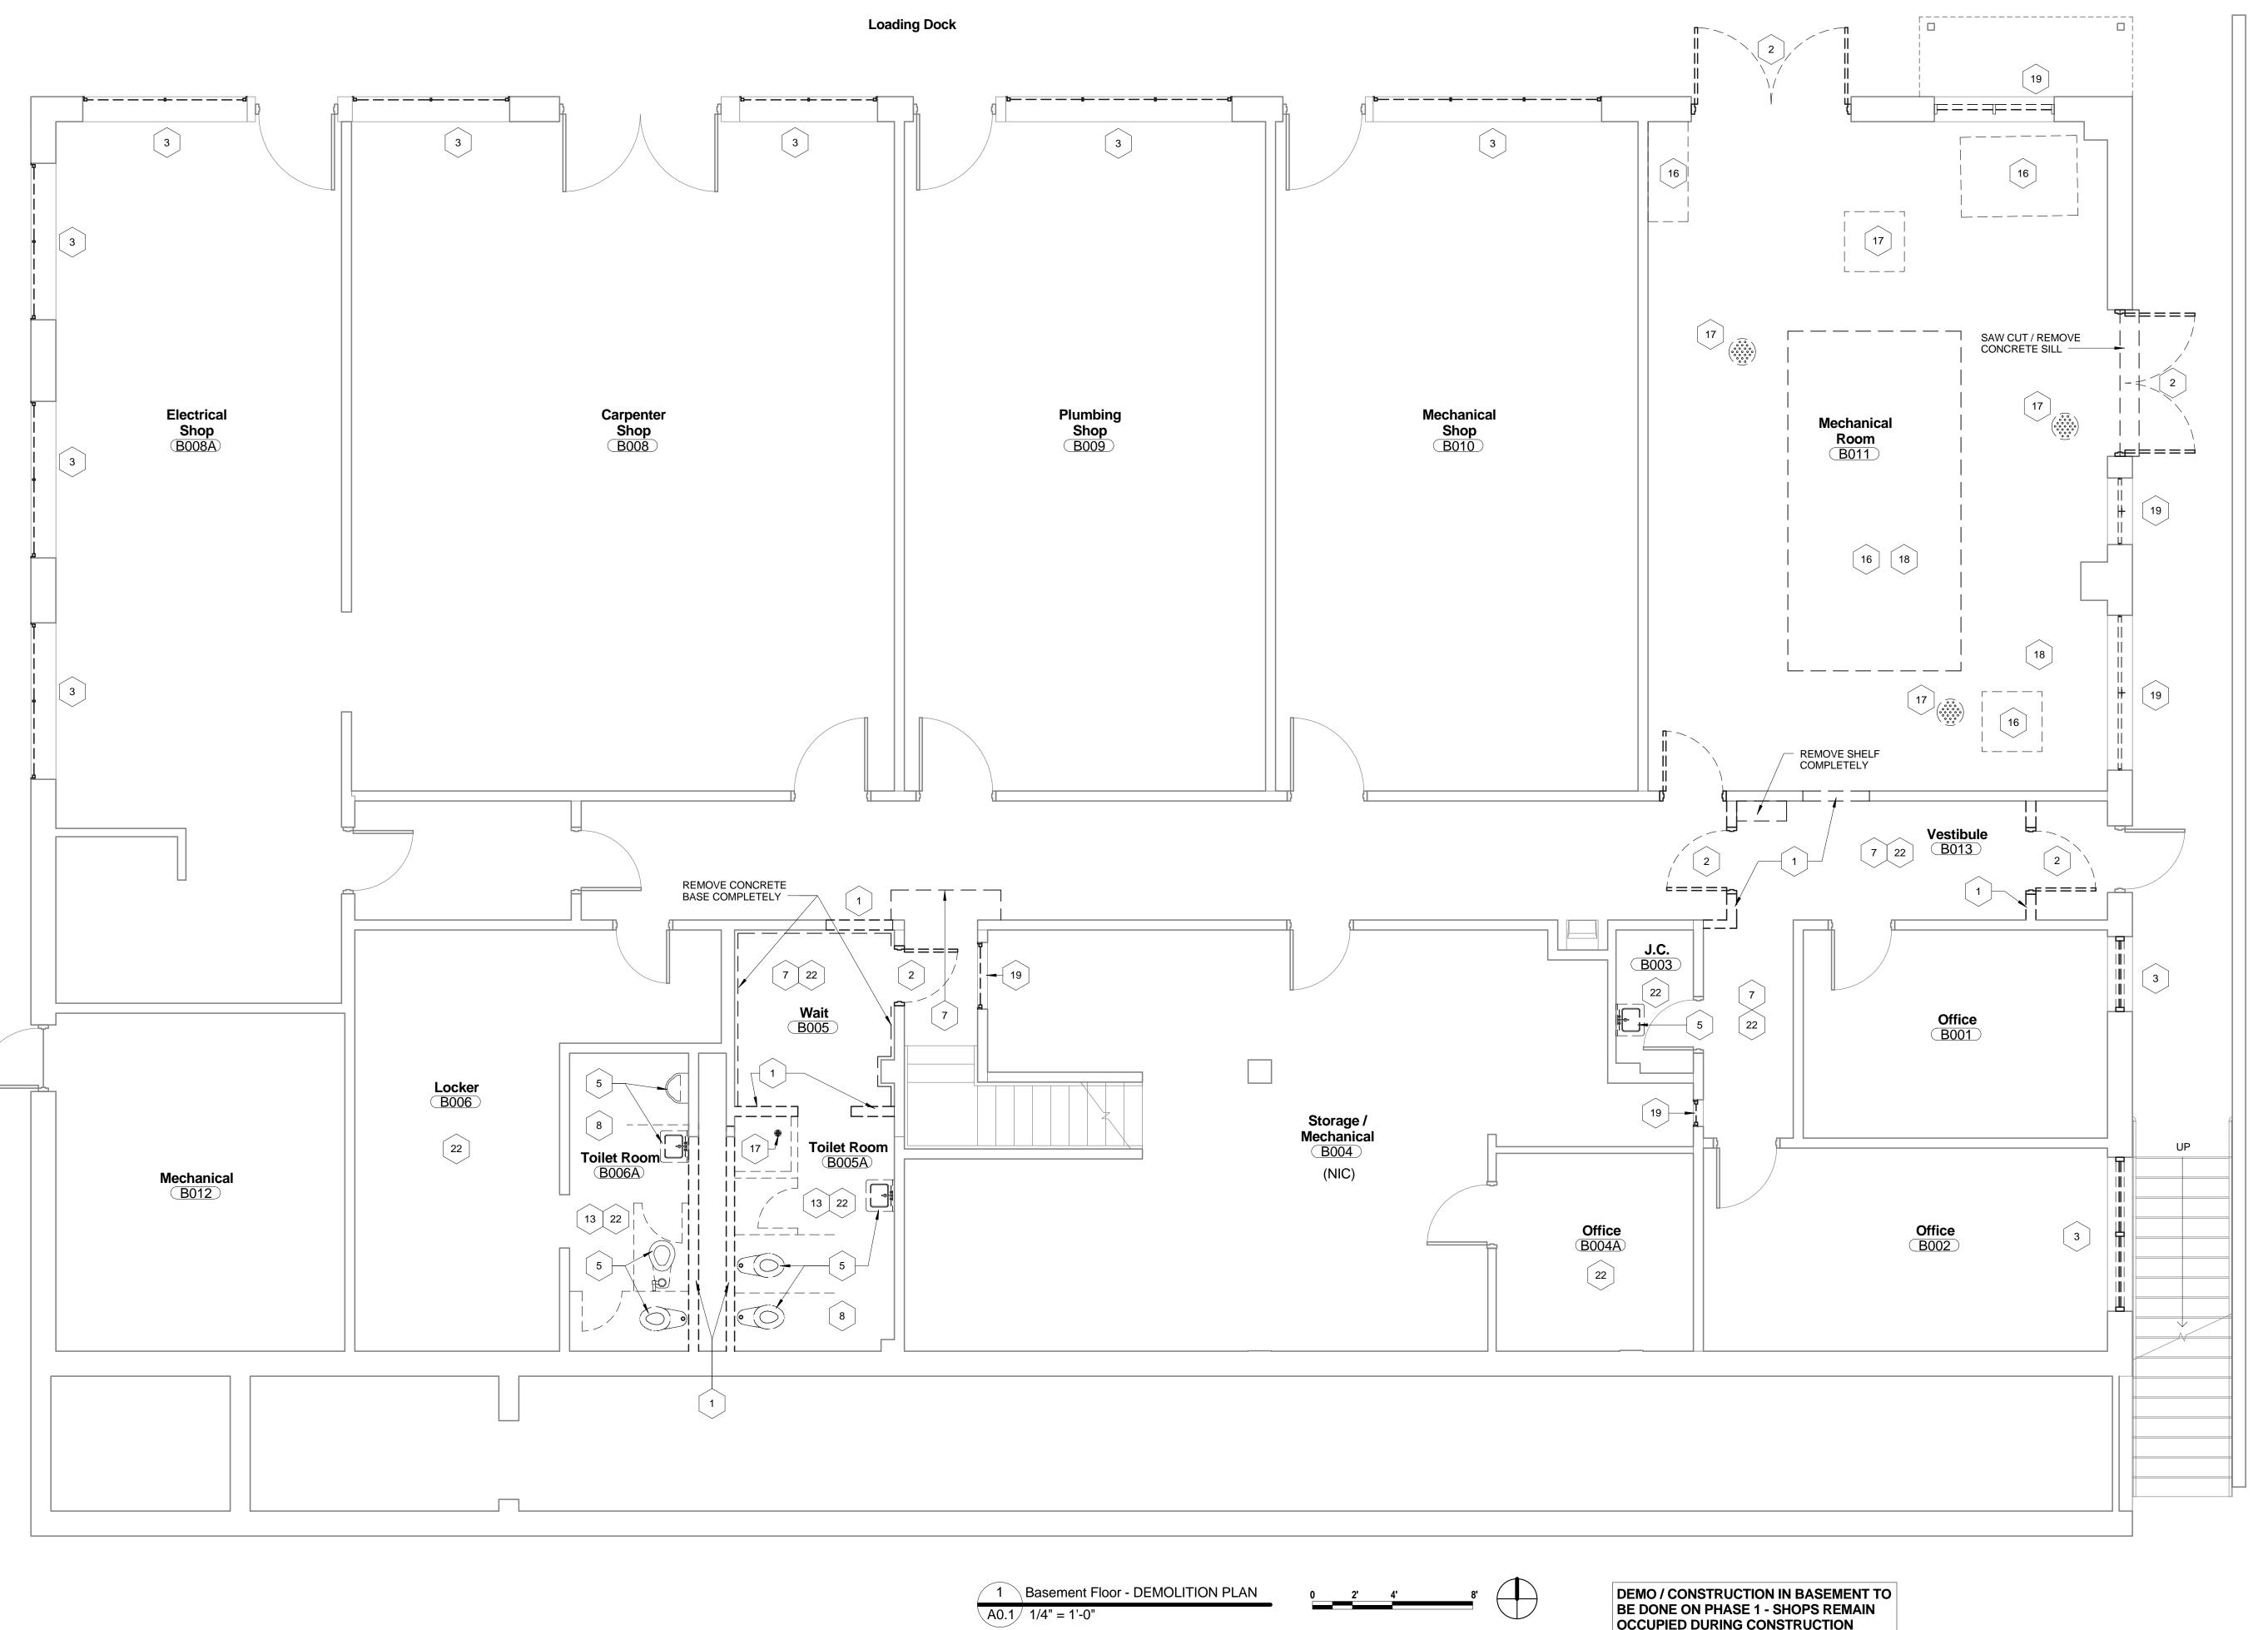






Approved: Infection Control

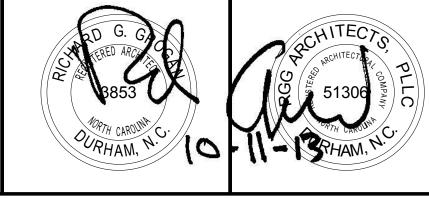Date 10/11/2013 FIRST FLOOR LIFE SAFETY PLANS RESEARCH AND ANCILLARY SUPPORT Project No. 558-13-101 Project Drawing No. 13-E-0X Approved: Chief, Engineering Service DRAWING NO. RQA LS1.2 **VA Medical Center** Durham, NC



STATEMENT OF BID ITEMS

A: BASE BID: SELECTED DEMOLITION AND NEW CONSTRUCTION TO RENOVATE BUILDING 6, INCLUDING NEW WALLS, CEILINGS, FINISHES, PLUMBING, MECHANICAL, ELECTRICAL, ROOF REPLACEMENT, WINDOW REPLACEMENT, AND NEW ENTRY VESTIBULES.

B: ALTERNATES:

ALTERNATE 1: DEDUCT ALL COST ASSOCIATED WITH WINDOW REPLACEMENT.

ALTERNATE 2: DEDUCT ALL COST ASSOCIATED WITH NEW ENTRY VESTIBULES (2) INCLUDING CONCRETE WORK, STORE FRONT, AND CANOPY ROOF SYSTEM - EXISTING CANOPY AND STOREFRONT SHALL REMAIN.

ALTERNATE 3: DEDUCT ALL COST ASSOCIATED WITH BASEMENT MEN'S TOILET ROOM B006A AND

WOMEN'S TOILET ROOM B005.

ALTERNATE 4: DEDUCT ALL COST ASSOCIATED WITH BLOOD DRAW ROOM 1118A INCLUDING NEW EXTERIOR ENTRY DOOR. ADD NEW REPLACEMENT WINDOW UNIT AT EXISTING WINDOW.

OCCUPIED DURING CONSTRUCTION

Wall Legend

EXISTING CONSTRUCTION EXISTING 2-HOUR FIRE BARRIER DEMOLISHED CONSTRUCTION TEMPORARY CONSTRUCTION NEW CONSTRUCTION

NEW 2-HOUR FIRE BARRIER

GENERAL DEMOLITION NOTES:

CMU CONSTRUCTION

- PROVIDE 1 HR SMOKE TIGHT FIRE RATED PARTITION IN CORRIDOR TO SEPARATE PROJECT CONSTRUCTION FROM BUILDING USERS.
- PROVIDE WALK OFF MATS AT PROJECT ENTRANCE. KEEP CORRIDOR CLEAN OF DEBRIS. MOP FLOORS AS REQUIRED TO KEEP DIRT TO A MINIMUM.
- REMOVE ALL MISC. ITEMS ATTACHED TO WALLS, AND PREPARE WALLS TO RECEIVE NEW FINISHES.
- REMOVE VINYL WALL COVERING COMPLETELY ON ALL EXISTING WALLS TO REMAIN, PATCH AND REPAIR WALLS AS NEEDED FOR NEW PAINT.
- 5. EXISTING BASEMENT WALLS ARE MASONRY W/ PLASTER.

DEMOLITION LEGEND

- 1 REMOVE EXISTING WALL TO LIMITS SHOWN
- 2 REMOVE EXISTING DOOR AND FRAME COMPLETELY
- REMOVE EXISTING WINDOW UNIT AND PREPARE FOR NEW WINDOW INSTALLATION (FIRST FLOOR DEMOLITION INCLUDES REMOVAL OF GYP. BD. / METAL STUD BÙLK HEAD, GYP. BD. JAMB AND WINDOW STOOL). COORDINATE W/ ASBESTOS ABATEMENT.
- 4 REMOVE EXISTING CASEWORK AND SHELVING COMPLETELY
- 5 REMOVE FIXTURES COMPLETELY, SEE PLUMBING DWGS.
- 6 REMOVE EXISTING CARPET AND RUBBER BASE COMPLETELY
- REMOVE EXISTING VCT AND RUBBER BASE COMPLETELY
- 8 REMOVE EXISTING PORCELAIN FLOOR TILE AND MORTAR BED COMPLETELY
- REMOVE EXISTING WALL TILE COMPLETELY. PATCH AND REPAIR WALLS AS NEEDED TO RECEIVE NEW FINISHES.
- REMOVE EXISTING CUBICLE FURNITURE SYSTEM COMPLETELY -SALVAGE AND RETURN TO VAMC
- REMOVE EXISTING EMERGENCY SHOWER COMPLETELY, SEE PLUMBING DWGS.
- 12 REMOVE EXISTING FREEZER COMPLETELY (INCLUDING CEILING ABOVE)
- 13 REMOVE EXISTING TOILET PARTITIONS COMPLETELY
- REMOVE EXISTING GYP. BD. CEILING COMPLETELY
- 15 REMOVE EXISTING DOOR ONLY, H.M. FRAME TO REMAIN
- 16 REMOVE EXISTING 4" RAISED CONCRETE PAD
- 17 EXISTING FLOOR DRAIN TO BE CAPPED SEE PLUMBING DWGS.
- 18 ALL MECHANICAL EQUIPMENT TO BE REMOVED SEE MECHANICAL DWGS.
- 19 REMOVE EXISTING METAL LOUVER. COORDINATE WITH ASBESTOS ABATEMENT.
- 20 REMOVE EXISTING CONCRETE PAD & STEPS
- 21 REMOVE EXISTING METAL PIPE RAIL TO LIMITS SHOWN
- 22 REMOVE EXISTING LAY-IN CEILING TILE AND GRID COMPLETELY
- REMOVE EXISTING WINDOW UNIT AND MASONRY WALL BELOW FOR NEW DOOR AND FRAME.
- 24 REMOVE EXISTING WATER FOUNTAIN COMPLETELY
- 25 REMOVE EXISTING STOREFRONT SYSTEM COMPLETELY
- 26 REMOVE EXISTING ROOF CANOPY COMPLETELY

ASBESTOS WARNING:

MATERIALS CONTAINING ASBESTOS ARE KNOWN TO EXIST IN THIS FACILITY, INCLUDING FLOOR TILE, AND/OR BLACK MASTIC, DUCT MASTIC, PIPE INSULATION, CAULKING/SEALANTS AT EXTERIOR WINDOWS AND STOREFRONT, AND ROOF MASTIC IN THE EVENT ASBESTOS CONTAINING MATERIALS ARE ENCOUNTERED IN THIS PROJECT THAT HAVE NOT BEEN PREVIOUSLY DOCUMENTED, THE CONTRACTOR WILL IMMEDIATELY CEASE WORK IN THE INVOLVED AREA, SECURE THE AREA TO PREVENT INADVERTENT CONTAMINATION OR EXPOSURE, AND NOTIFY THE COR. UNDER NO CIRCUMSTANCES WILL THE CONTRACTOR DISTURB ASBESTOS CONTAINING MATERIALS.

LEAD BASED MATERIAL WARNING:


EXIST ON BUILDING STRUCTURE(S) OR OTHER ITEMS IN THE CONSTRUCTION AREA. THE CONTRACTOR IS HEREBY ADVISED OF THE NEED FOR COMPLIANCE WITH OSHA STANDARD 1926.62 SUBPART D, TITLED "LEAD", [29 CFR 1910] DURING WORK WITH ALL LEAD CONTAINING MATERIALS.

> CONSTRUCTION DOCUMENTS DESTROY ALL PREVIOUS COPIES

RGG






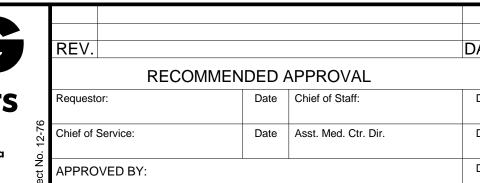

MEDICAL CENTER DIRECTOR

BASEMENT - DEMOLITION PLAN RENOVATE BUILDING 6 FOR RESEARCH AND ANCILLARY SUPPORT 558-13-101 pproved: Chief, Engineering Service uilding No. Designed By: Drawn By: RGG Approved: Infection Control VA Medical Center Durham, NC

10/11/2013 13-E-0X DRAWING NO. **| A0.**1

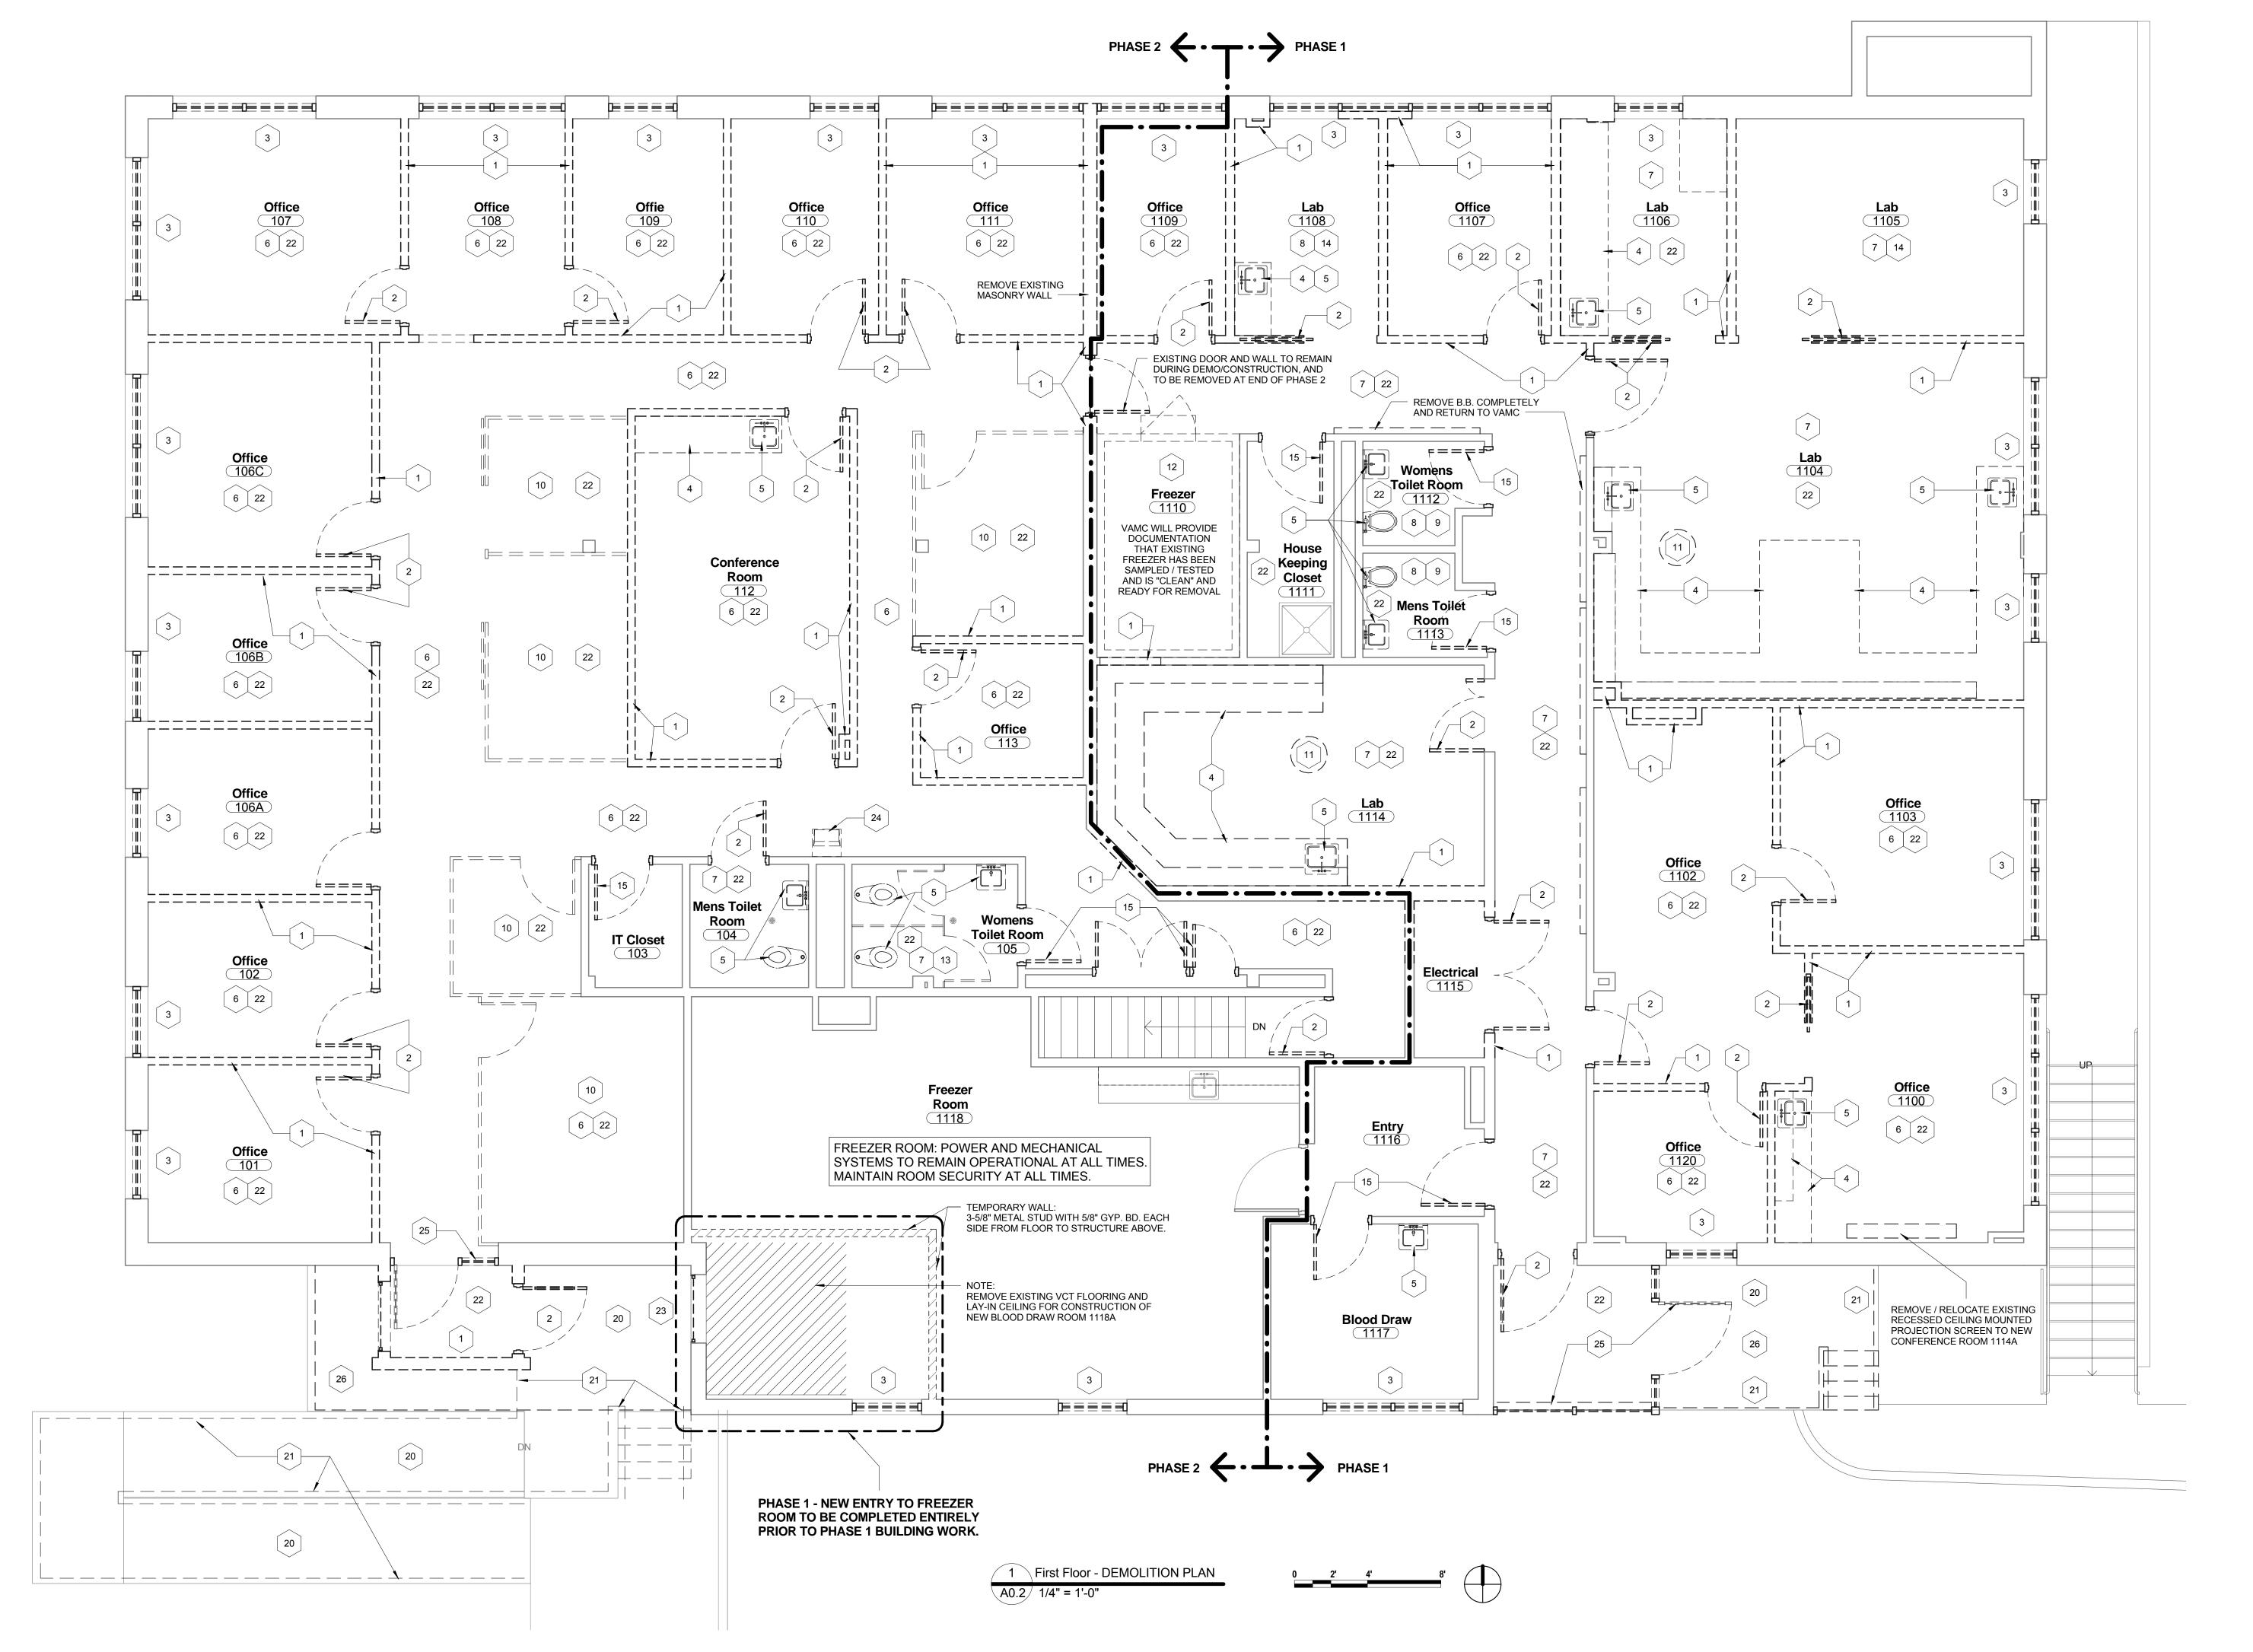

Wall Legend **EXISTING CONSTRUCTION** EXISTING 2-HOUR FIRE BARRIER _----DEMOLISHED CONSTRUCTION TEMPORARY CONSTRUCTION NEW CONSTRUCTION NEW 2-HOUR FIRE BARRIER

GENERAL DEMOLITION NOTES:

CMU CONSTRUCTION

- PROVIDE 1 HR SMOKE TIGHT FIRE RATED PARTITION IN CORRIDOR TO SEPARATE PROJECT CONSTRUCTION FROM BUILDING USERS.
- PROVIDE WALK OFF MATS AT PROJECT ENTRANCE. KEEP CORRIDOR CLEAN OF DEBRIS. MOP FLOORS AS REQUIRED TO KEEP DIRT TO A MINIMUM.
- REMOVE ALL MISC. ITEMS ATTACHED TO WALLS, AND PREPARE WALLS TO RECEIVE NEW FINISHES.
- REMOVE VINYL WALL COVERING COMPLETELY ON ALL EXISTING WALLS TO REMAIN, PATCH AND REPAIR WALLS AS NEEDED FOR NEW PAINT.
- 5. EXISTING BASEMENT WALLS ARE MASONRY W/ PLASTER.

DEMOLITION LEGEND

- REMOVE EXISTING WALL TO LIMITS SHOWN
- 2 REMOVE EXISTING DOOR AND FRAME COMPLETELY
- REMOVE EXISTING WINDOW UNIT AND PREPARE FOR NEW WINDOW INSTALLATION (FIRST FLOOR DEMOLITION INCLUDES REMOVAL OF GYP. BD. / METAL STUD BÙLK HEAD, GYP. BD. JAMB AND WINDOW STOOL).
- 4 REMOVE EXISTING CASEWORK AND SHELVING COMPLETELY
- 5 REMOVE FIXTURES COMPLETELY, SEE PLUMBING DWGS.

COORDINATE W/ ASBESTOS ABATEMENT.

- 6 REMOVE EXISTING CARPET AND RUBBER BASE COMPLETELY
- REMOVE EXISTING VCT AND RUBBER BASE COMPLETELY
- REMOVE EXISTING PORCELAIN FLOOR TILE AND MORTAR BED COMPLETELY
- REMOVE EXISTING WALL TILE COMPLETELY. PATCH AND REPAIR WALLS AS NEEDED TO RECEIVE NEW FINISHES.
- REMOVE EXISTING CUBICLE FURNITURE SYSTEM COMPLETELY -SALVAGE AND RETURN TO VAMC
- REMOVE EXISTING EMERGENCY SHOWER COMPLETELY, SEE PLUMBING DWGS.
- 12 REMOVE EXISTING FREEZER COMPLETELY (INCLUDING CEILING ABOVE)
- REMOVE EXISTING TOILET PARTITIONS COMPLETELY
- REMOVE EXISTING GYP. BD. CEILING COMPLETELY
- REMOVE EXISTING DOOR ONLY, H.M. FRAME TO REMAIN
- 16 REMOVE EXISTING 4" RAISED CONCRETE PAD
- EXISTING FLOOR DRAIN TO BE CAPPED SEE PLUMBING DWGS.
- ALL MECHANICAL EQUIPMENT TO BE REMOVED SEE MECHANICAL DWGS.
- 19 REMOVE EXISTING METAL LOUVER. COORDINATE WITH ASBESTOS ABATEMENT.
- 20 REMOVE EXISTING CONCRETE PAD & STEPS
- REMOVE EXISTING METAL PIPE RAIL TO LIMITS SHOWN
- 22 REMOVE EXISTING LAY-IN CEILING TILE AND GRID COMPLETELY
- REMOVE EXISTING WINDOW UNIT AND MASONRY WALL BELOW FOR NEW DOOR AND FRAME.
- 24 REMOVE EXISTING WATER FOUNTAIN COMPLETELY
- 25 REMOVE EXISTING STOREFRONT SYSTEM COMPLETELY
- 26 REMOVE EXISTING ROOF CANOPY COMPLETELY

ASBESTOS WARNING:

CONTAINING MATERIALS.

MATERIALS CONTAINING ASBESTOS ARE KNOWN TO EXIST IN THIS FACILITY, INCLUDING FLOOR TILE, AND/OR BLACK MASTIC, DUCT MASTIC, PIPE INSULATION, CAULKING/SEALANTS AT EXTERIOR WINDOWS AND STOREFRONT, AND ROOF MASTIC IN THE EVENT ASBESTOS CONTAINING MATERIALS ARE ENCOUNTERED IN THIS PROJECT THAT HAVE NOT BEEN PREVIOUSLY DOCUMENTED, THE CONTRACTOR WILL IMMEDIATELY CEASE WORK IN THE INVOLVED AREA, SECURE THE AREA TO PREVENT INADVERTENT CONTAMINATION OR EXPOSURE, AND NOTIFY THE COR. UNDER NO CIRCUMSTANCES WILL THE CONTRACTOR DISTURB ASBESTOS

LEAD BASED MATERIAL WARNING:

EXIST ON BUILDING STRUCTURE(S) OR OTHER ITEMS IN THE CONSTRUCTION AREA. THE CONTRACTOR IS HEREBY ADVISED OF THE NEED FOR COMPLIANCE WITH OSHA STANDARD 1926.62 SUBPART D, TITLED "LEAD", [29 CFR 1910] DURING WORK WITH ALL LEAD CONTAINING MATERIALS.

> **CONSTRUCTION DOCUMENTS** DESTROY ALL PREVIOUS COPIES

> > 10/11/2013


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A0.2

DRAWING NO.






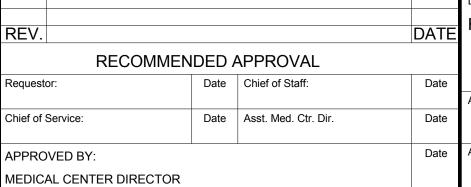

FIRST FLOOR - DEMOLITION PLAN RENOVATE BUILDING 6 FOR RESEARCH AND ANCILLARY SUPPORT 558-13-101 uilding No. Designed By: Drawn By: pproved: Chief, Engineering Service RGG Approved: Infection Control VA Medical Center Durham, NC



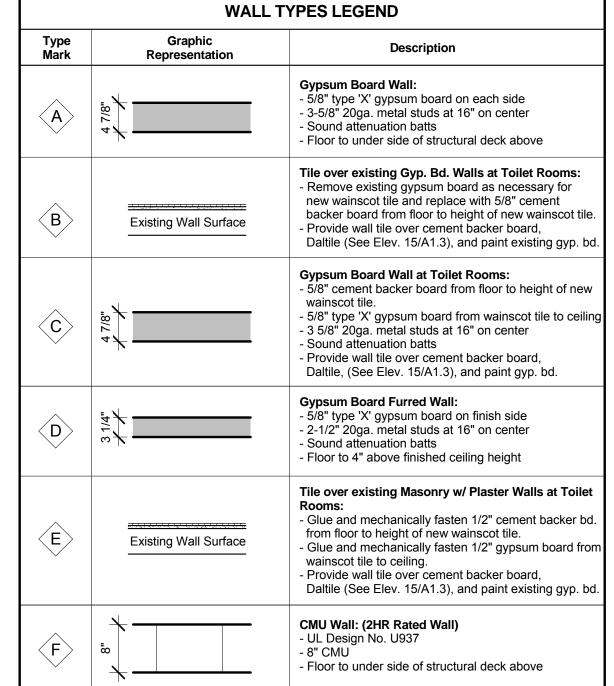

GENERAL CONSTRUCTION NOTES:

- CLEAN ALL WALLS, FLOORS, AND CEILING AT COMPLETION OF CONSTRUCTION. PREPARE ALL SURFACES TO RECEIVE NEW FINISHES.
- PAINT ALL WALLS AND PREVIOUSLY PAINTED ITEMS WITH IN PROJECT LIMITS AND AFFECTED BY PROJECT.
- 3. ALL NEW WALL CONSTRUCTION TO EXTEND TO UNDER SIDE OF STRUCTURAL DECK ABOVE (FULL HEIGHT PARTITION), UNLESS OTHERWISE NOTED.
- WHERE WALLS AND FIXTURES ARE REMOVED, PATCH AND REPAIR WALLS TO
- RECEIVE NEW FINISHES. WHERE WALLS OR CONCRETE PADS ARE REMOVED, INSTALL LIGHT WEIGHT CONCRETE
- FILL OR LEVELING MATERIAL TO F.F. ELEVATION. PREPARE FLOORS TO RECEIVE NEW CARPET / VCT / TILE.
- WHERE NEW TOILET FIXTURES ARE TO BE INSTALLED, REMOVE PORTION OF EXISTING WALL TO PROVIDE ACCESS FOR CARRIER. FILL CAVITY WITH SIMILAR CONSTRUCTION TO
- 8 PROVIDE 12" HEIGHT 16 GA CONTINUOUS BRIDGING TYPICAL AT ALL MOLINTED FIXTURES (GRAB BARS). REMOVE / REPLACE EXISTING GYP. BD. FINISH AS REQUIRED.
- CONTRACTOR SHALL INSTALL NEW TOILET ACCESSORIES (TOILET TISSUE HOLDER, PAPER TOWEL DISPENSER, SOAP DISPENSER, AND TOILET SEAT PAPER DISPENSER). TOILET ACCESSORIES TO BE PROVIDED BY VAMC.
- 10. SPECIALTY EQUIPMENT AND FURNITURE (DASHED LINES) PROVIDED BY VAMC.
- WHERE NEW ELECTRICAL. DATA. & PLUMBING DEVICES / FIXTURES ARE TO BE INSTALLED IN EXISTING WALLS, WALLS SHALL BE CHASED & REPAIRED TO MATCH EXISTING CONDITIONS.
- (7) PARKING SPACES LOCATED IN FRONT OF BUILDING (SOUTH ELEV.): PROVIDE HIGH DENSITY POLYETHYLENE PARKING STOPS (72"L X 8"W X 4"H, COLOR:GRAY) WITH ANCHORING SYSTEM.

CONSTRUCTION LEGEND

- WALL (TYPICAL) SEE WALL TYPES LEGEND
- NEW DOOR AND H.M. FRAME SEE DOOR SCHEDULE
- INSTALL NEW LIGHT WEIGHT CONCRETE FILL TO F.F. ELEVATION TO LIMITS SHOWN (HATCHED AREA).

NEW MODULAR CASEWORK (FABRICATED BY MILE MARKER OR APPROVED EQUAL): 36" HIGH

- PROVIDE NEW MORTAR BED AND APPLY NEW PORCELAIN FLOOR TILE SEE ROOM FINISHES LEGEND
- MODULAR BASE AND WALL CABINETS WITH CUSTOM COUNTERTOP AND BACKSPLASH. SINK UNIT TO HAVE UNDERMOUNT S.S. SINK. LAMINATE FINISH TO BE NATURAL WALNUT / COUNTERTOP TO BE SOLID SURFACE CORIAN, COLOR SAHARA.
- CR CARD READER, SEE DOOR HARDWARE REQUIREMENTS
- NEW MARBLE THRESHOLD, SEE DETAIL 6/A4.1
- NEW MONOLITHIC TOILET PARTITIONS (FLOOR MOUNTED), COLOR TO BE SELECTED BY VAMC NEW ALUMINUM WINDOW UNIT, SEE ELEVATIONS AND DETAIL 6/A3.1
- NEW ALUMINUM STOREFRONT SYSTEM TO BE KAWNEER OR APPROVED EQUAL,
- SEE SHEET A4.2 FOR DETAILS
- NEW STOREFRONT FIXED GLASS IN EXISTING MASONRY OPENING NEW MASONRY WALL INFILL WITH SIMILAR CONSTRUCTION TO MATCH EXISTING
- NEW CONCRETE PAD & STEPS, SEE STRUCTURAL DWGS.
- NEW FREESTANDING STEEL GUARDRAIL/HANDRAIL, 1-1/2" OUTSIDE O STEEL PIPE, HANDRAIL TO BE MOUNTED ON NEW CONCRETE PAD AT RAMP - SEE SHEET A4.2 FOR ELEVATIONS AND DETAILS

NEW HI-LO EWC, SEE PLUMBING DWGS.

- NEW 24" X 24" X 12" CORNER MOP SINK W/ FRP WALL PROTECTION, SEE PLUMBING DWGS.
- FILL ALL OPENINGS / FIRE SEAL ALL PENETRATIONS TO MEET REQUIREMENTS OF 2HR RATED CONSTRUCTION, TYPICAL FOR NEW AND EXISTING OPENINGS.
- NEW DOOR ON EXISTING HOLLOW METAL FRAME SEE DOOR SCHEDULE
- INFILL / REPAIR EXISTING CMU/PLASTER WALL WITH SIMILAR CONSTRUCTION TO MATCH EXISTING, PREPARE TO RECEIVE NEW FINISHES.
- NEW SEMI-RECESSED FIRE EXTINGUISHER CABINET, SEE ELEV. 7/A4.1

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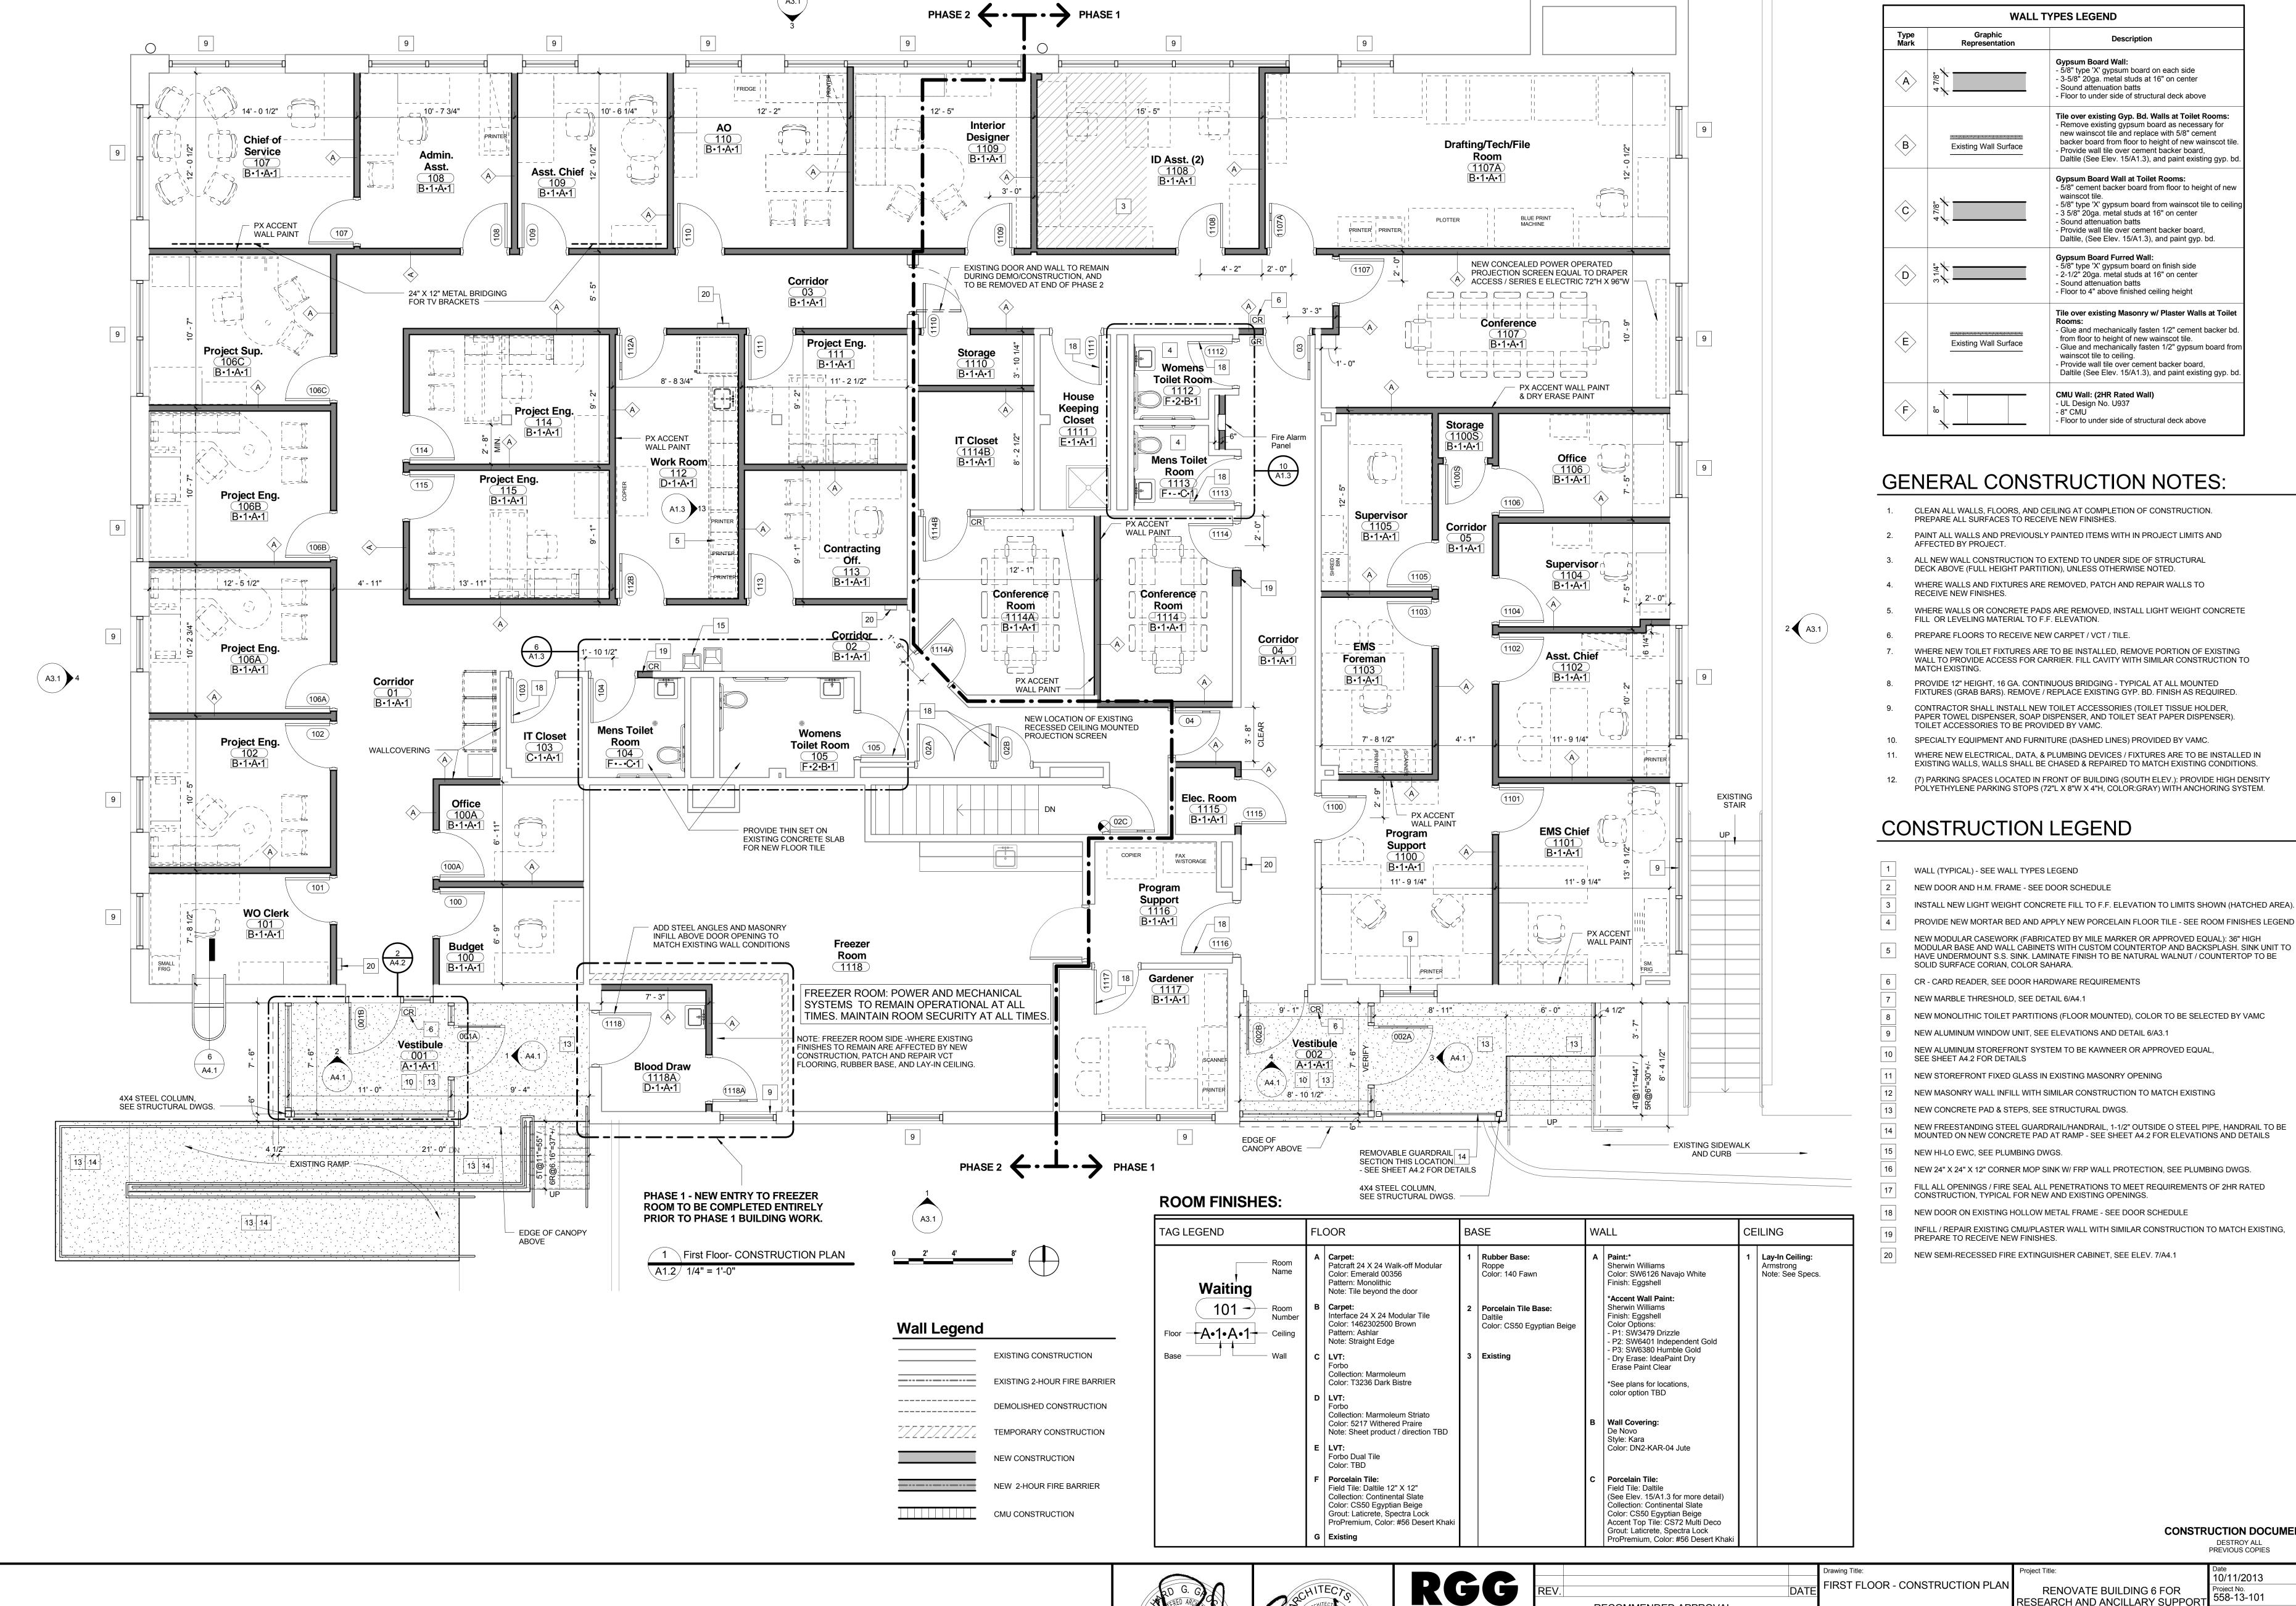




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RECOMMEN	DED A	APPROVAL		
estor:	Date	Chief of Staff:	Date	
				Approved: Chief, Eng
of Service:	Date	Asst. Med. Ctr. Dir.	Date	
ROVED BY:			Date	Approved: Infection (

- CONSTRUCTION PLAN RENOVATE BUILDING 6 FOR RESEARCH AND ANCILLARY SUPPORT 558-13-101 Engineering Service uilding No. Designed By: Drawn By: Checked By: RGG RGG Control .ocation VA Medical Center Durham, NC

10/11/2013 13-E-0X DRAWING NO.




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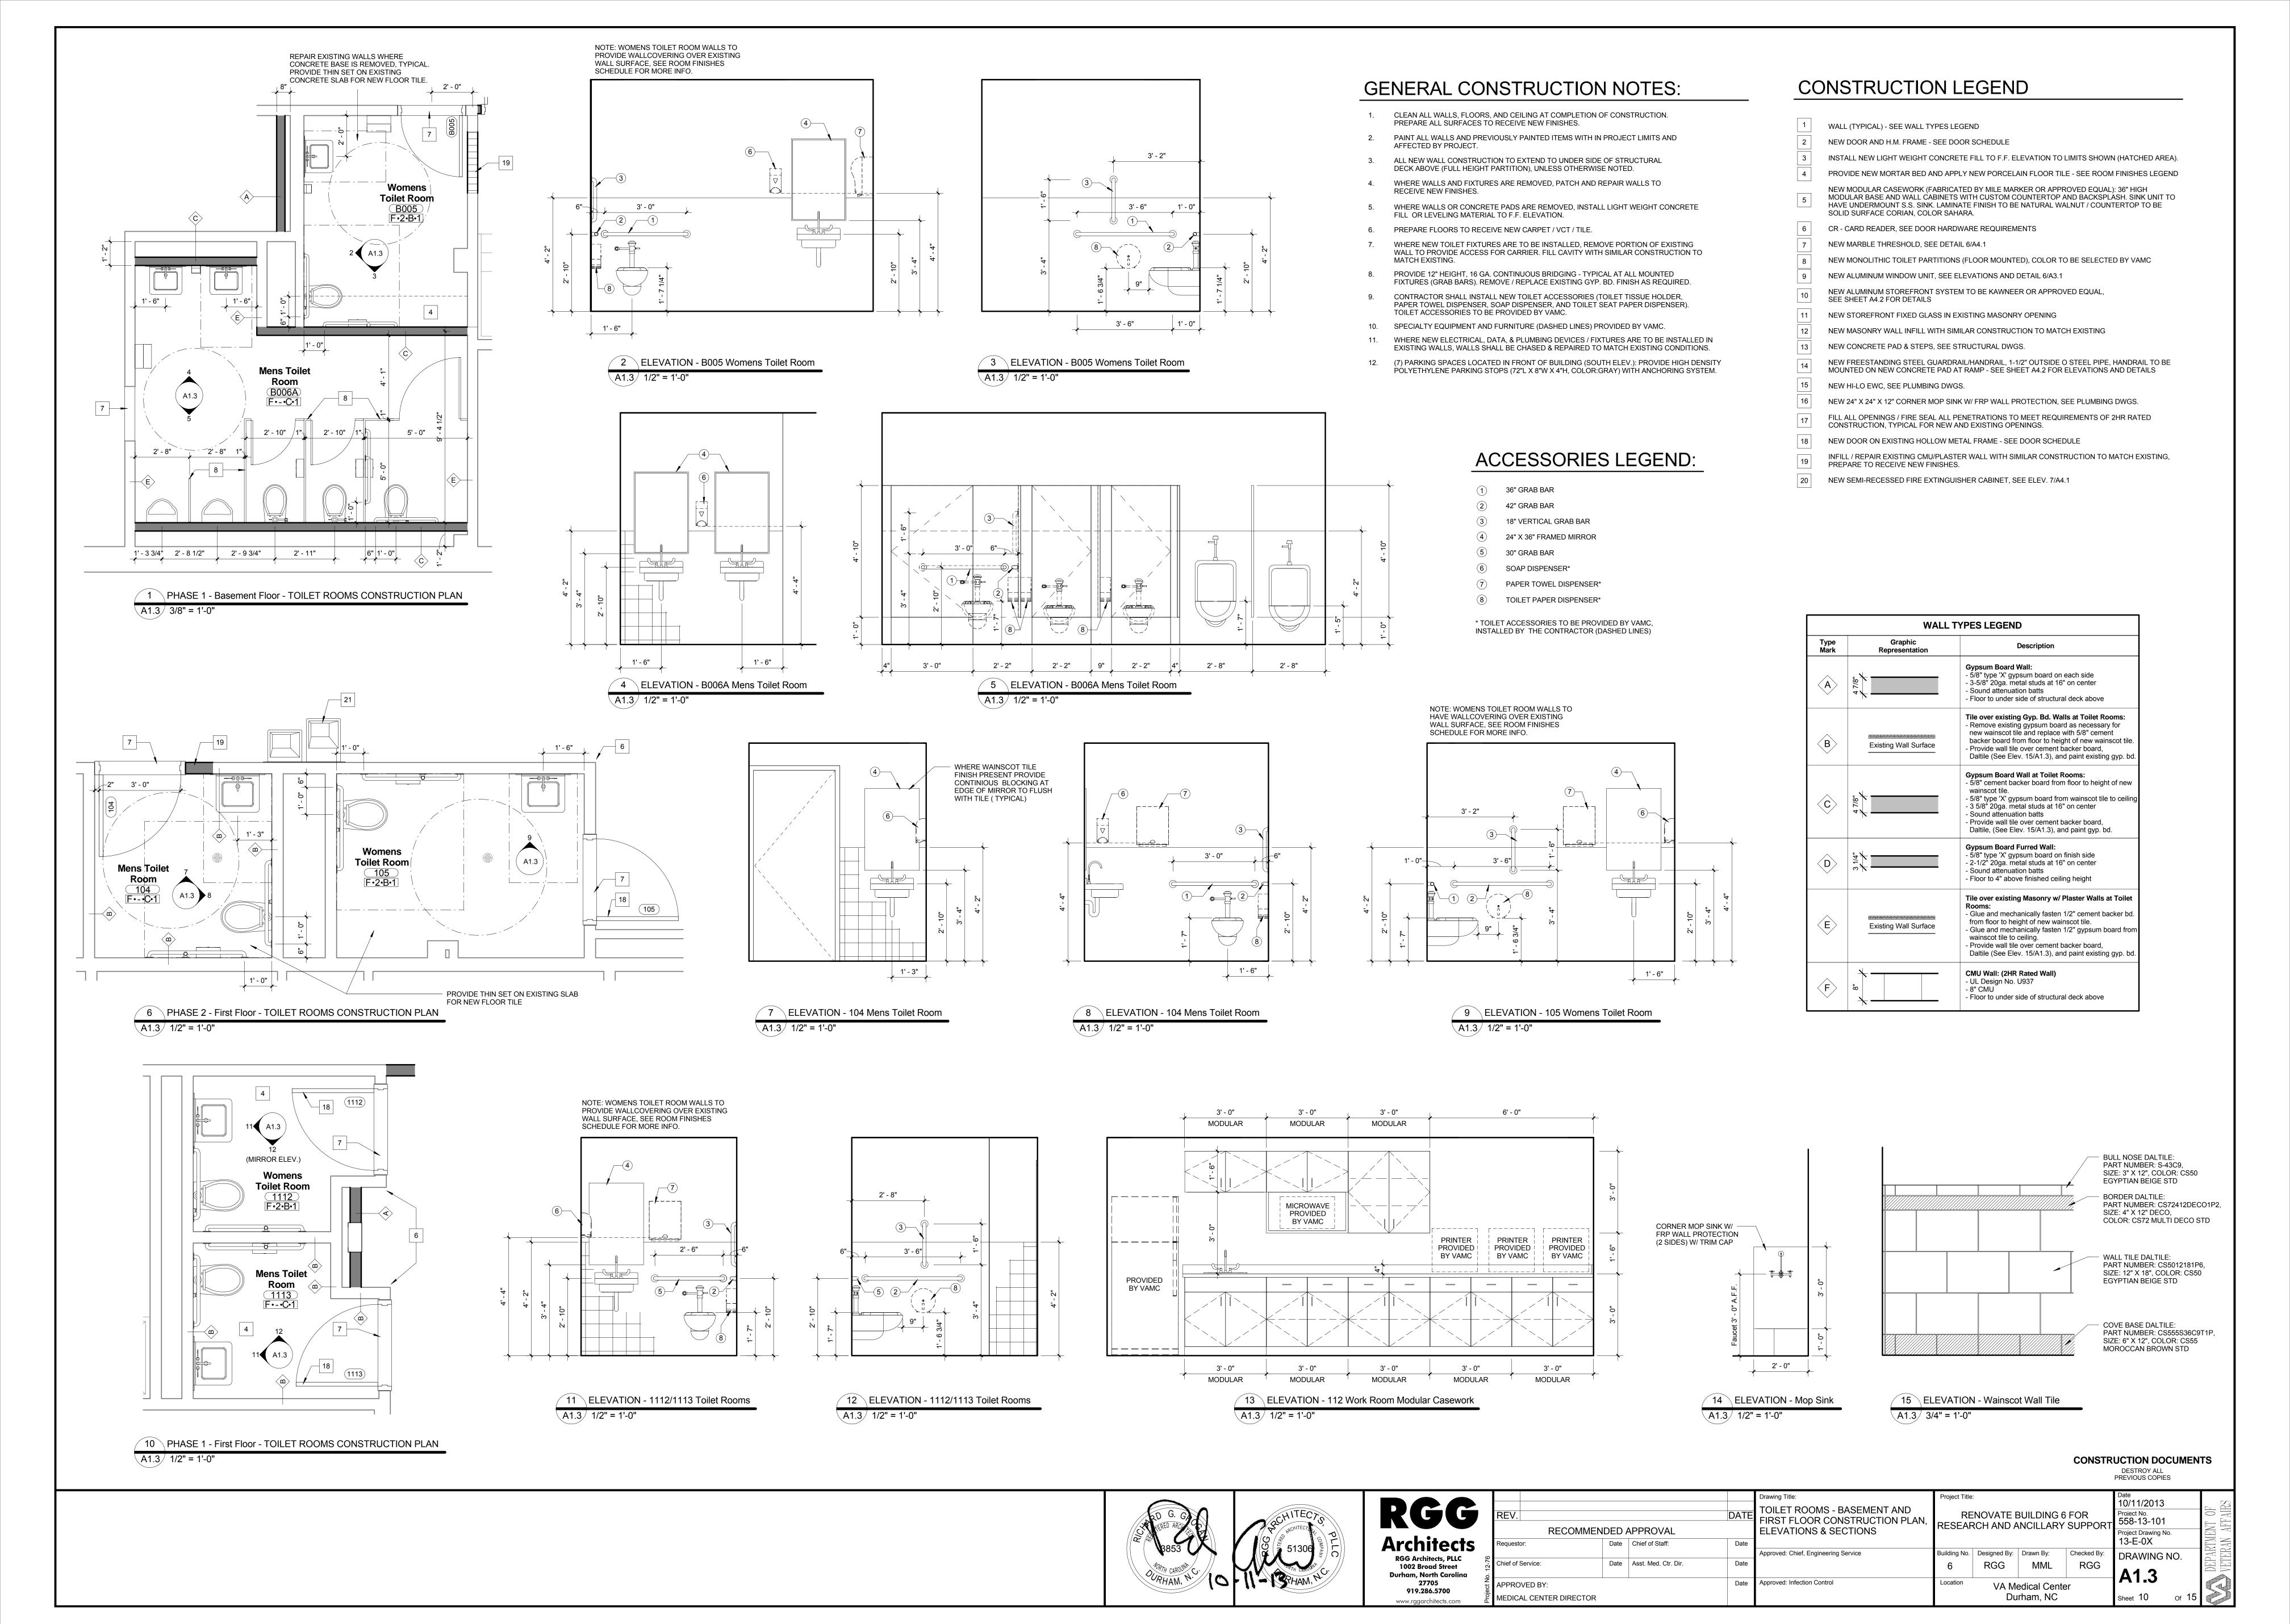





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10/11/2013 RENOVATE BUILDING 6 FOR RESEARCH AND ANCILLARY SUPPORT 558-13-101 Project Drawing No. 13-E-0X pproved: Chief, Engineering Service uilding No. Designed By: Drawn By: DRAWING NO. RGG MML RGG A1.2 Approved: Infection Control .ocation VA Medical Center Durham, NC



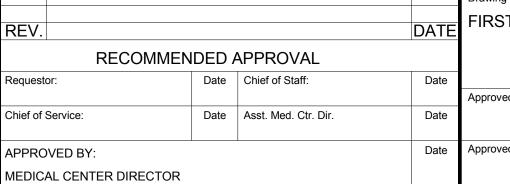


Reflected Ceiling Plan Legend 1"x11" Aluminum Prefinished

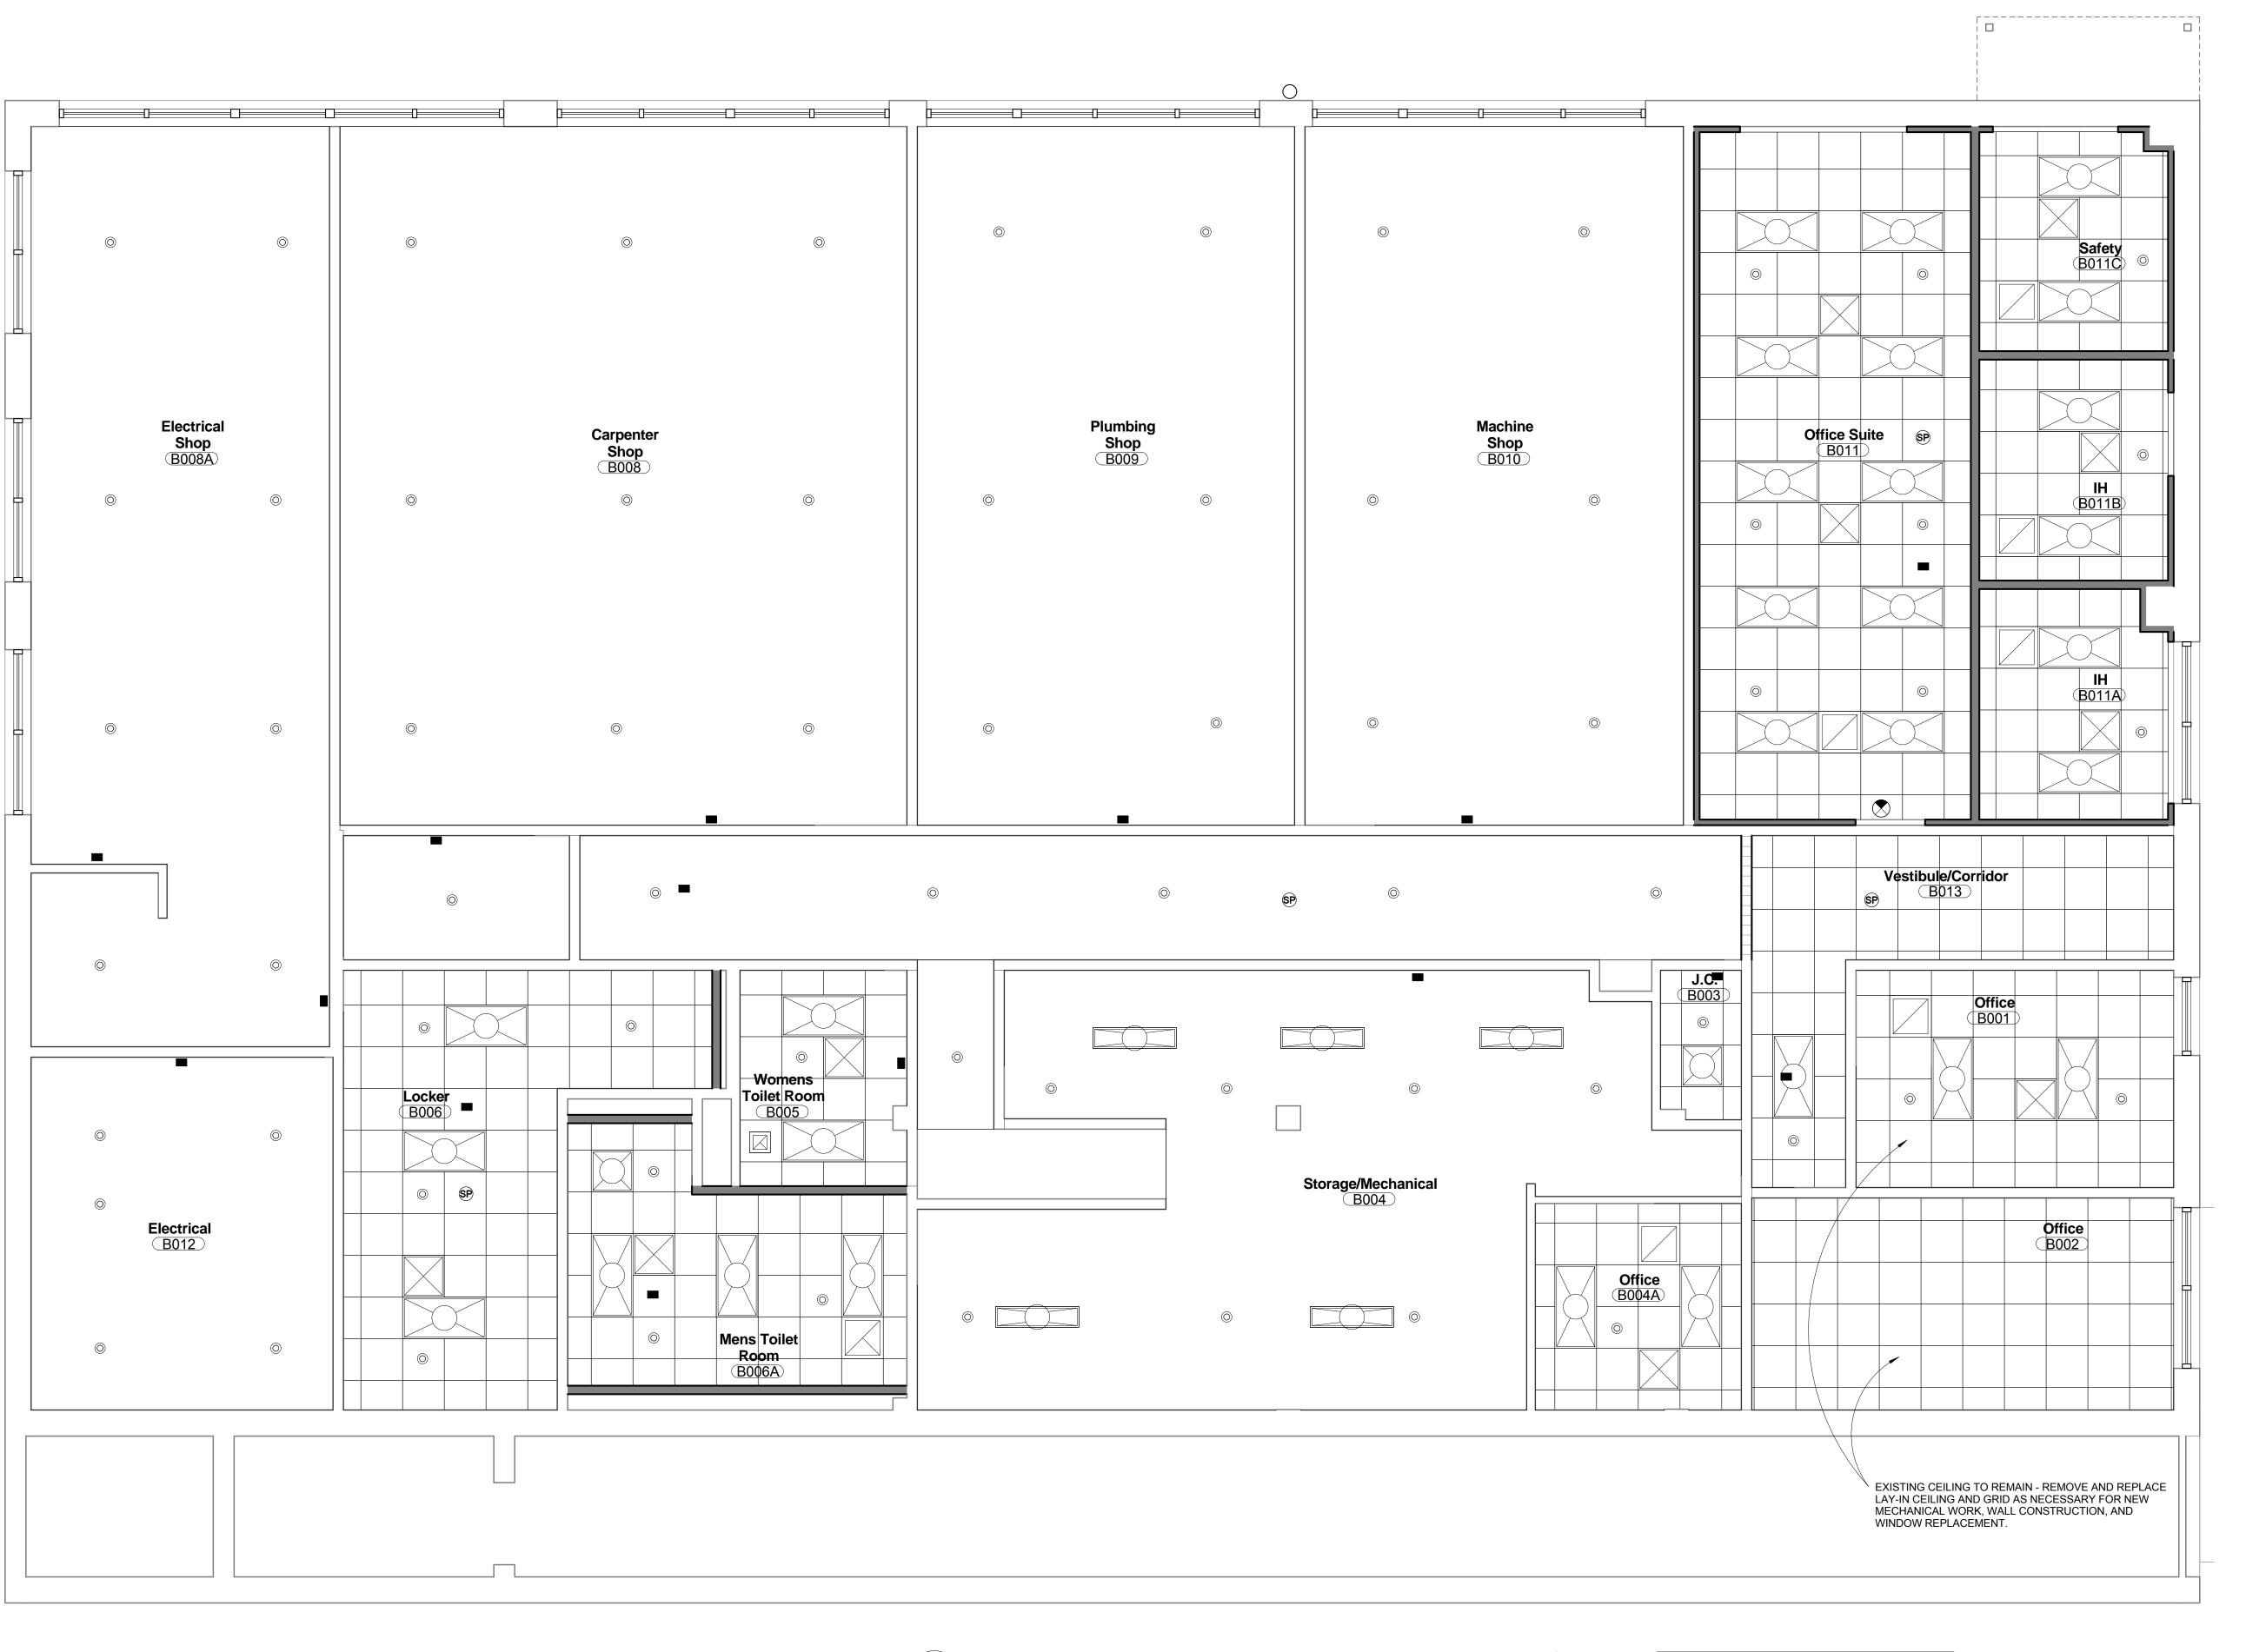
	0.032 Ceiling Panel -Interlo
	24"x24" Acoustical
	Tile Ceiling








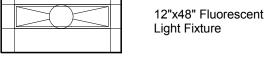

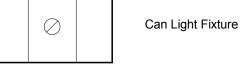

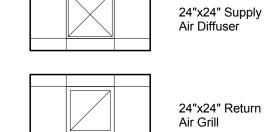


	24"x24" Exhaust Air Grill

		•
	(OC)	Occupancy

|--|

0	Sprinkler

	Fire Strobe
	•

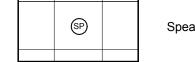


1 Basement Floor - NEW REFLECTED CEILING PLAN 0 2' 4' A2.1 1/4" = 1'-0"



DEMO / CONSTRUCTION IN BASEMENT TO BE DONE ON PHASE 1 - SHOPS REMAIN OCCUPIED DURING CONSTRUCTION

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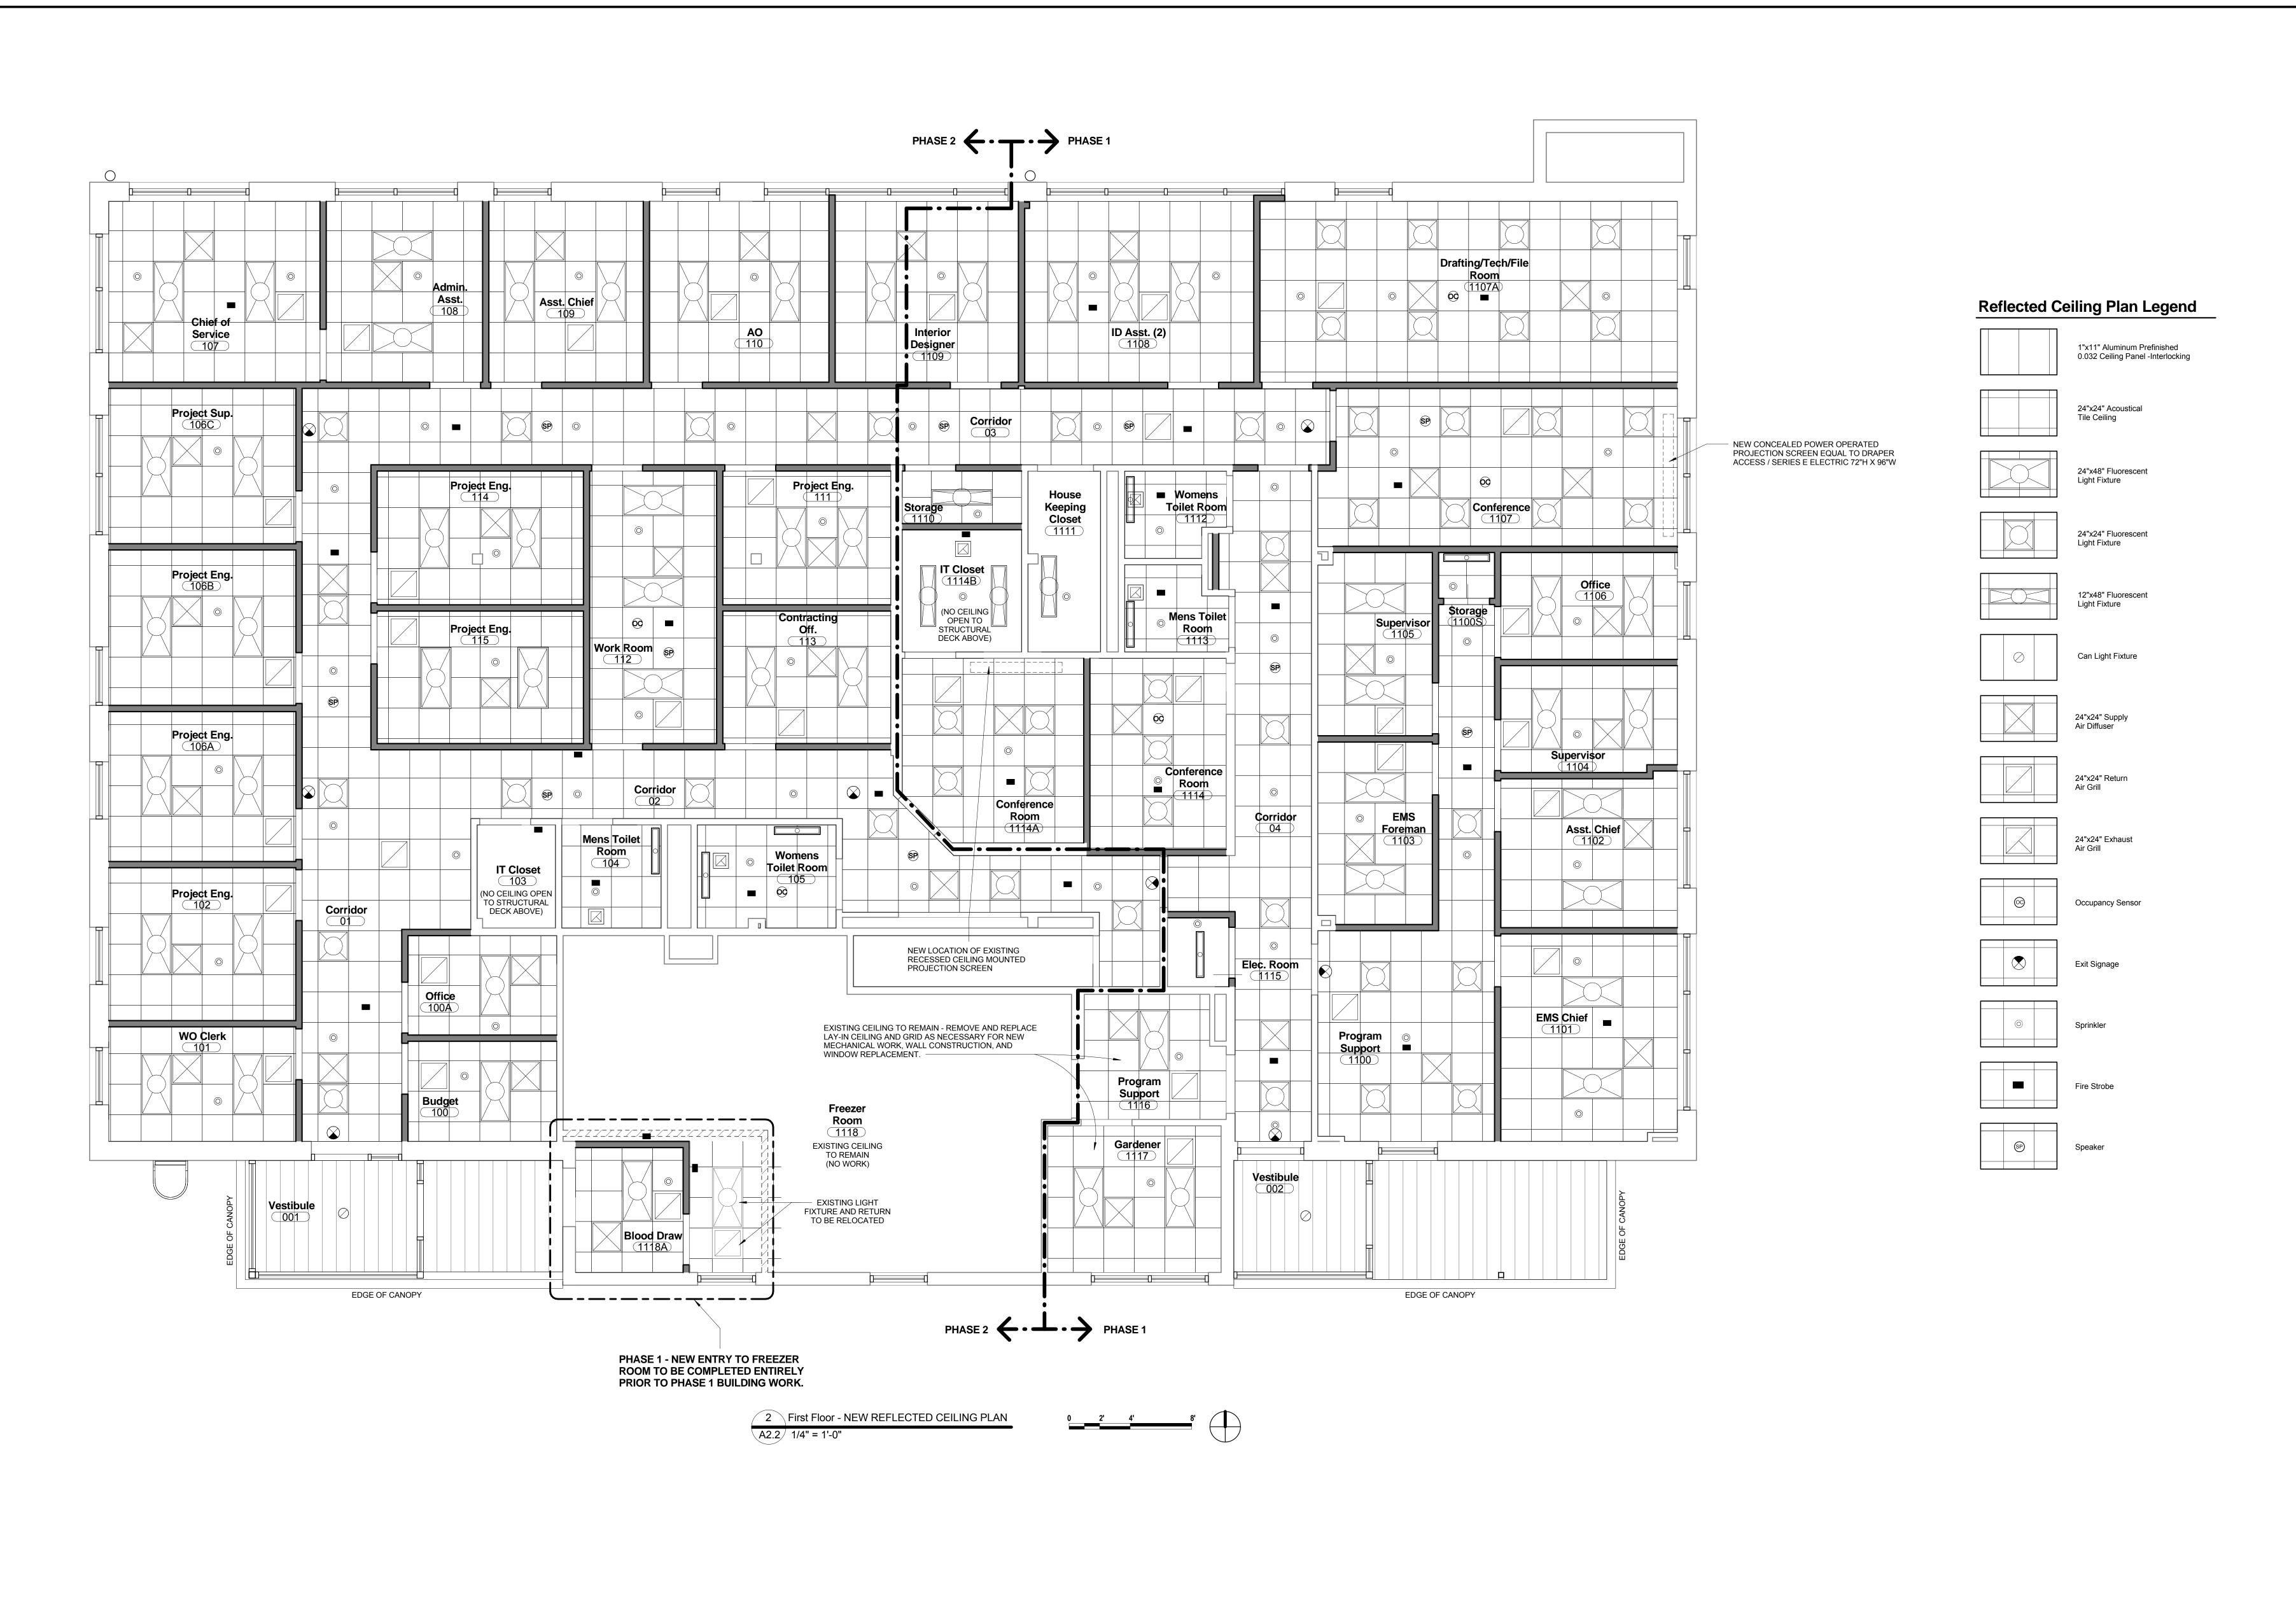


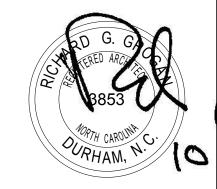

REV.	Drawing Title: BASEMENT - NEW REFLECTED CEILING PLAN			
RECOMME				
Requestor:	Date	Chief of Staff:	Date	
				Approved: Chief, Engineering Service
Chief of Service:	Date	Asst. Med. Ctr. Dir.	Date	
APPROVED BY:			Date	Approved: Infection Control
MEDICAL CENTER DIRECTOR				

Date 10/11/2013 RENOVATE BUILDING 6 FOR
RESEARCH AND ANCILLARY SUPPORT

Project No.
558-13-101 Project Drawing No. 13-E-0X DRAWING NO. VA Medical Center Durham, NC



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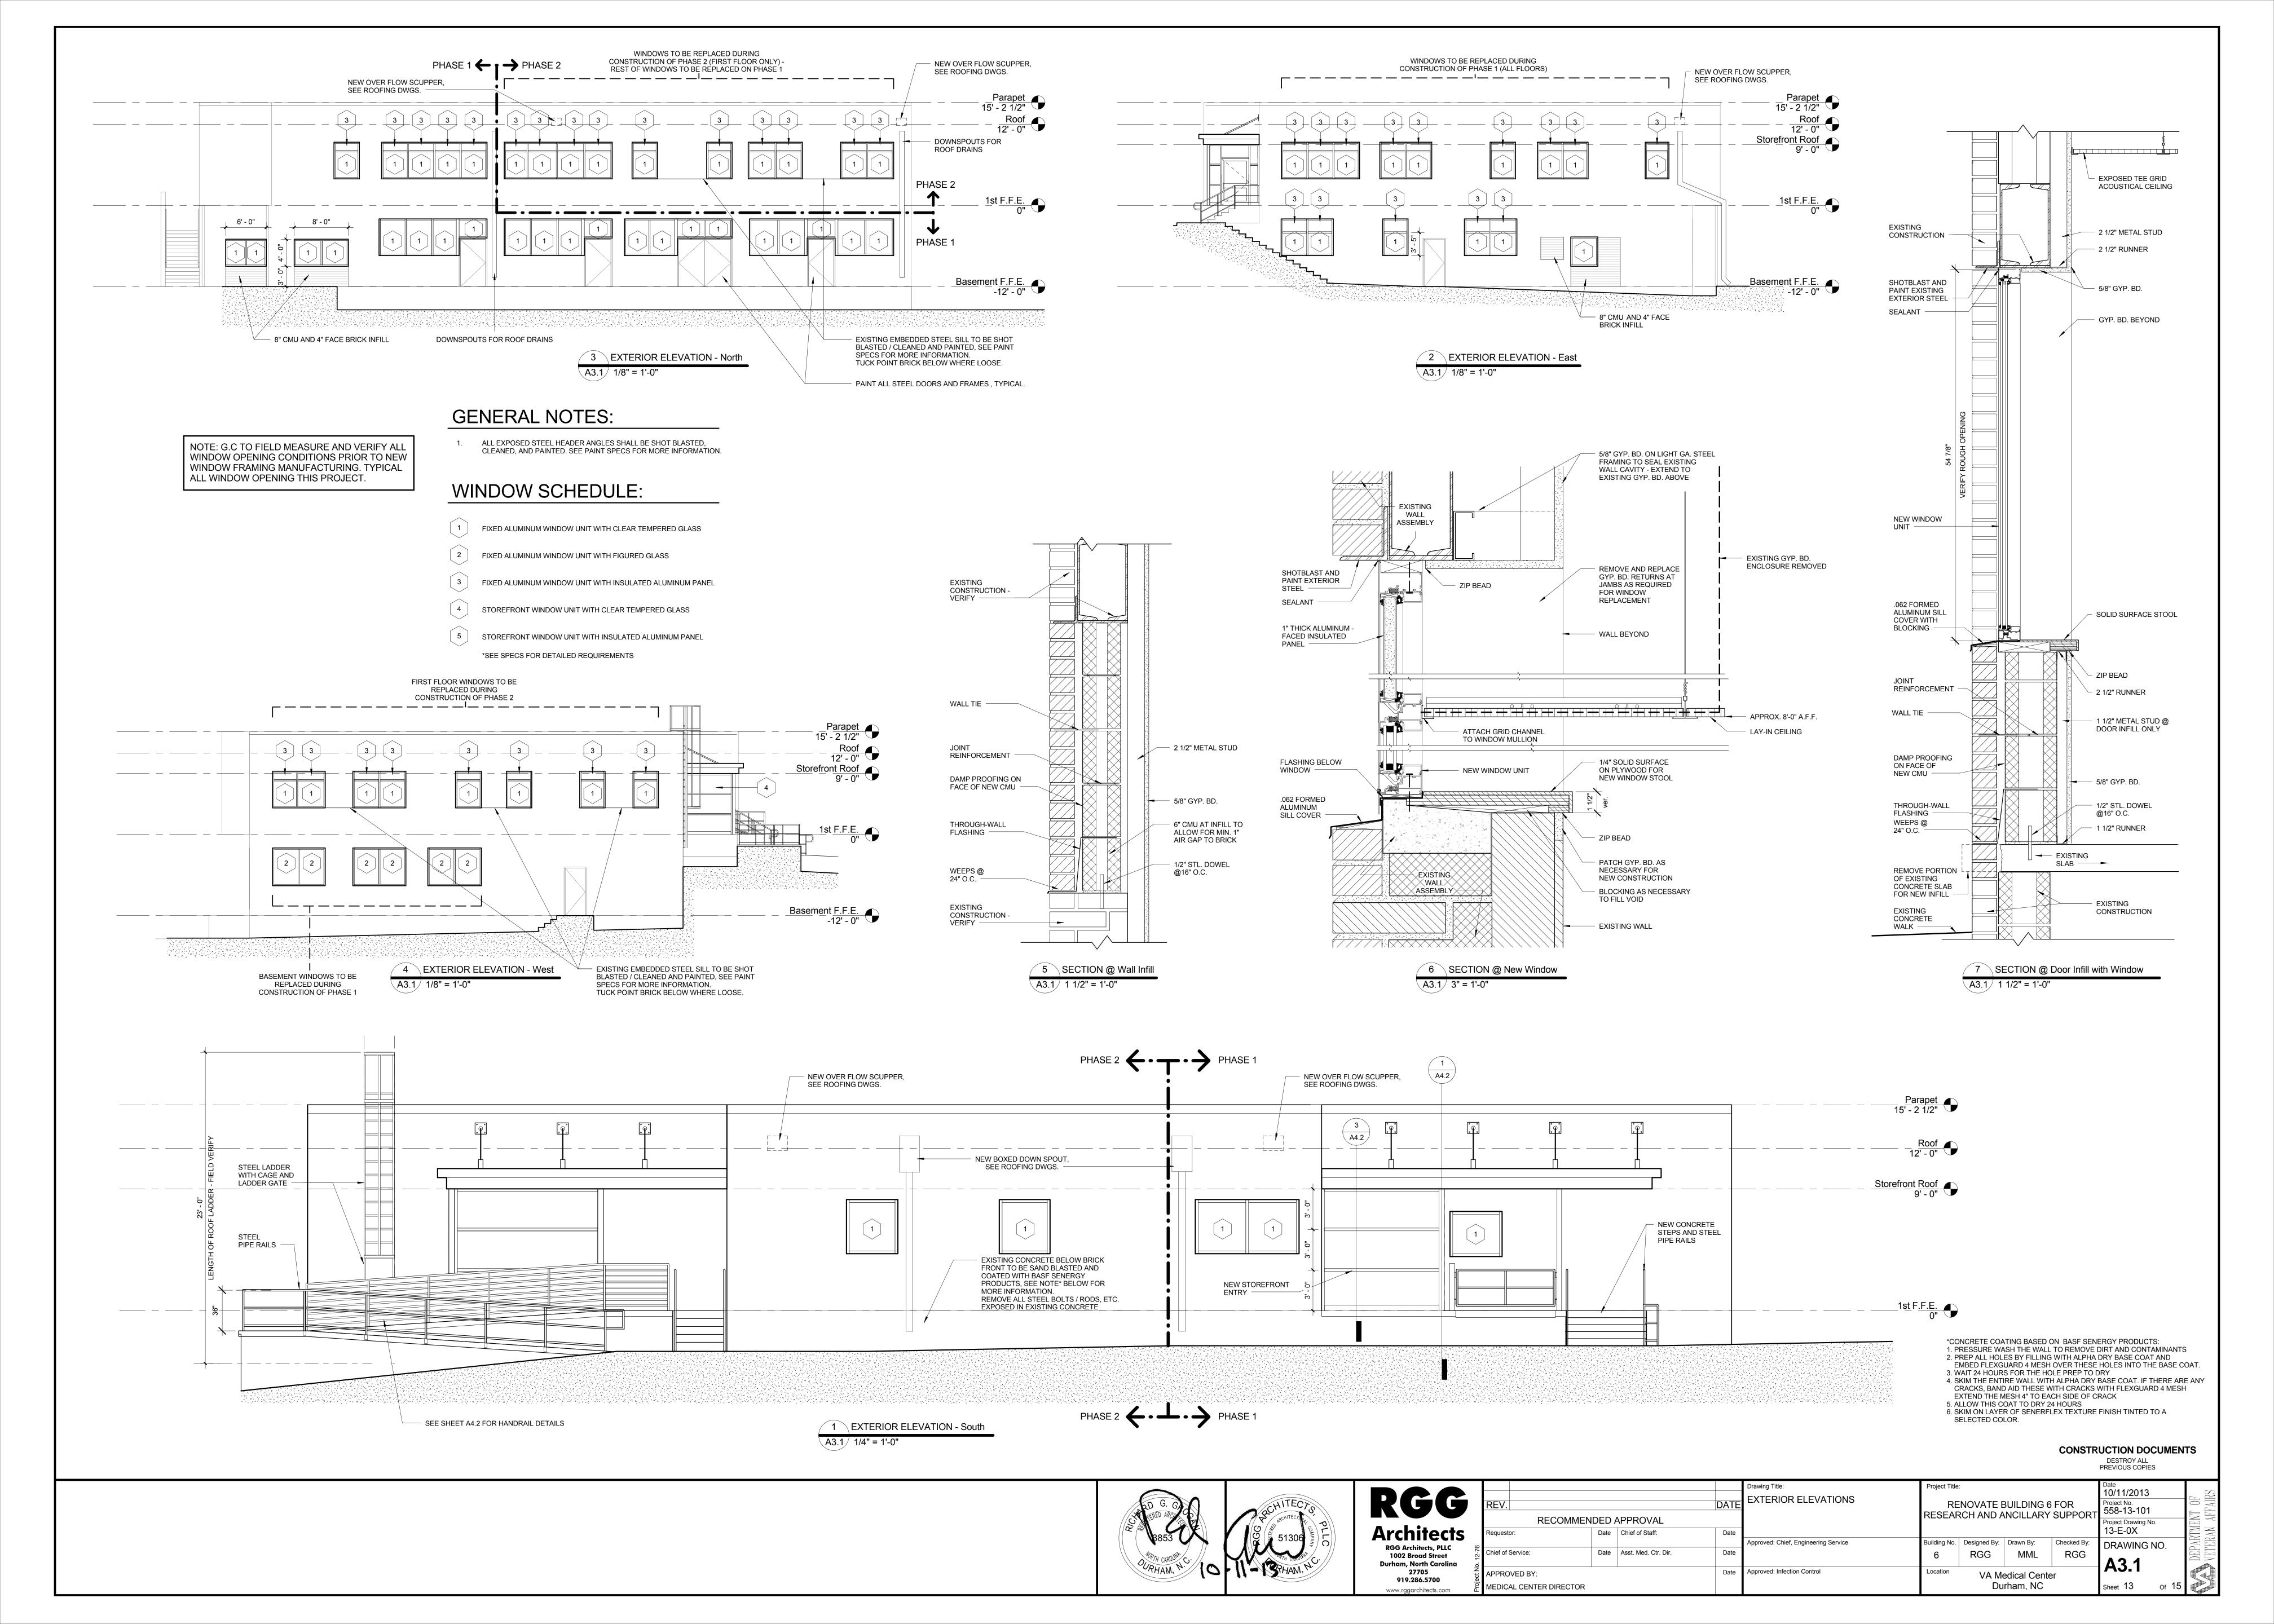







				Drawing Title:
EV.			DATE	FIRST FLOOR NEW REFLECTED CEILING PLAN
RECOMMEN	IDED A			
questor:	Date	Chief of Staff:	Date	
				Approved: Chief, Engineering Service
ief of Service:	Date	Asst. Med. Ctr. Dir.	Date	
PROVED BY:				Approved: Infection Control
DICAL CENTER DIRECTOR				

Project Title	:	Date 10/11/2013		
	NOVATE E	Project No. 558-13-101		
		Project Drawing No. 13-E-0X		
Building No.	Designed By:	Drawn By:	Checked By:	DRAWING NO.
6	RGG	MML	RGG	A2.2
Location	VA Me Du	Sheet 12 Of 15		



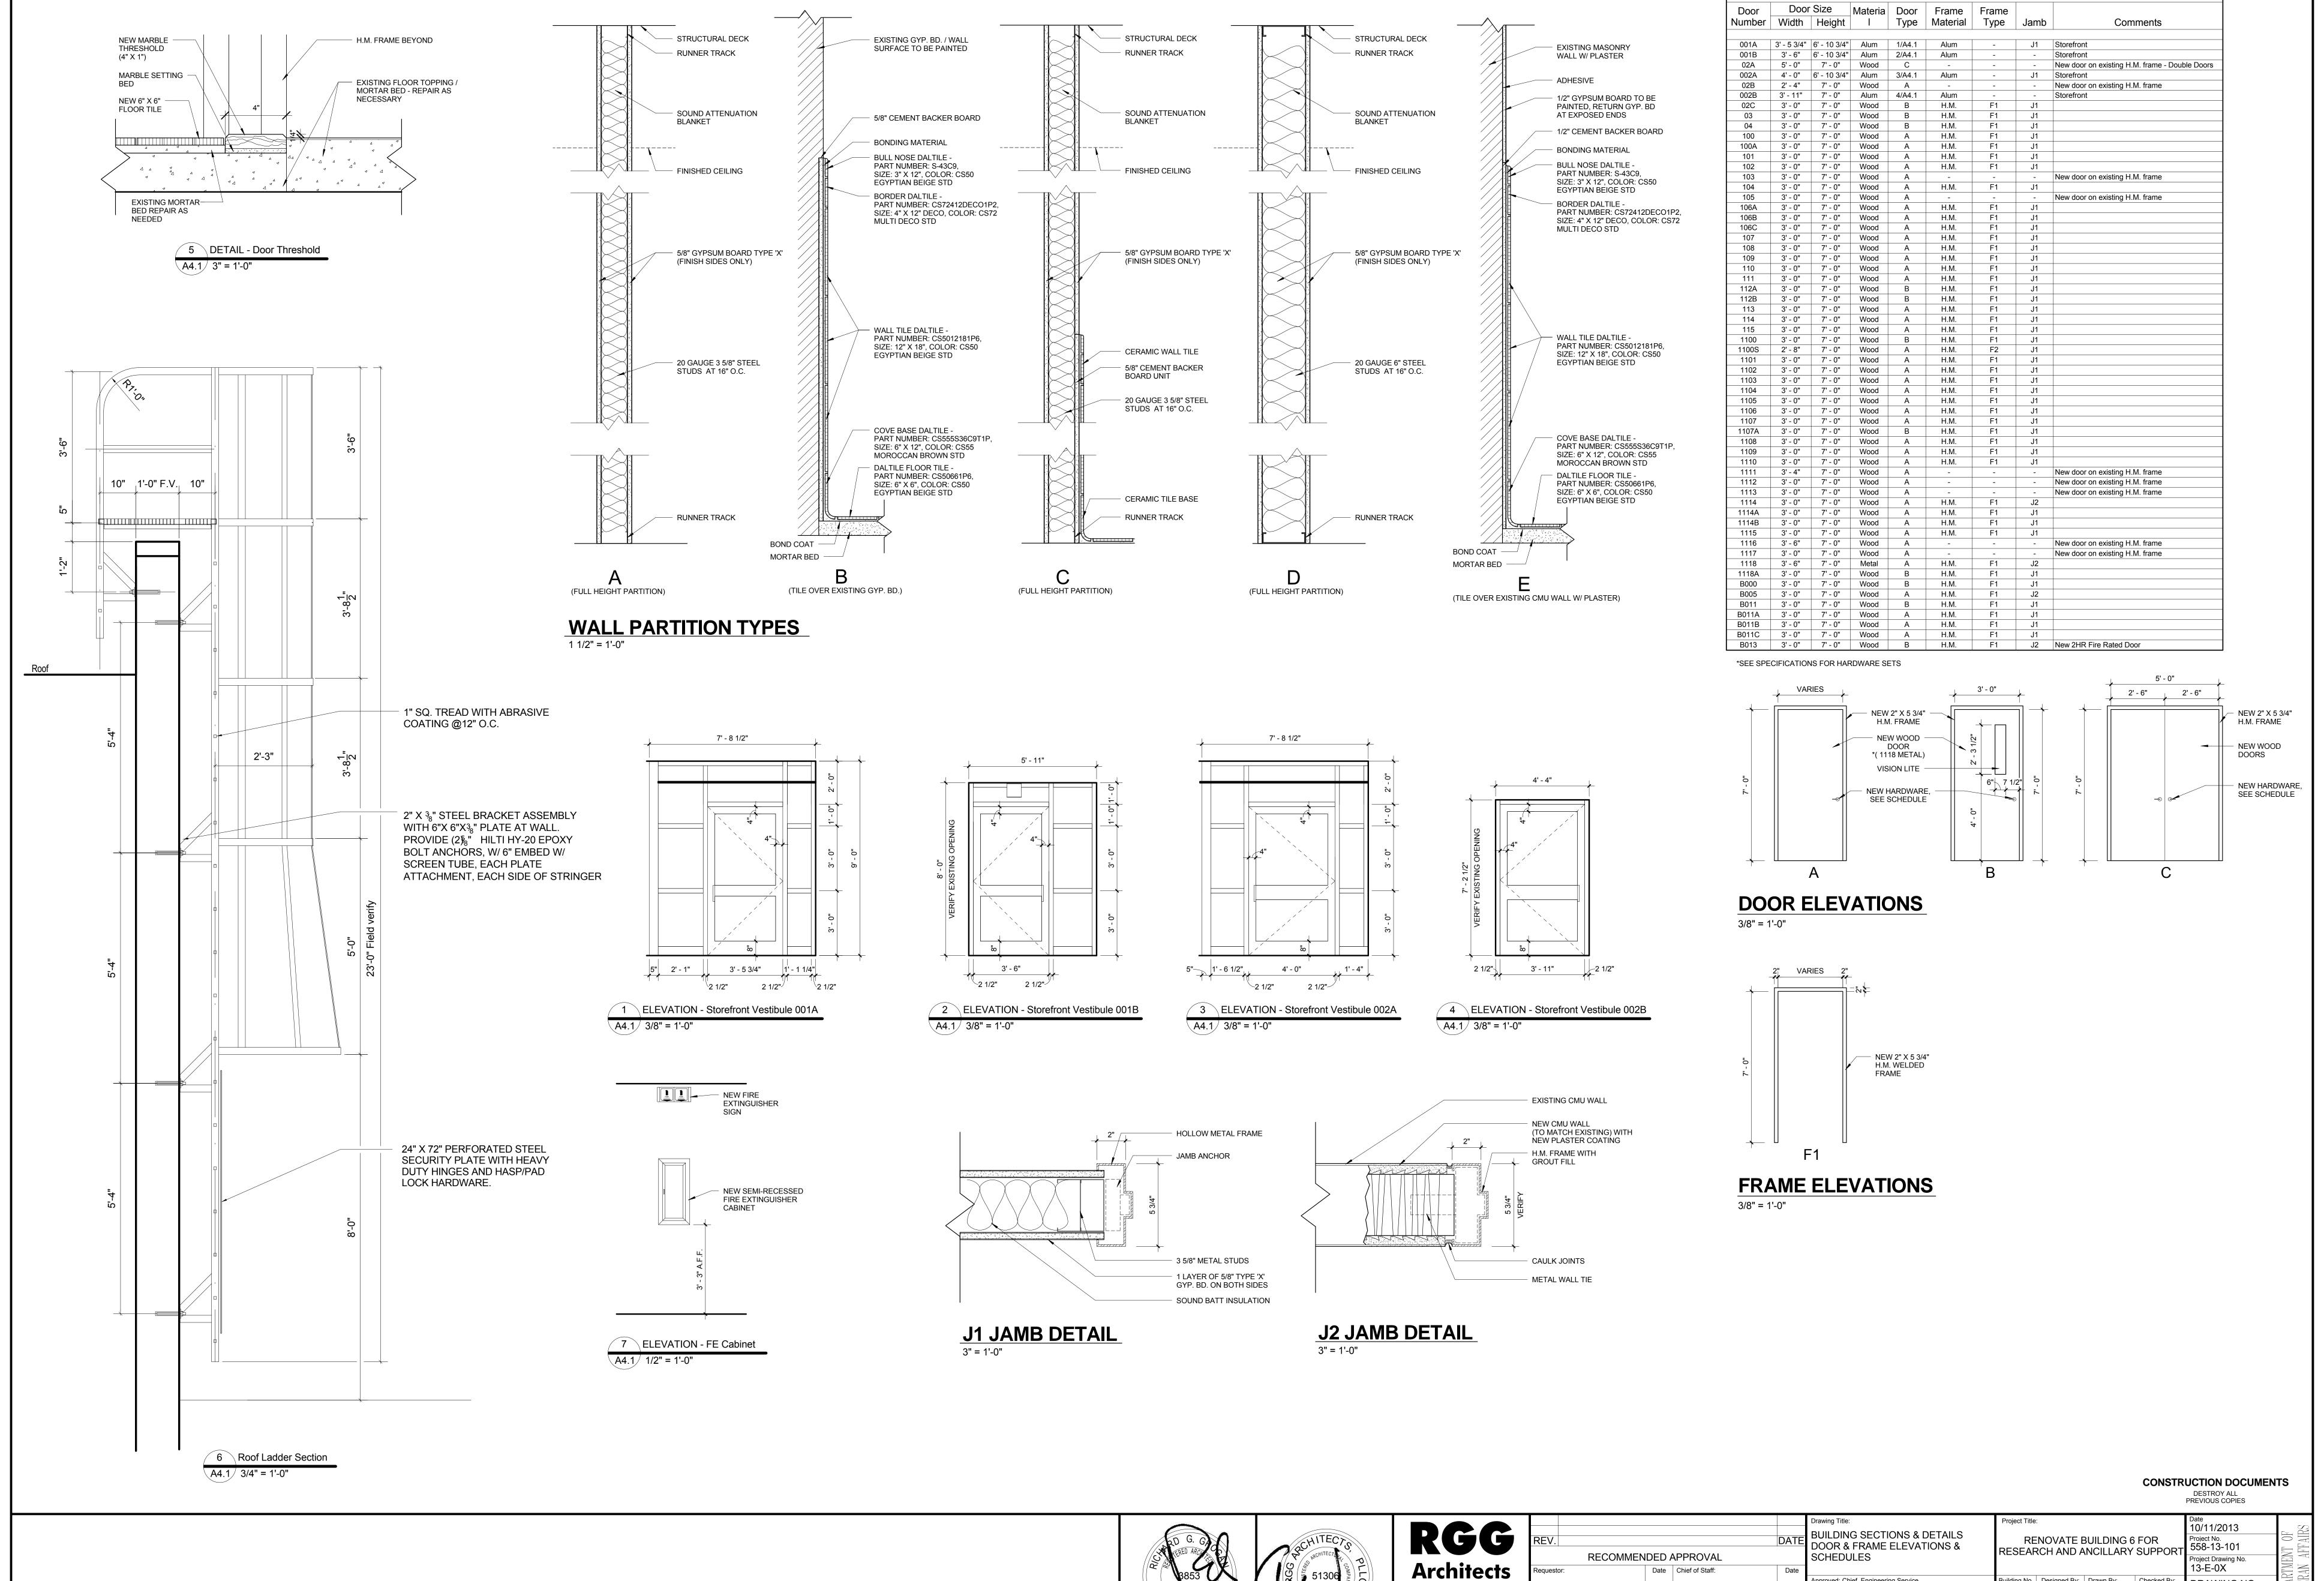

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RECOMMENDED APPROVAL SCHEDULES 13-E-0X Date Chief of Staff: pproved: Chief, Engineering Service uilding No. Designed By: Drawn By: DRAWING NO. Chief of Service: Date Asst. Med. Ctr. Dir. RGG RGG A4.1 Approved: Infection Control APPROVED BY: VA Medical Center Durham, NC MEDICAL CENTER DIRECTOR

Door Schedule

