

ABBREVIATIONS

A.C.T.	ACOUSTICAL CEILING TILE	LAV.	LAVATORY
ADJ.	ADJUSTABLE	LMST.	LIMESTONE
A.F.F.	ABOVE FINISH FLOOR	LVR.	LOUVER
ALT.	ALTERNATE	MAT.	MATERIAL
ALUM.	ALUMINUM	MAX.	MAXIMUM
BLDG.	BUILDING	MIN.	MINIMUM
C.F.S.	CLEAR FLOOR SPACE	M.O.	MASONRY OPENING
C.J.	CONTROL JOINT	MOD. BIT.	MODIFIED BITUMEN
CL	CENTER LINE	M.R.	MOISTURE RESISTANT
CMU	CONCRETE MASONRY UNIT	MTL	METAL
CLR.	CLEAR	MTLR	METAL ROOF
CLG.	CEILING	MWP	MEMBRANE WATERPROOFING
C.O.	CASED OPENING	NOM.	NOMINAL
CONC.	CONCRETE	N.T.S.	NOT TO SCALE
CONSTR.	CONSTRUCTION	O.C.	ON CENTER
CONT.	CONTINUOUS	OPNG.	OPENING
DBL.	DOUBLE	OPP.	OPPOSITE
DET.	DETAIL	PLAM.	PLASTIC LAMINATE
DIA.	DIAMETER	PLYWD.	PLYWOOD
DIAG.	DIAGONAL	PNL.	PANEL
DIM.	DIMENSION	PSF	POUNDS PER SQUARE FOOT
DWG.	DRAWING	PSI	POUNDS PER SQUARE INCH
EA.	EACH	P.T.	PRESURE TREATED
EL.	ELEVATION	R.	RADIUS
EQ.	EQUAL	REINF.	REINFORCE
EQUIP.	EQUIPMENT	REQD.	REQUIRED
EXST.	EXISTING	RLG.	RAILING
EXP.	EXPANSION	RM.	ROOM
EXT.	EXTERIOR	R.O.	ROUGH OPENING
FIN.	FINISH	RTU	ROOF TOP UNIT
FLR.	FLOOR	R.V.	ROOF VENT
FRMG.	FRAMING	S.C.	SOLID CORE
FT.	FOOT	SCWD	SOLID CORE WOOD DOOR
GA.	GAUGE	SHT.	SHEET
GT.	GROUT	SIM.	SIMILAR
GYP.	GYPSUM	SPEC.	SPECIFICATIONS
GYP. BD.	GYPSUM BOARD	STD.	STANDARD
HAZ.	HAZARDOUS	STL.	STEEL
HCWD	HOLLOW CORE WOOD DOOR	STRUCT.	STRUCTURAL
HDR.	HEADER	SQ.	SQUARE
HDW	HARDWARE	THK.	THICK
HMD	HOLLOW METAL DOOR	TYP.	TYPICAL
HMDR.	HANDRAIL	U.N.O.	UNLESS NOTED OTHERWISE
HORIZ.	HORIZONTAL	VERT.	VERTICAL
HT.	HEIGHT	V.I.F.	VERIFY IN FIELD
IN.	INCH	W.P.	WATERPROOF
INCL.	INCLUDED	WT.	WEIGHT
INT.	INTERIOR	W.W.F.	WELDED WIRE FABRIC
JAN.	JANITOR	WD.	WOOD
JT.	JOINT		

ARCHITECTURAL SYMBOLS

	CENTER LINE INDICATOR
	ELEVATION INDICATOR
	CENTER LINE
	DEMOLITION LINE
	EXISTING TO REMAIN LINE
	HIDDEN FEATURES LINE
	NEW LINE
	BREAK, ROUND (USER DEFINES SIZE)
	BREAK, STRAIGHT (SEE SECTION INDICATORS, BUILDING, WITH BREAK STANDARDS)
	DETAIL INDICATOR
	BUILDING SECTION INDICATOR
	CORRIDOR
	ROOM NAME AND NUMBER
	WALL OR PARTITION TYPE

GENERAL NOTES:

- COMPLY WITH ALL GOVERNING AND GENERAL CONDITIONS OF THE CONTRACT.
- VERIFY ALL DIMENSIONS/WORK TO BE DONE BASED ON EXISTING CONDITIONS NOTIFY COTR IMMEDIATELY OF ANY CONFLICTS.
- ALL NEW AND EXISTING PARTITIONS ARE TO BE CONTINUOUS TO THE STRUCTURE ABOVE, UNLESS OTHERWISE NOTED.
- INSTALL METAL BLOCKING IN ALL WALLS WHERE REQUIRED FOR HANDRAILS. WALL GUARDS, FOR SHELVING, WALL CABINETS, WALL MOUNTED DOOR STOPS OR EQUIPMENT. CUT AND PATCH DRYWALL IN EXISTING WALLS FOR INSTALLATION OF NEW BLOCKING WHERE REQUIRED.
- INSTALL 3 1/2" SOUND ATTENUATION BLANKET INSULATION IN ALL NEW INTERIOR PARTITIONS, UNLESS OTHERWISE NOTED.
- CUT AND PATCH EXISTING DRYWALL PARTITIONS TO CONCEAL ROUTING OF UTILITY SERVICES, PIPES, ETC., UNLESS OTHERWISE PROHIBITED BY CODES.
- UNLESS OTHERWISE NOTED, LOCATE FRAMES OF DOORS SHOWN IN ROOM CORNERS TO ABUT ADJACENT PERPENDICULAR WALLS. ALLOW FOR PROTRUDING HARDWARE.
- FURR OUT AROUND PIPES, UTILITIES, ETC., NEW AND EXISTING TO REMAIN, WITH THE MINIMUM DEPTH NECESSARY TO CONCEAL PIPES.
- VERIFY EXTENT OF CONSTRUCTION LIMITS WITH COTR.
- PREPARE EXISTING WALLS TO REMAIN TO RECEIVE NEW FINISH IN ACCORDANCE WITH MANUFACTURER'S RECOMMENDATIONS. SEE EXTENT OF EXISTING WALL TO REMAIN ON PLAN.
- TRADES SHALL NOT DISRUPT OR LIMIT THE FACILITIES LIFE SAFETY.

MATERIALS LEGEND


	CONCRETE		EXISTING CONSTRUCTION TO REMAIN		BASE COURSE		NEW CONSTRUCTION
	EARTH		EXISTING CONSTRUCTION TO BE REMOVED		RIGID INSULATION		BATT INSULATION

DEMOLITION NOTES:

- REMOVE CONSTRUCTION SHOWN DASHED ON ARCHITECTURAL DEMOLITION PLAN.
- DELIVER TO GOVERNMENT ALL SALVAGEABLE MATERIALS SCHEDULED FOR REMOVAL. REMOVE FROM SITE ANY ITEMS NOT DESIRED BY THE GOVERNMENT.
- REMOVE ALL DEBRIS AND LEAVE WORK AREA IN BROOM CLEAN CONDITION ONLY.
- SEE ENGINEERING DRAWINGS FOR ADDITIONAL INFORMATION INCLUDING REMOVAL OF ALL PIPING, PLUMBING FIXTURES, ETC.
- REMOVE EXISTING CEILINGS AND FLOOR FINISHES AS REQUIRED FOR NEW WORK/ FINISHES. SEE FINISH SCHEDULE.
- PATCH AND REPAIR EXISTING WALLS, CEILINGS, FLOOR ETC., THAT ARE TO REMAIN, WHERE DAMAGED BY CONSTRUCTION. THIS INCLUDES DAMAGE DONE TO EXISTING SPACES ABOVE/BELOW AND ADJACENT TO, REQUIRED TO COMPLETE NEW WORK. ANY PATCHING REQUIRED OF EXISTING CONCRETE FLOORS IS TO MEET ACI STANDARDS REQUIRED OF NEW CONSTRUCTION.
- STOP WORK IMMEDIATELY AND NOTIFY THE COTR IF AND WHEN ANY EXISTING CONDITION IS ENCOUNTERED DURING DEMOLITION WHICH APPEARS TO BE IN CONFLICT WITH THE DRAWINGS, THE REMOVAL OF WHICH MIGHT SEEM TO ENDANGER THE STRUCTURAL INTEGRITY OF THE BUILDING.
- REMOVE ALL EXISTING CASEWORK, INCLUDING BASE UNITS, SHELVES, ETC., WHETHER PERMANENTLY OR TEMPORARILY ATTACHED AS NOTED ON DRAWINGS.
- THIS NOTE OMITTED.
- REMOVE EXISTING DOORS, FRAMES, AND HARDWARE INDICATED BY DASHED LINES, (U.O.N) VERIFY WITH CONTRACTOR WHICH DOORS TO BE REUSED.
- UTILITIES AND SYSTEMS SERVING AREAS OUTSIDE THE CONSTRUCTION LIMITS SHALL REMAIN (UNLESS INDICATED TO BE MOVED/REWORKED). REMOVE ALL OTHER UTILITIES AND SYSTEMS (UNLESS SHOWN/INDICATED TO REMAIN).
- WHEN ROOM INDICATED TO BE DEMOLISHED, WORK INCLUDES BUT NOT LIMITED TO REMOVING WALLS, CEILING, FINISHES, DOORS, HARDWARE, WINDOW, AND VCT.
- EXISTING BUILDING STRUCTURAL SYSTEMS ARE UNDERSTOOD TO BE REINFORCED CONCRETE. IF CONTRACTOR ENCOUNTERS EXPOSED UNPROTECTED LOAD- BEARING STEEL COLUMNS, BEAMS OR DECKING ABOVE EXISTING PLASTER CEILINGS TO BE REMOVED - UNLESS OTHERWISE NOTED. CONTRACTOR SHALL IMMEDIATELY CONTACT THE ARCHITECT FOR FURTHER INSTRUCTION PRIOR TO PROCEEDING WITH THE WORK. **NOTE: BUILDING #107 IS EXPOSED STRUCTURAL STEEL**


NOTE:

- APPLICABLE TO PENETRATIONS OF ALL FIRE RATED MEMBRANES, IN ACCORDANCE WITH NFPA 101. REFER TO SPECIFICATIONS SECTION 07 84 00, FIRE STOPPING SYSTEMS.

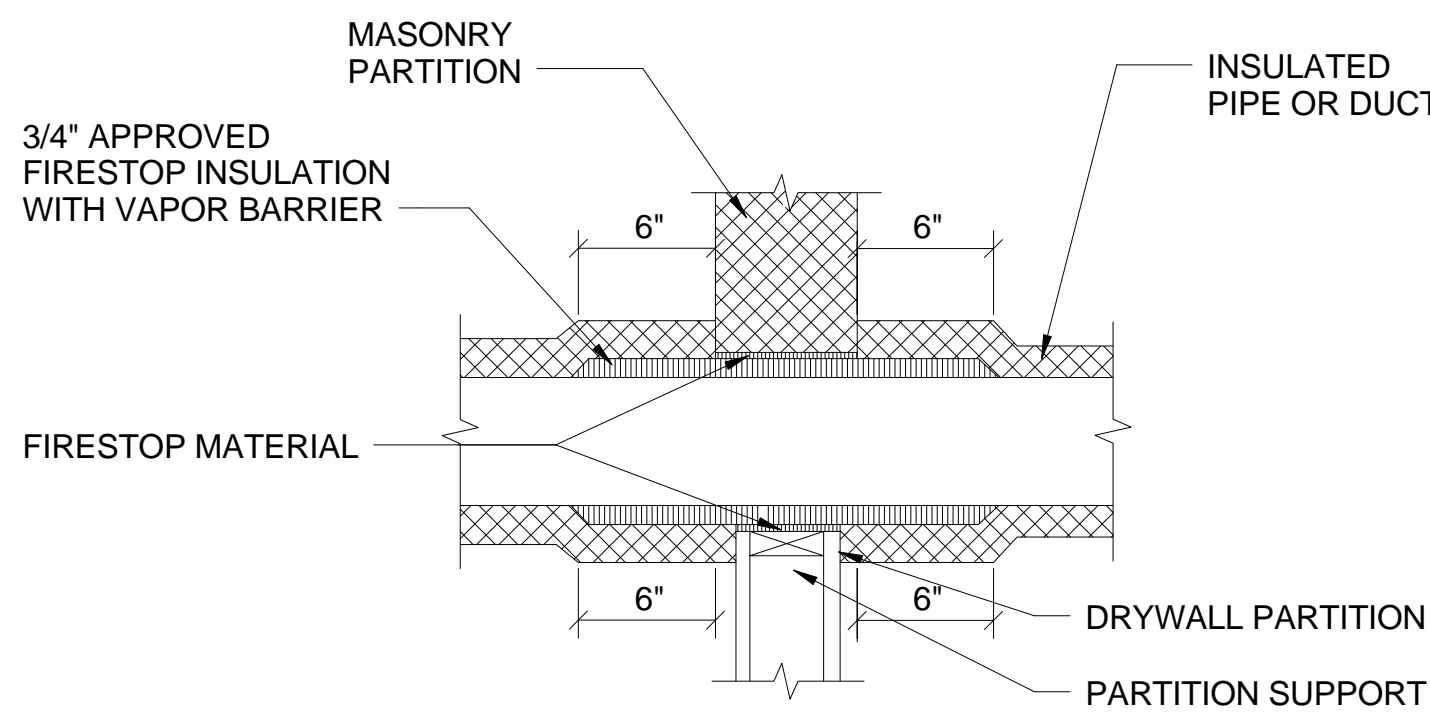


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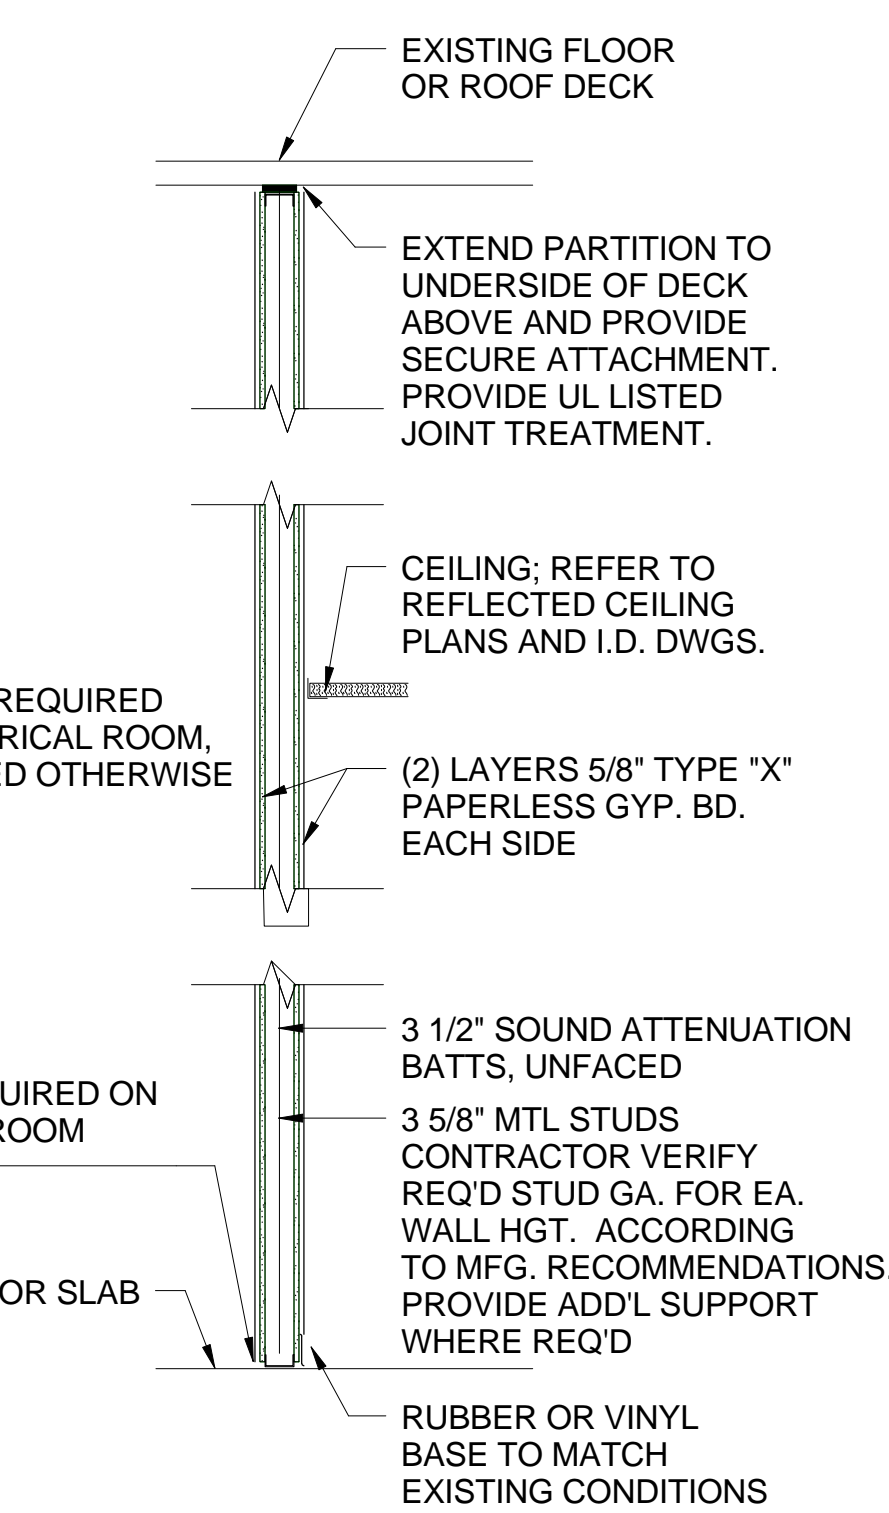
PIPE/DUCT PENETRATION OF SMOKE/FIRE BARRIERS NTS

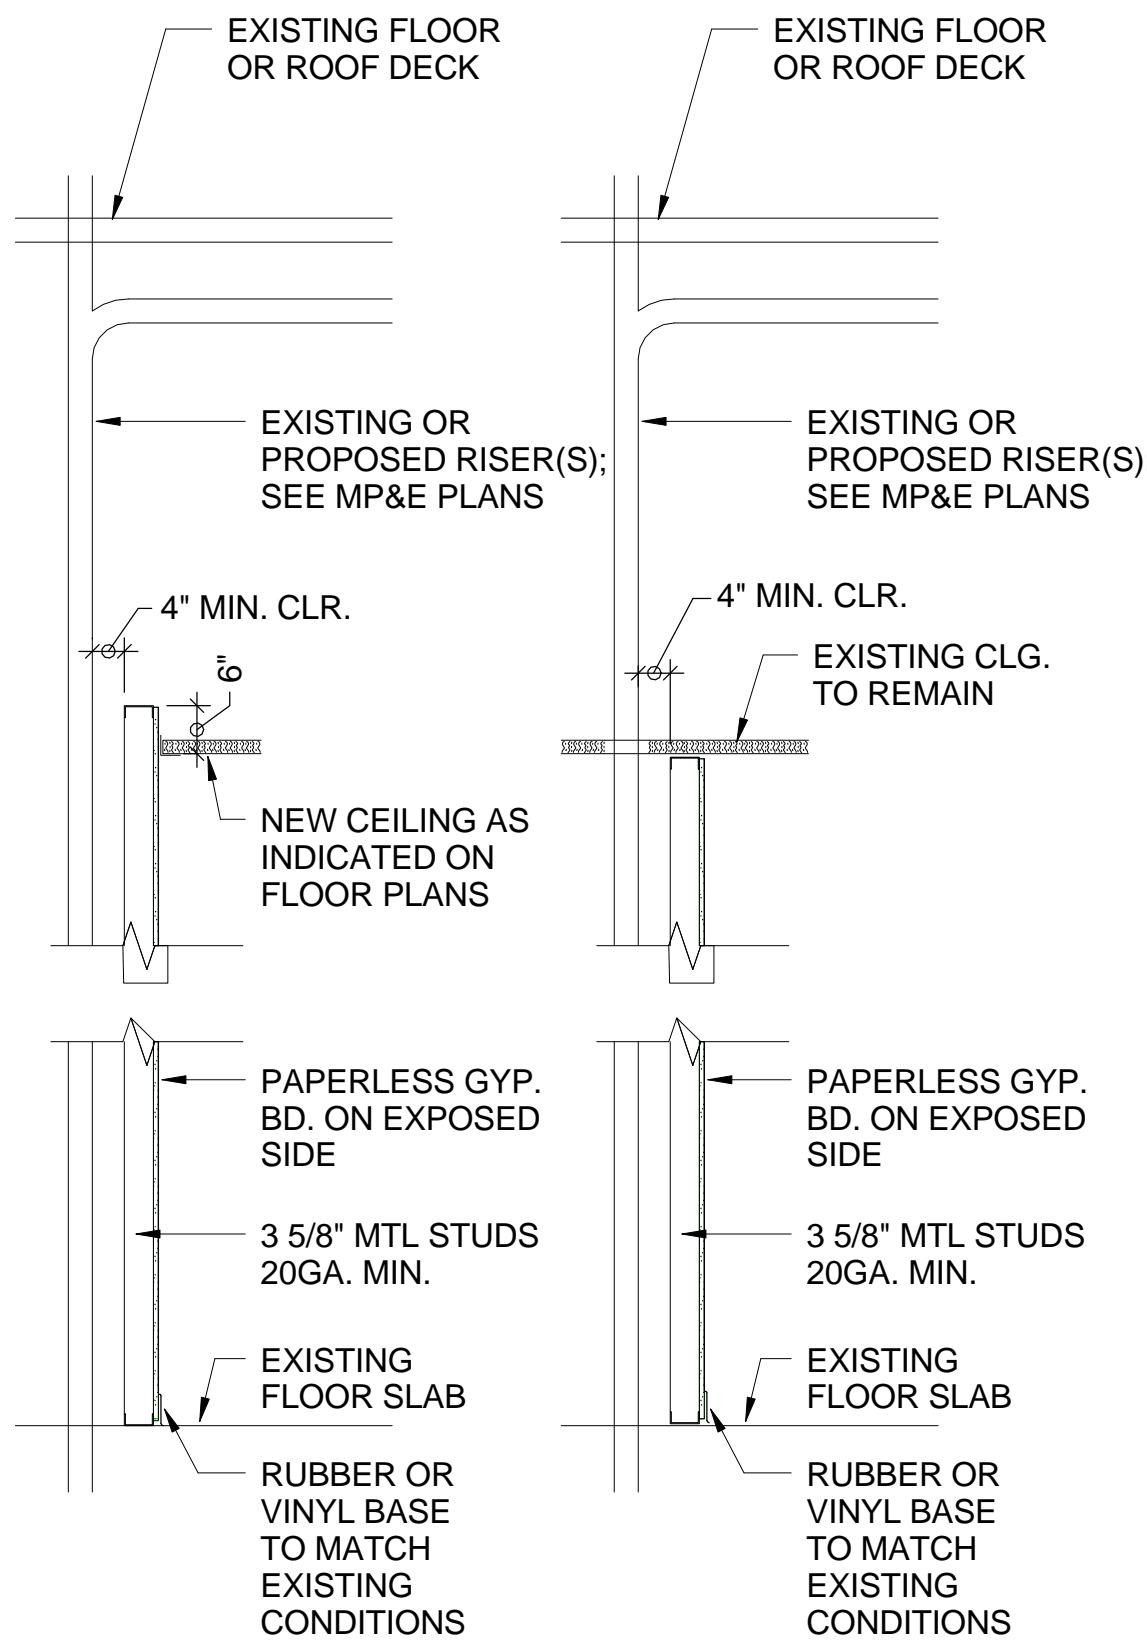


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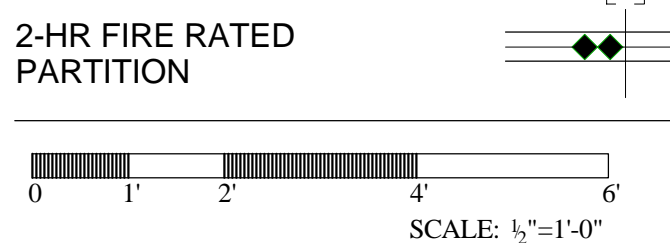
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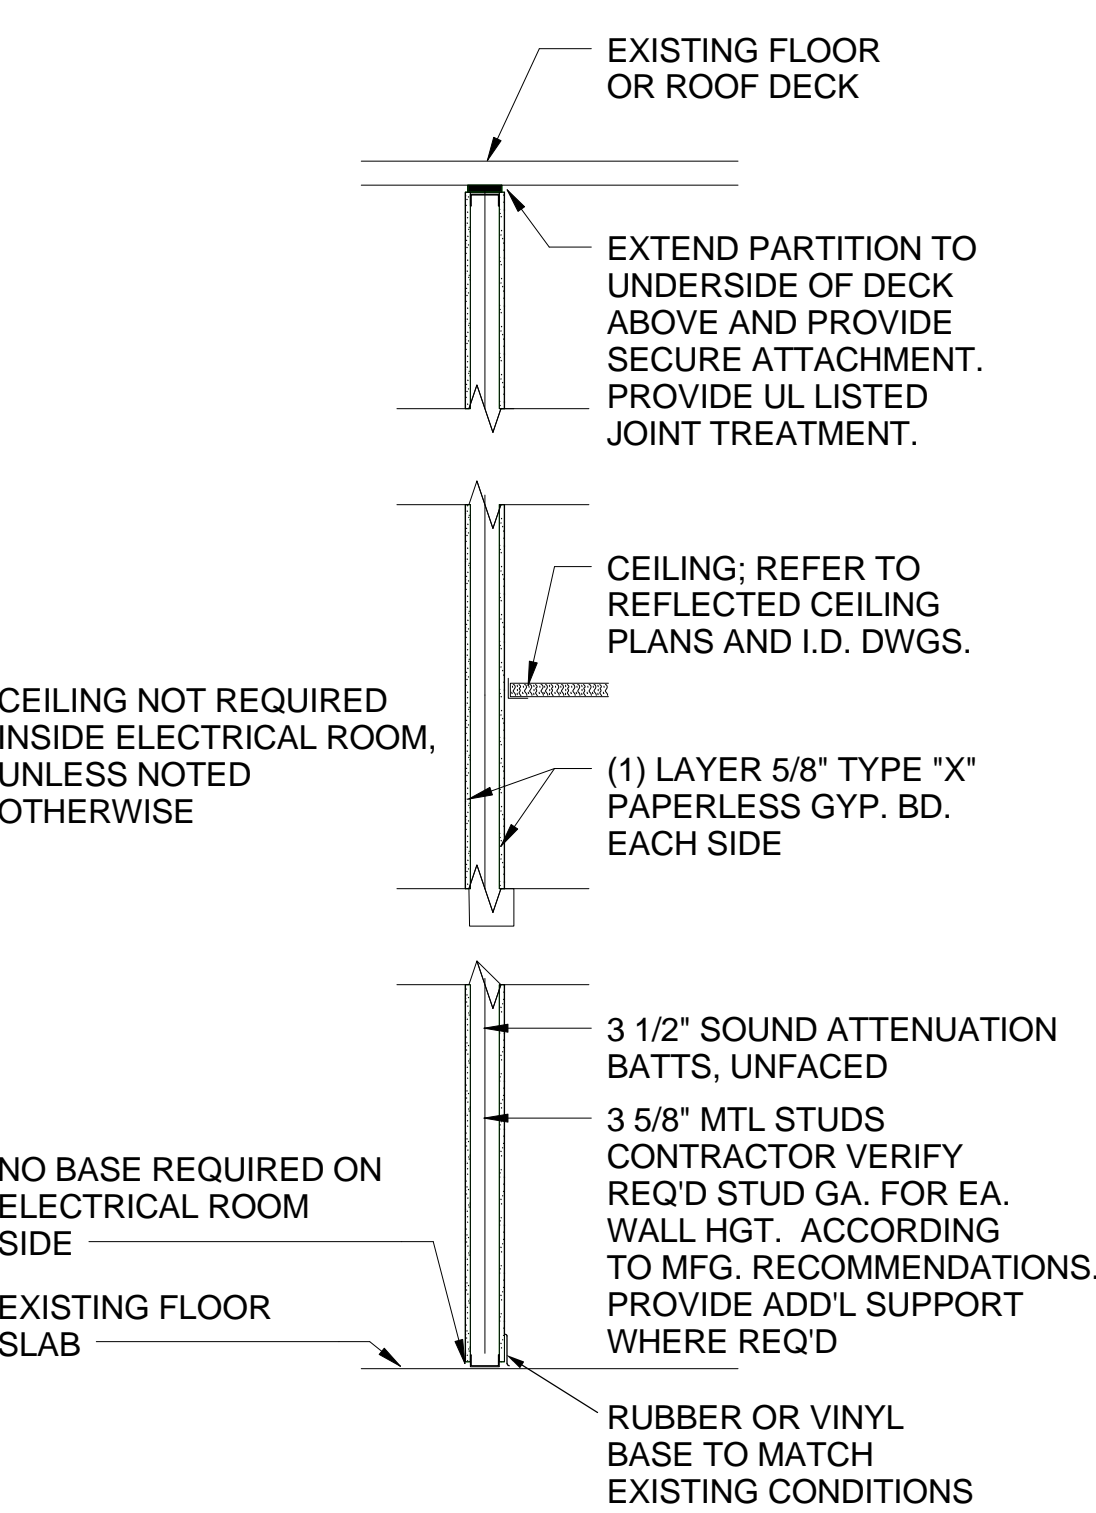
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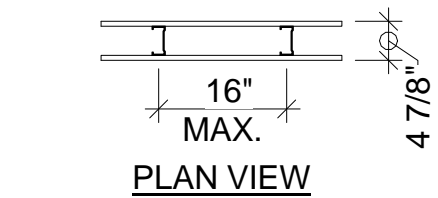
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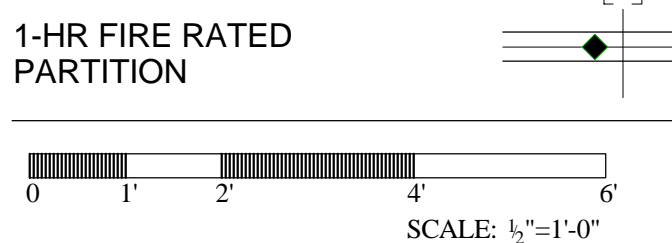
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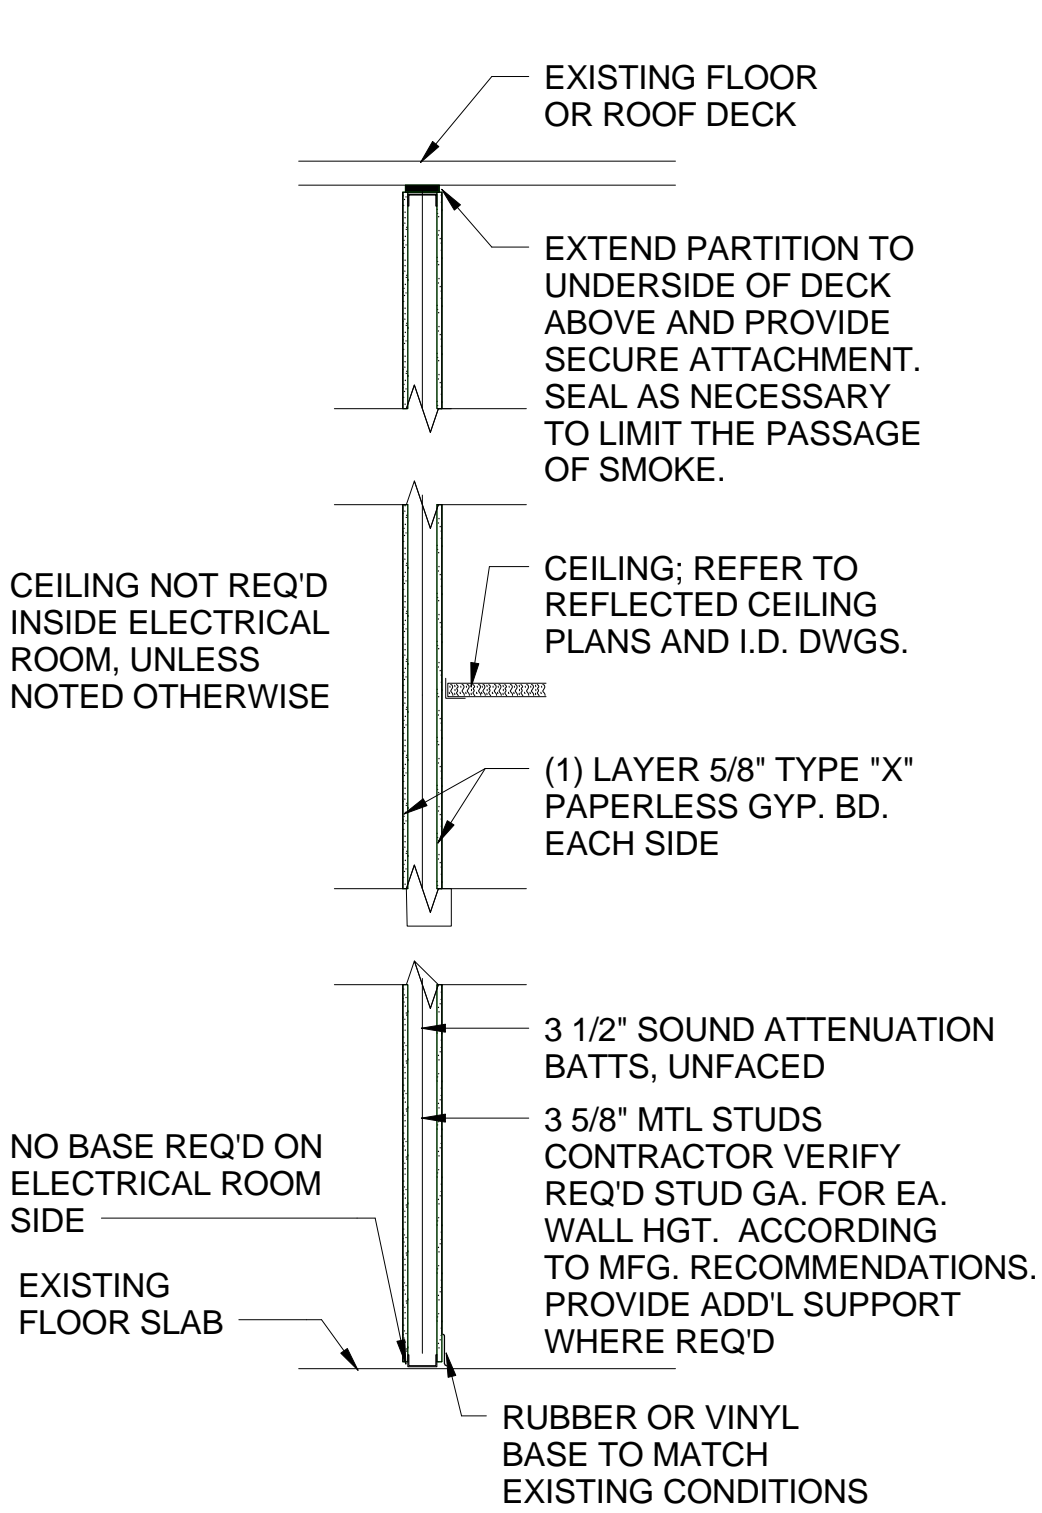
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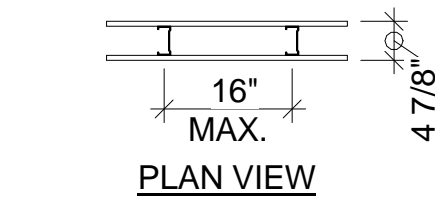
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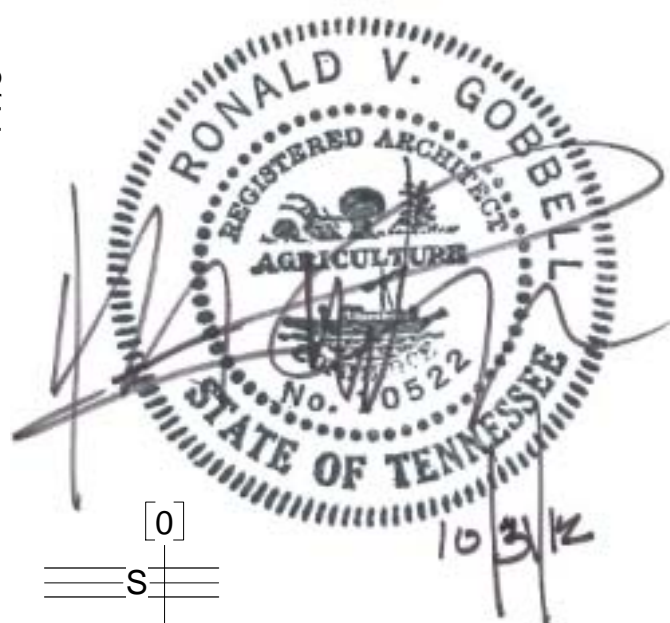
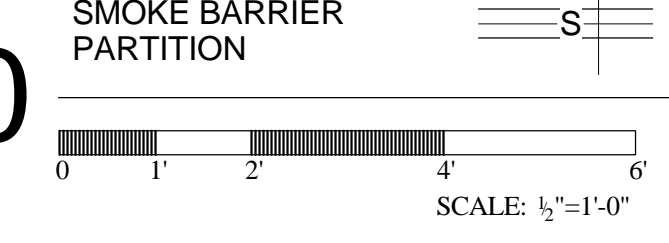
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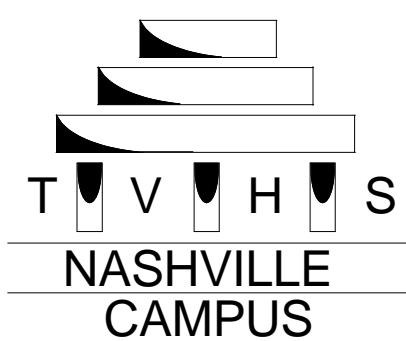
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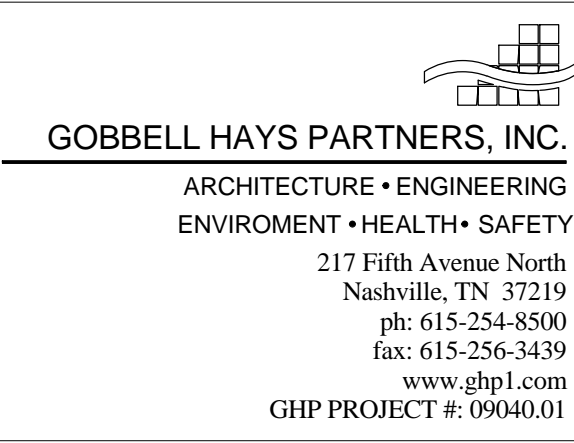
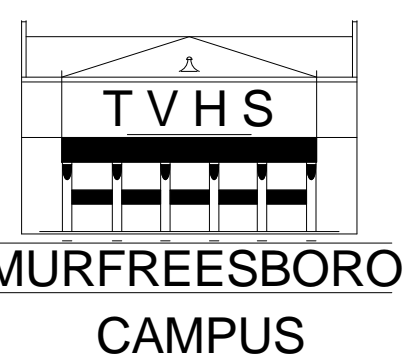
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SHEET TITLE: GEN. NOTES & PARTITION TYPES	PROJECT NUMBER: 626A4-1 1-202
APPROVED BY:	DWG # GC-001
APPROVED BY:	Dwg. 2 of 97
BLDG #	CHECKED BY:
	DRAWN BY:

Department of Veterans Affairs

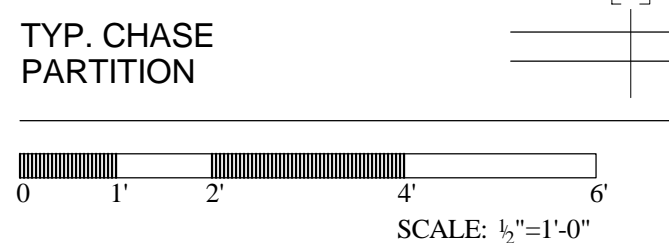1

AREAS WITH THIS HATCH INDICATE
ACM TAR COATING ON DUCT INSULATION

2

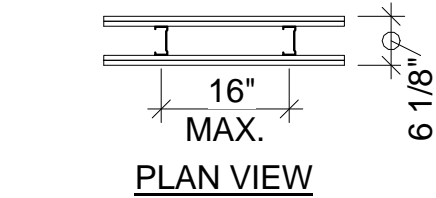AREAS WITH THIS HATCH INDICATE
ACM MASTIC UNDER NON-ACM FLOOR
TILE

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AREAS WITH THIS HATCH INDICATE
ACM PIPE INSULATION

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ACM PIPE FITTING INSULATION

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SAMPLE POSITIVE FOR LEAD

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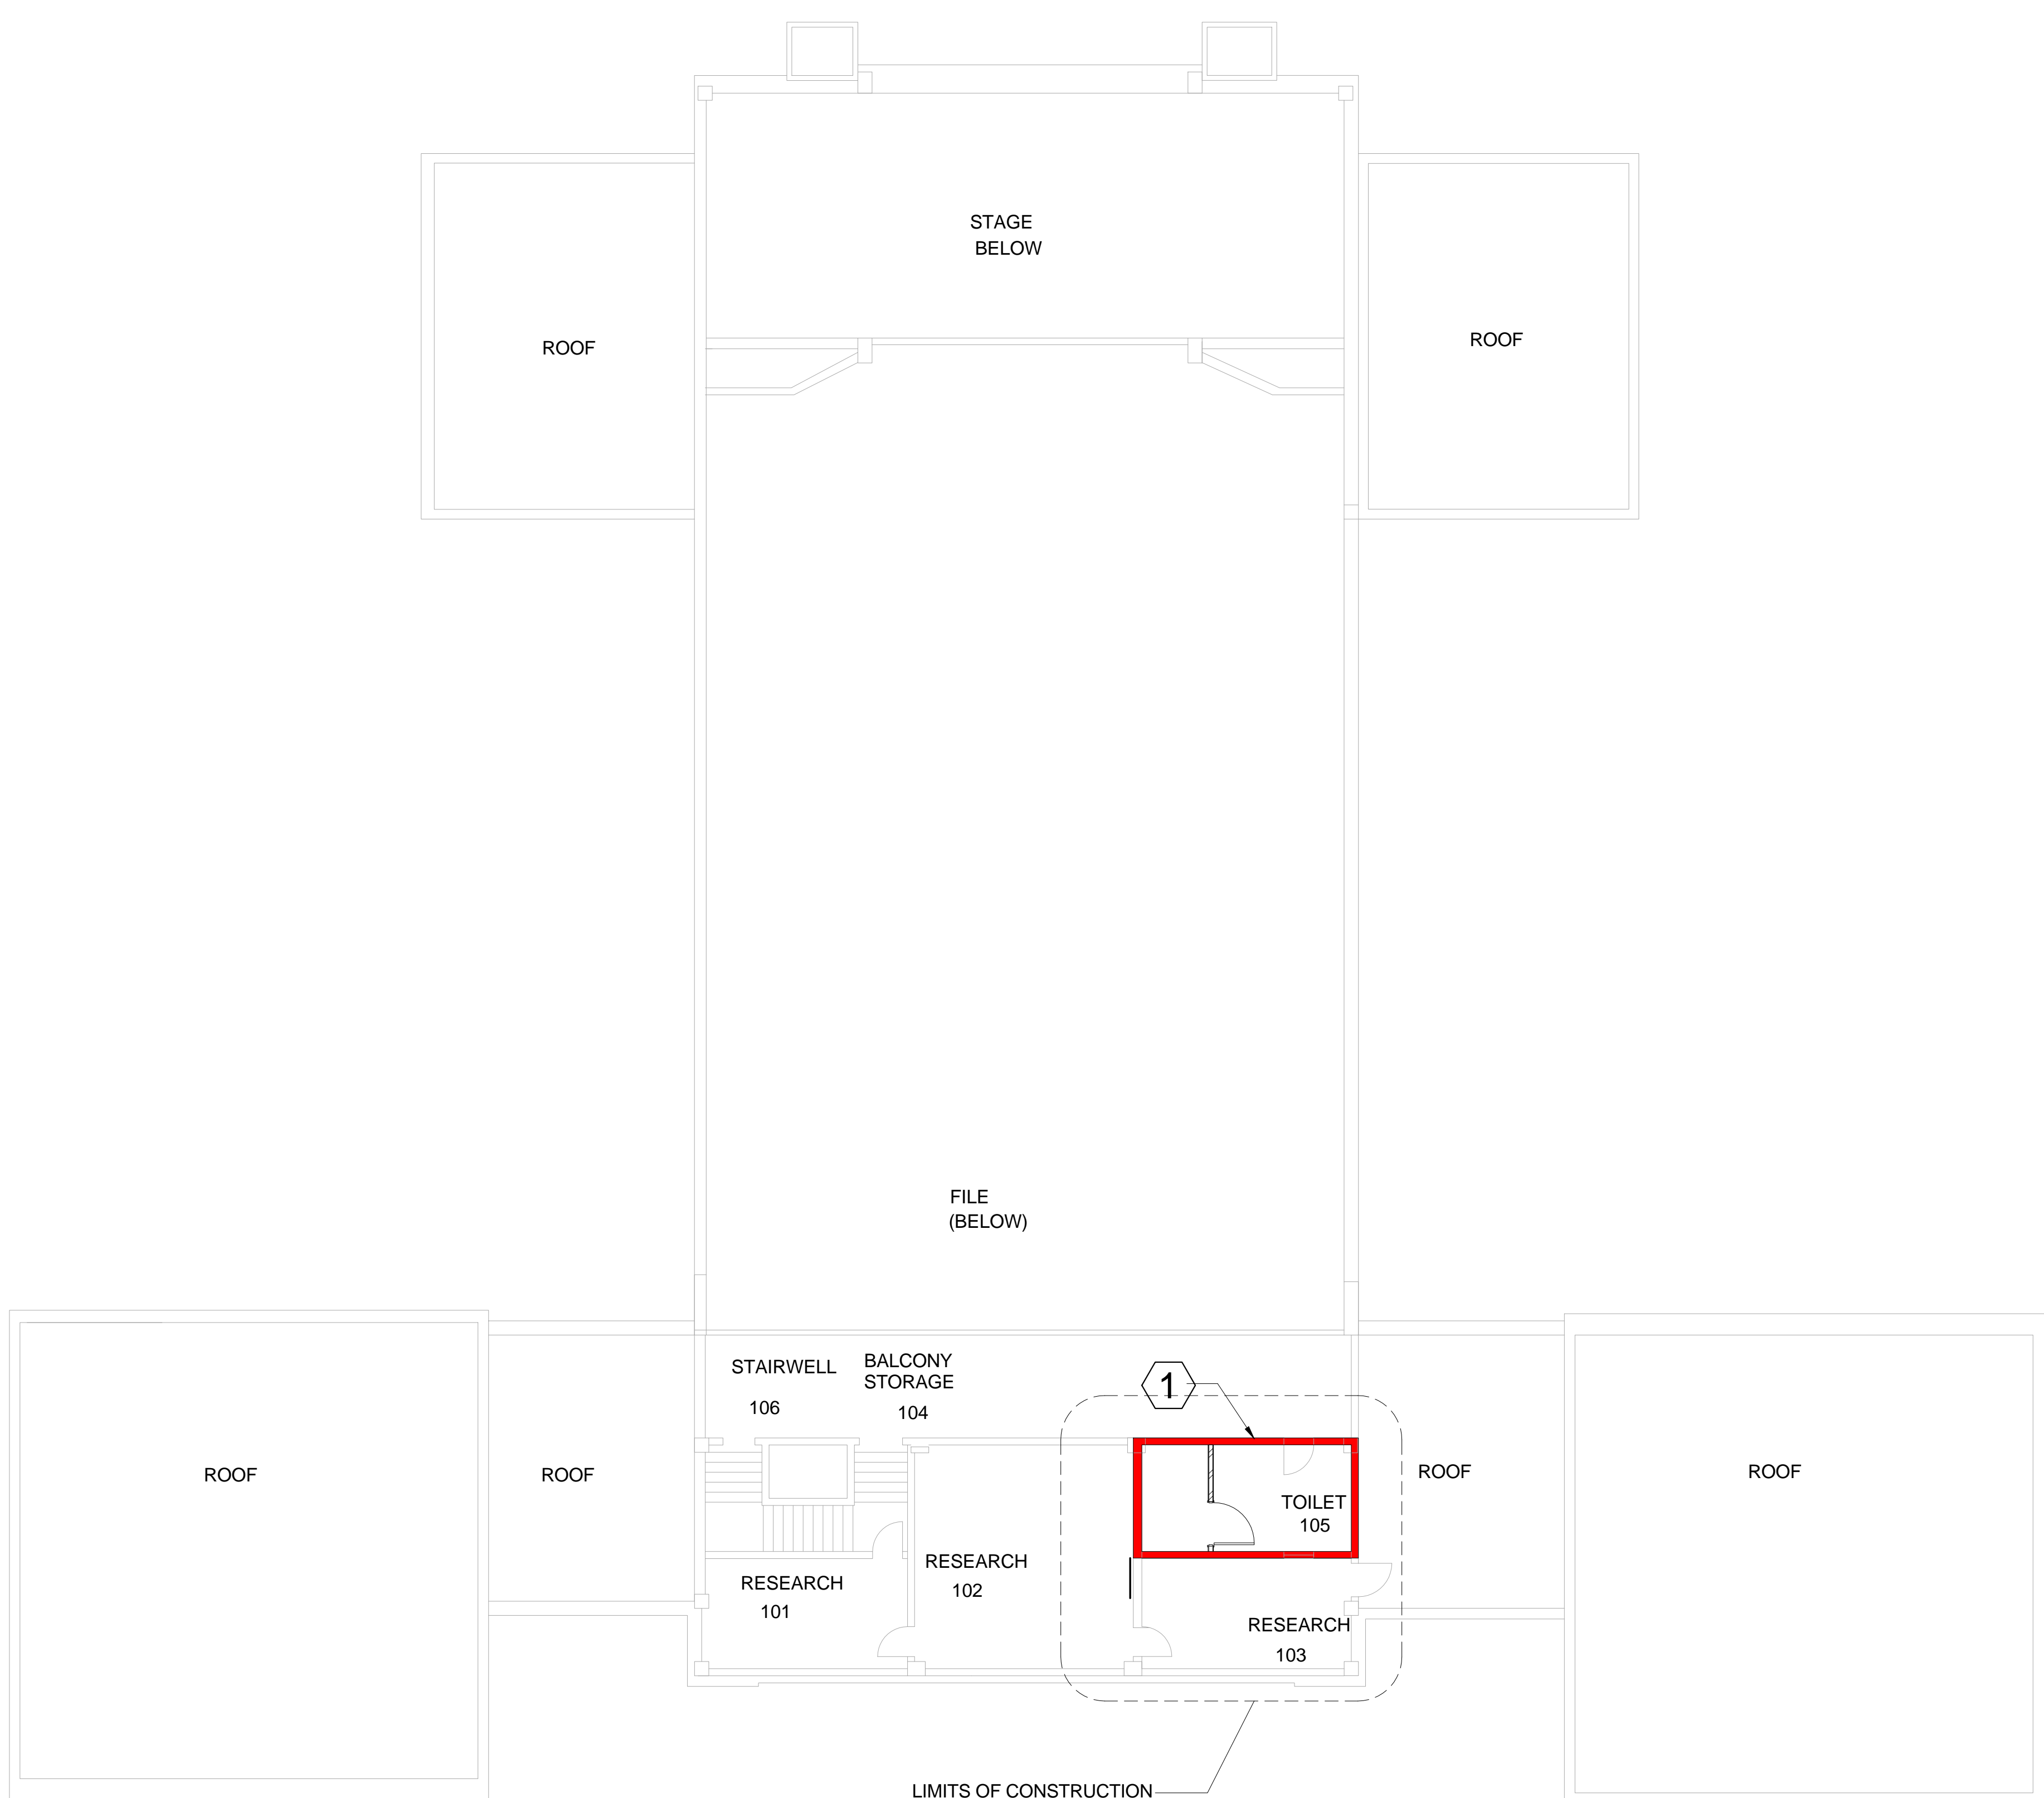
AREAS WITH THIS HATCH INDICATE
ACM TRANSITE PANELS

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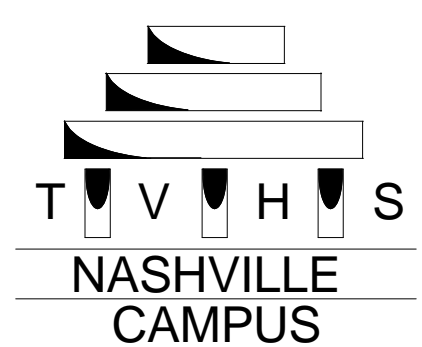


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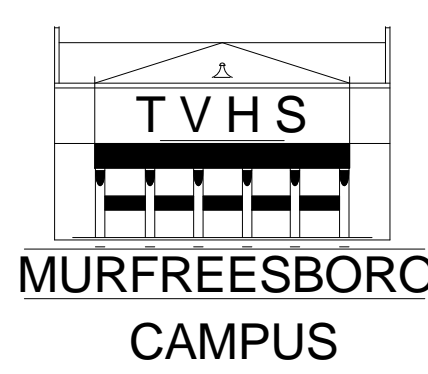
C1 BLDG. #4 - ACM FIRST FLOOR
1/8" = 1'-0"



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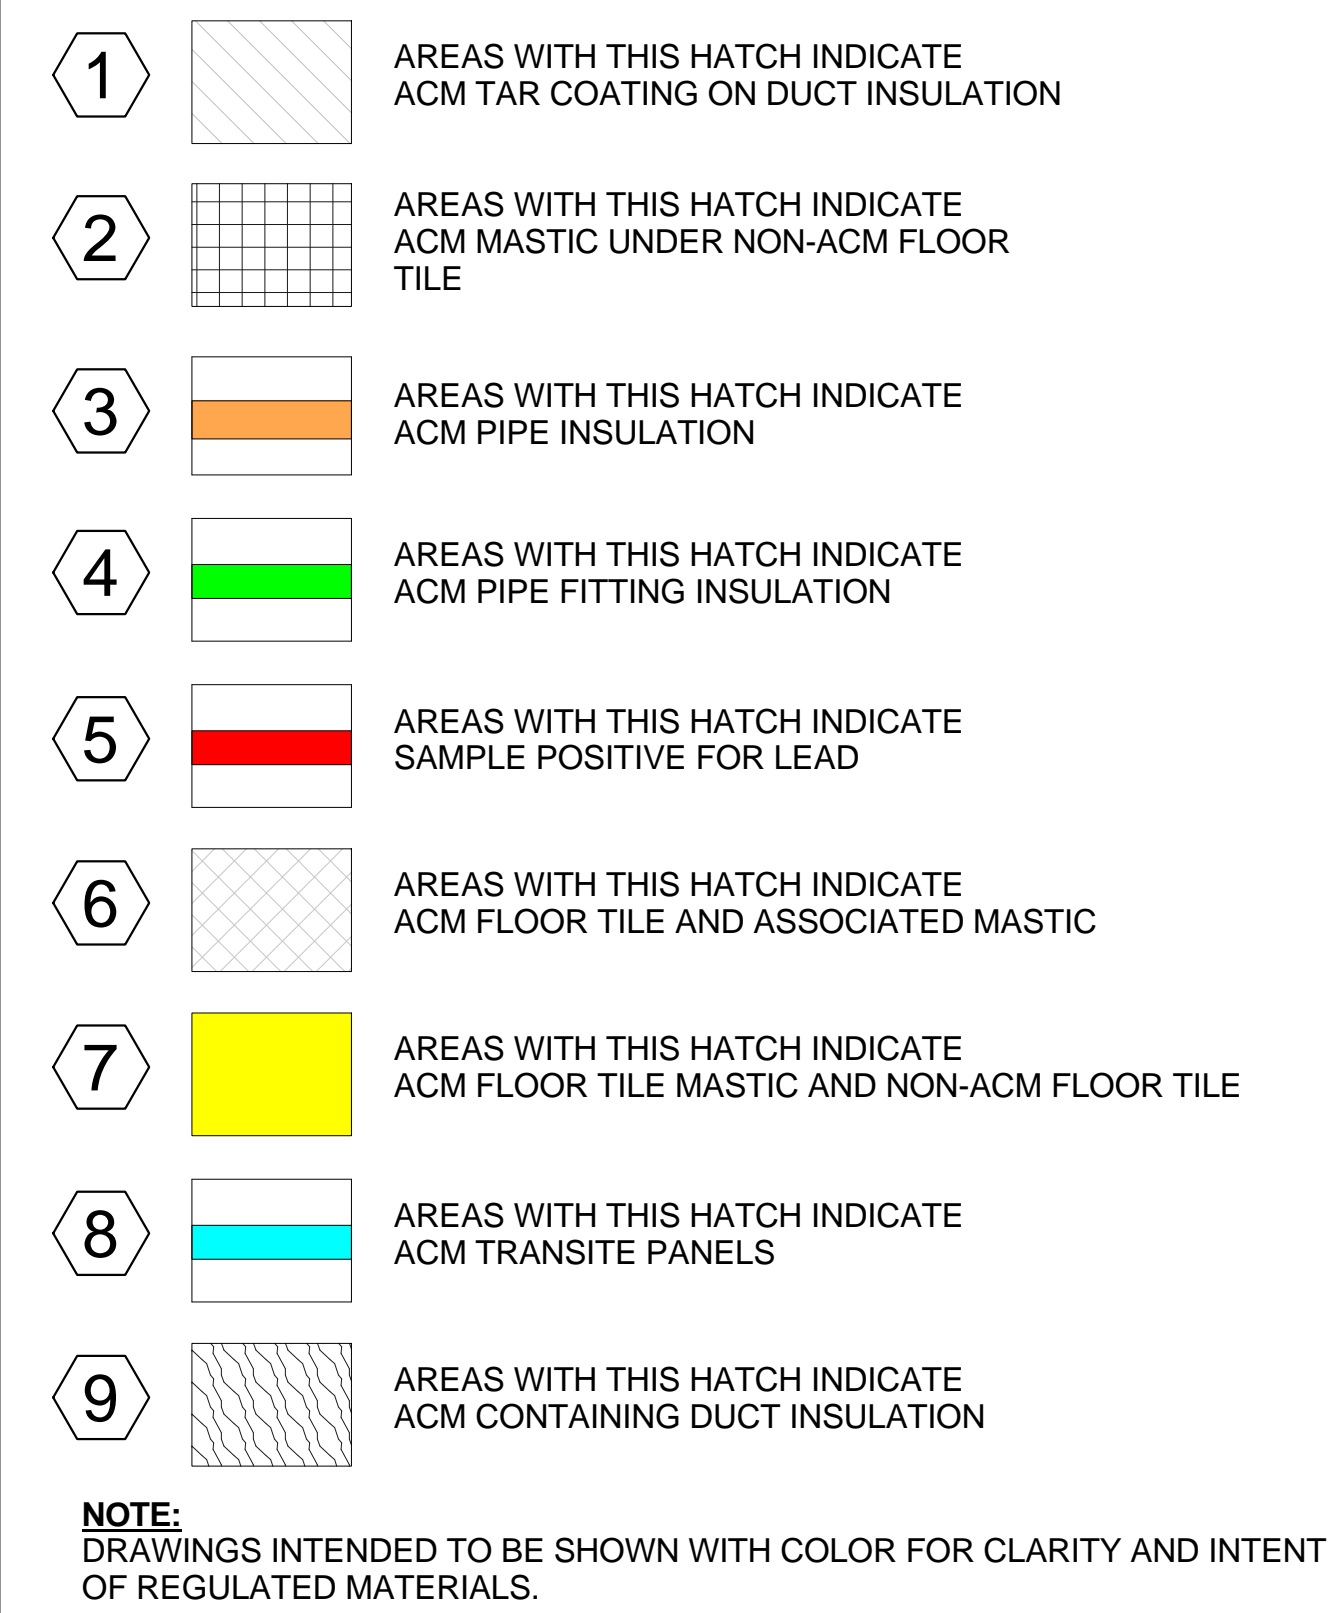
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PROJECT TITLE: UPGRADE ELEC. DISTRIBUTION - PHASE 3		
SHEET TITLE: ACM FIRST FLOOR		
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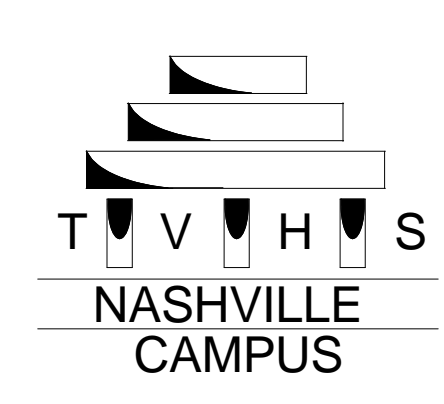
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PROJECT NUMBER: 626A4-1 1-202
DWG # 4-HA-002 Dwg. 4 of 97

Department of
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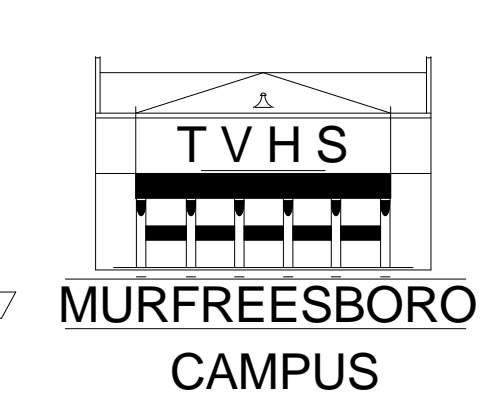


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
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GHP PROJECT #: 09040.01

PROJECT TITLE: UPGRADE ELEC. DISTRIBUTION - PHASE 3		
SHEET TITLE: ACM GROUND FLOOR		
APPROVED BY:		
APPROVED BY:	ALVIN C. YORK CAMPUS 2400 LISBURN PIKE MURFREESBORO, TENNESSEE	
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DATE:
OCTOBER 31, 2012

PROJECT NUMBER:
626A4-1 1-202

DWG #
5-HA-003
Dwg. 5 of 97

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- 1

AREAS WITH THIS HATCH INDICATE
ACM TAR COATING ON DUCT INSULATION
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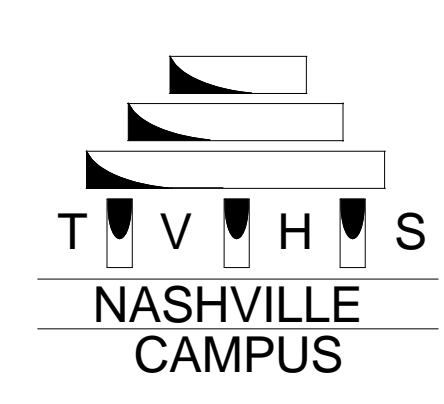


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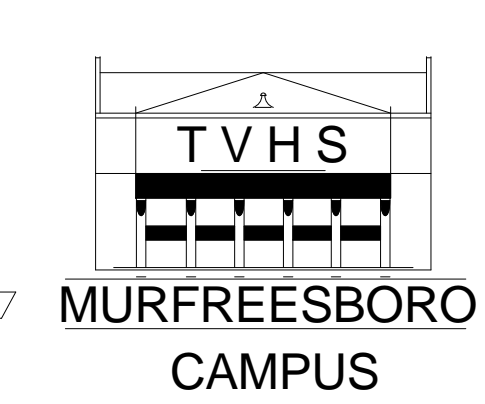
C1 BLDG. #5 - ACM FIRST FLOOR
1/8" = 1'-0"



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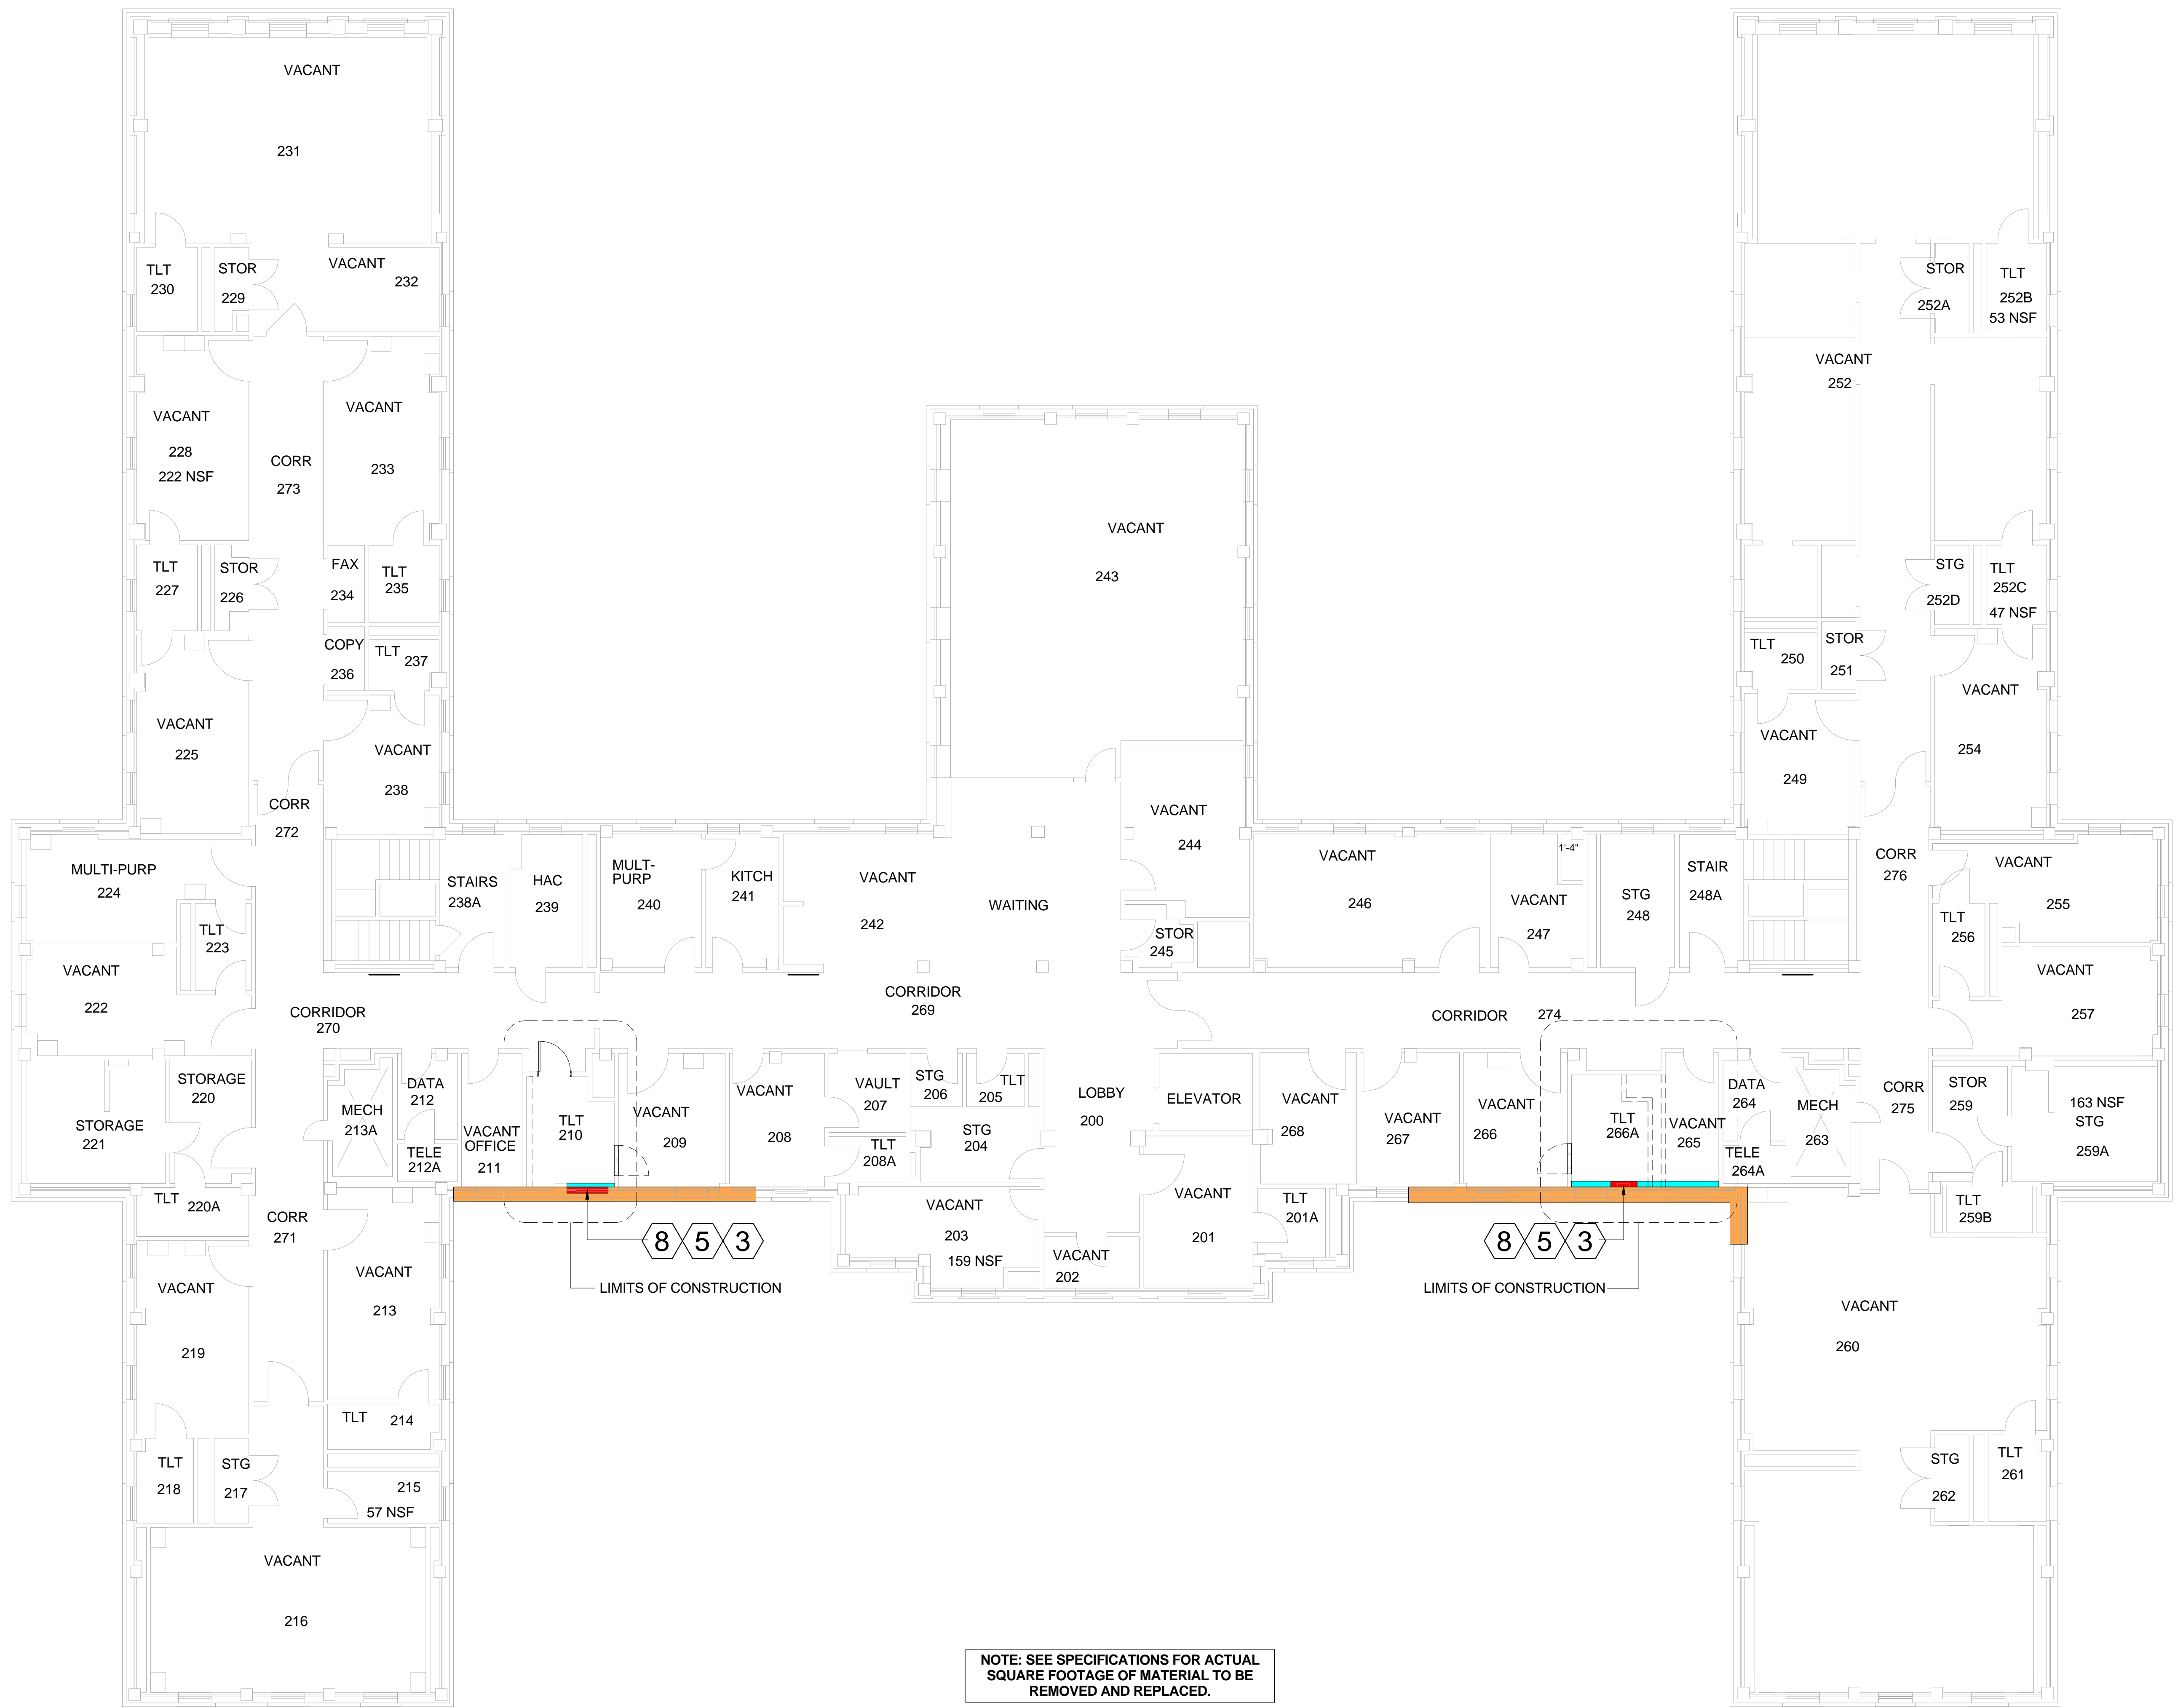


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SHEET TITLE: ACM FIRST FLOOR	PROJECT NUMBER: 626A4-1 1-202
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- 9 AREAS WITH THIS HATCH INDICATE ACM CONTAINING DUCT INSULATION

NOTE:
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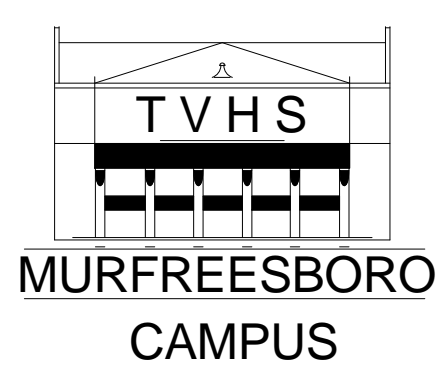
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SHEET TITLE: ACM SECOND FLOOR	PROJECT NUMBER: 626A4-1 1-202
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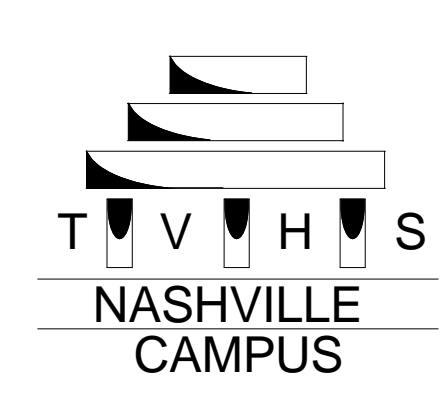
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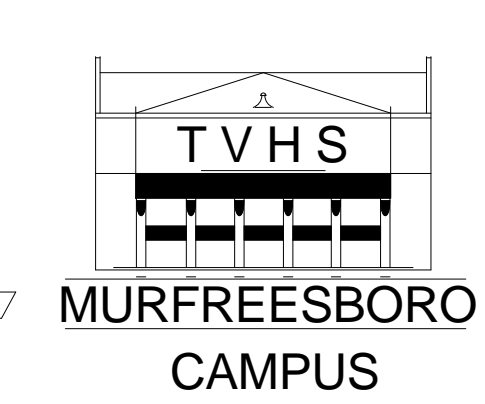
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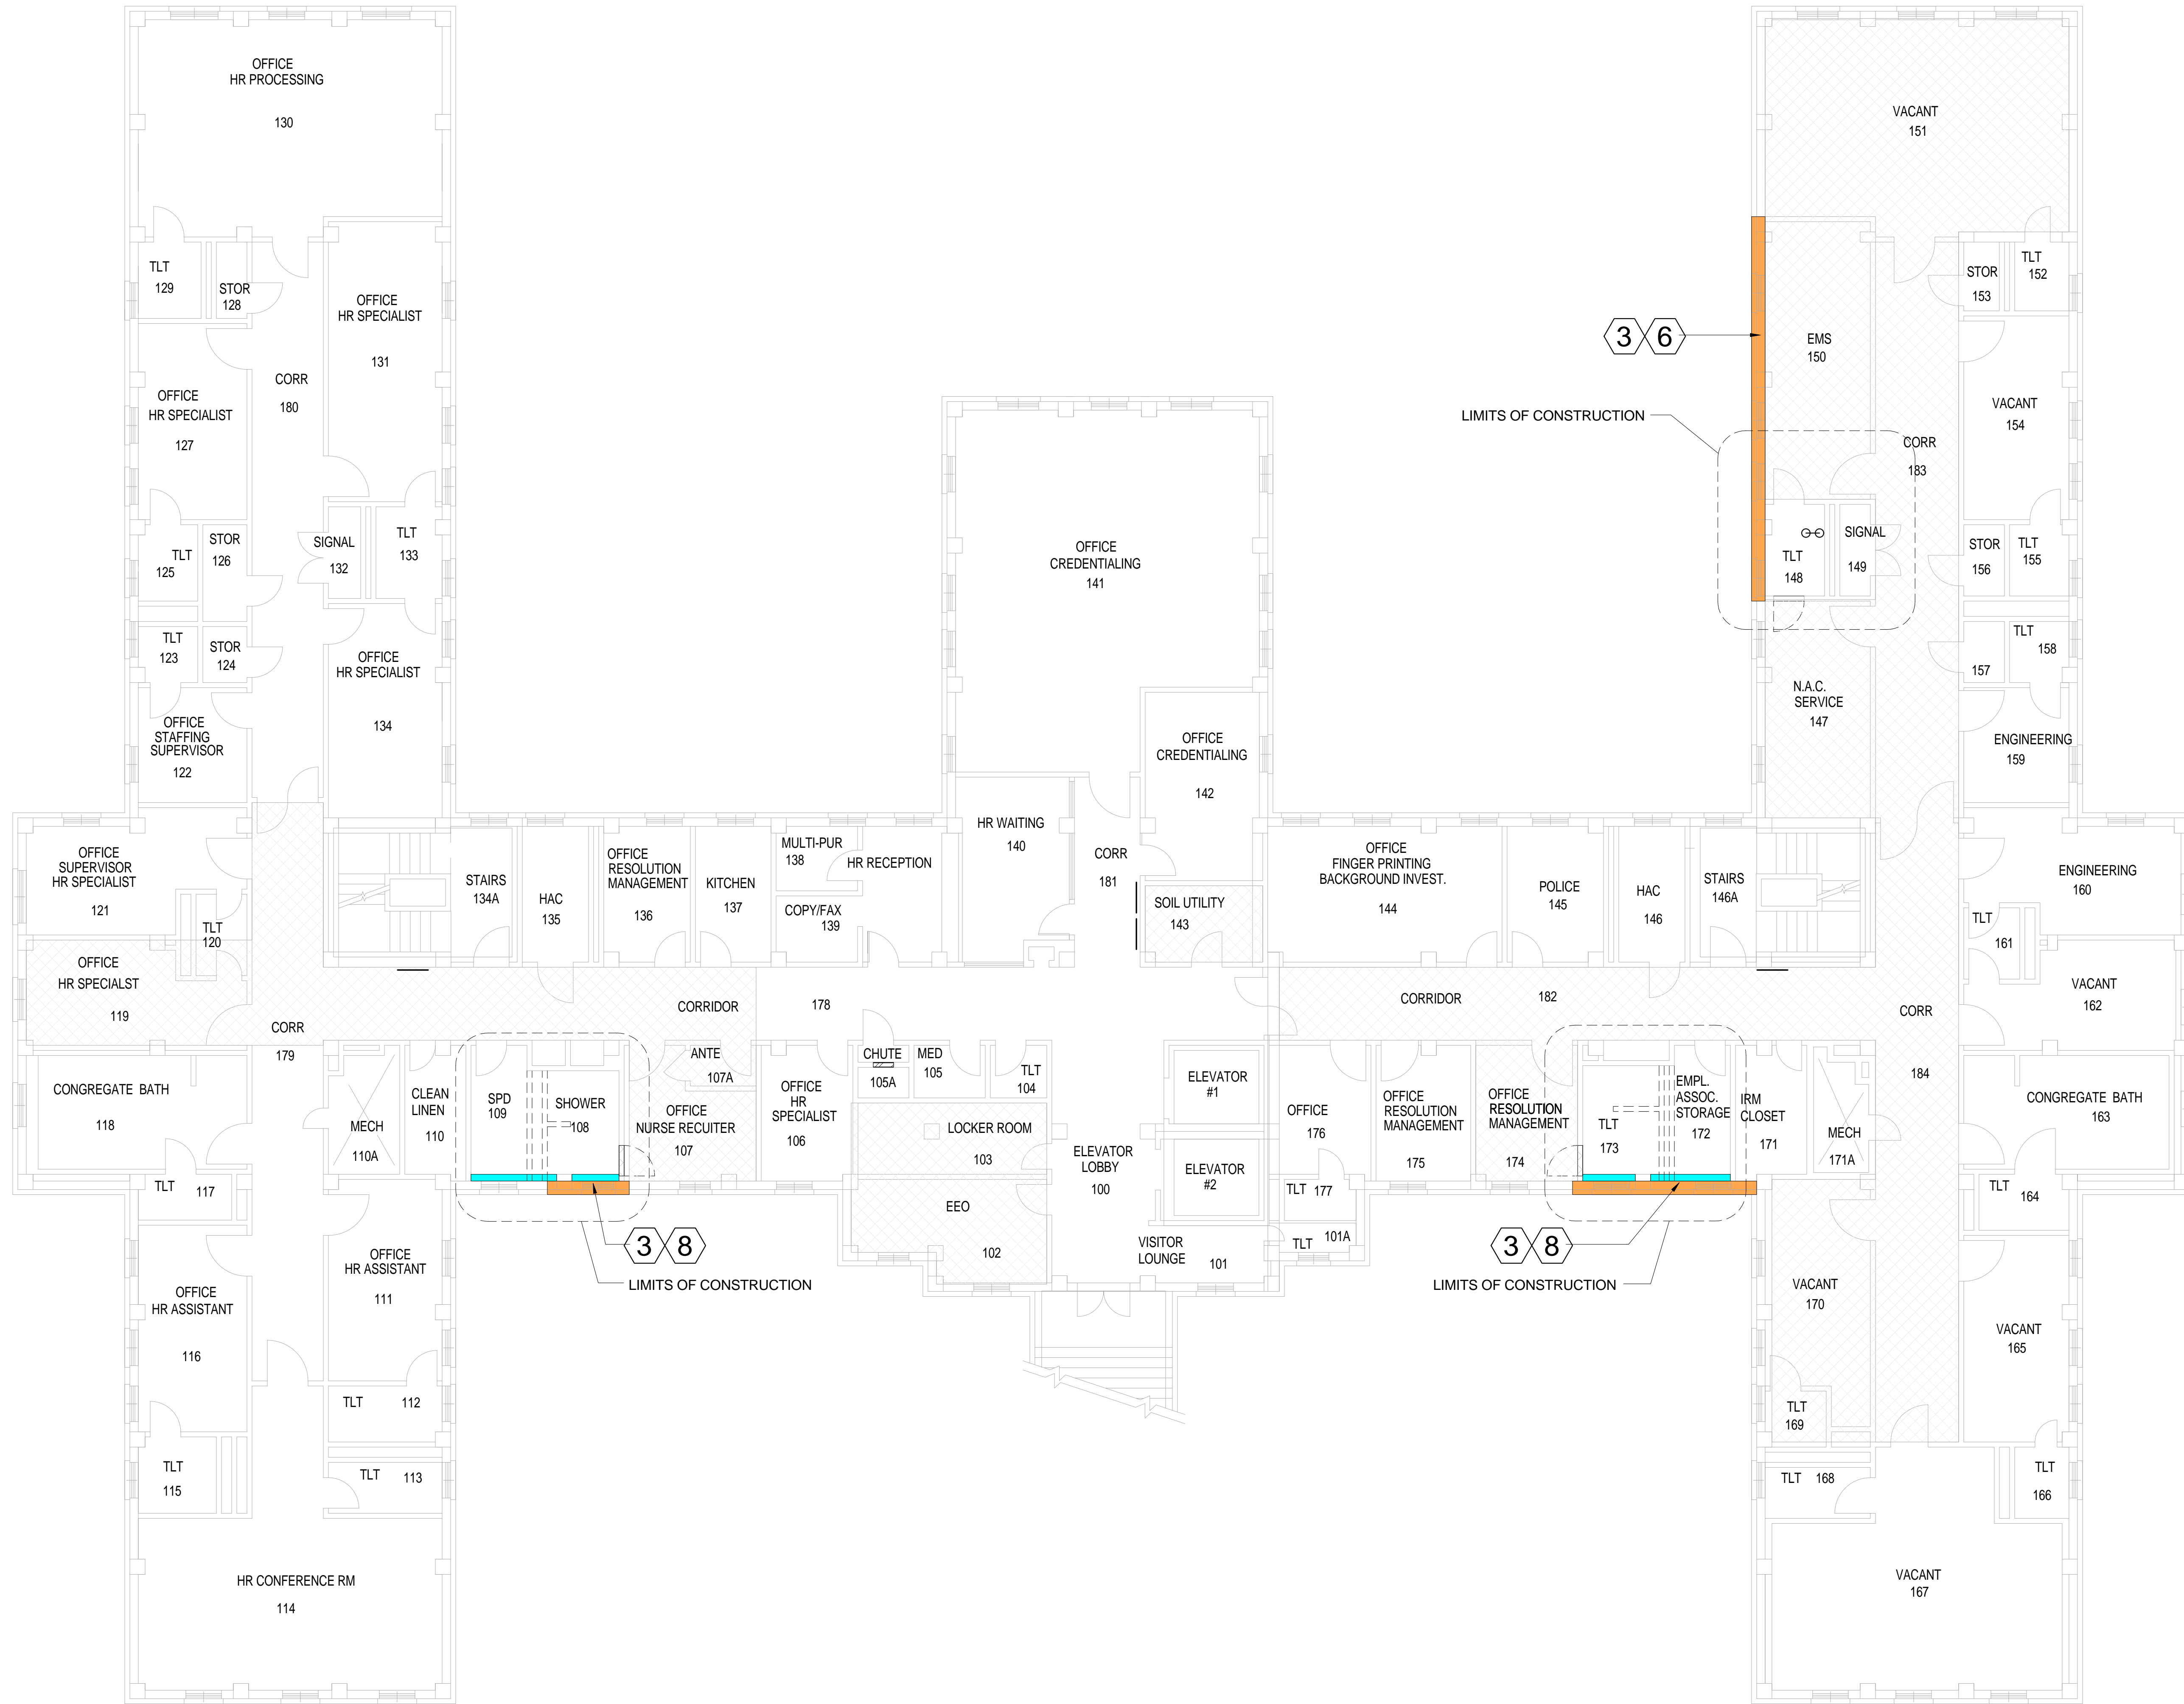


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PROJECT TITLE: UPGRADE ELEC. DISTRIBUTION - PHASE 3	DATE: OCTOBER 31, 2012
SHEET TITLE: ACM GROUND FLOOR	PROJECT NUMBER: 626A4-1 1-202
APPROVED BY:	DWG # 6-HA-006
APPROVED BY:	Dwg. 8 of 97
BLDG #	CHECKED BY:
	DRAWN BY:

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- 1 AREAS WITH THIS HATCH INDICATE ACM TAR COATING ON DUCT INSULATION
- 2 AREAS WITH THIS HATCH INDICATE ACM MASTIC UNDER NON-ACM FLOOR TILE
- 3 AREAS WITH THIS HATCH INDICATE ACM PIPE INSULATION
- 4 AREAS WITH THIS HATCH INDICATE ACM PIPE FITTING INSULATION
- 5 AREAS WITH THIS HATCH INDICATE SAMPLE POSITIVE FOR LEAD
- 6 AREAS WITH THIS HATCH INDICATE ACM FLOOR TILE AND ASSOCIATED MASTIC
- 7 AREAS WITH THIS HATCH INDICATE ACM FLOOR TILE MASTIC AND NON-ACM FLOOR TILE
- 8 AREAS WITH THIS HATCH INDICATE ACM TRANSITE PANELS
- 9 AREAS WITH THIS HATCH INDICATE ACM CONTAINING DUCT INSULATION

NOTE:
DRAWINGS INTENDED TO BE SHOWN WITH COLOR FOR CLARITY AND INTENT OF REGULATED MATERIALS.

NOTE: SEE SPECIFICATIONS FOR ACTUAL SQUARE FOOTAGE OF MATERIAL TO BE REMOVED AND REPLACED.


C1 BLDG. #6 - ACM FIRST FLOOR
1/8" = 1'-0"



REVISION	DATE



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GHP PROJECT #: 09040.01

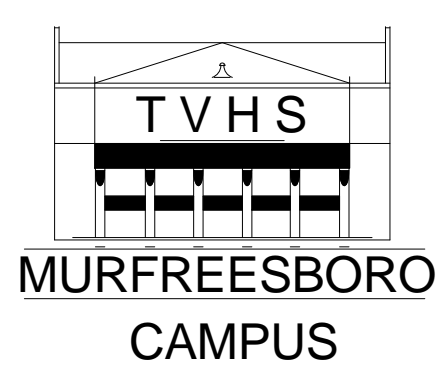PROJECT TITLE: UPGRADE ELEC. DISTRIBUTION - PHASE 3	DATE: OCTOBER 31, 2012
SHEET TITLE: ACM FIRST FLOOR	PROJECT NUMBER: 626A4-1 1-202
APPROVED BY:	DWG # 6-HA-007
APPROVED BY:	Dwg. 9 of 97
BLDG #	CHECKED BY:
	DRAWN BY:

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1. AREAS WITH THIS HATCH INDICATE ACM TAR COATING ON DUCT INSULATION
2. AREAS WITH THIS HATCH INDICATE ACM MASTIC UNDER NON-ACM FLOOR TILE
3. AREAS WITH THIS HATCH INDICATE ACM PIPE INSULATION
4. AREAS WITH THIS HATCH INDICATE ACM PIPE FITTING INSULATION
5. AREAS WITH THIS HATCH INDICATE SAMPLE POSITIVE FOR LEAD
6. AREAS WITH THIS HATCH INDICATE ACM FLOOR TILE AND ASSOCIATED MASTIC
7. AREAS WITH THIS HATCH INDICATE ACM FLOOR TILE MASTIC AND NON-ACM FLOOR TILE
8. AREAS WITH THIS HATCH INDICATE ACM TRANSITE PANELS
9. AREAS WITH THIS HATCH INDICATE ACM CONTAINING DUCT INSULATION

NOTE:
DRAWINGS INTENDED TO BE SHOWN WITH COLOR FOR CLARITY AND INTENT OF REGULATED MATERIALS.


C1 BLDG. #6 - ACM SECOND FLOOR
1/8" = 1'-0"



REVISION	DATE



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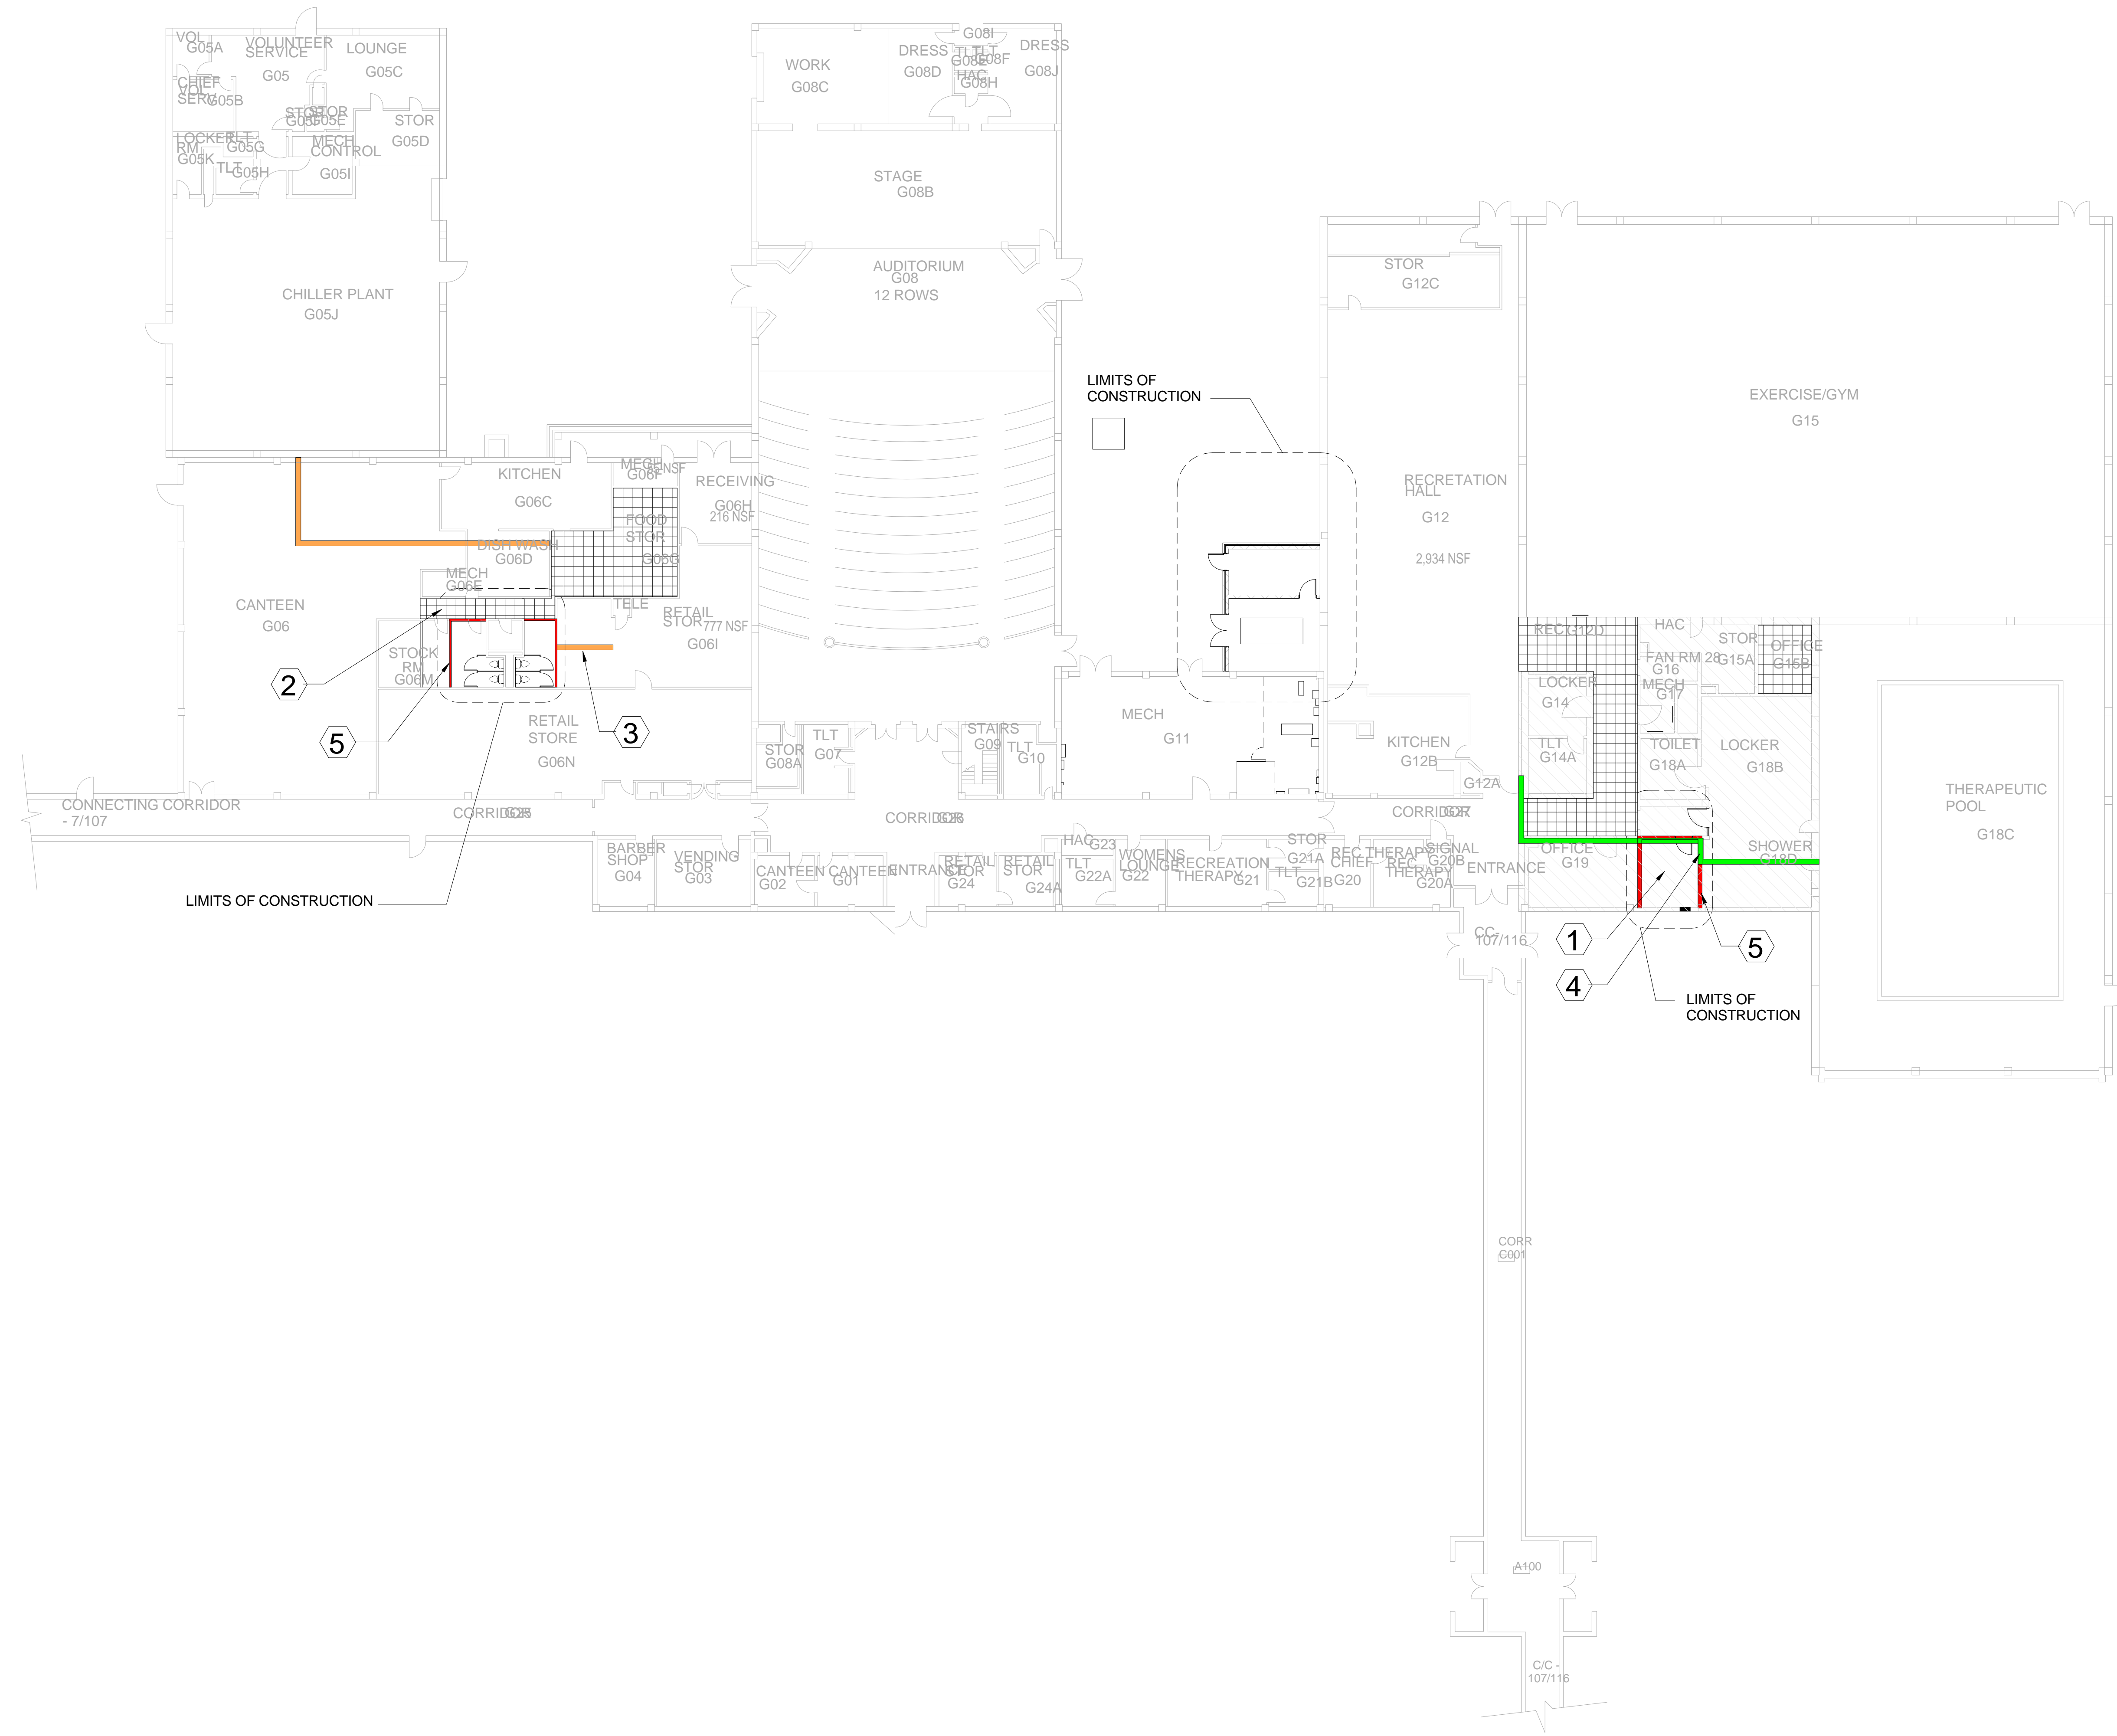

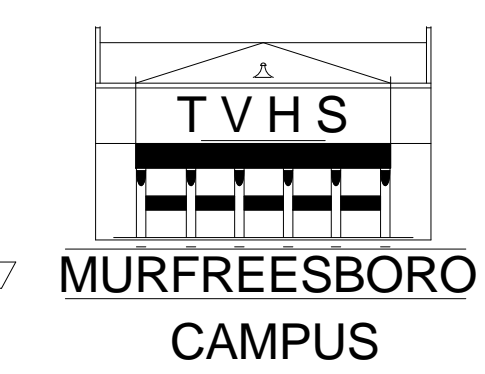
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GHP PROJECT #: 00040.01

PROJECT TITLE: UPGRADE ELEC. DISTRIBUTION - PHASE 3	DATE: OCTOBER 31, 2012
SHEET TITLE: ACM SECOND FLOOR	PROJECT NUMBER: 626A4-1 1-202
APPROVED BY:	DWG # 6-HA-008
APPROVED BY:	Dwg. 10 of 97
BLDG #	CHECKED BY:
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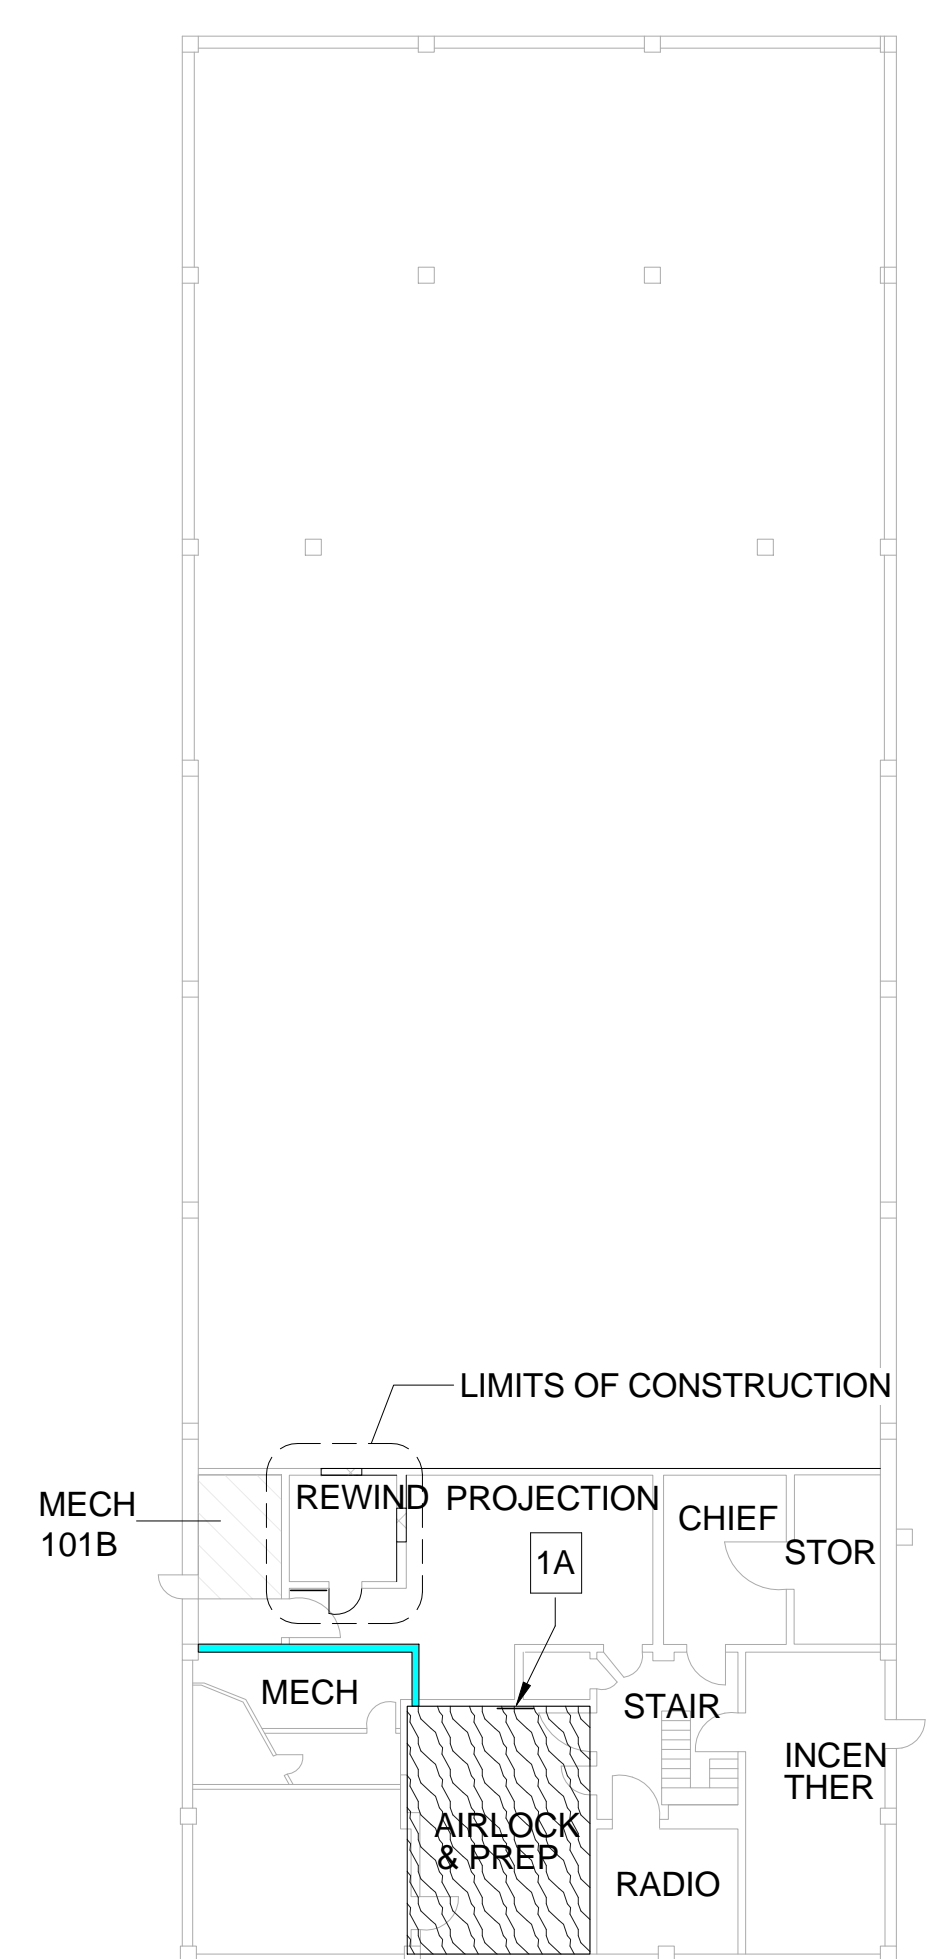


- 1. AREAS WITH THIS HATCH INDICATE ACM TAR COATING ON DUCT INSULATION
- 2. AREAS WITH THIS HATCH INDICATE ACM MASTIC UNDER NON-ACM FLOOR TILE
- 3. AREAS WITH THIS HATCH INDICATE ACM PIPE INSULATION
- 4. AREAS WITH THIS HATCH INDICATE ACM PIPE FITTING INSULATION
- 5. AREAS WITH THIS HATCH INDICATE SAMPLE POSITIVE FOR LEAD
- 6. AREAS WITH THIS HATCH INDICATE ACM FLOOR TILE AND ASSOCIATED MASTIC
- 7. AREAS WITH THIS HATCH INDICATE ACM FLOOR TILE MASTIC AND NON-ACM FLOOR TILE
- 8. AREAS WITH THIS HATCH INDICATE ACM TRANSITE PANELS
- 9. AREAS WITH THIS HATCH INDICATE ACM CONTAINING DUCT INSULATION

NOTE: DRAWINGS INTENDED TO BE SHOWN WITH COLOR FOR CLARITY AND INTENT OF REGULATED MATERIALS.

C1 BLDG. #107 - ACM GROUND FLOOR
1/16" = 1'-0"


E1 BLDG. #107 - ACM FIRST FLOOR
1/16" = 1'-0"



REVISION	DATE



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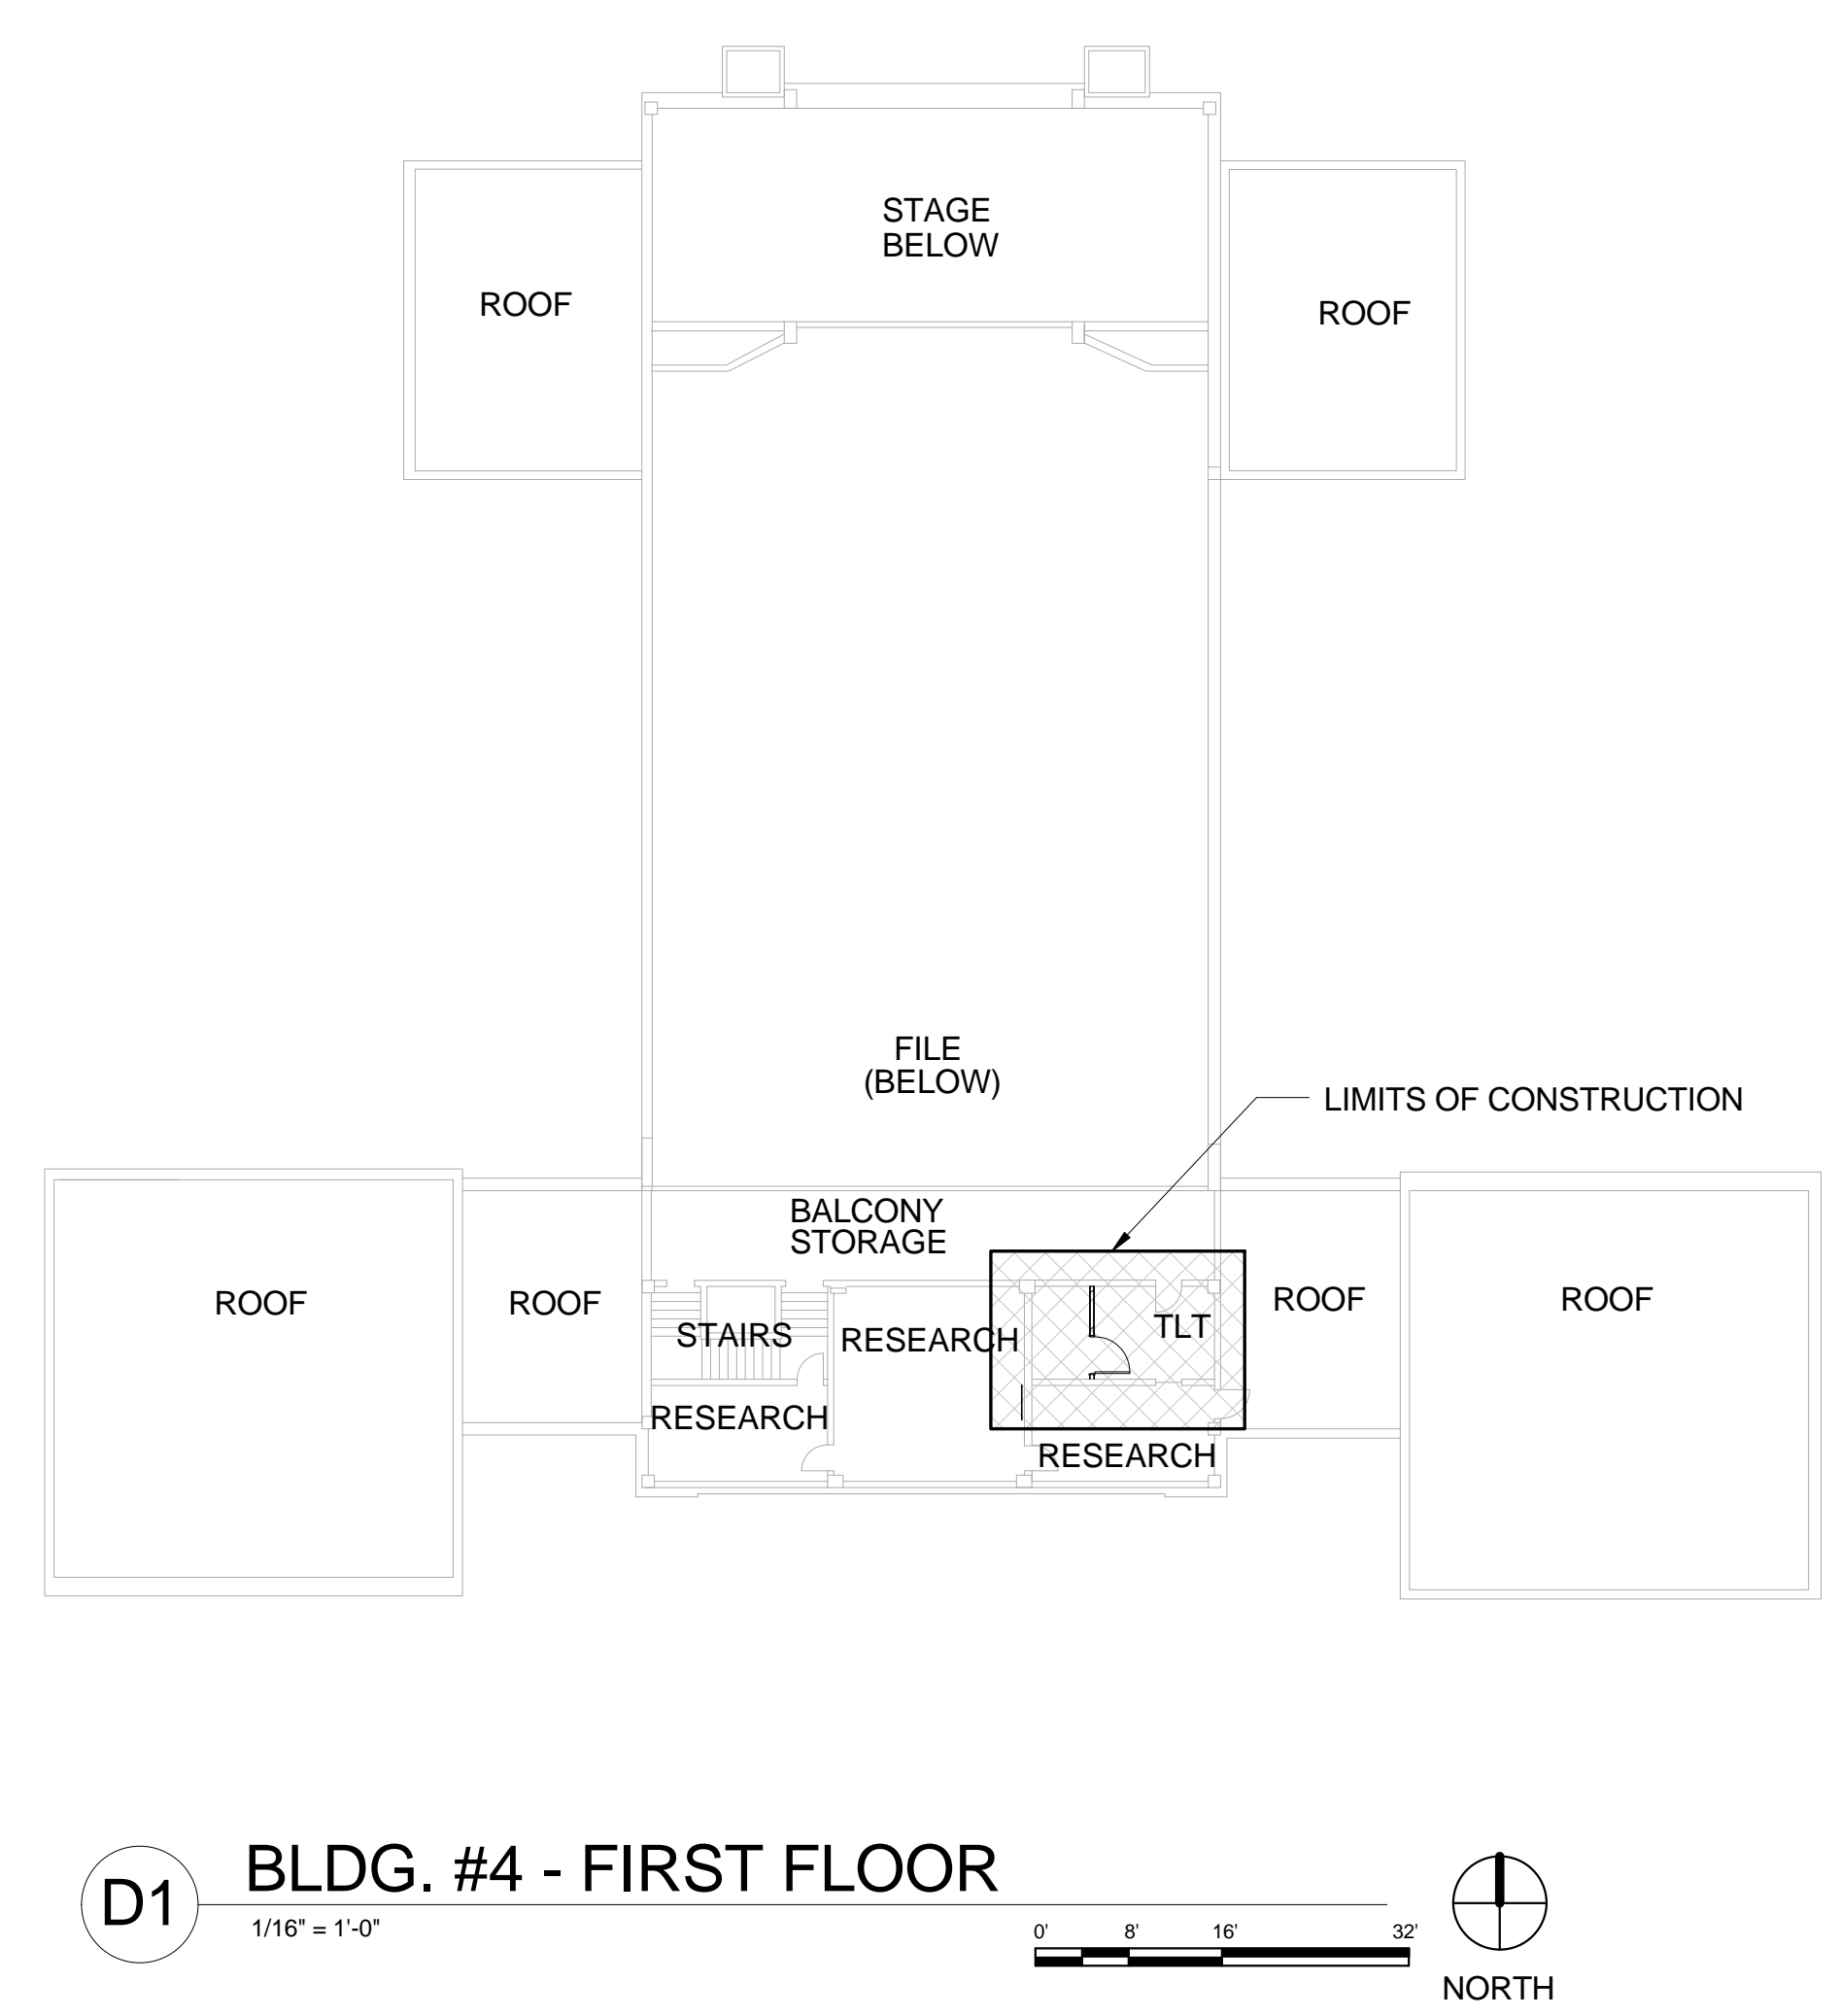
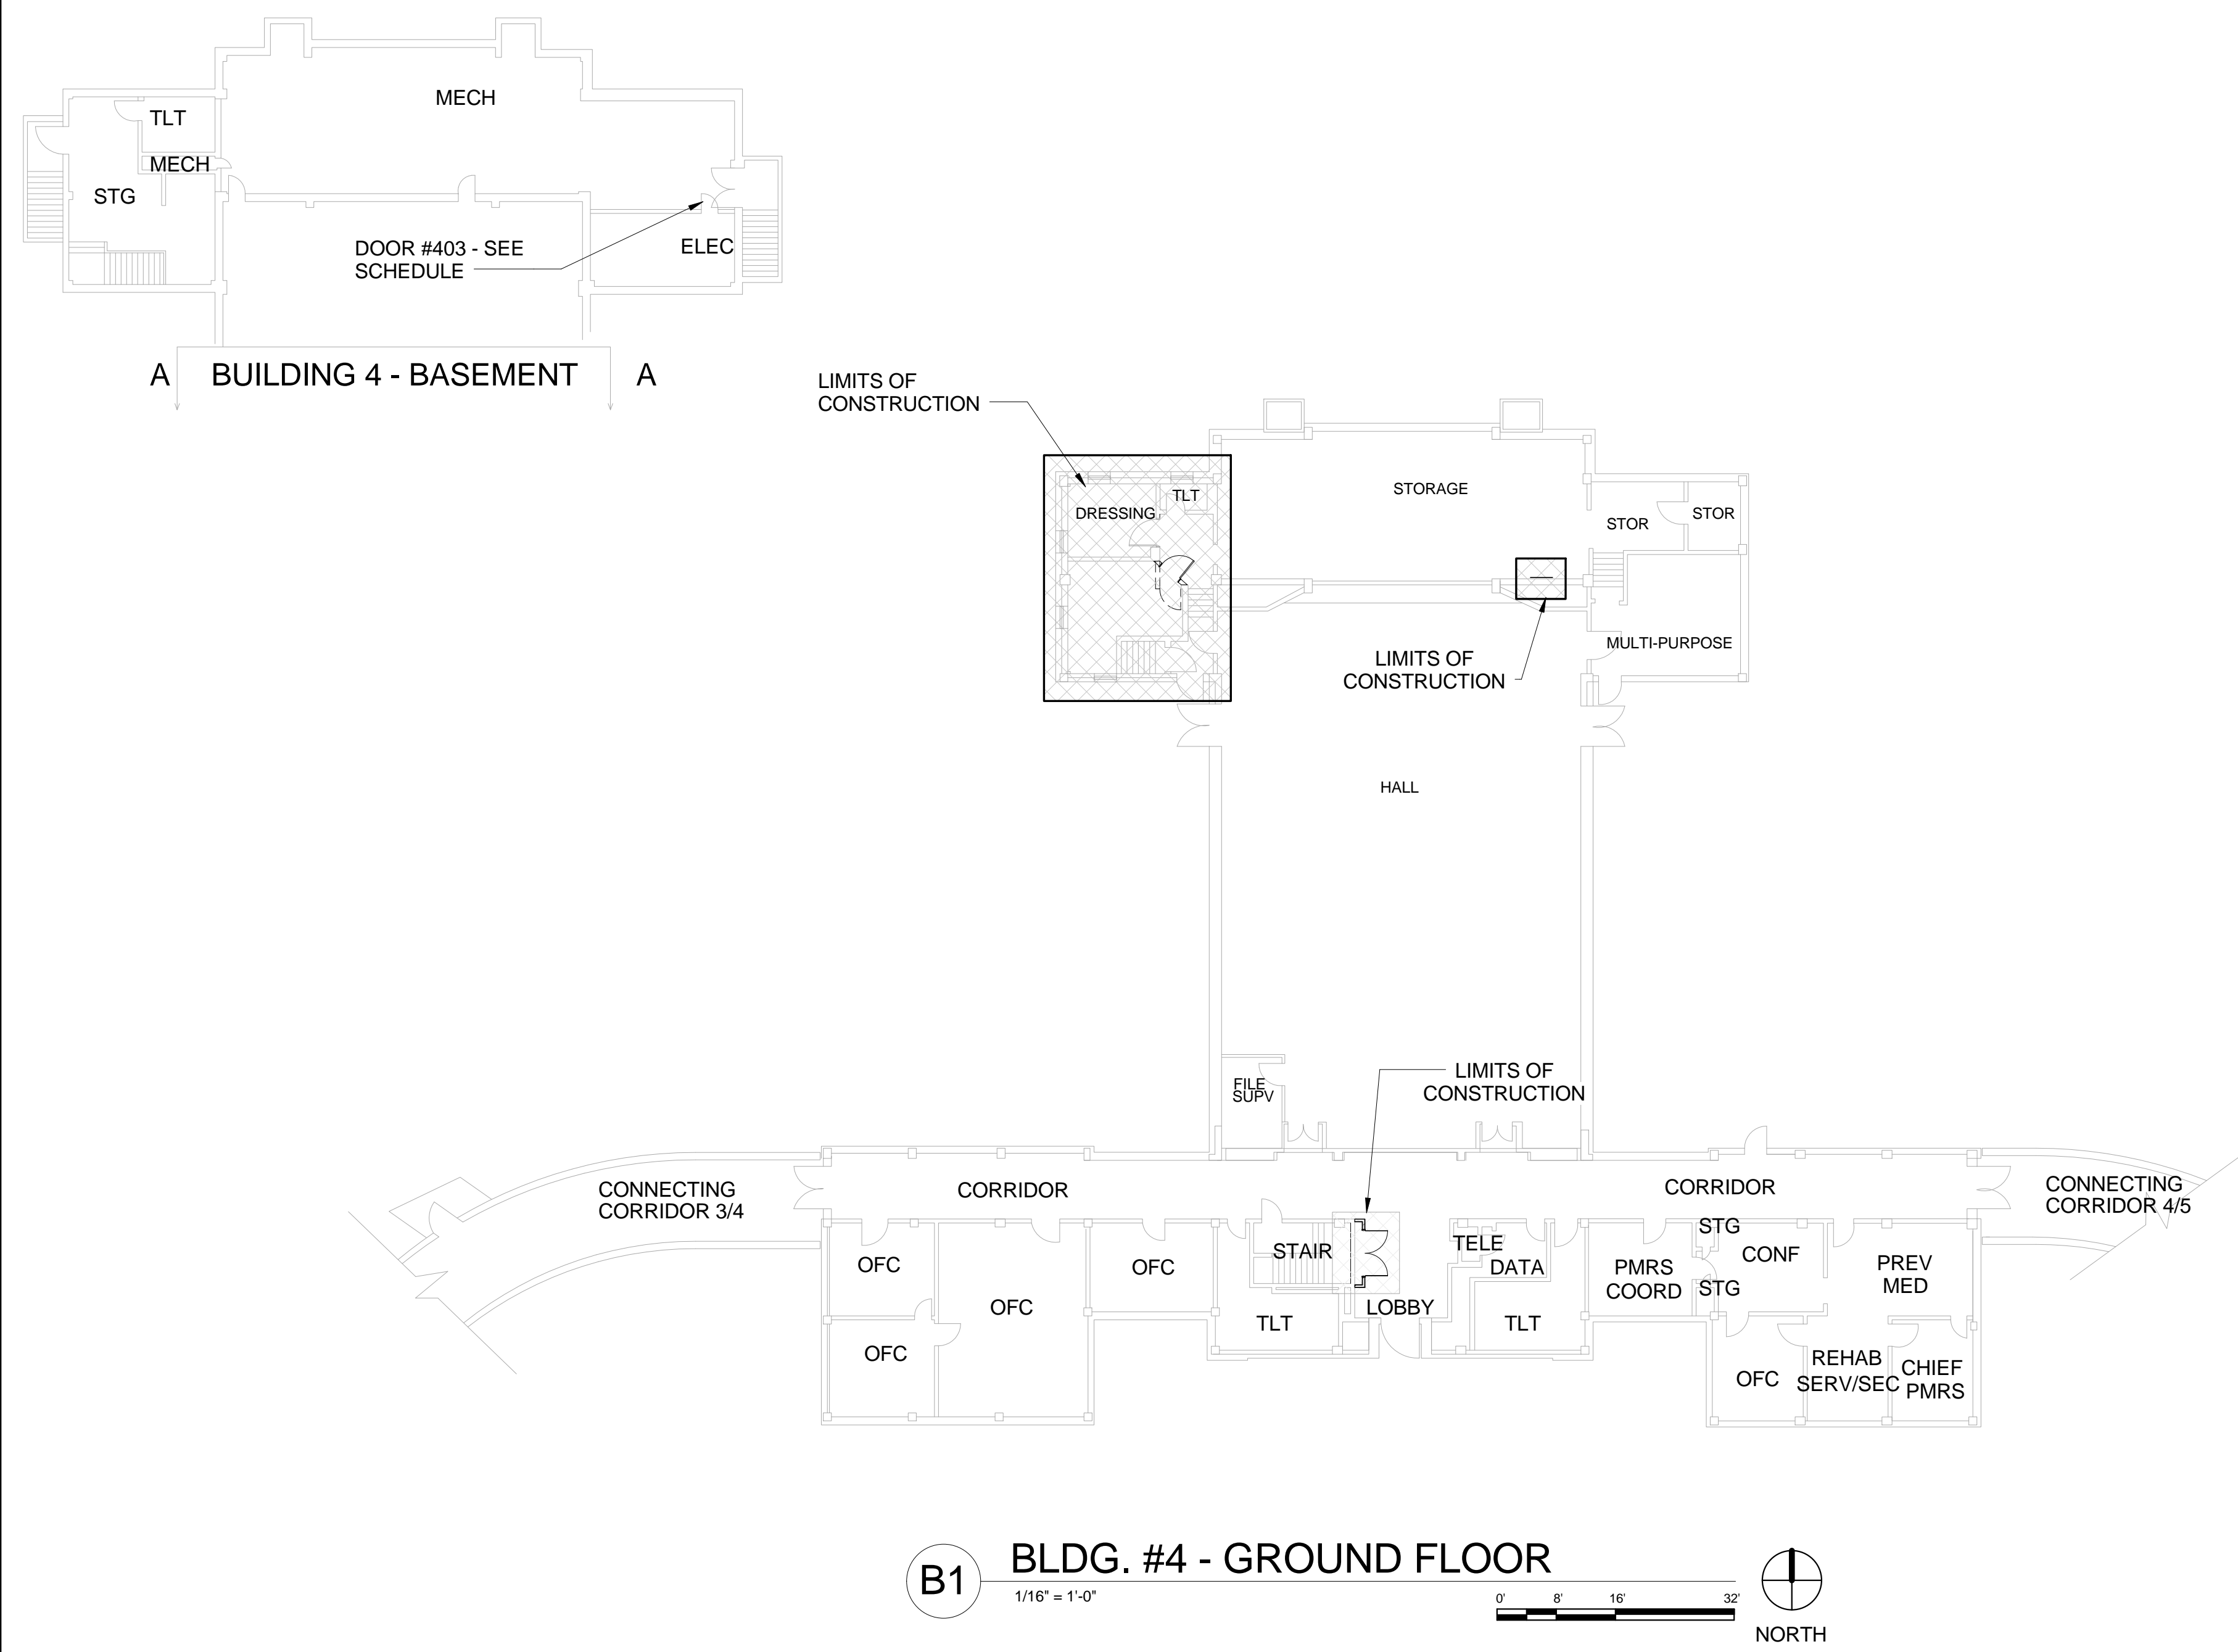
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GHP PROJECT #: 09040.01

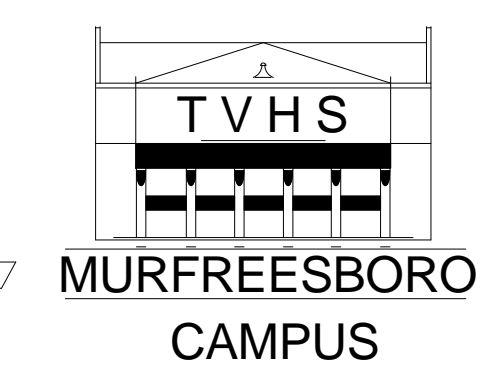PROJECT TITLE:	UPGRADE ELEC. DISTRIBUTION - PHASE 3
SHEET TITLE:	ACM GND / 1ST FLOOR
APPROVED BY:	
APPROVED BY:	
BLDG #	CHECKED BY: DRAWN BY:


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PROJECT NUMBER:	626A4-1 1-202
DWG #	107-HA-009
Dwg. 11 of 97	

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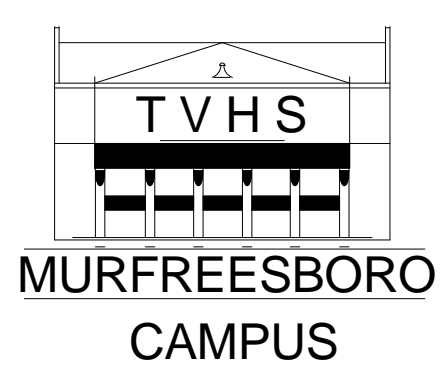


LEGEND:
HATCH DENOTES THE LIMITS OF CONSTRUCTION

REVISION	DATE

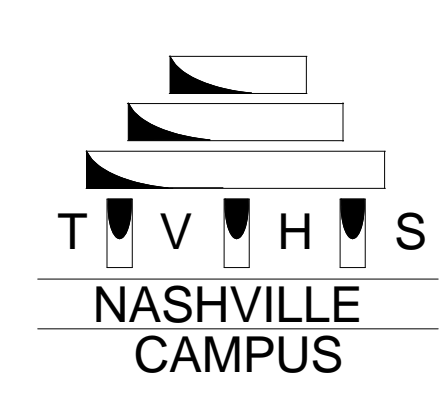

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GHP PROJECT #: 00040.01

PROJECT TITLE: UPGRADE ELEC. DISTRIBUTION - PHASE 3	DATE: OCTOBER 31, 2012
SHEET TITLE: LIMITS OF CONSTRUCTION	PROJECT NUMBER: 626A4-1 1-202
APPROVED BY:	DWG # 4-AS-101 Dwg. 12 of 97
APPROVED BY:	
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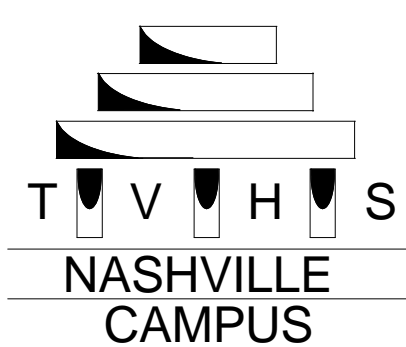
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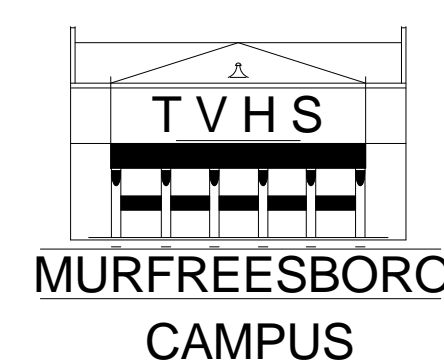
LEGEND:

	HATCH DENOTES THE LIMITS OF CONSTRUCTION
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
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GHP PROJECT #: 09040.0

PROJECT TITLE: UPGRADE ELEC. DISTRIBUTION - PHASE 3	
SHEET TITLE: LIMITS OF CONSTRUCTION	
APPROVED BY:	
APPROVED BY:	ALVIN C. YORK CAMPUS 3401 GLENN FIVE MURFREESBORO, TENNESSEE
BLDG # 5	CHECKED BY: DRAWN BY:


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OCTOBER 31, 2012

PROJECT NUMBER:
626A4-1 1-202

DWG #
5-AS-102



Dwg 13 Of 97

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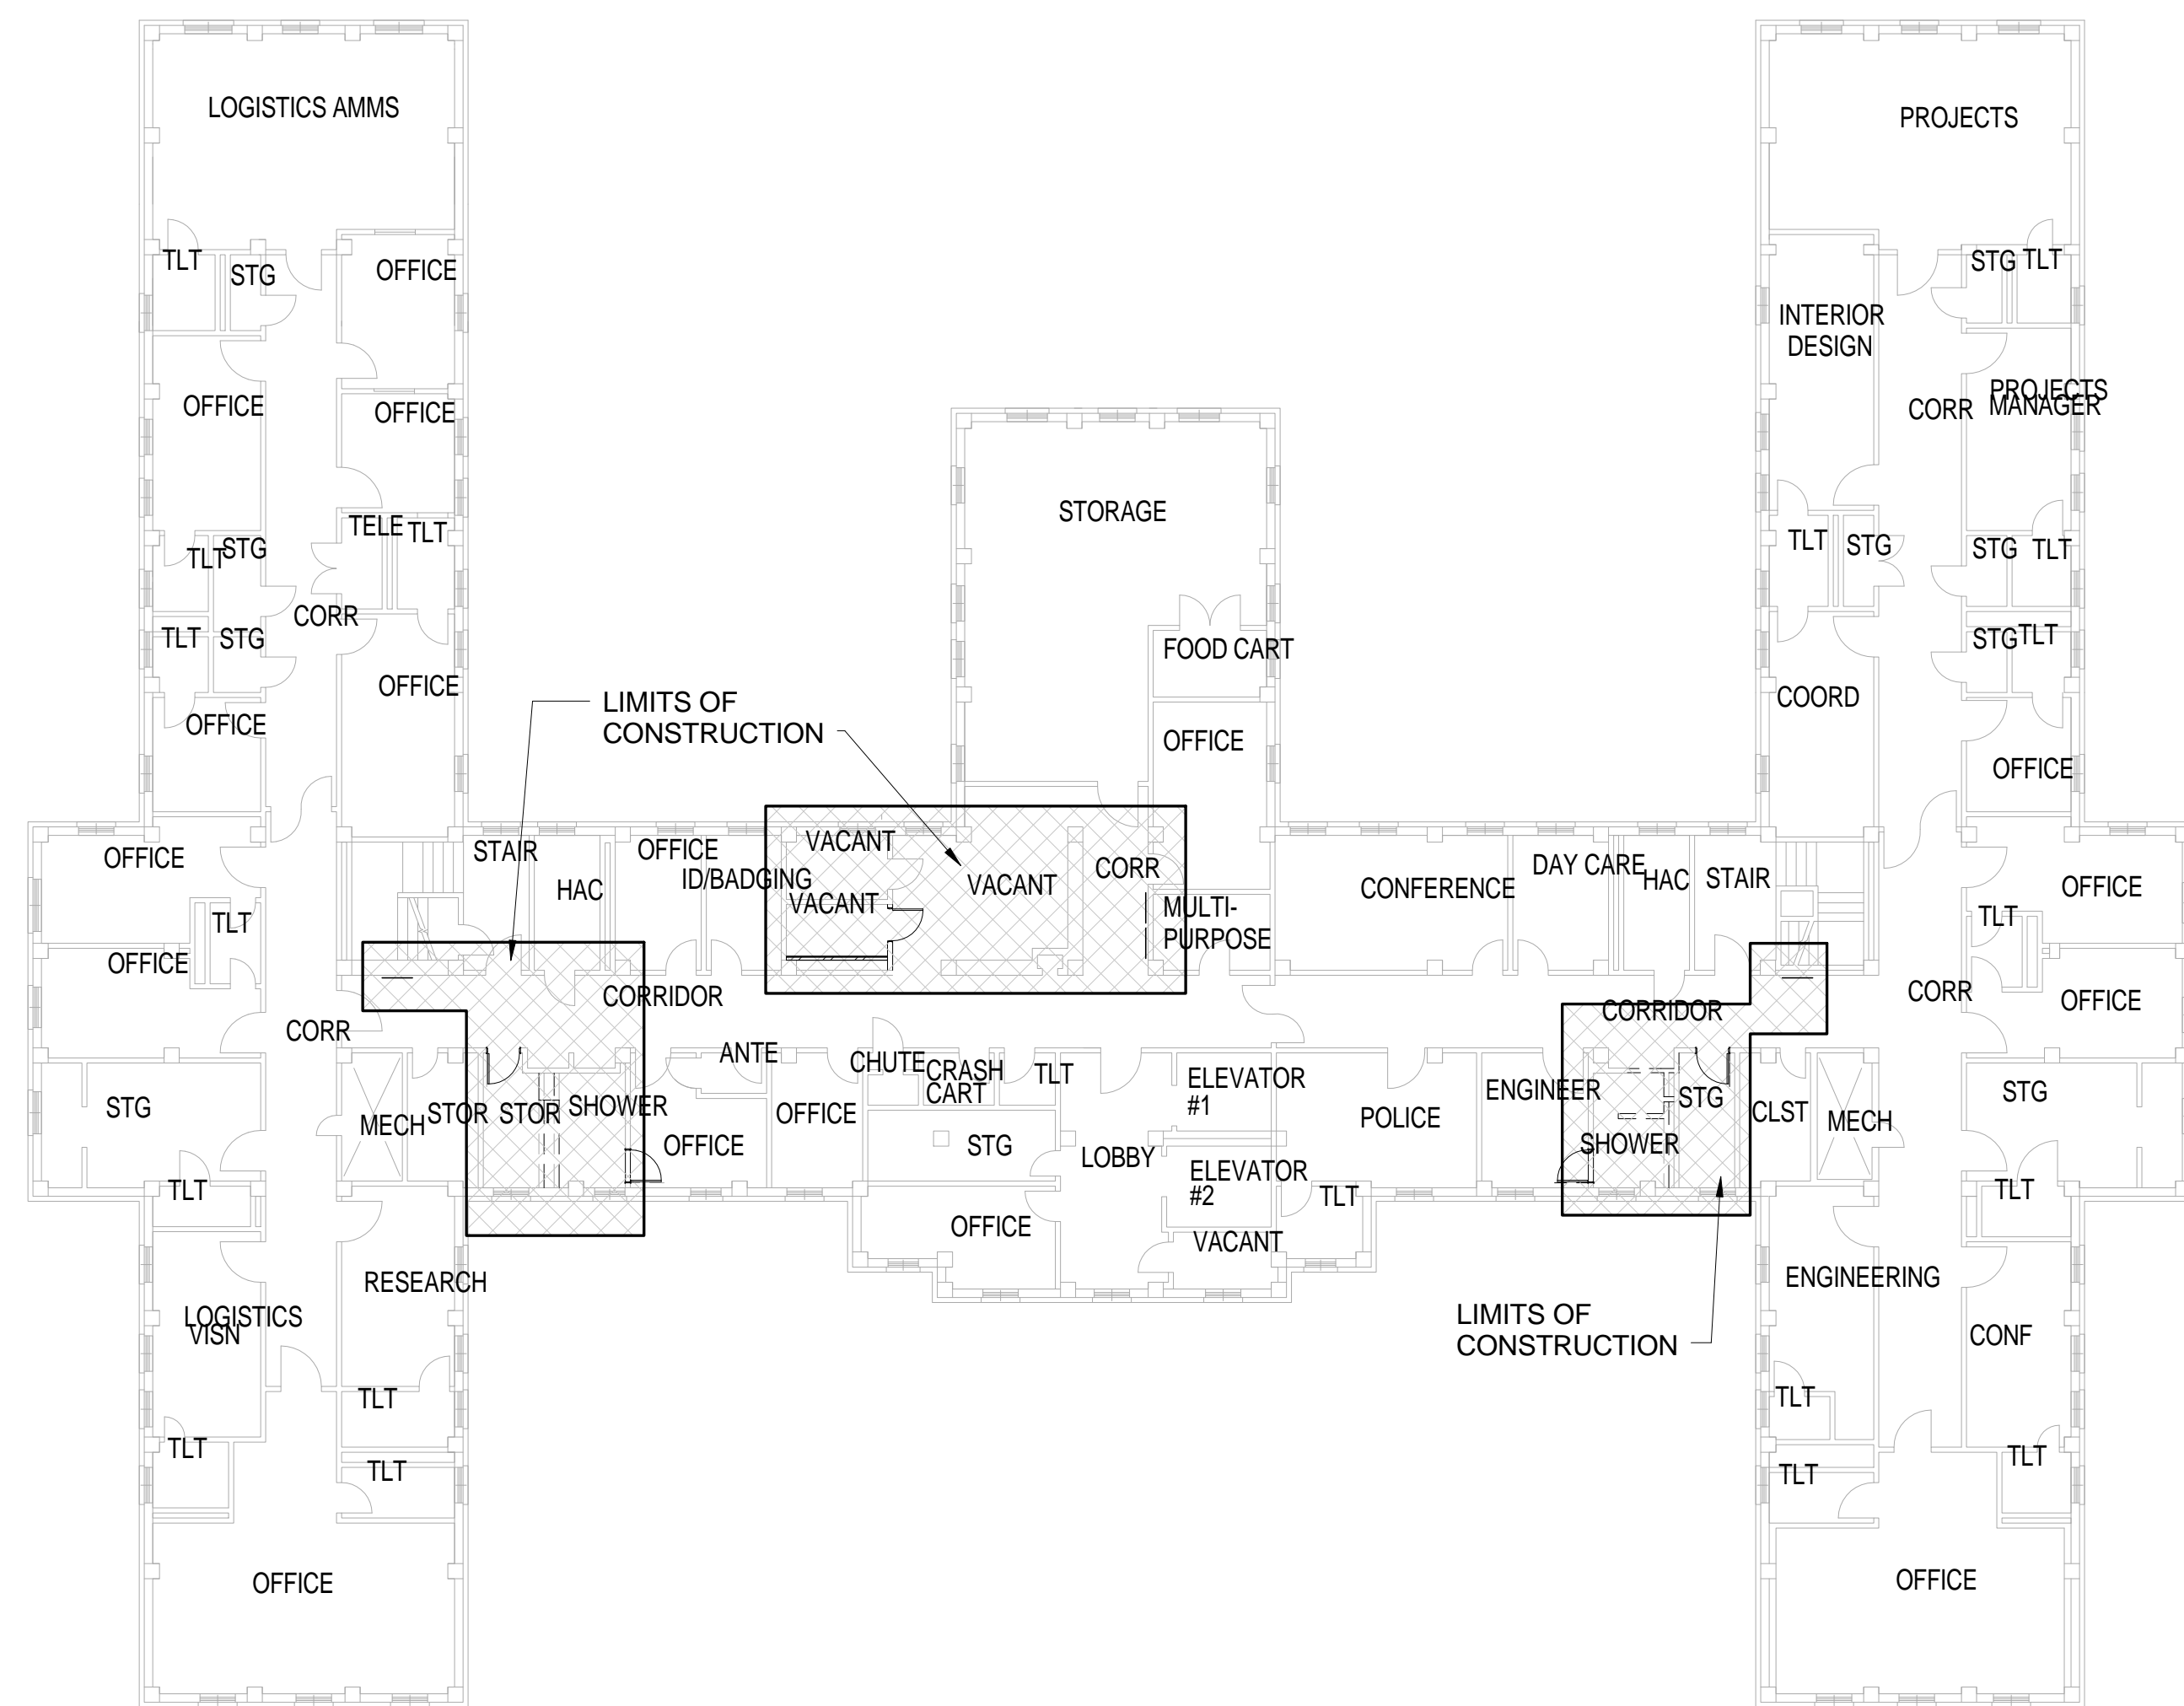
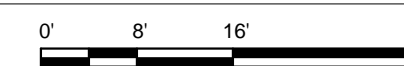
A3 BLDG. #6 - GND FLOOR

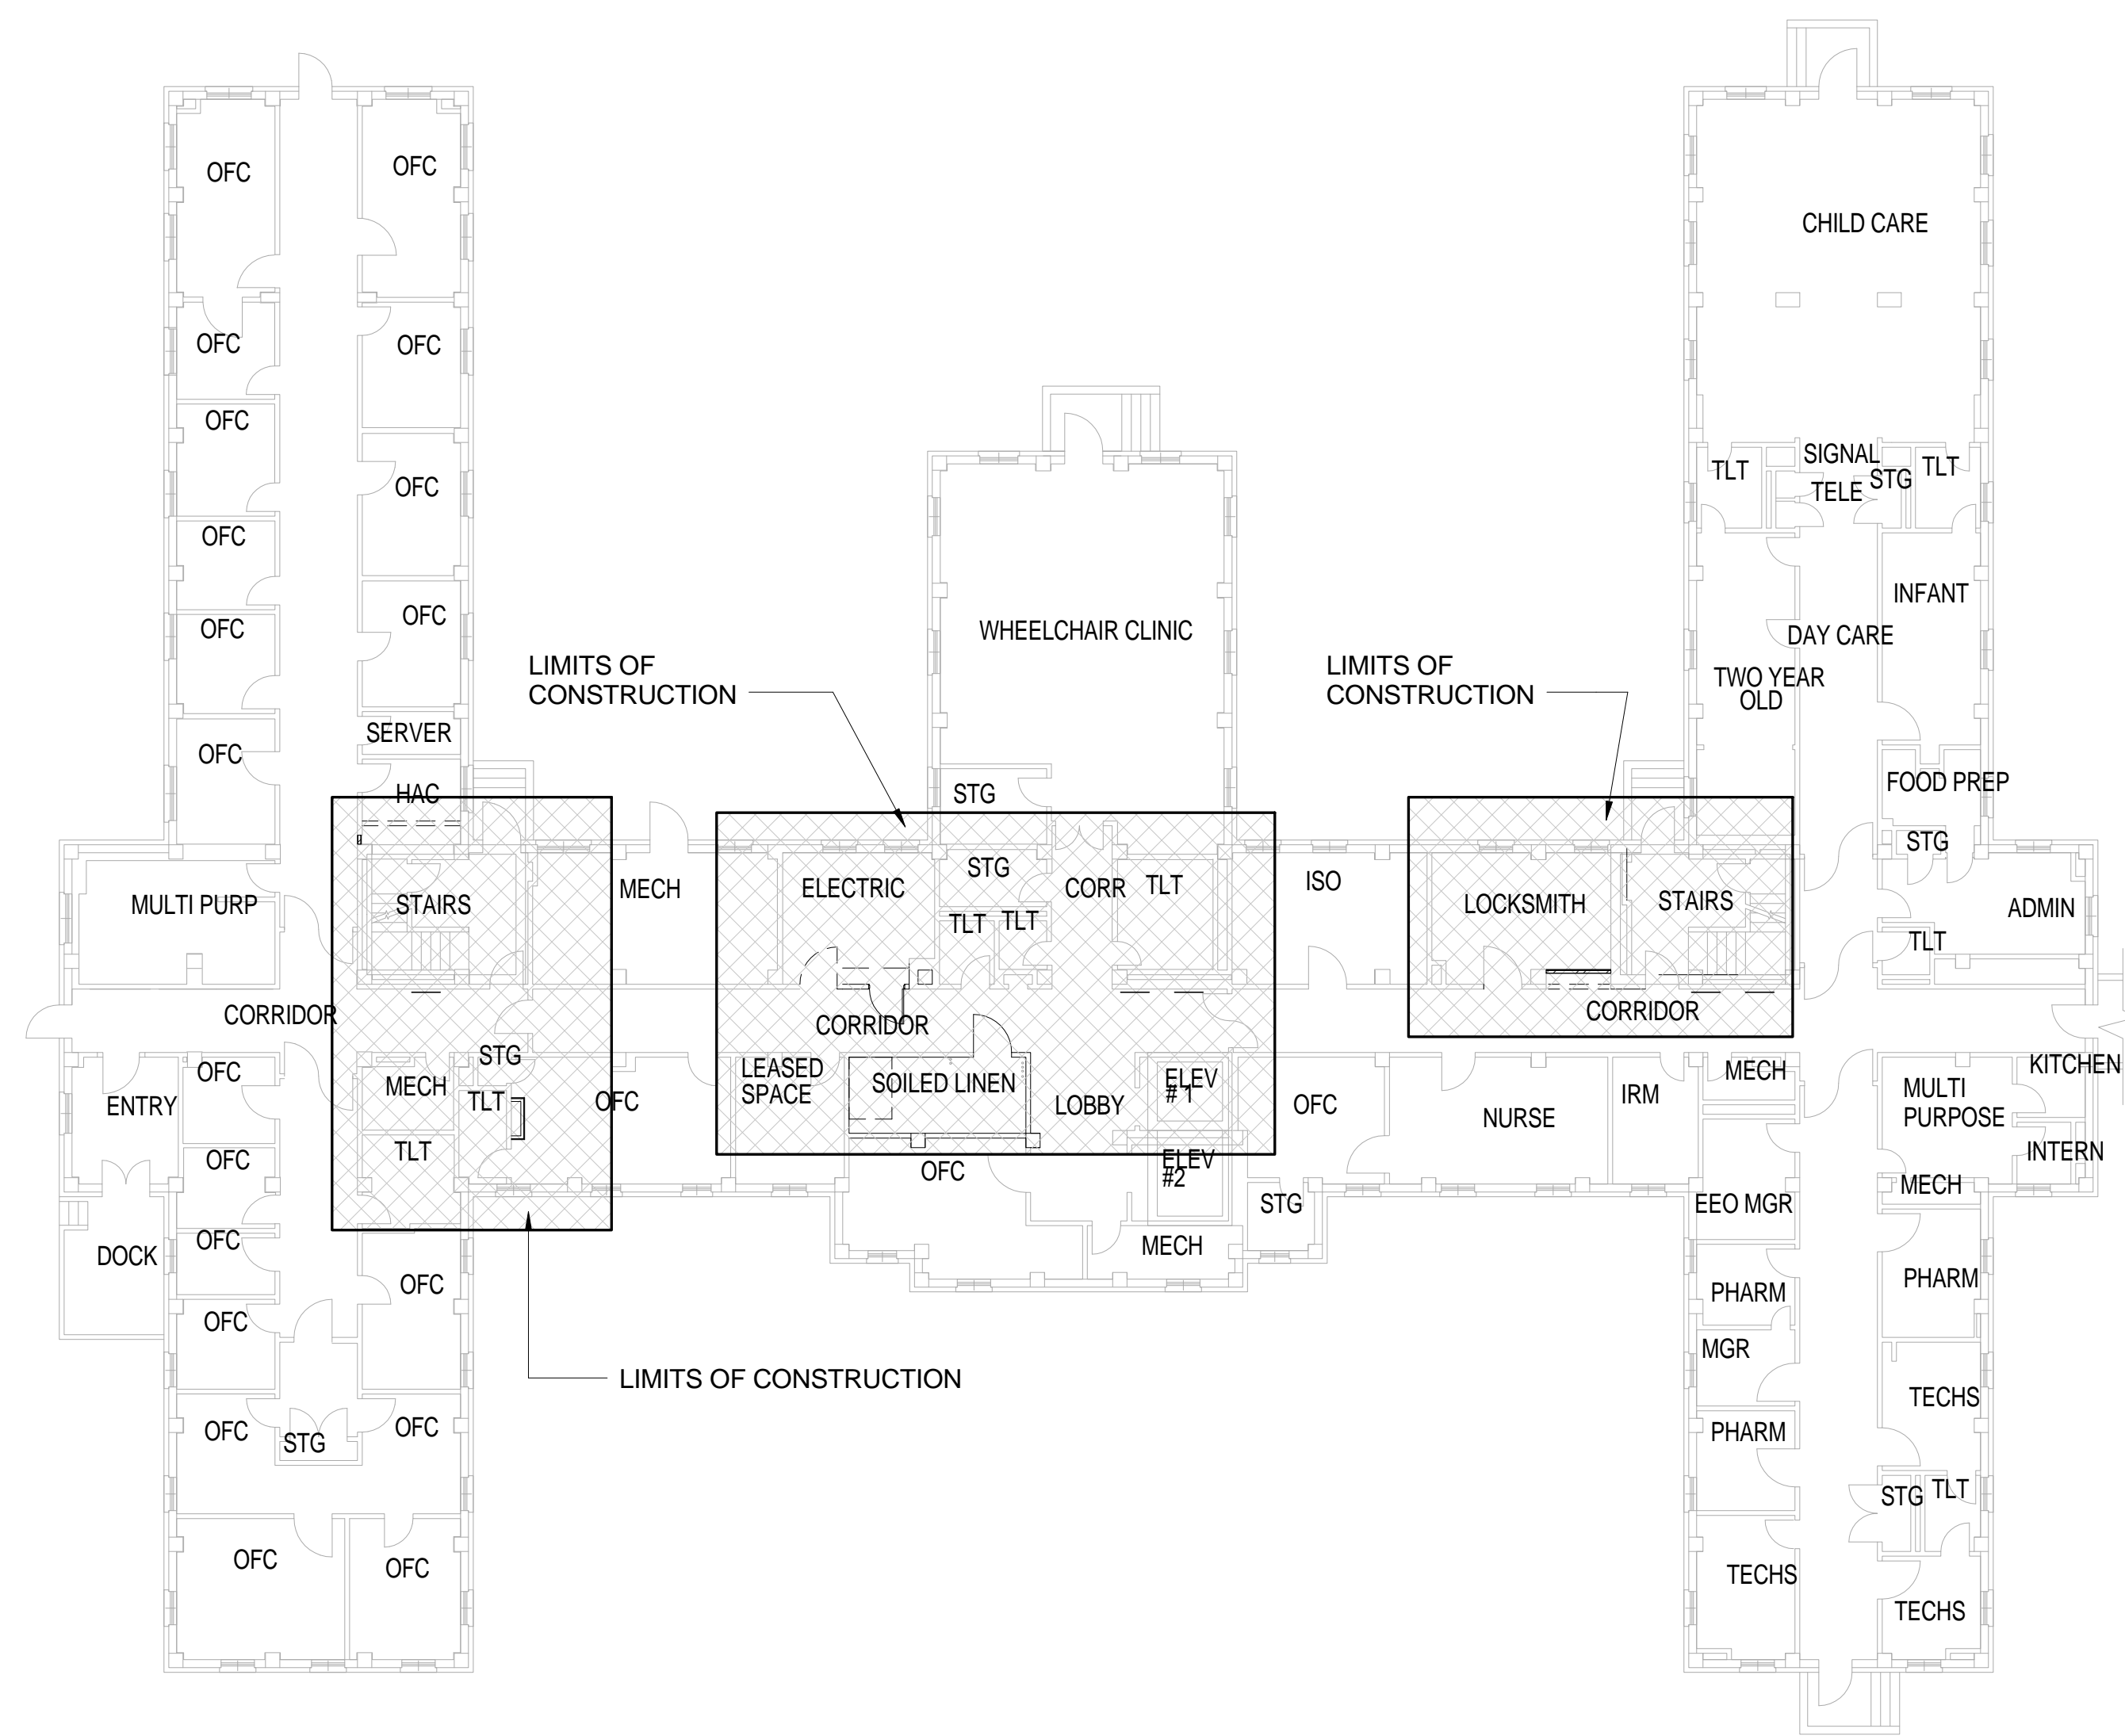1/16" = 1'-0"




D3 BLDG. #6 - 1ST FLOOR

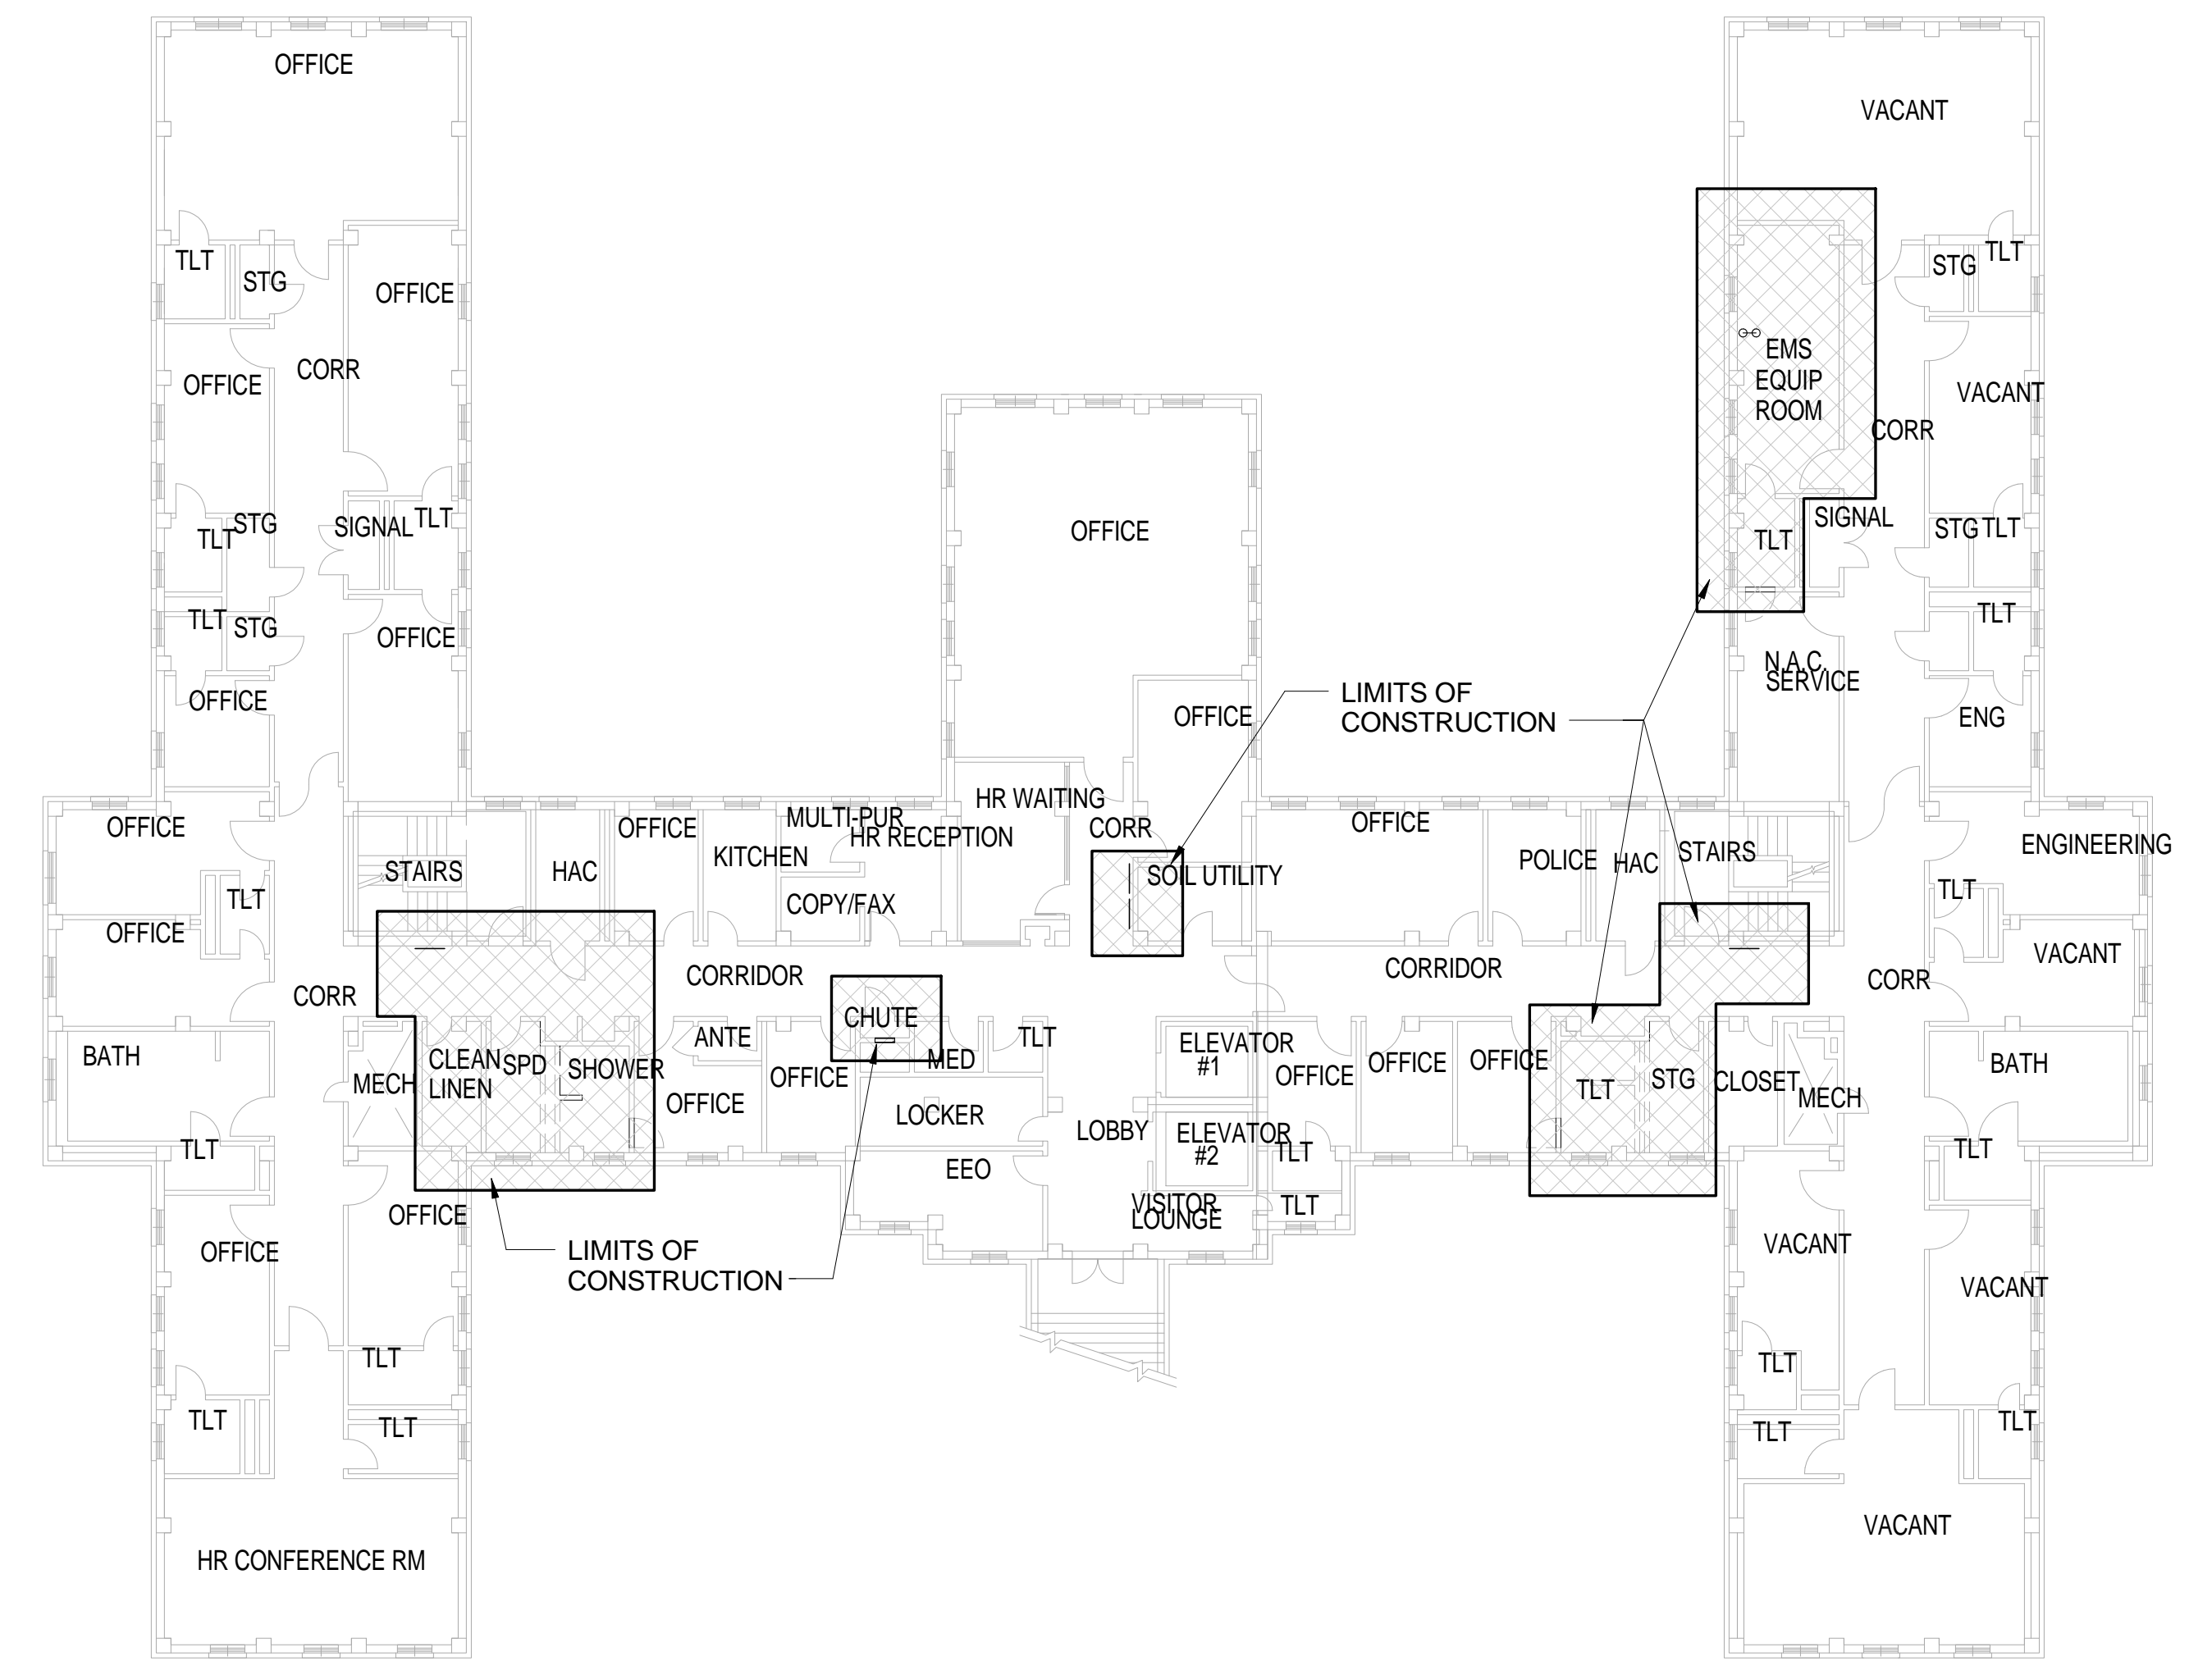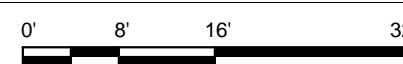1/16" = 1'-0"



A1 BLDG. #6 - 2ND FLOOR

1/16" = 1'-0"


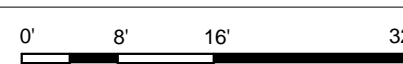


LEGEND:	
	HATCH DENOTES THE LIMITS OF CONSTRUCTION

REVISION	DATE




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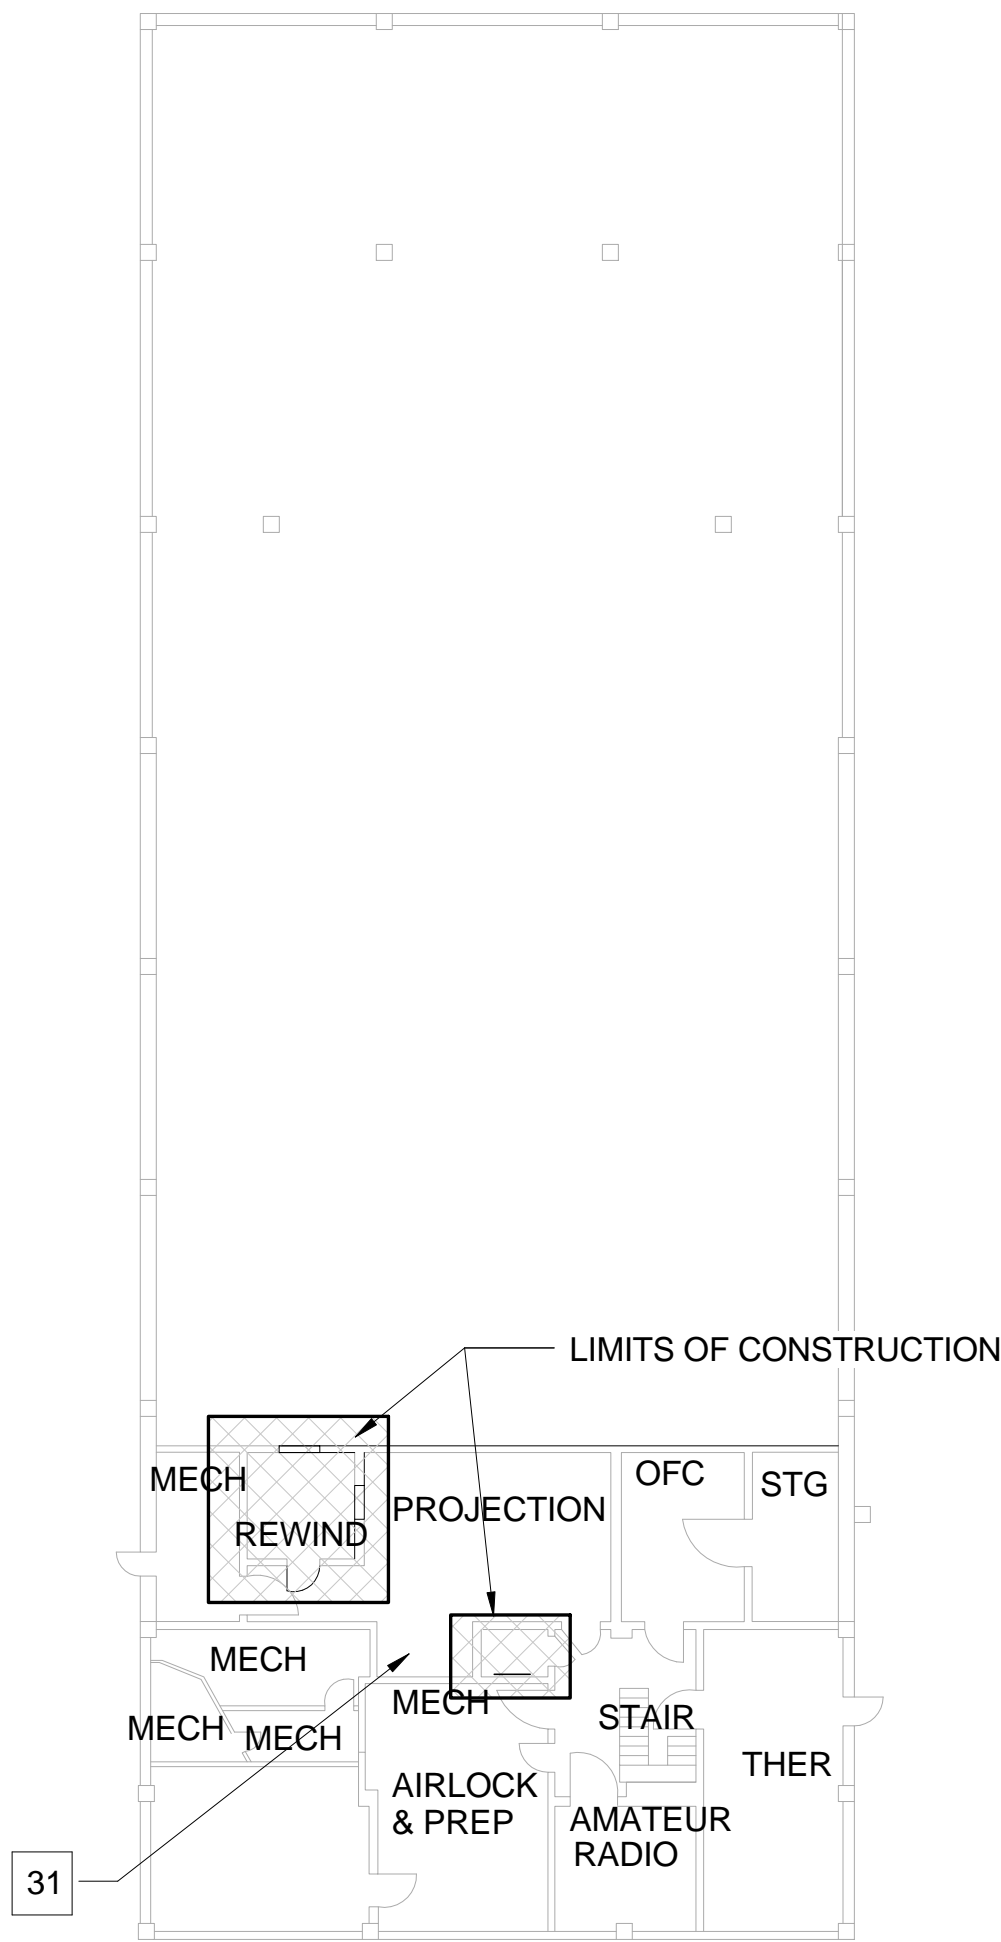
PROJECT TITLE: UPGRADE ELEC. DISTRIBUTION - PHASE 3	DATE: OCTOBER 31, 2012
SHEET TITLE: LIMITS OF CONSTRUCTION	PROJECT NUMBER: 626A4-1 1-202
APPROVED BY:	DWG # 6-AS-103
APPROVED BY:	Dwg. 14 of 97
BLDG # 6	CHECKED BY:
	DRAWN BY:
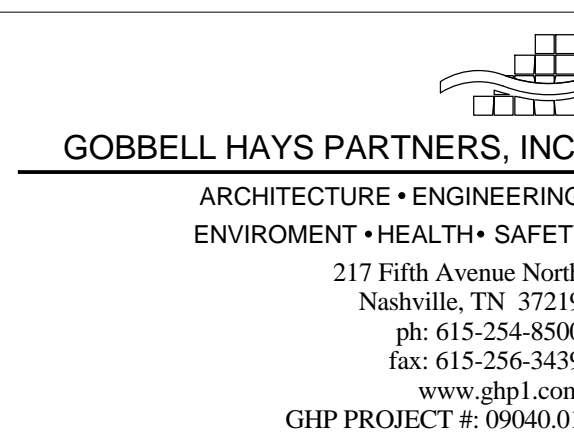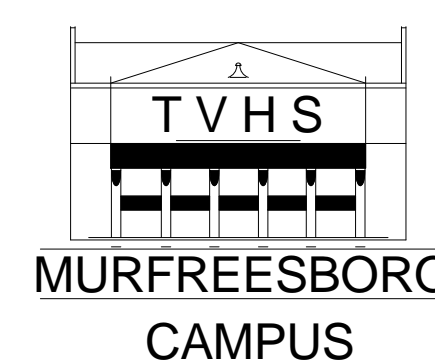
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31 UPON COMPLETION OF MECHANICAL REMOVAL AND ACM ABATEMENT, PATCH REMAINING VOID TO MATCH EXISTING ADJACENT SURFACES. SEE ACM DRAWINGS



B2 BLDG. #107 GND FLOOR
1/16" = 1'-0"

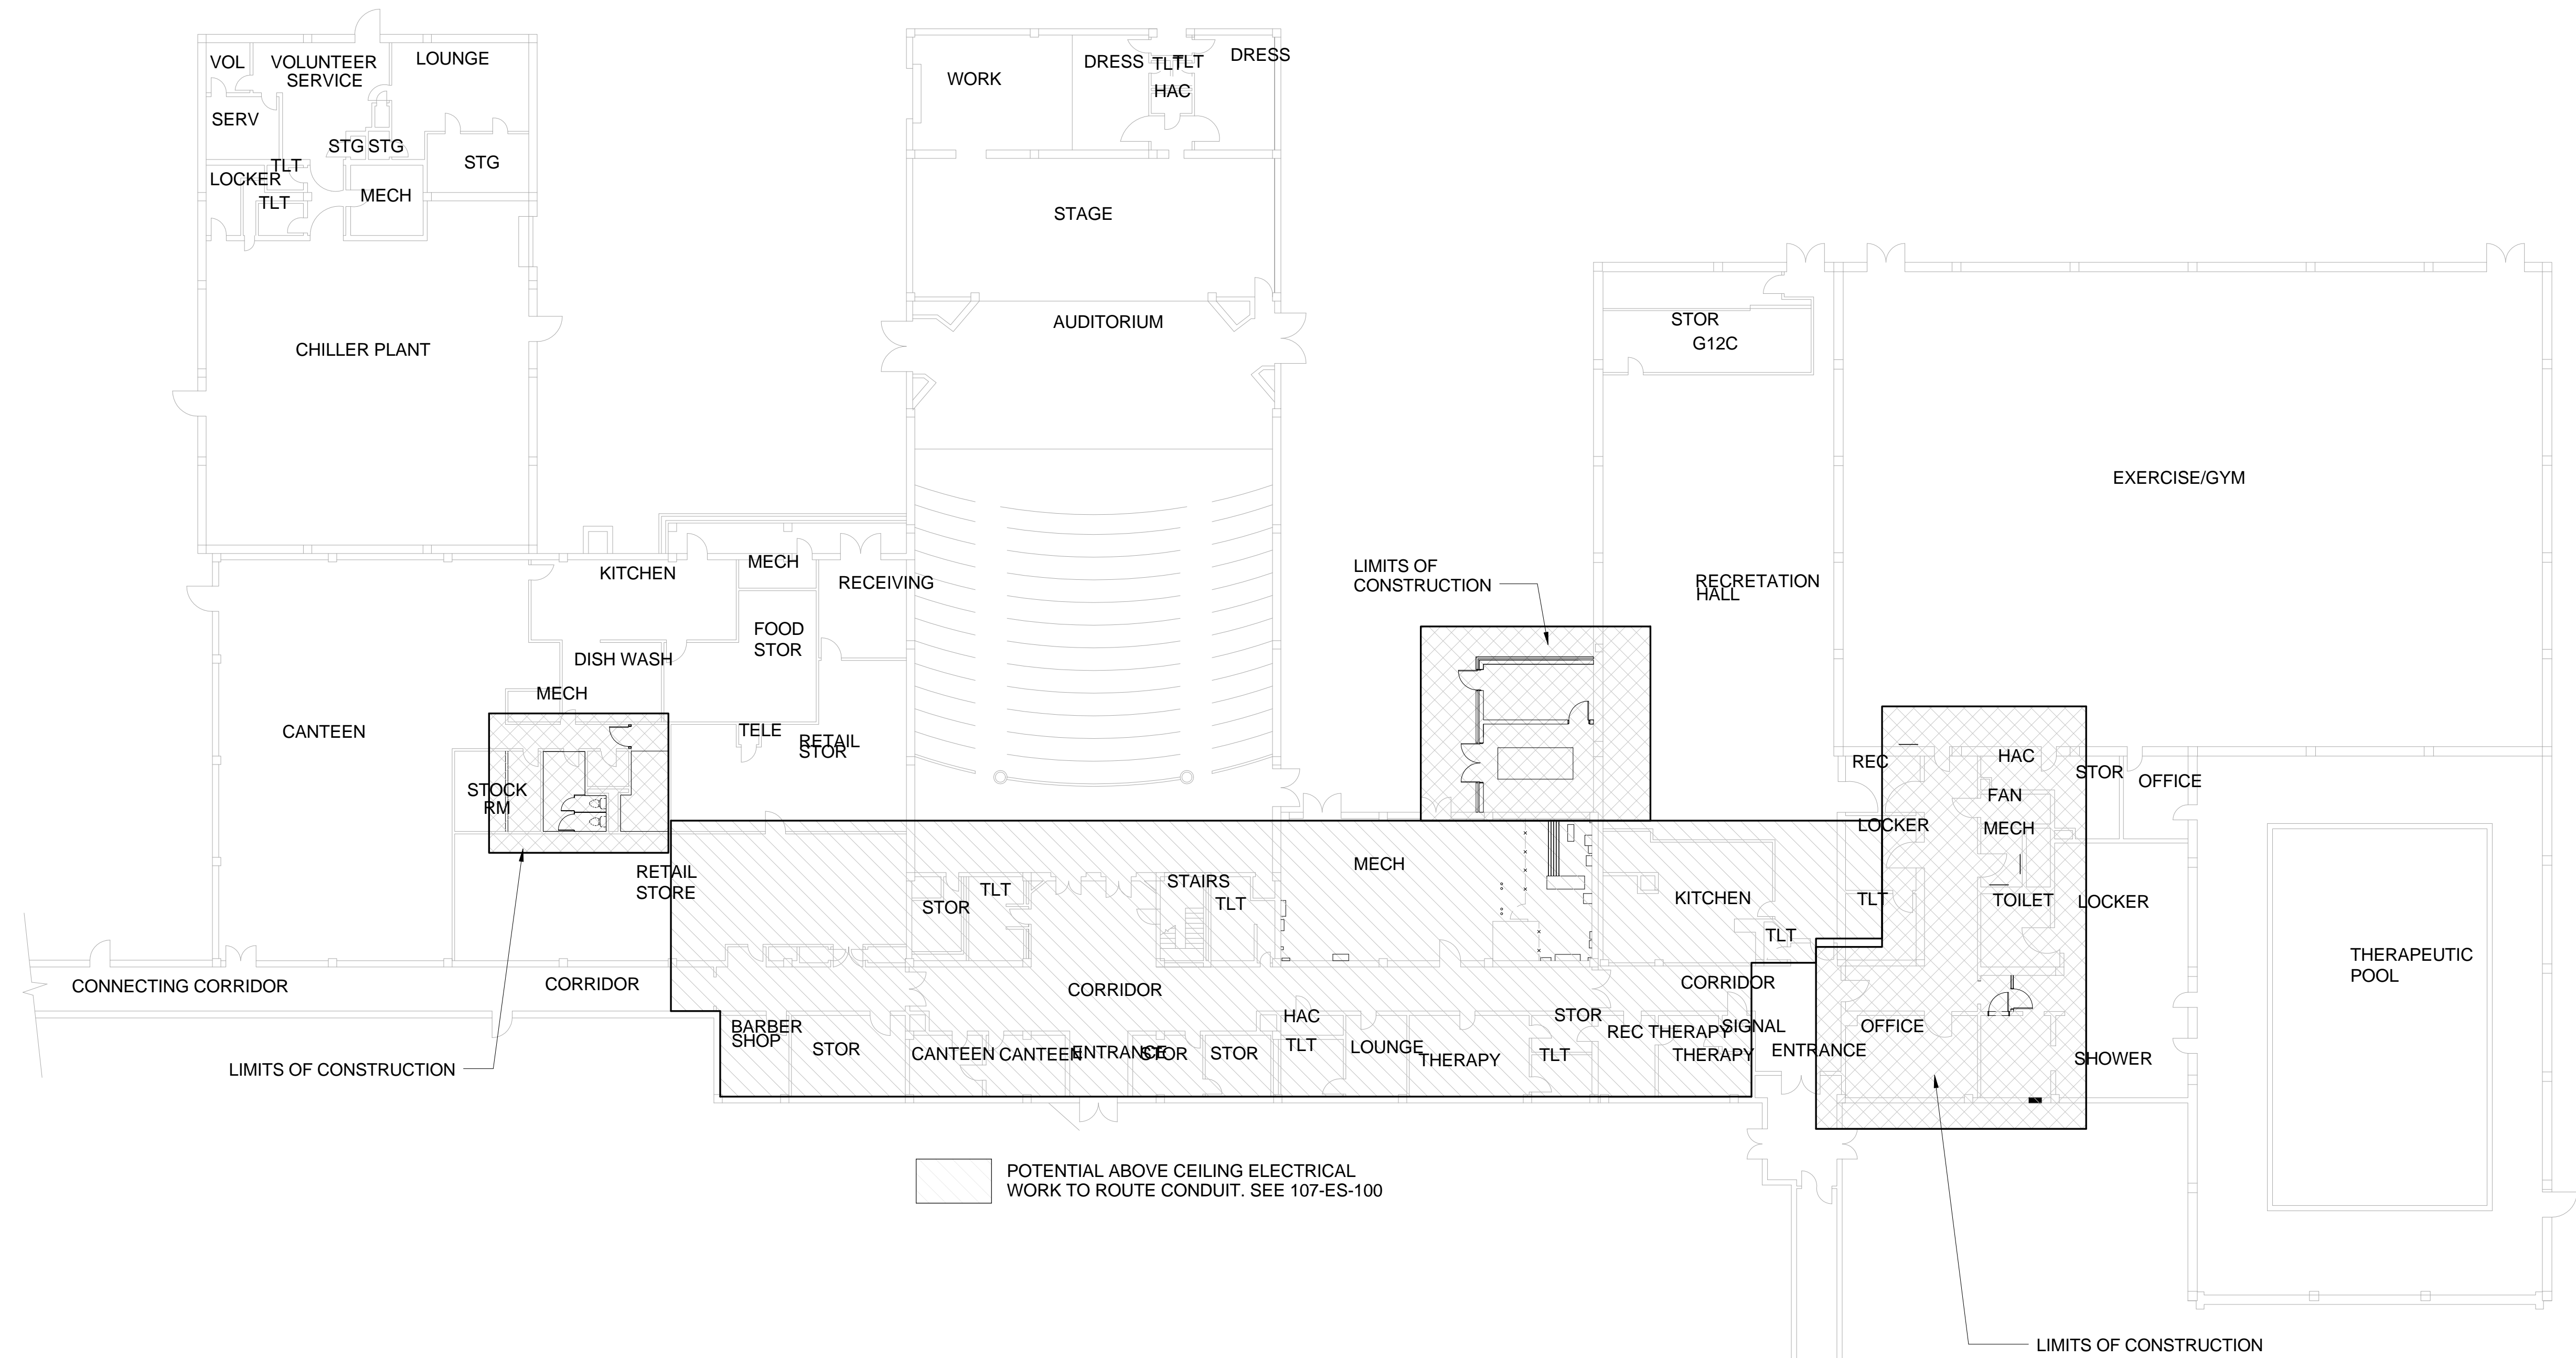


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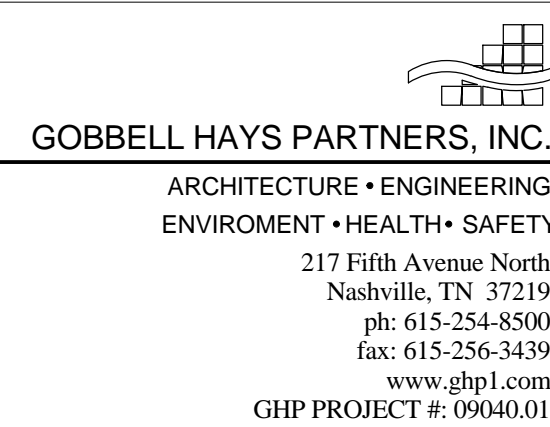
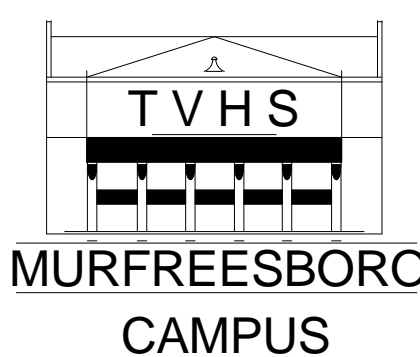


LEGEND:
HATCH DENOTES THE LIMITS OF CONSTRUCTION

REVISION	DATE

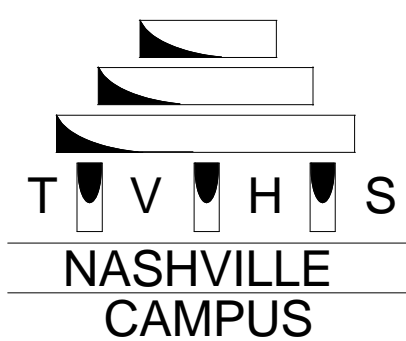


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PROJECT TITLE: UPGRADE ELEC. DISTRIBUTION - PHASE 3	DATE: OCTOBER 31, 2012
SHEET TITLE: LIMITS OF CONSTRUCTION	PROJECT NUMBER: 626A4-1 1-202
APPROVED BY:	DWG # 107-AS-104
APPROVED BY:	Dwg. 15 of 97
BLDG # 107	CHECKED BY:
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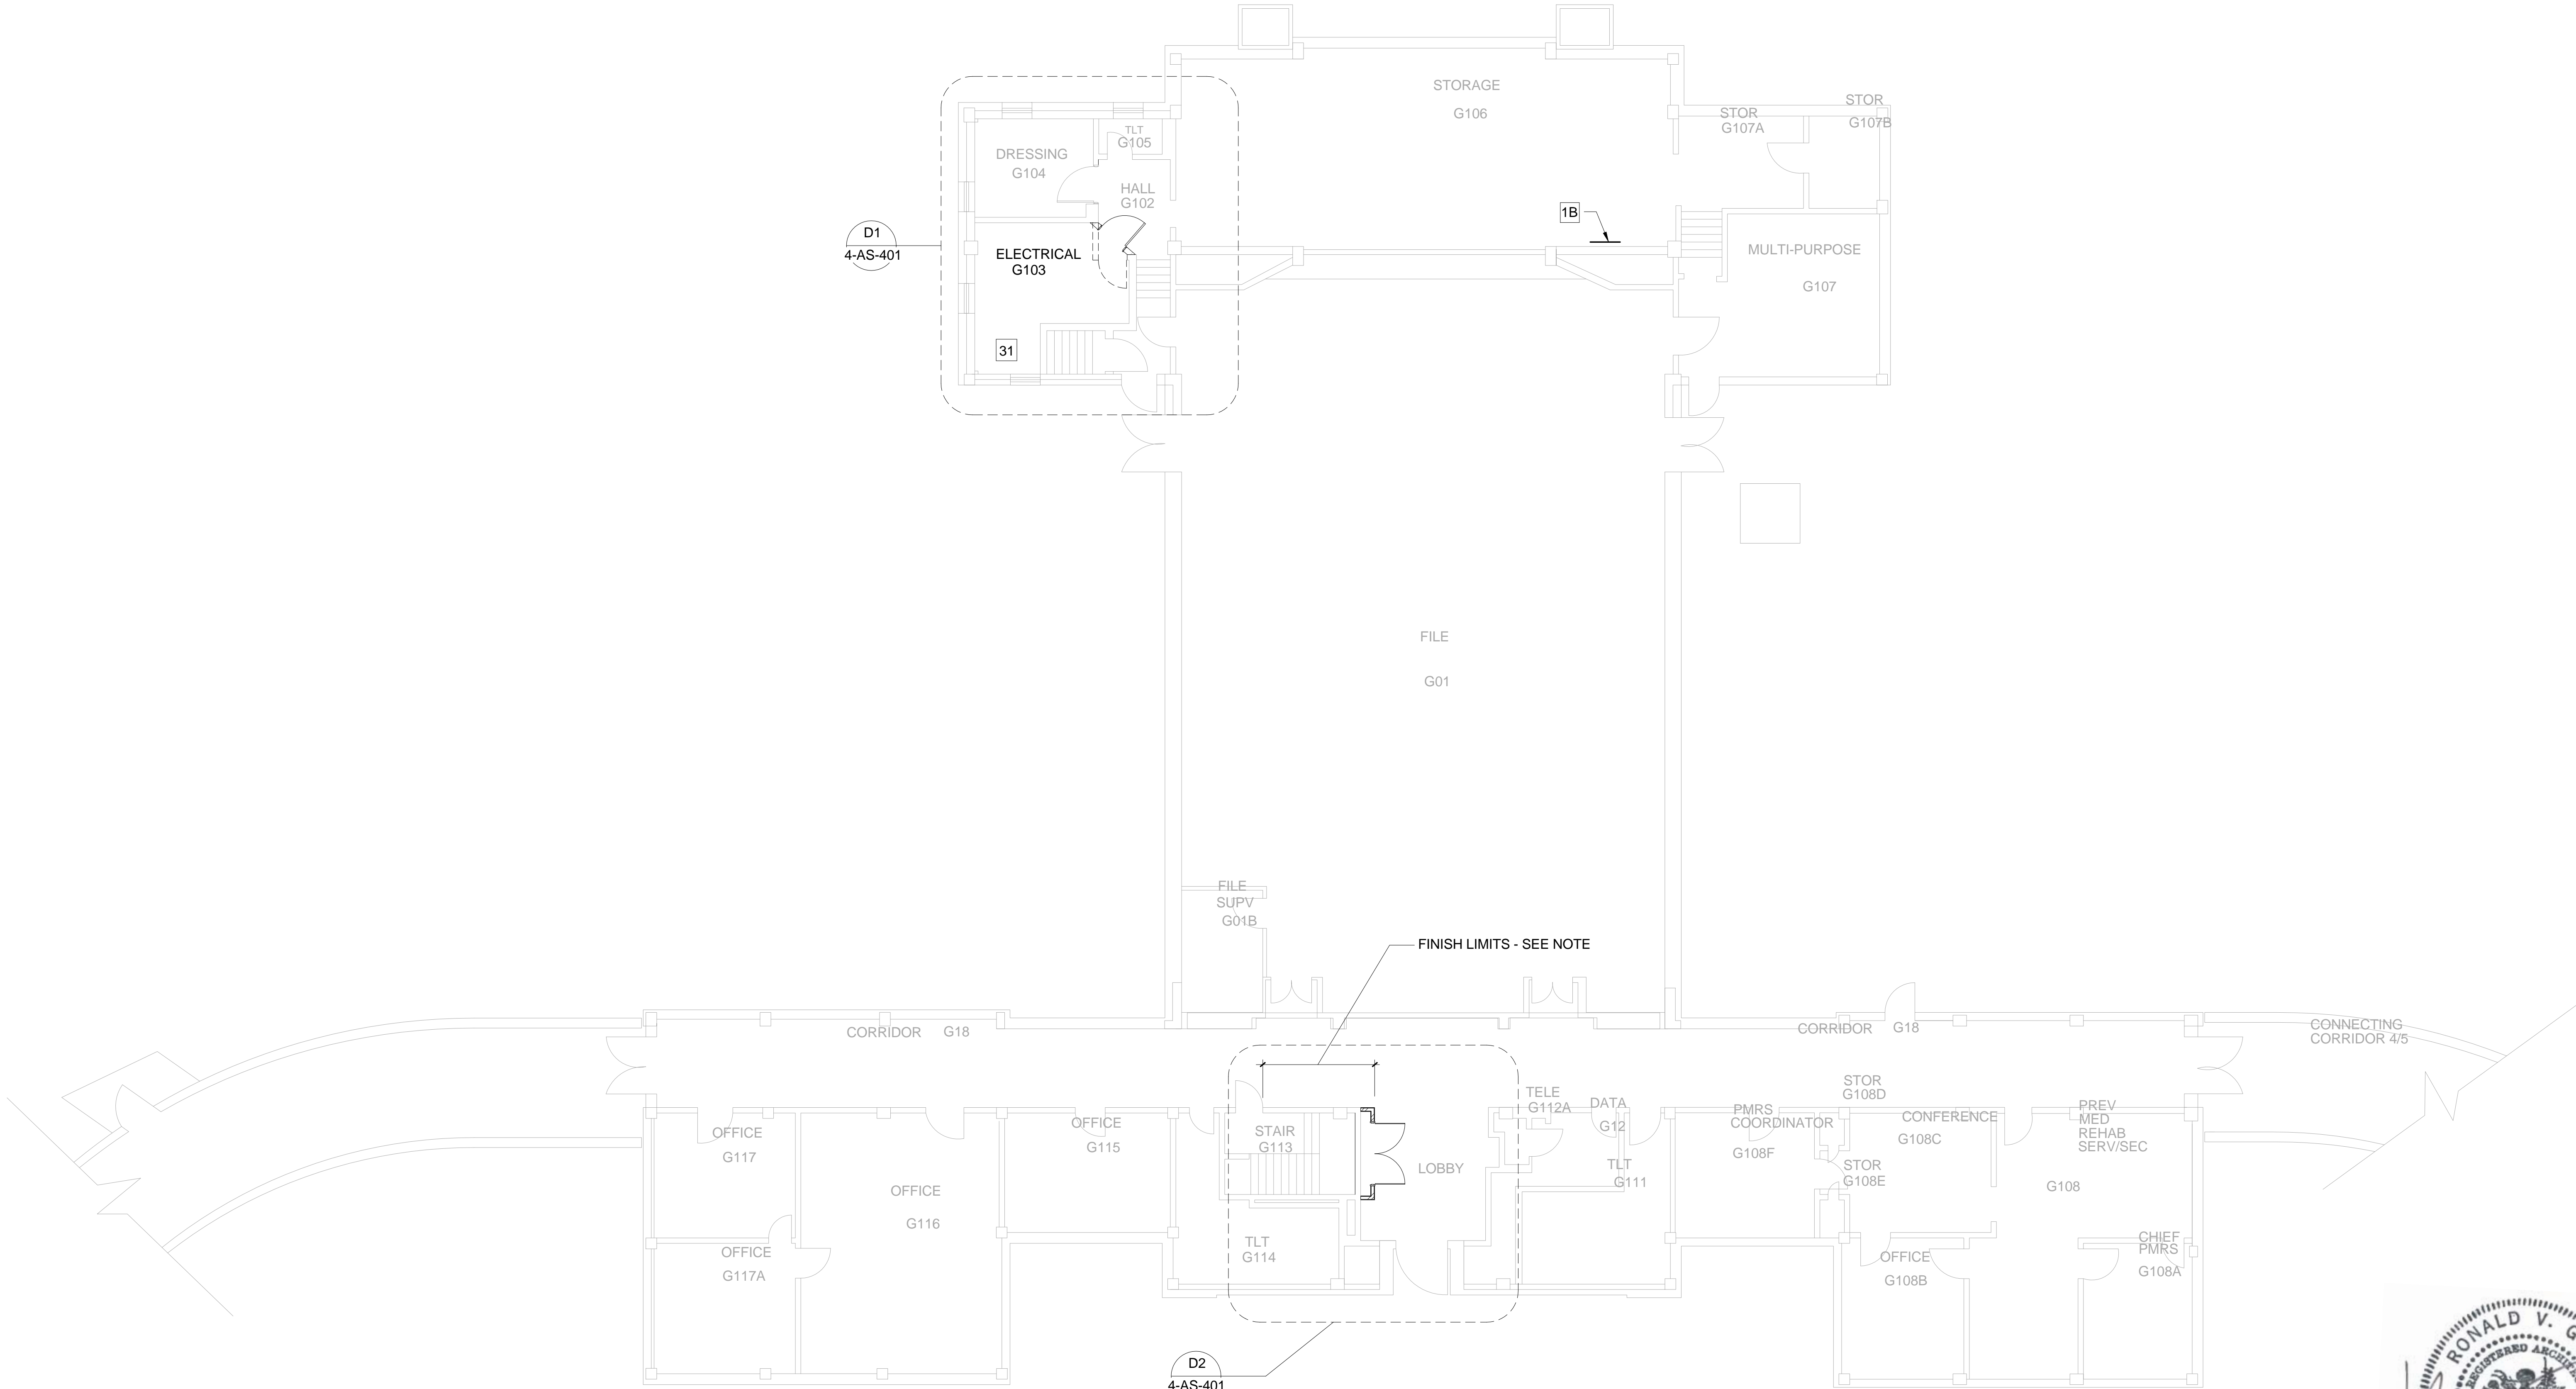
FINISH NOTE:

FINISH LIMITS INDICATED THUSLY: DENOTES THE AREA OF THE WALL, CORNER TO CORNER (OR DOOR FRAME). THIS AREA TO BE REPAIRED, PAINTED AND / OR PATCHED WITH MATCHING VINYL WALL COVERING (WALL COVING FURNISHED BY THE GOVERNMENT) AS IS NECESSARY TO MATCH EXISTING FINISH.

KEY NOTES:

- 1B RELOCATE EXISTING SURFACE MOUNTED ELECTRIC PANEL TO NEW ELECTRICAL ROOM / CLST. PATCH AND PAINT TO MATCH SURROUNDING CONDITIONS.
- 2 NEW TRANSFORMER PAD - SEE SITE PLAN
- 31 UPON COMPLETION OF MECHANICAL REMOVAL AND ACM ABATEMENT, PATCH REMAINING VOID TO MATCH EXISTING ADJACENT SURFACES. SEE ACM DRAWINGS

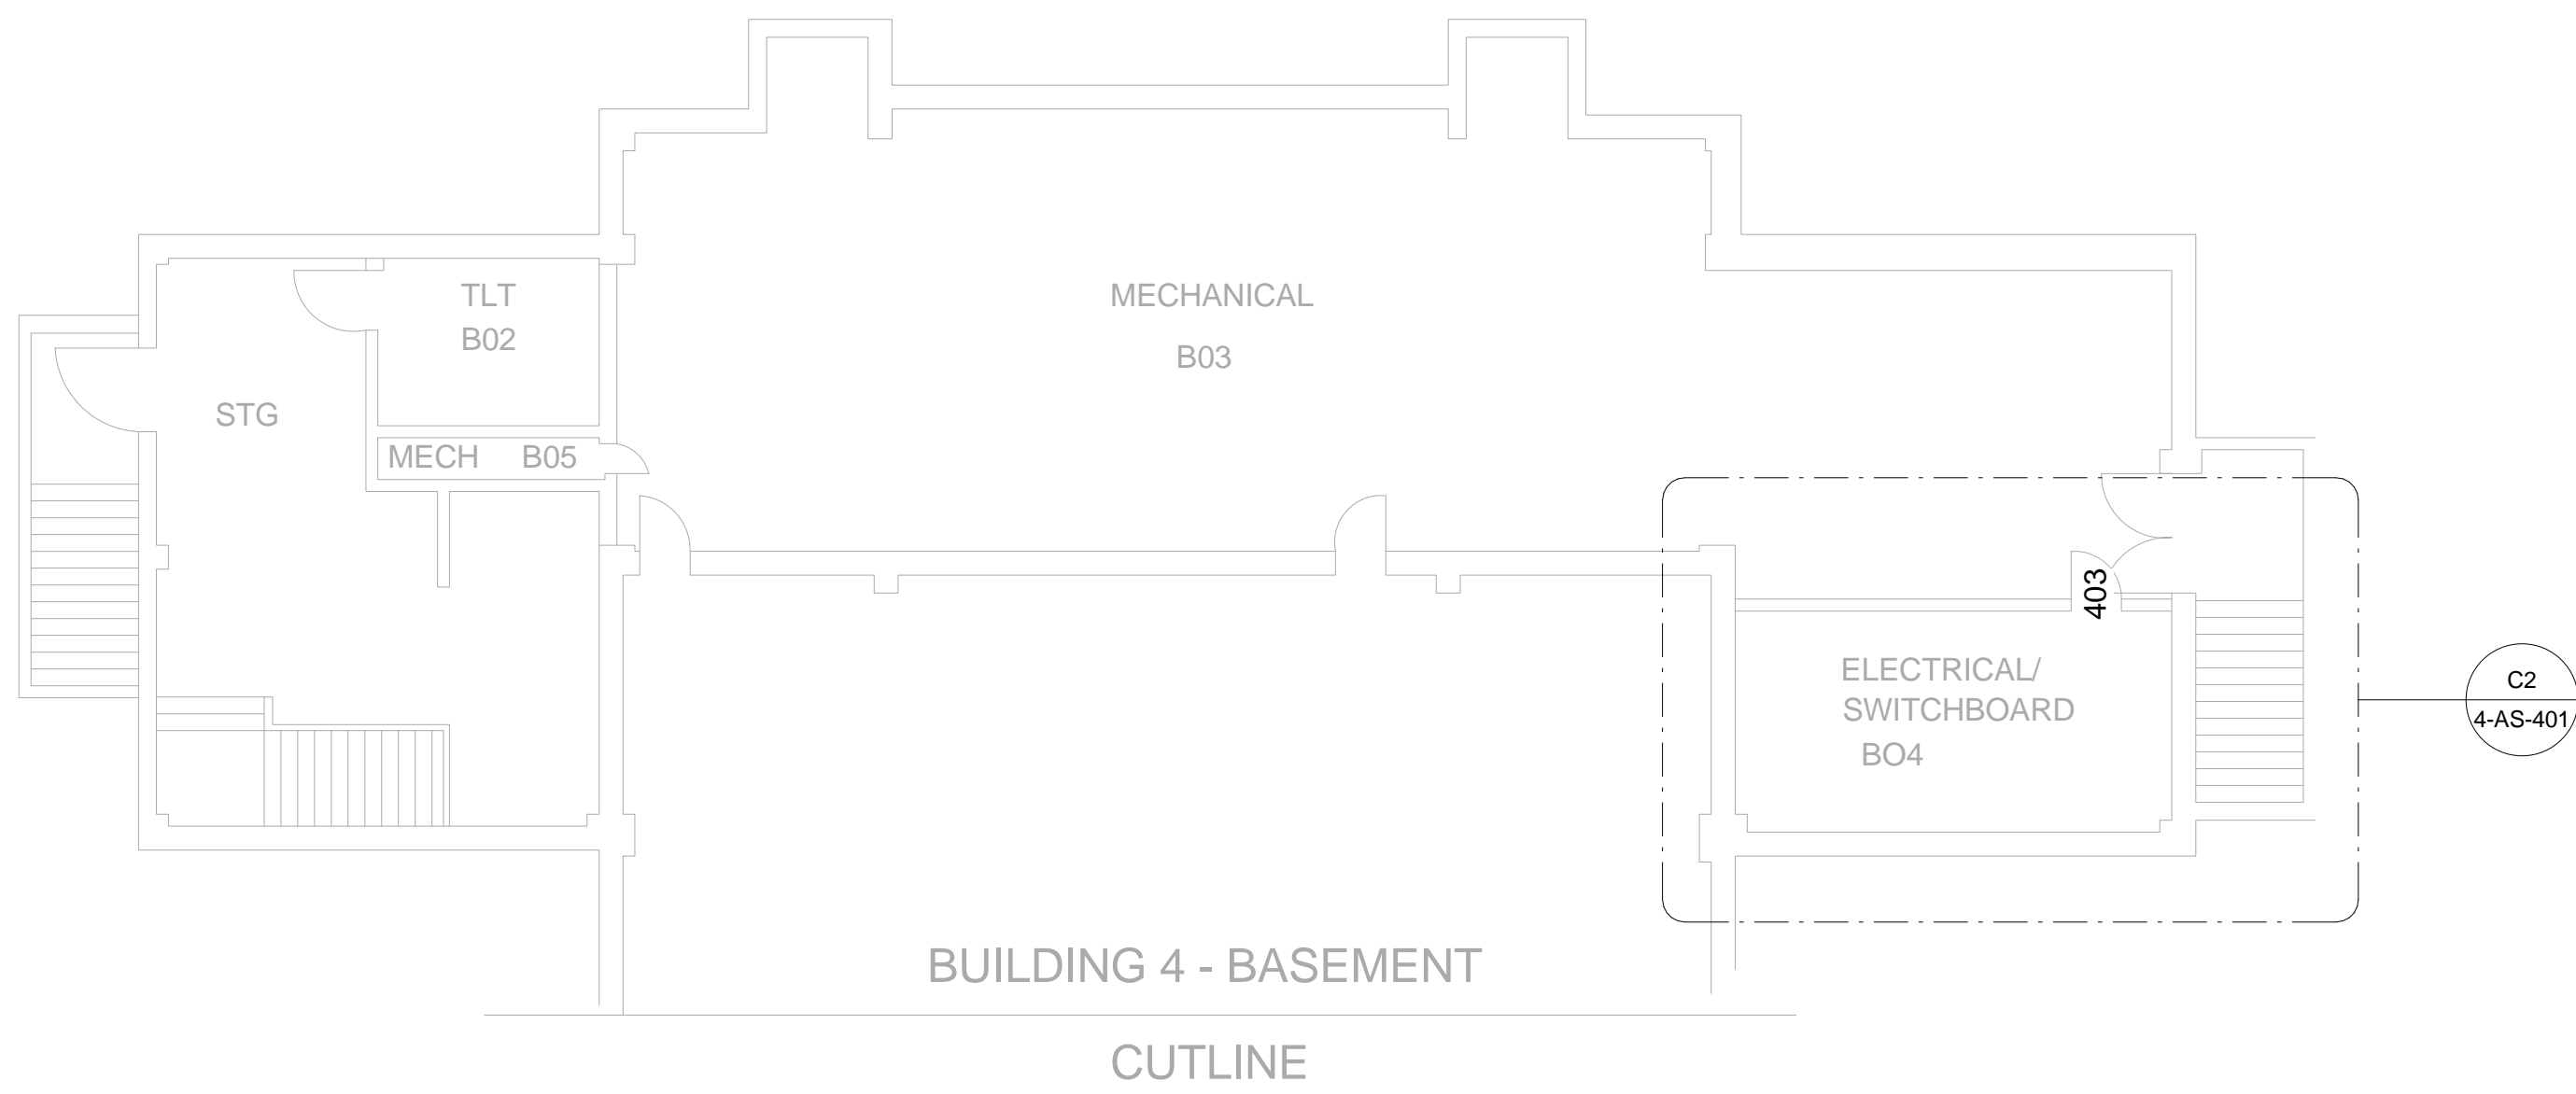2




C1 BLDG. #4 - GROUND FLOOR

1/8" = 1'-0"


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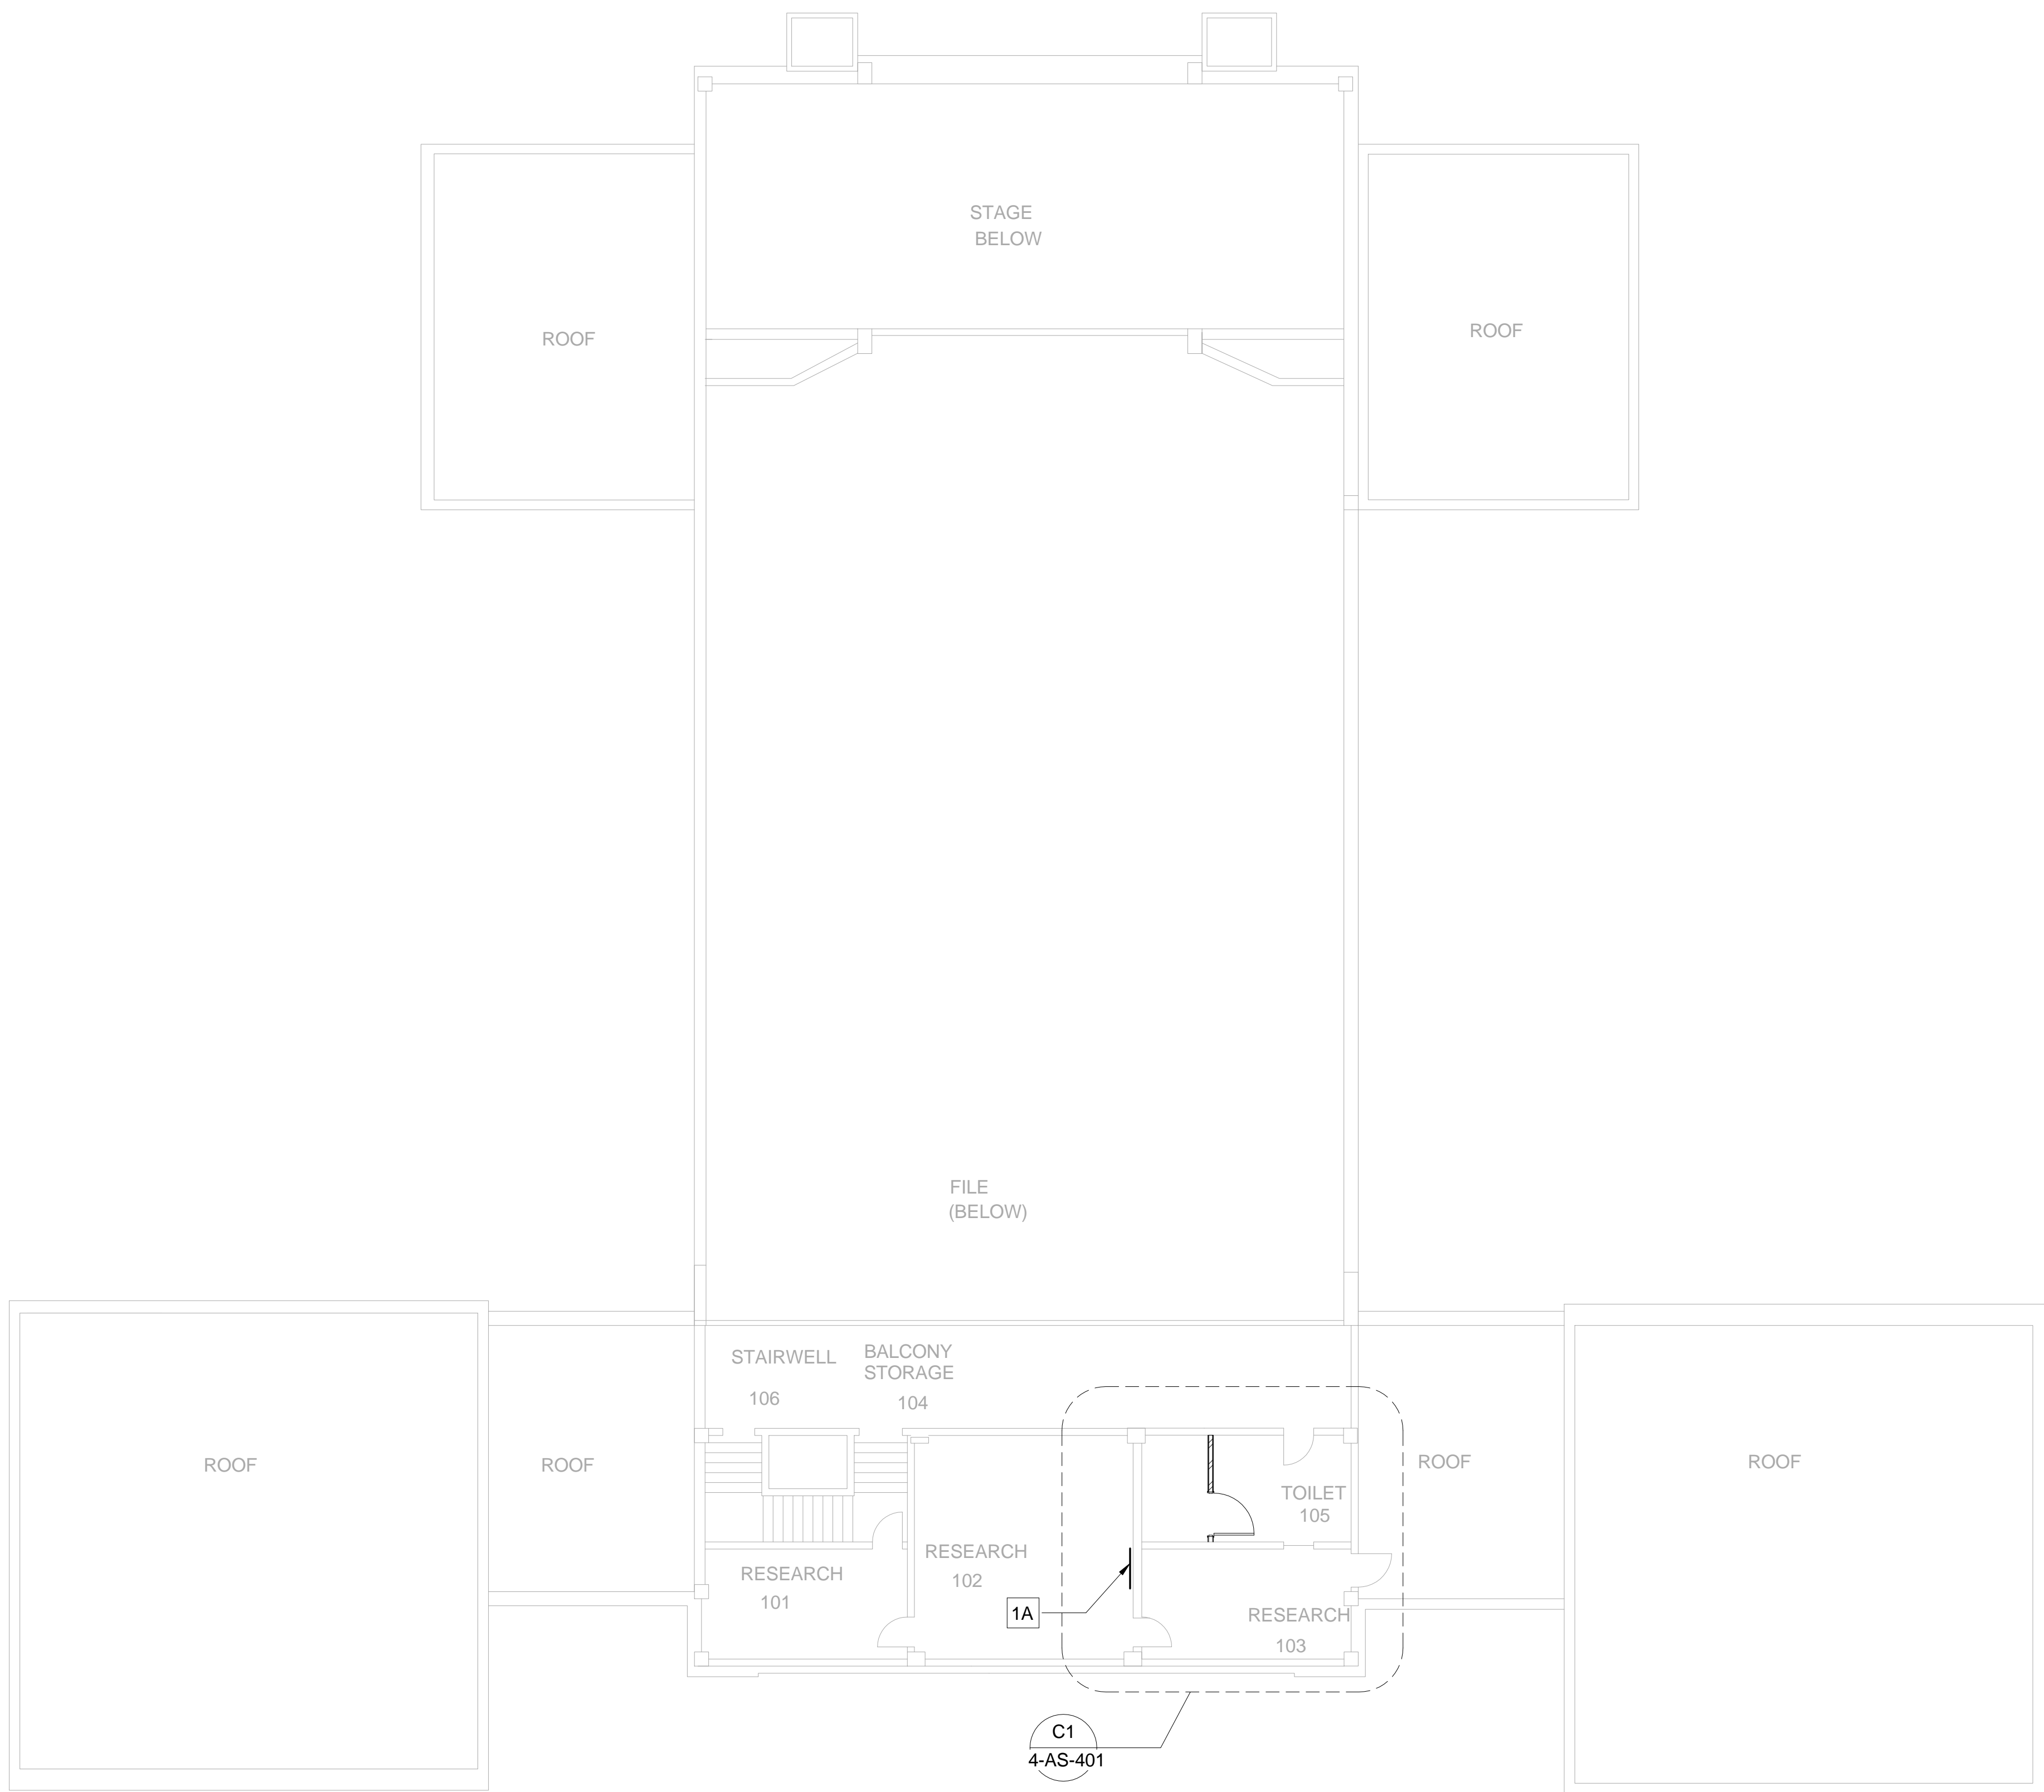
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GHP PROJECT #: 00040.01

PROJECT TITLE: UPGRADE ELEC. DISTRIBUTION - PHASE 3	DATE: OCTOBER 31, 2012
SHEET TITLE: GROUND FLOOR	PROJECT NUMBER: 626A4-1 1-202
APPROVED BY:	DWG # 4-AS-105
APPROVED BY:	Dwg. 16 of 97
BLDG # 4	CHECKED BY:
	DRAWN BY:

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KEY NOTES	
1A	RELOCATE EXISTING RECESSED ELECTRIC PANEL TO NEW ELECTRICAL ROOM / CLOSET. PATCH AND REPAIR WALL WITH GYP. BD. AND STL. STUDS AS NECESSARY. REFINISH WALL MATERIAL / COLOR / SHEEN SHALL MATCH SURROUNDING CONDITIONS. [COVER WITH METAL IN MECHANICAL ROOMS].
1B	RELOCATE EXISTING SURFACE MOUNTED ELECTRIC PANEL TO NEW ELECTRICAL ROOM / CLOSET. PATCH AND FINISH TO MATCH SURROUNDING EXISTING FINISHES.

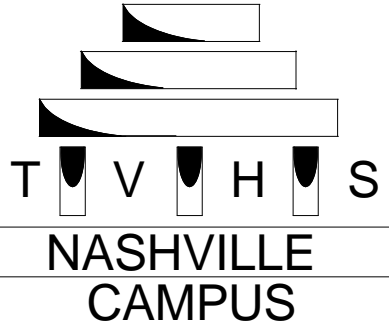


C1 BLDG. #4 - FIRST FLOOR
1/8" = 1'-0"

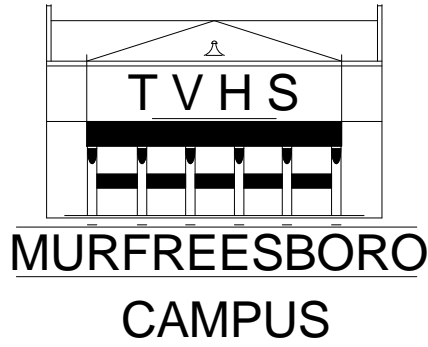0' 2' 4' 8' 16'


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GHP PROJECT #: 00040.01

PROJECT TITLE: UPGRADE ELEC. DISTRIBUTION - PHASE 3		DATE: OCTOBER 31, 2012
SHEET TITLE: 1ST FLOOR		PROJECT NUMBER: 626A4-1 1-202
APPROVED BY:		DWG # 4-AS-106 Dwg. 17 of 97
APPROVED BY:	ALVIN C. YORK CAMPUS JAMES LEAVEN PHE MURFREESBORO, TENNESSEE	
BLDG # 4	CHECKED BY:	DRAWN BY:

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FINISH NOTE:
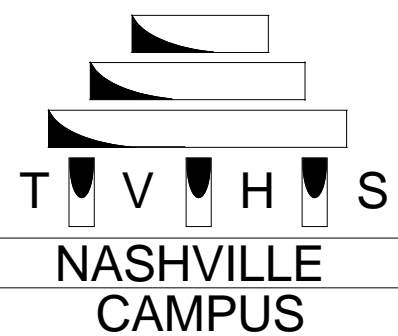
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KEY NOTES


- 1A) RELOCATE EXISTING RECESSED ELECTRIC PANEL TO NEW ELECTRICAL ROOM / CLOSET. PATCH AND REPAIR WALL WITH GYP. BD. AND STL. STUDS AS NECESSARY. REFINISH WALL MATERIAL / COLOR / SHEEN SHALL MATCH SURROUNDING CONDITIONS. [COVER WITH METAL IN MECHANICAL ROOMS].
- 1B) RELOCATE EXISTING SURFACE MOUNTED ELECTRIC PANEL TO NEW ELECTRICAL ROOM / CLOSET. PATCH AND FINISH TO MATCH SURROUNDING EXISTING FINISHES.

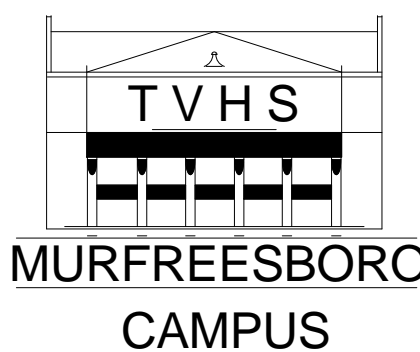



C1 BLDG. #5 - GROUND FLOOR
1/8" = 1'-0"



REVISION	DATE

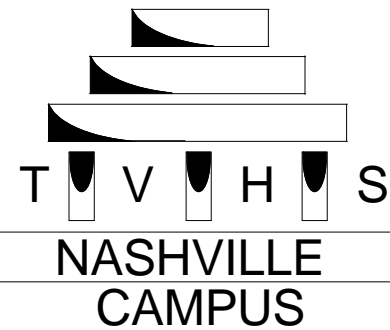


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PROJECT TITLE:	UPGRADE ELEC. DISTRIBUTION - PHASE 3
SHEET TITLE:	GROUND FLOOR
APPROVED BY:	
APPROVED BY:	
BLDG #	5
CHECKED BY:	
DRAWN BY:	

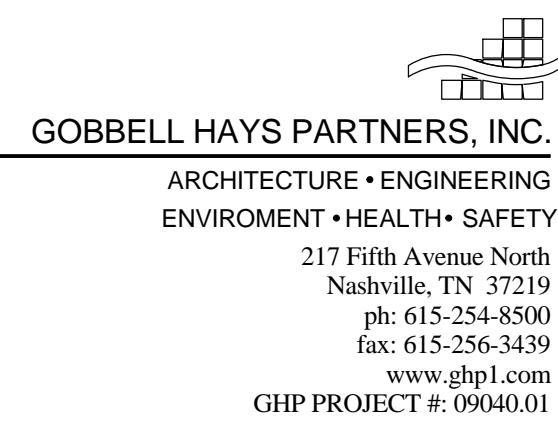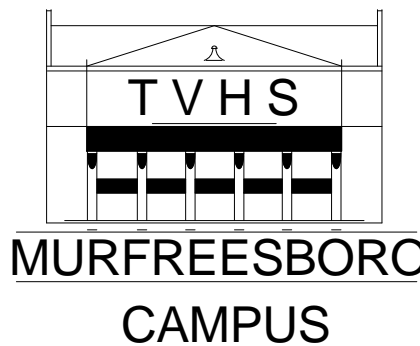DATE:	OCTOBER 31, 2012
PROJECT NUMBER:	626A4-1 1-202
DWG #	5-AS-107
Dwg. 18 of 97	

Department of Veterans Affairs




FINISH NOTE:
FINISH LIMITS INDICATED THUSLY: ' ' DENOTES THE AREA OF THE WALL, CORNER TO CORNER (OR DOOR FRAME). THIS AREA TO BE REPAIRED, PAINTED AND / OR PATCHED WITH MATCHING VINYL WALL COVERING (WALL COVING FURNISHED BY THE GOVERNMENT) AS IS NECESSARY TO MATCH EXISTING FINISH.


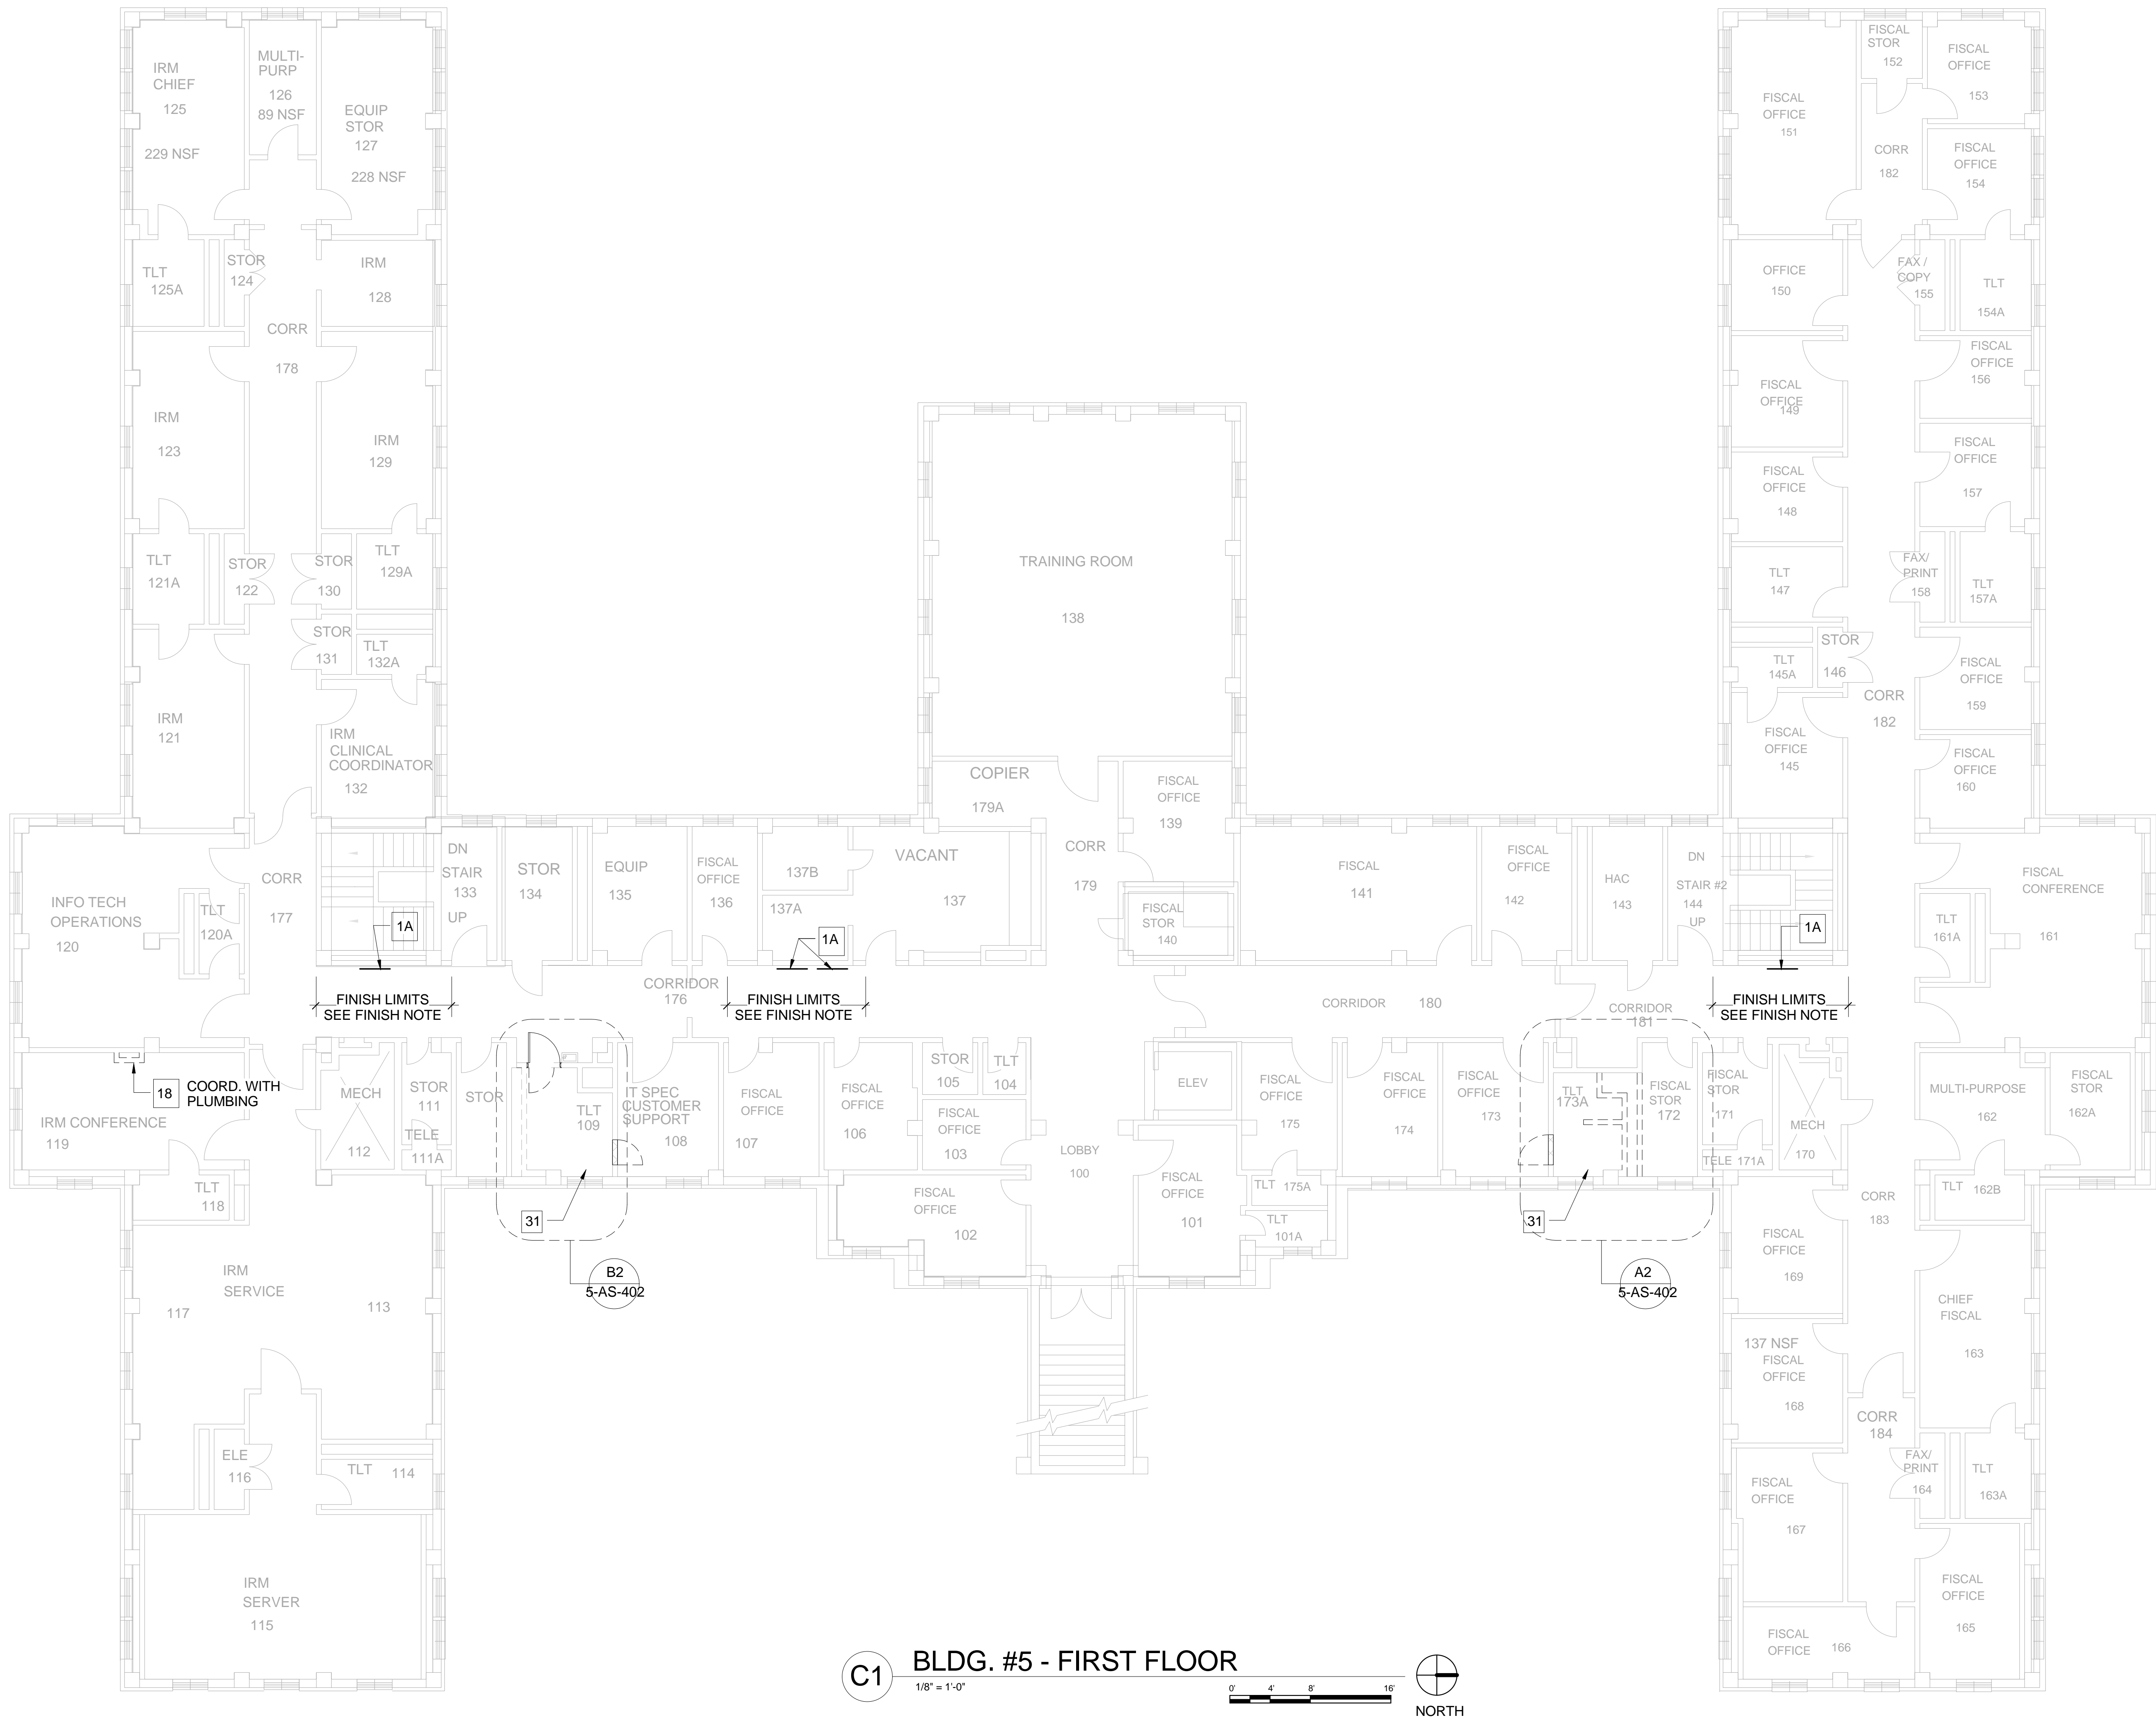
- KEY NOTES
- 1A RELOCATE EXISTING RECESSED ELECTRIC PANEL TO NEW ELECTRICAL ROOM / CLOSET. PATCH AND REPAIR WALL WITH GYP. BD. AND STL. STUDS AS NECESSARY. REFINISH WALL MATERIAL / COLOR / SHEEN SHALL MATCH SURROUNDING CONDITIONS. [COVER WITH METAL IN MECHANICAL ROOMS].
 - 1B RELOCATE EXISTING SURFACE MOUNTED ELECTRIC PANEL TO NEW ELECTRICAL ROOM / CLOSET. PATCH AND FINISH TO MATCH SURROUNDING EXISTING FINISHES.
 - 18 REMOVE EXISTING CHASE. PATCH & REPAIR EXISTING WALLS, FLOOR & CEILING. FINISH TO MATCH SURROUNDING SURFACES.
 - 31 UPON COMPLETION OF MECHANICAL REMOVAL AND ACM ABATEMENT, PATCH REMAINING VOID TO MATCH EXISTING ADJACENT SURFACES. SEE ACM DRAWINGS



REVISION	DATE

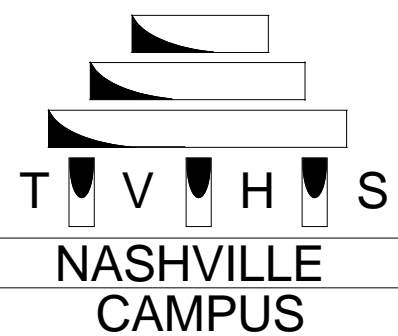

Tennessee Valley Healthcare System

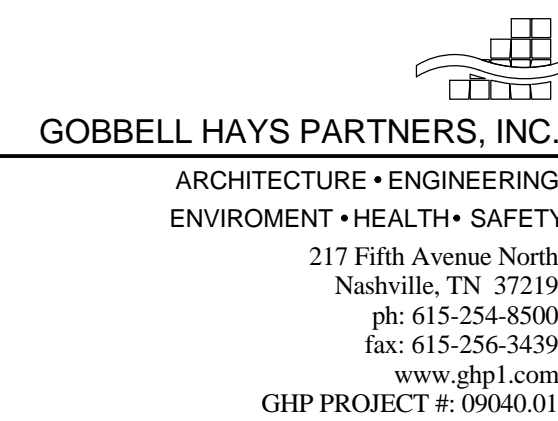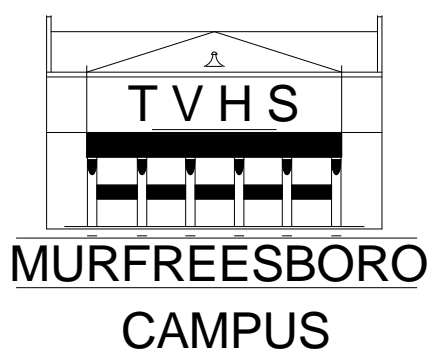

PROJECT TITLE: UPGRADE ELEC. DISTRIBUTION - PHASE 3	DATE: OCTOBER 31, 2012
SHEET TITLE: 1ST FLOOR	PROJECT NUMBER: 626A4-1 1-202
APPROVED BY:	DWG # 5-AS-108
APPROVED BY:	Dwg. 19 of 97
BLDG # 5	CHECKED BY:
	DRAWN BY:


Department of
Veterans Affairs

FINISH LIMITS INDICATED THUSLY: * * DENOTES THE AREA OF THE WALL, CORNER TO CORNER (OR DOOR FRAME). THIS AREA TO BE REPAIRED, PAINTED AND /OR PATCHED WITH MATCHING VINYL WALL COVERING (WALL COVING FURNISHED BY THE GOVERNMENT) AS IS NECESSARY TO MATCH EXISTING FINISH.

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1B	RELOCATE EXISTING SURFACE MOUNTED ELECTRIC PANEL TO NEW ELECTRICAL ROOM / CLOSET. PATCH AND FINISH TO MATCH SURROUNDING EXISTING FINISHES.
31	UPON COMPLETION OF MECHANICAL REMOVAL AND ACM ABATEMENT PATCH REMAINING VOID TO MATCH EXISTING ADJACENT SURFACES. SEE ACM DRAWINGS

[illegible]

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GHP PROJECT #: 09040.01

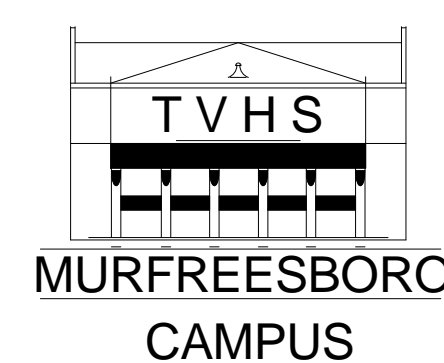PROJECT TITLE: UPGRADE ELEC. DISTRIBUTION - PHASE 3	
SHEET TITLE: 2ND FLOOR	
APPROVED BY:	
APPROVED BY:	ALVIN C. YORK CAMPUS 5400 GILMAN PIKE MURFREESBORO, TENNESSEE
BLDG # 5	CHECKED BY: DRAWN BY:

DATE:
OCTOBER 31, 2012

PROJECT NUMBER:
626A4-1 1-202

DWG #
5-AS-109

Dwg. 20 of 97


Department of
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FINISH NOTE:

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KEY NOTES


- 1A RELOCATE EXISTING RECESSED ELECTRIC PANEL TO NEW ELECTRICAL ROOM / CLOSET. PATCH AND REPAIR WALL WITH GYP. BD. AND STL. STUDS AS NECESSARY. REFINISH WALL MATERIAL / COLOR / SHEEN SHALL MATCH SURROUNDING CONDITIONS. [COVER WITH METAL IN MECHANICAL ROOMS].
- 1B RELOCATE EXISTING SURFACE MOUNTED ELECTRIC PANEL TO NEW ELECTRICAL ROOM / CLOSET. PATCH AND FINISH TO MATCH SURROUNDING EXISTING FINISHES.
- 2 NEW TRANSFORMER PAD - SEE SITE PLAN




C1 BLDG. #6 - GROUND FLOOR
1/8" = 1'-0"
0 4 8 16
NORTH

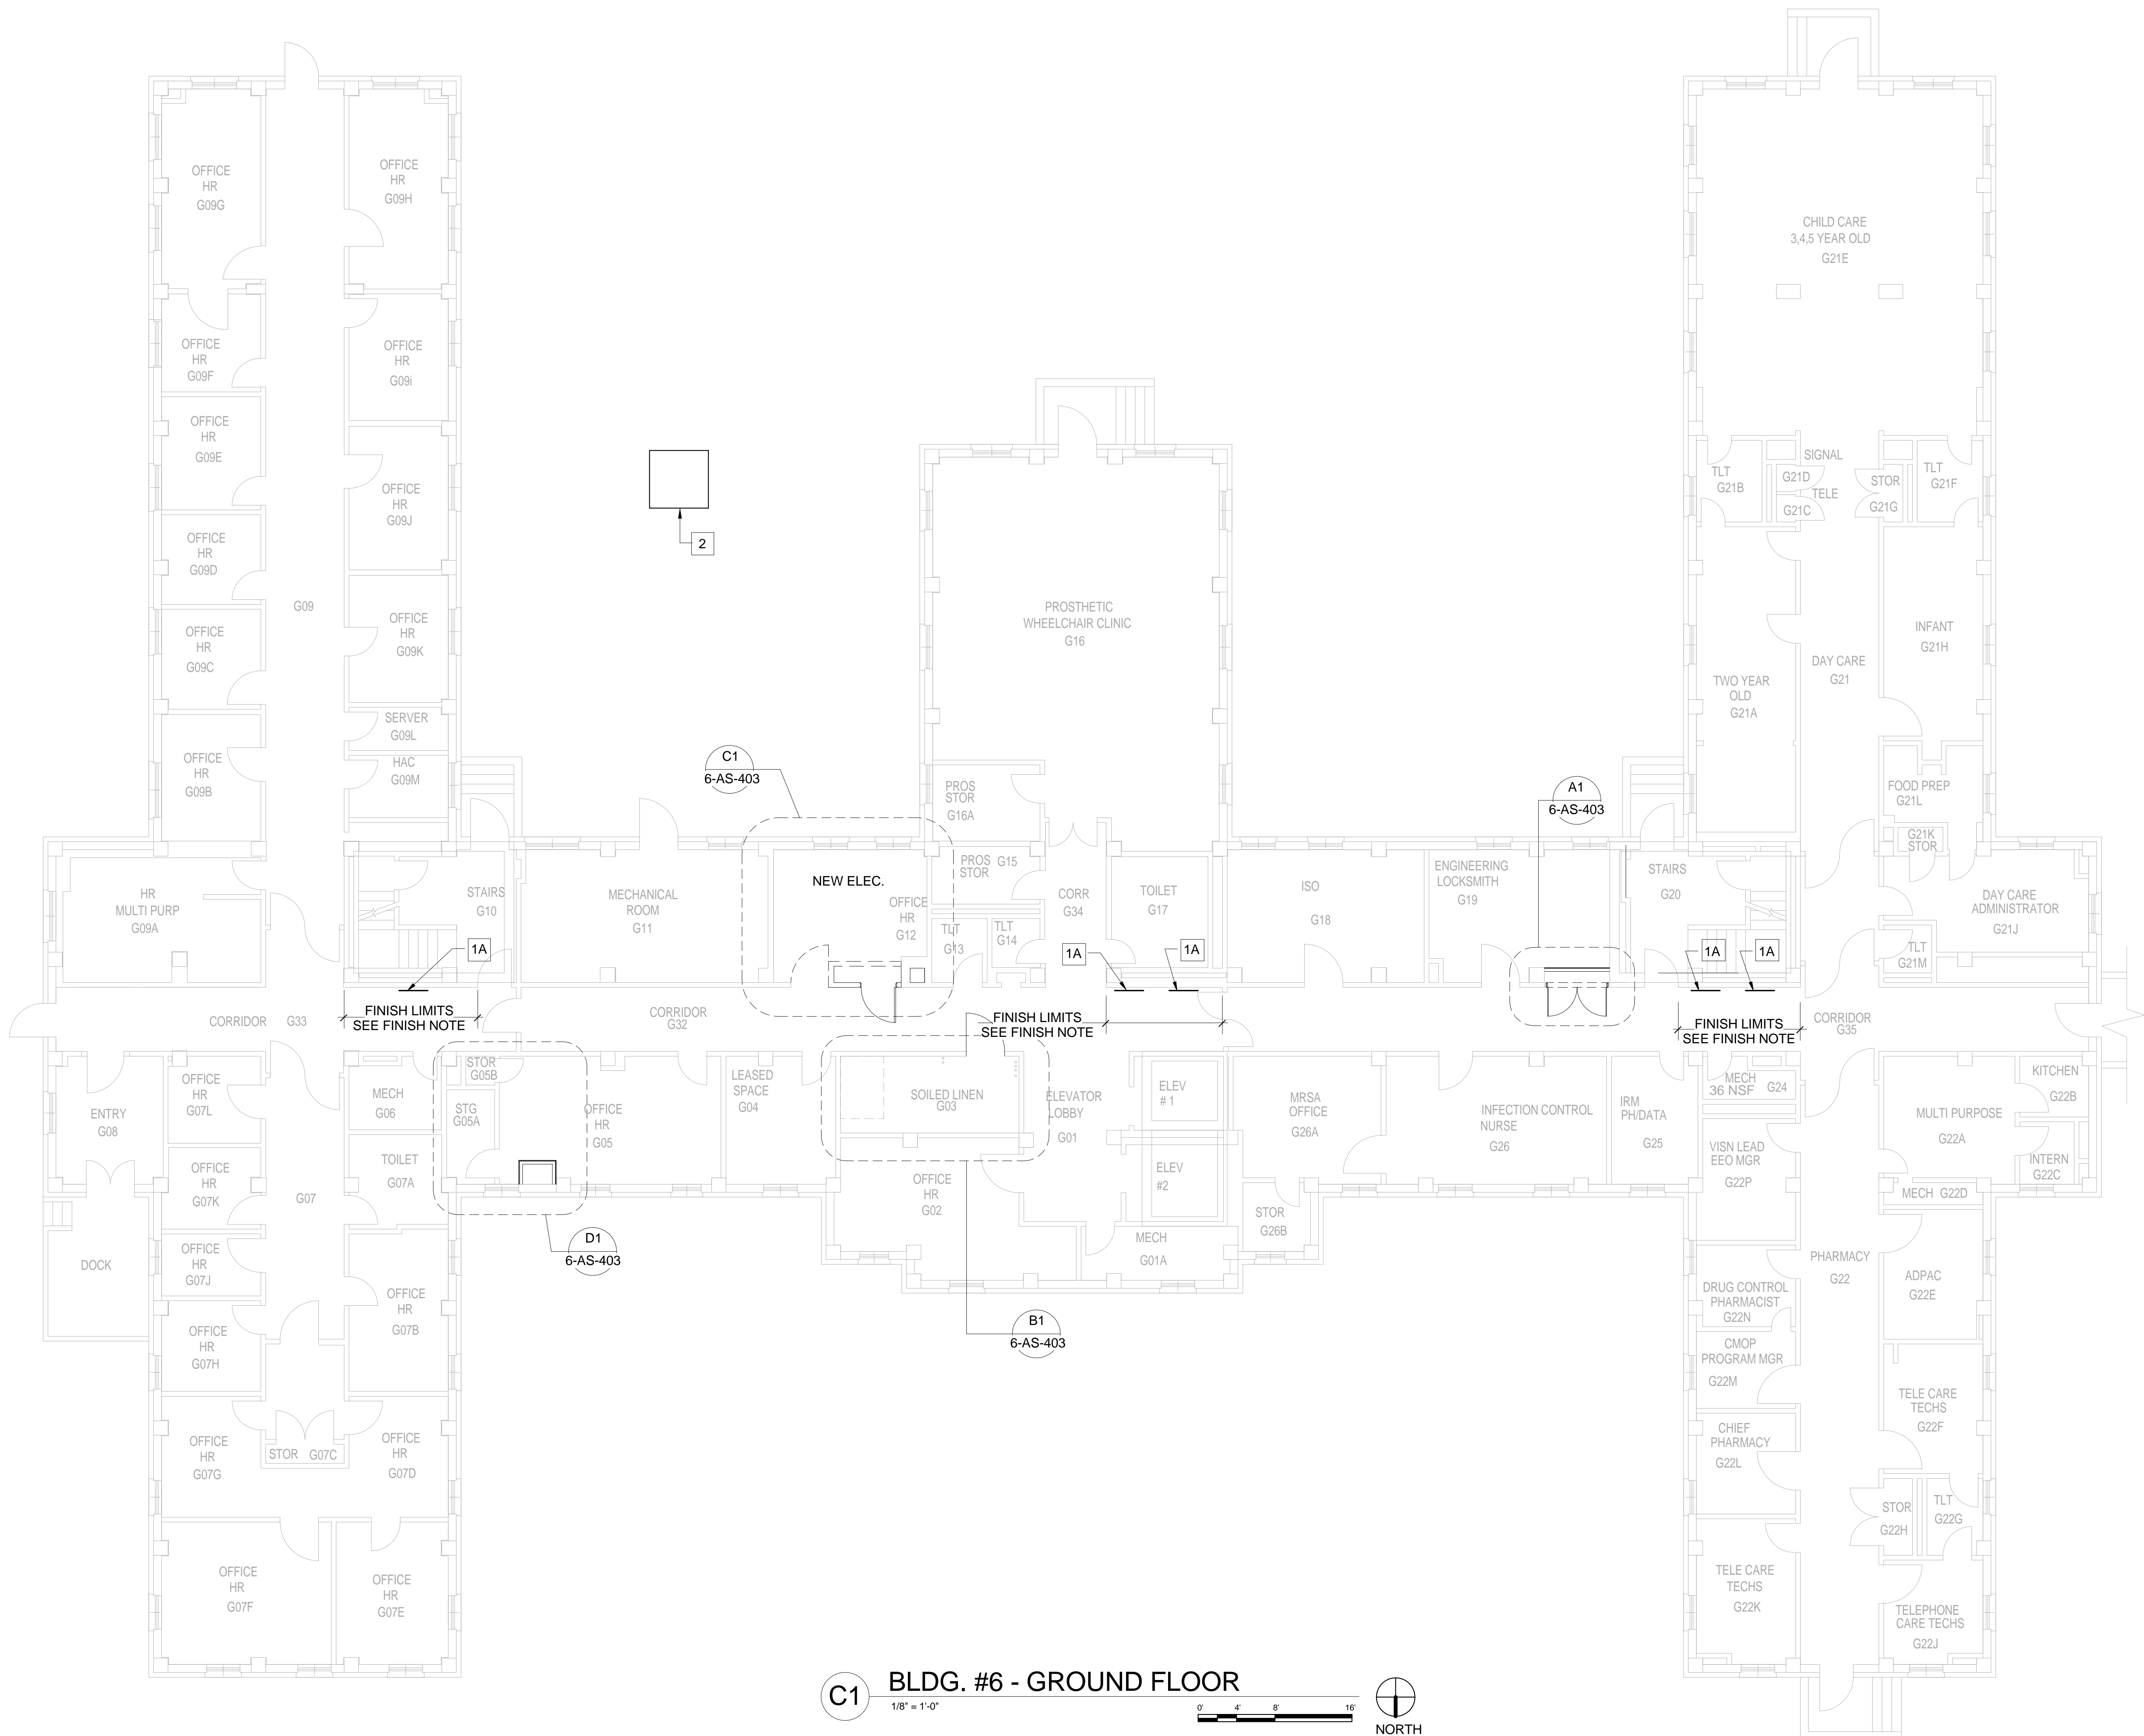

REVISION	DATE

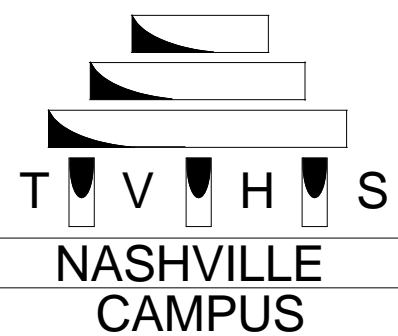


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PROJECT TITLE:	UPGRADE ELEC. DISTRIBUTION - PHASE 3
SHEET TITLE:	GROUND FLOOR
APPROVED BY:	
APPROVED BY:	
BLDG #	6
CHECKED BY:	
DRAWN BY:	

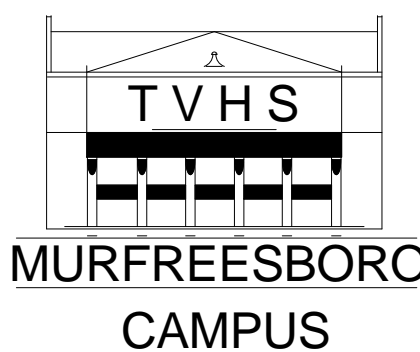DATE:	OCTOBER 31, 2012
PROJECT NUMBER:	626A4-1 1-202
DWG #	6-AS-110
Dwg. 21 of 97	


Department of
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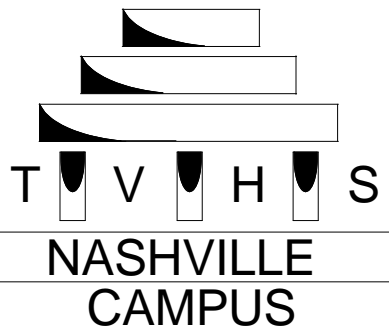
FINISH NOTE:
FINISH LIMITS INDICATED THUSLY: . . . DENOTES THE AREA OF THE WALL, CORNER TO CORNER (OR DOOR FRAME), THIS AREA TO BE REPAIRED, PAINTED AND / OR PATCHED WITH MATCHING VINYL WALL COVERING (WALL COVING FURNISHED BY THE GOVERNMENT) AS IS NECESSARY TO MATCH EXISTING FINISH.

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- 1A RELOCATE EXISTING RECESSED ELECTRIC PANEL TO NEW ELECTRICAL ROOM / CLOSET. PATCH AND REPAIR WALL WITH GYP. BD. AND STL. STUDS AS NECESSARY. REFINISH WALL MATERIAL / COLOR / SHEEN SHALL MATCH SURROUNDING CONDITIONS. [COVER WITH METAL IN MECHANICAL ROOMS],
 - 1B RELOCATE EXISTING SURFACE MOUNTED ELECTRIC PANEL TO NEW ELECTRICAL ROOM / CLOSET. PATCH AND FINISH TO MATCH SURROUNDING EXISTING FINISHES.
 - 7 IN-FILL EXISTING DOOR OPENING WITH MATERIAL TO MATCH ADJACENT WALL CONSTRUCTION. FINISH TO MATCH SURROUNDING CONDITIONS.
- 31 UPON COMPLETION OF MECHANICAL REMOVAL AND ACM ABATEMENT, PATCH REMAINING VOID TO MATCH EXISTING ADJACENT SURFACES. SEE ACM DRAWINGS


C1 BLDG. #6 - FIRST FLOOR
1/8" = 1'-0"

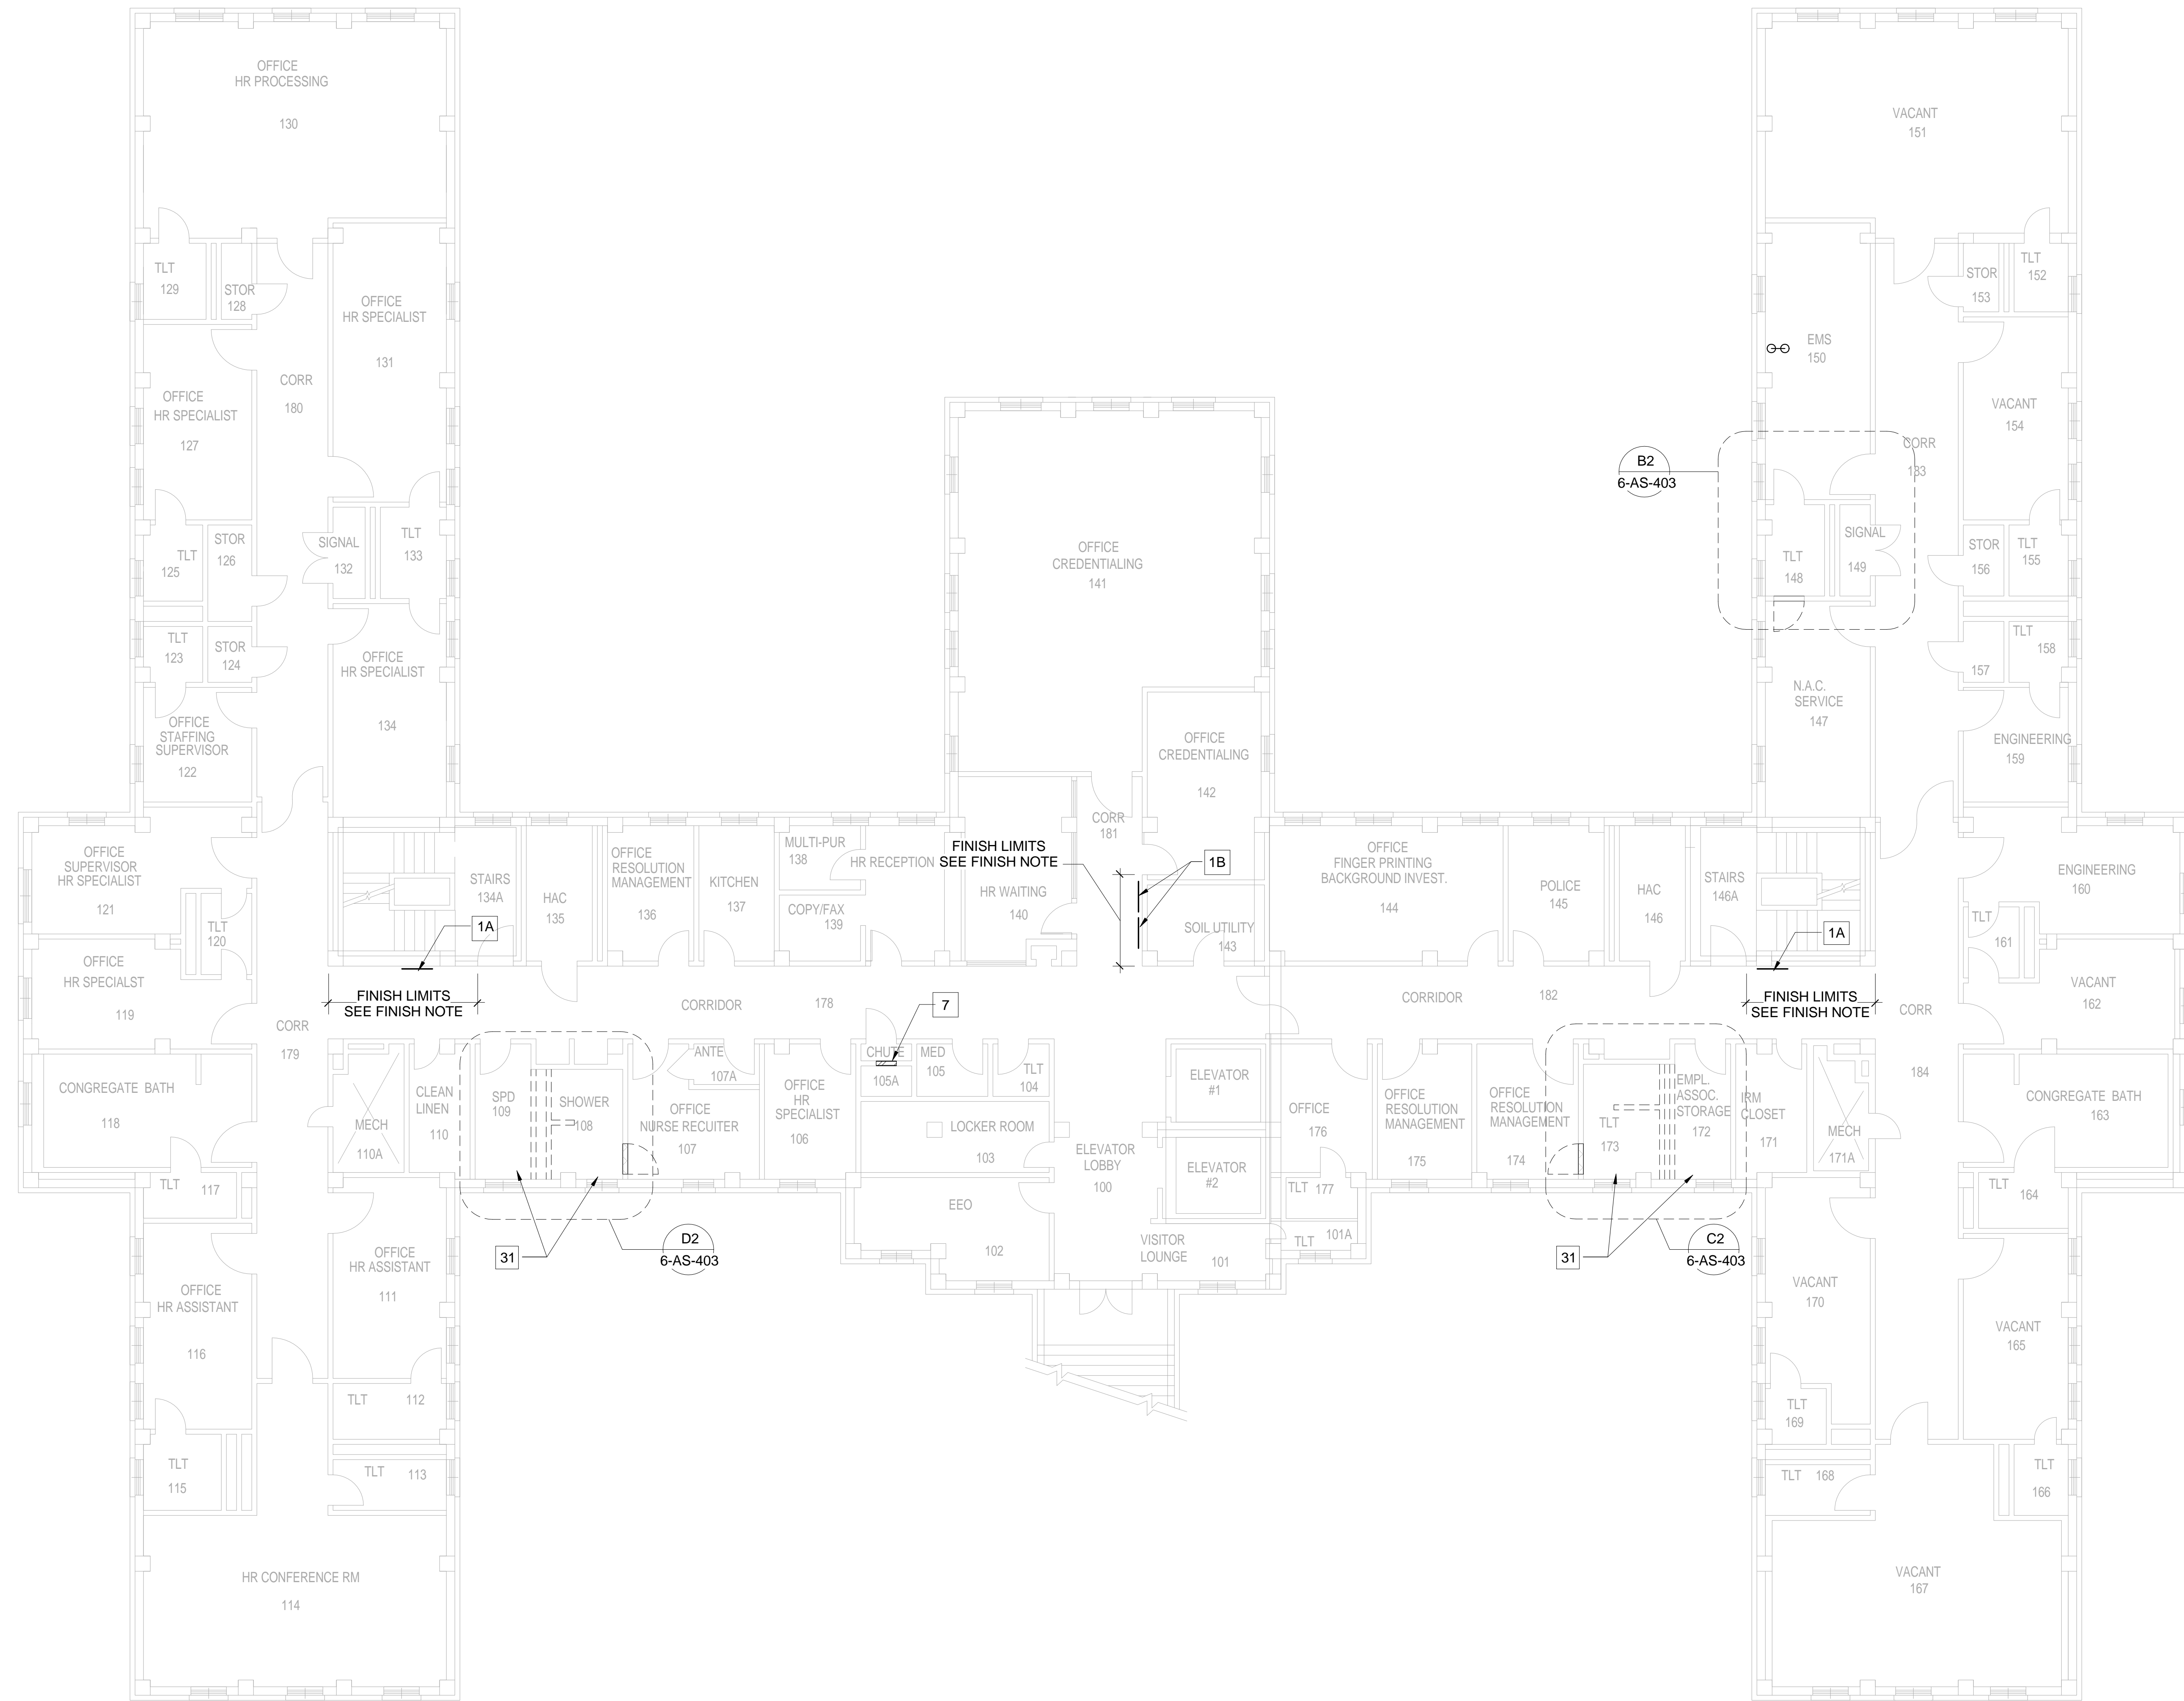

REVISION	DATE

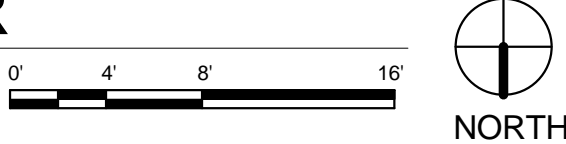

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GHP PROJECT #: 00040.01

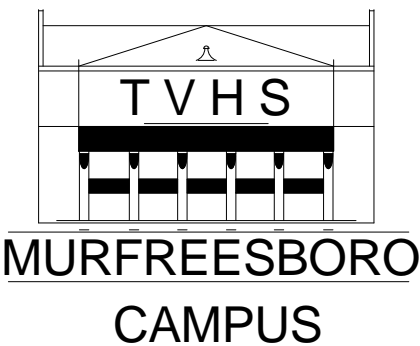PROJECT TITLE:
UPGRADE ELEC. DISTRIBUTION - PHASE 3

SHEET TITLE: **1ST FLOOR**

APPROVED BY: _____

APPROVED BY: _____

BLDG # **6**

CHECKED BY: _____

DRAWN BY: _____

DATE:
OCTOBER 31, 2012


PROJECT NUMBER:
626A4-1-202

DWG # **6-AS-111**
Dwg. 22 of 97

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Veterans Affairs

FINISH LIMITS INDICATED THUSLY: DENOTES THE AREA OF THE WALL, CORNER TO CORNER (OR DOOR FRAME). THIS AREA TO BE REPAIRED, PAINTED AND / OR PATCHED WITH MATCHING VINYL WALL COVERING (WALL COVING FURNISHED BY THE GOVERNMENT) AS IS NECESSARY TO MATCH EXISTING FINISH.

1A	RELOCATE EXISTING RECESSED ELECTRICAL PANEL TO NEW ELECTRICAL ROOM / CLOSET. PATCH AND REPAIR WALL WITH GYP. BD. AND STL. STUDS AS NECESSARY. REFINISH WALL MATERIAL / COLOR / GREEN SHALL MATCH SURROUNDING CONDITIONS. [COVER WITH METAL IN MECHANICAL ROOMS].
1B	RELOCATE EXISTING SURFACE MOUNTED ELECTRICAL PANEL TO NEW ELECTRICAL ROOM / CLOSET. PATCH AND FINISH TO MATCH SURROUNDING EXISTING FINISHES.
31	UPON COMPLETION OF MECHANICAL REMOVAL AND ACM ABATEMENT, PATCH REMAINING VOID TO MATCH EXISTING ADJACENT SURFACES. SEE ACM DRAWINGS
32	EXISTING DUCTWORK (LOTTED WITHIN WALL) SHALL REMAIN. PATCH EXISTING GCL AS REQUIRED TO PROVIDE FINISHED ENCLOSURE AT EXISTING DUCTWORK. VERIFY SIZE & LOCATION IN FIELD.

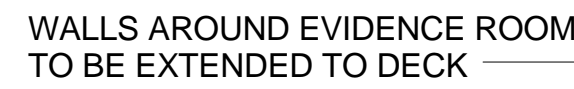

FINISH LIMITS
SEE FINISH NOTE


FINISH LIMITS
SEE FINISH NOTE

FINISH LIMITS
SEE FINISH NOTE


6-AS-403

6-AS-403

6-AS-403

$$1/8'' = 1'-0''$$


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GHP PROJECT #: 09040.01

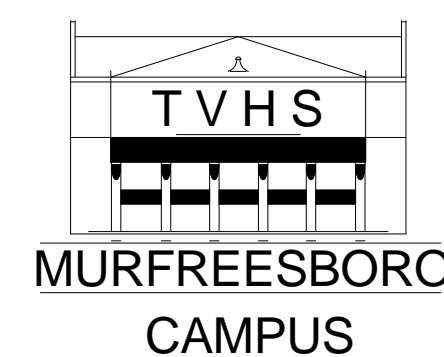
DATE:
OCTOBER 31, 2012

PROJECT NUMBER:
626A4-1 1-202


DWG #
6-AS-112

Dwg. 23 Of 97

Department of
Veterans Affairs

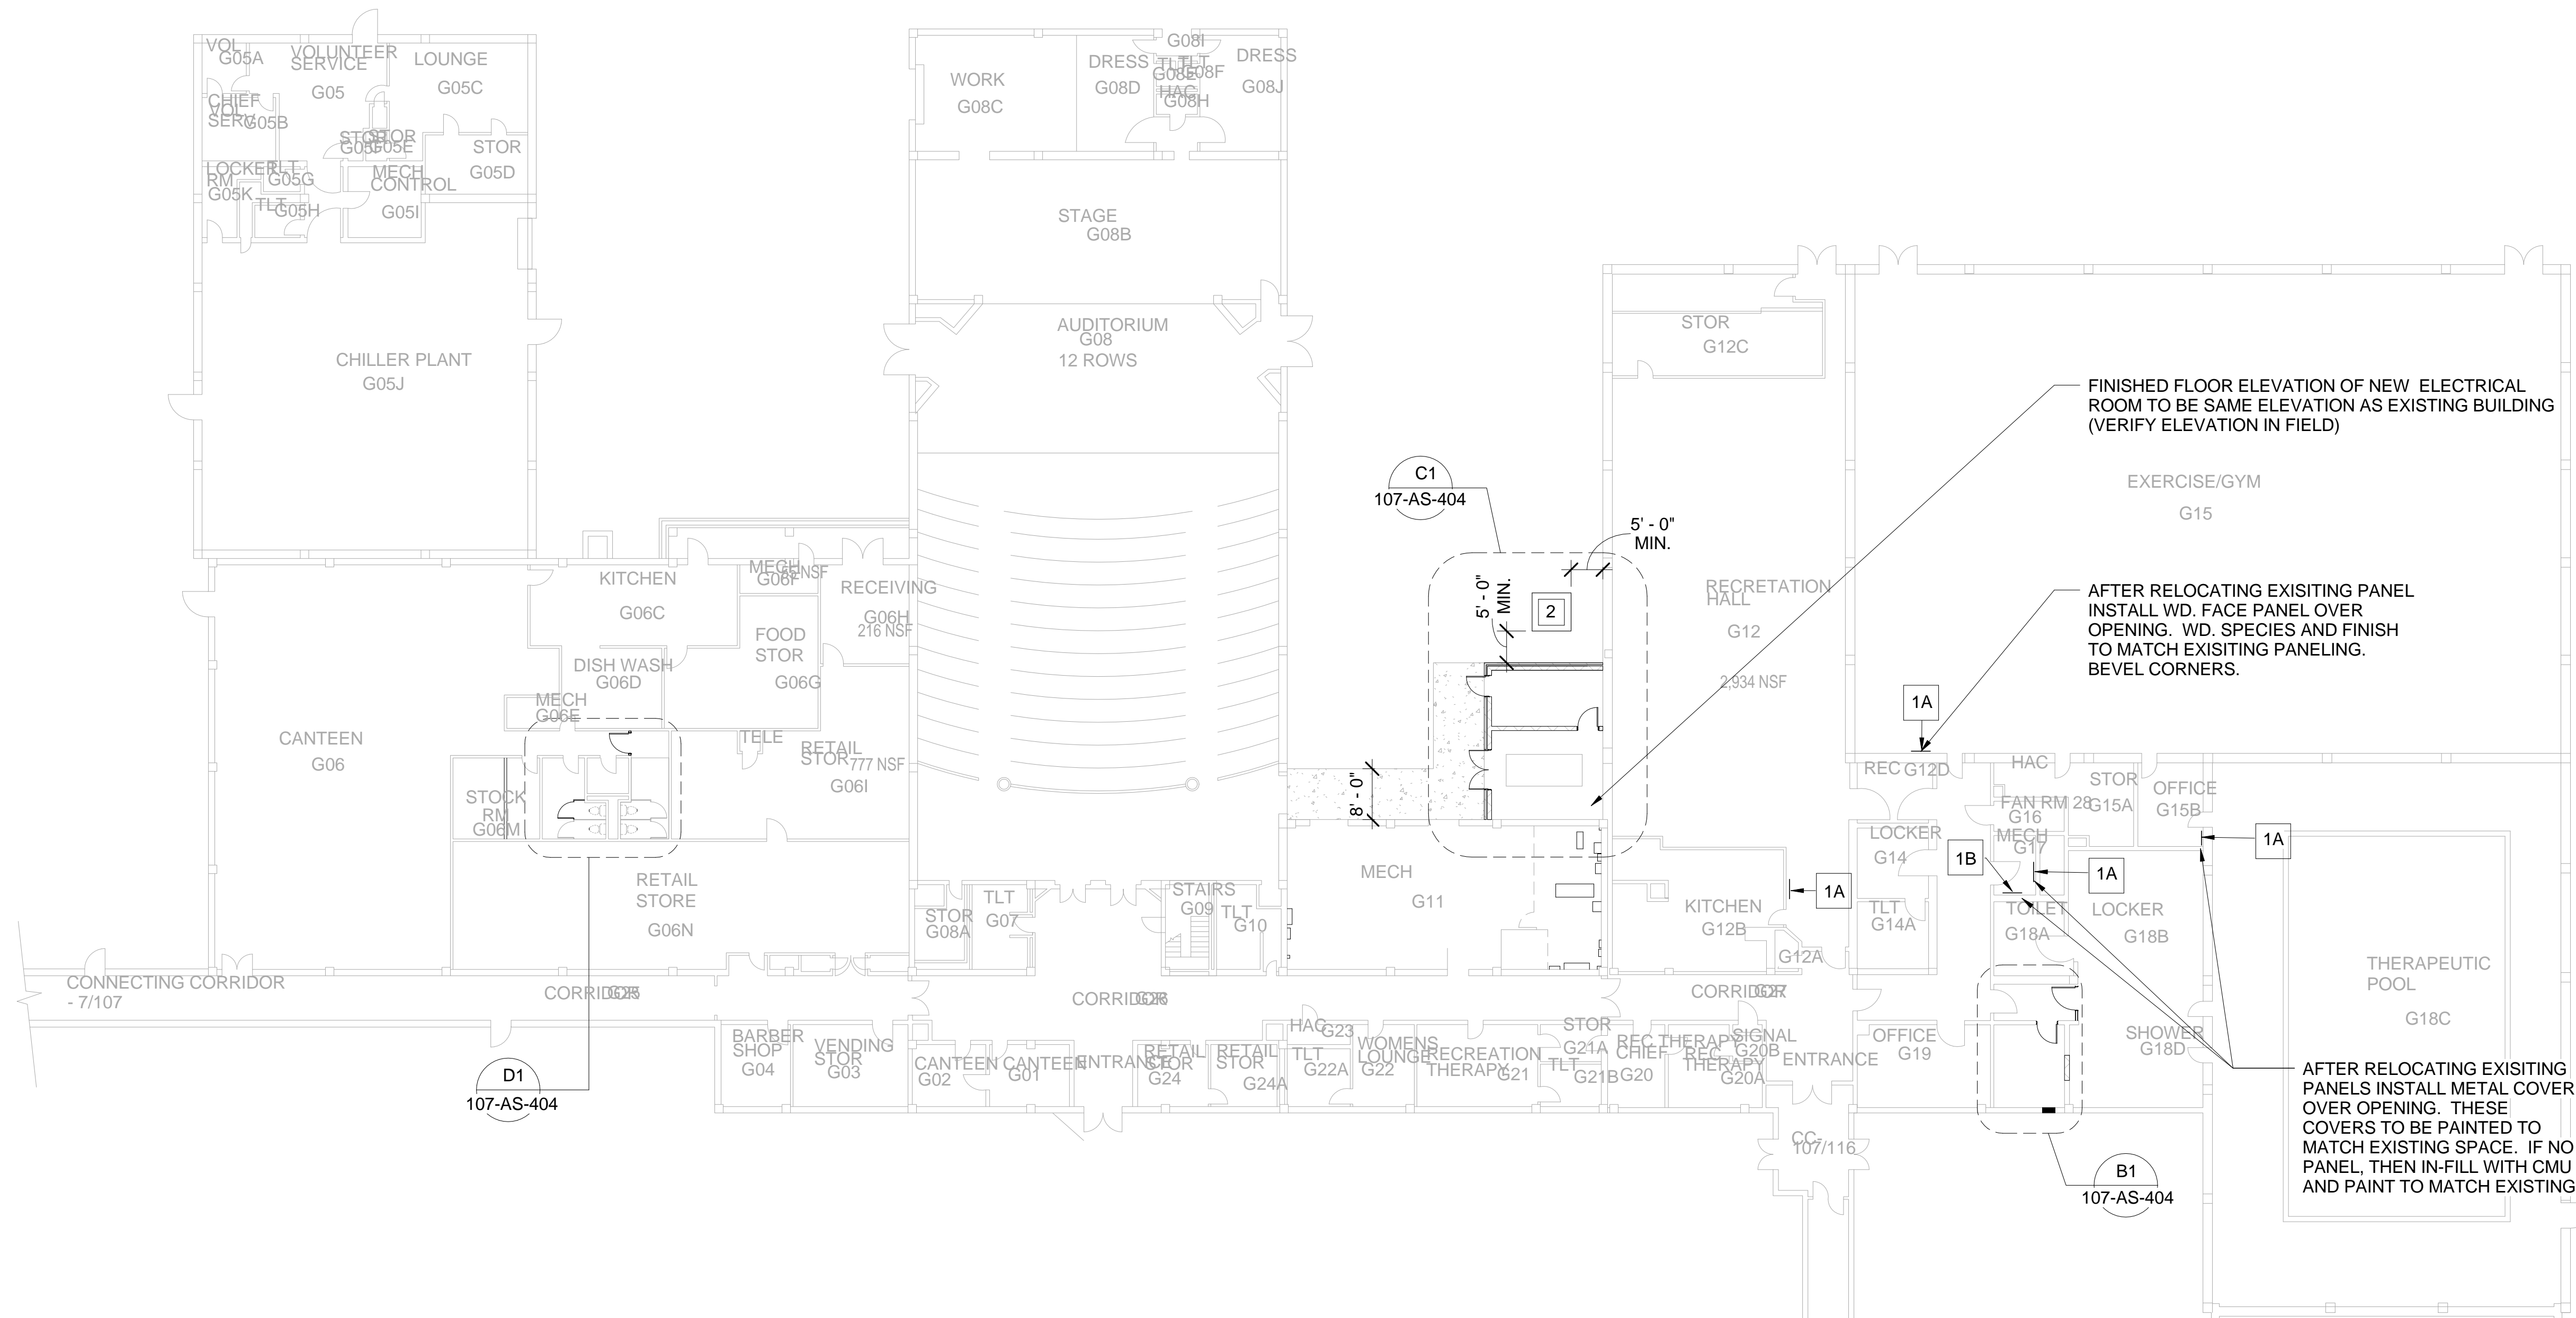

B2 BLDG. #107 - GROUND FLOOR
1/16" = 1'-0"

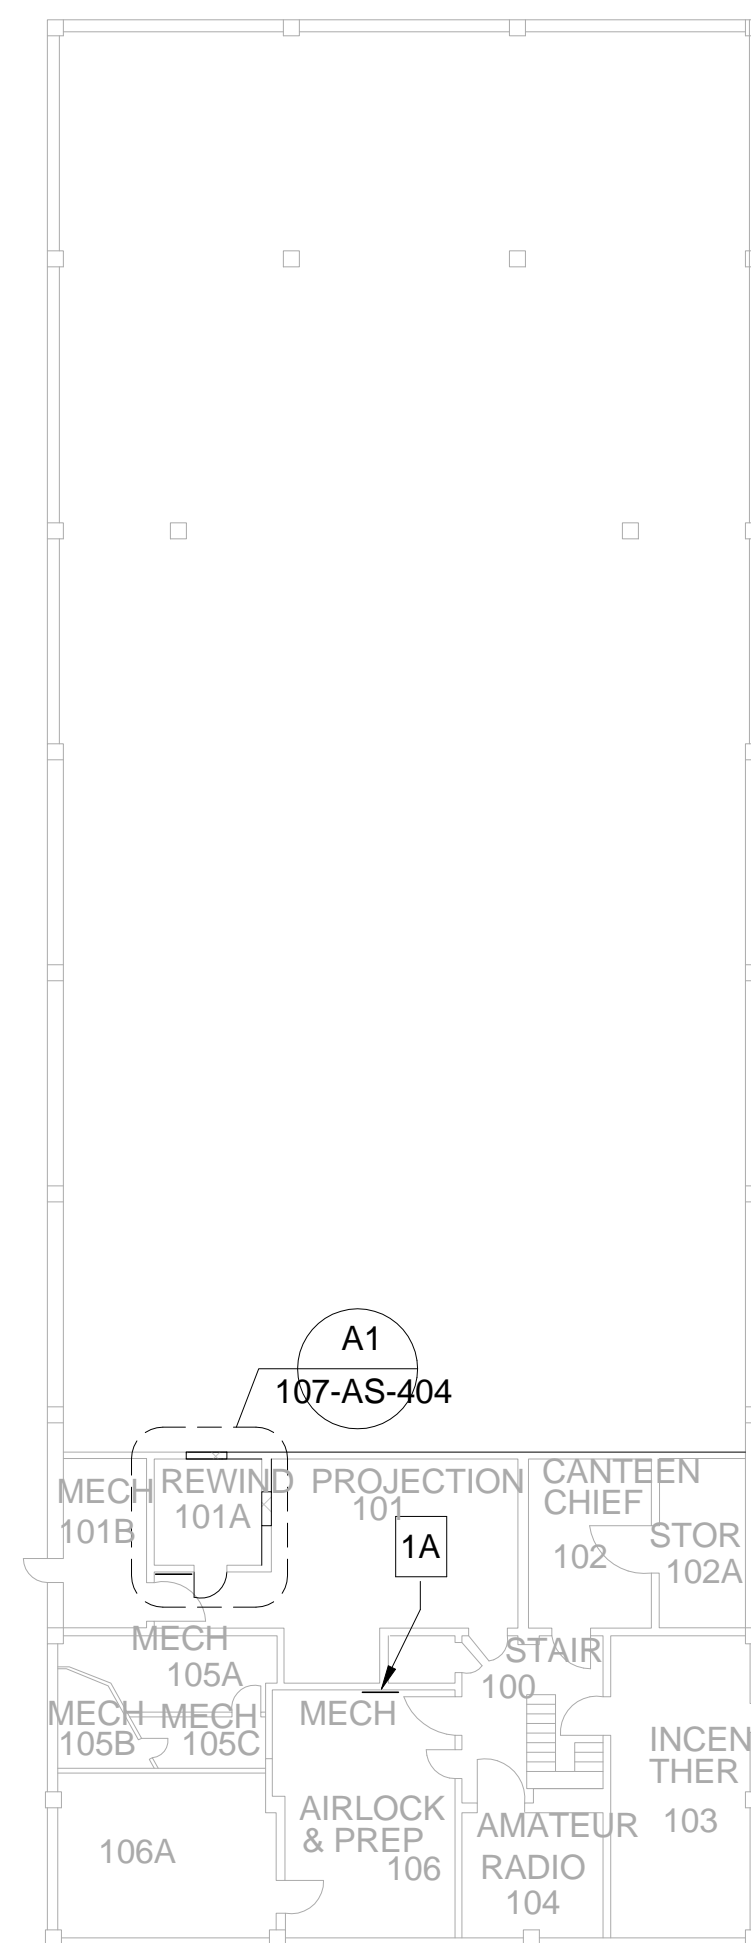


E2 BLDG. #107 - FIRST FLOOR
1/16" = 1'-0"


- KEY NOTES
- 1A RELOCATE EXISTING RECESSED ELECTRIC PANEL TO NEW ELECTRICAL ROOM / CLOSET. PATCH AND REPAIR WALL WITH GYP. BD. AND STL. STUDS AS NECESSARY. REFINISH WALL MATERIAL / COLOR / SHEEN SHALL MATCH SURROUNDING CONDITIONS. [COVER WITH METAL IN MECHANICAL ROOMS],
 - 1B RELOCATE EXISTING SURFACE MOUNTED ELECTRIC PANEL TO NEW ELECTRICAL ROOM / CLOSET. PATCH AND FINISH TO MATCH SURROUNDING EXISTING FINISHES.
 - 2 NEW TRANSFORMER PAD - SEE SITE PLAN



REVISION	DATE

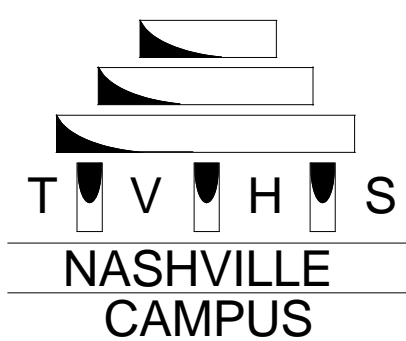

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GHP PROJECT #: 09040.01

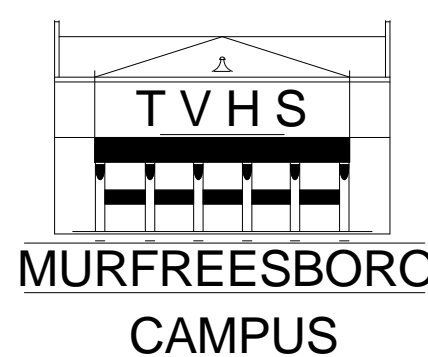PROJECT TITLE:
UPGRADE ELEC. DISTRIBUTION - PHASE 3

SHEET TITLE: **GND / 1ST FLOOR**

APPROVED BY:

APPROVED BY:

BLDG # **107**

CHECKED BY:

DRAWN BY:

DATE:
OCTOBER 31, 2012

PROJECT NUMBER:
626A4-1 1-202

DWG #
107-AS-113
Dwg. 24 of 97


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FINISH NOTE:
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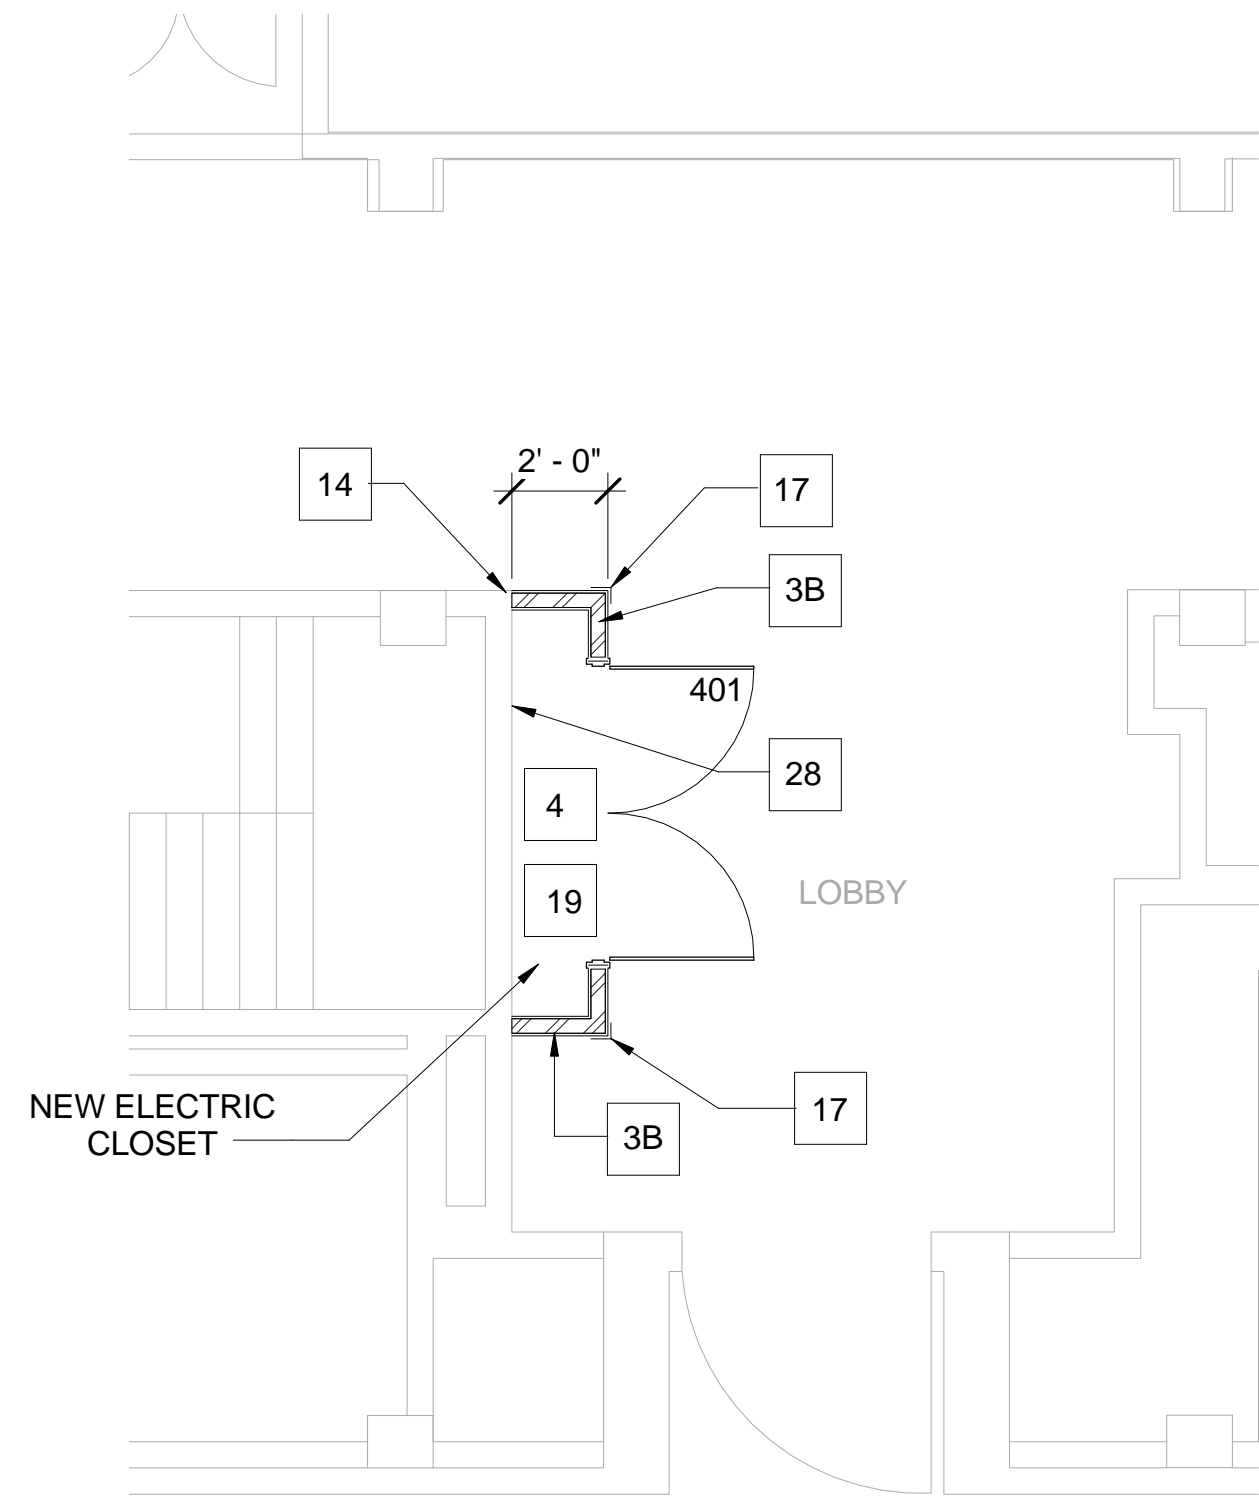
31 UPON COMPLETION OF MECHANICAL REMOVAL AND ACM ABATEMENT, PATCH REMAINING VOID TO MATCH EXISTING ADJACENT SURFACES. SEE ACM DRAWINGS

27	N/A
28	REMOVE EXISTING CRASH RAIL.
29	N/A
30	N/A


KEY NOTES	
1A	RELOCATE EXISTING RECESSED ELECTRIC PANEL TO NEW ELECTRICAL ROOM / CLST. PATCH AND REPAIR WALL WITH GYP. BD. AND STL. STUDS. REPAINT WALL, COLOR / SHEEN SHALL MATCH SURROUNDING CONDITIONS.
1B	N/A
2	N/A
3A	N/A
3B	NEW WALL: 3 5/8" x 20GA. STL STUDS @ 1'-4" O.C. WITH 5/8" TYPE 'X' FIRE RATED GYP. BD. ON EACH FACE. WALL TO EXTEND TO DECK ABOVE AND FORM A SMOKE-TIGHT SEAL. EXTERIOR WALL FACE TO BE PAINTED (OR RECEIVE VINYL WALL COVERING) TO MATCH SURROUNDING WALLS. SEAL ALL PENETRATIONS. WALLS TO RECEIVE 3 1/2" SOUND BATT INSULATION, UNLESS OTHERWISE NOTED. REMOVE EXISTING FLOORING & CEILING AS REQ'D FOR THE INSTALLATION OF NEW PARTITION. REPLACE, PATCH AND REPAIR TO MATCH SURROUNDING CONDITIONS. NEW PARTITION TO REC'V BASE TO MATCH EXISTING.
4	NEW ELECTRIC ROOM / CLOSET - COORD. WITH WORK OF OTHER TRADES. EXISTING WALLS IN THIS AREA TO BE EXTENDED TO DECK ABOVE FORMING A SMOKE-TIGHT CONDITION. WALLS TO BE CONSTRUCTED & FINISHED TO MATCH EXISTING CONDITIONS. PAINT INTERIOR & EXTERIOR OF CLOSET
5	REMOVE PORTION OF EXISTING WALL AND CEILING AS REQ'D TO INSTALL A NEW DOOR AND FRAME AS SCHEDULED. PATCH, REPAIR & FINISH ADJACENT WALL, CEILING AND FLOORING AS NEEDED TO MATCH SURROUNDING CONDITIONS.
6	PATCH & REPAIR EXISTING WALL. FINISH TO MATCH SURROUNDING CONDITIONS.
7	N/A
8	DEMO. TOILET PARTITIONS & PLUMBING FIXTURES. PATCH WALLS & FLOOR TO MATCH EXISTING ADJACENT SURFACES. COORDINATE WITH PLUMBING. REMOVALS SHALL INCLUDE MISC. TOILET ACCESSORIES & TOILET PARTITIONS AS APPROPRIATE.
9	N/A
10	N/A
11	N/A
12	N/A
13	N/A
14	REMOVE EXISTING CORNER GUARD. BLEND EDGE OF NEW WALL CONSTRUCTION WITH EXISTING BULLNOSE CORNER. FINISH TO MATCH EXISTING.
15	N/A
16	REMOVE EXISTING DOOR AND FRAME.
17	INSTALL NEW CORNER GUARDS TO MATCH EXISTING.
18	N/A
19	REMOVE EXISTING CEILING AND EXPOSE TO STRUCT. - PAINT
20	N/A
21	N/A
22	N/A
23	N/A
24	N/A
25	N/A
26	N/A



C2 PARTIAL PLAN - BLDG. #4 BASEMENT ELECTRICAL ROOM
1/4" = 1'-0"

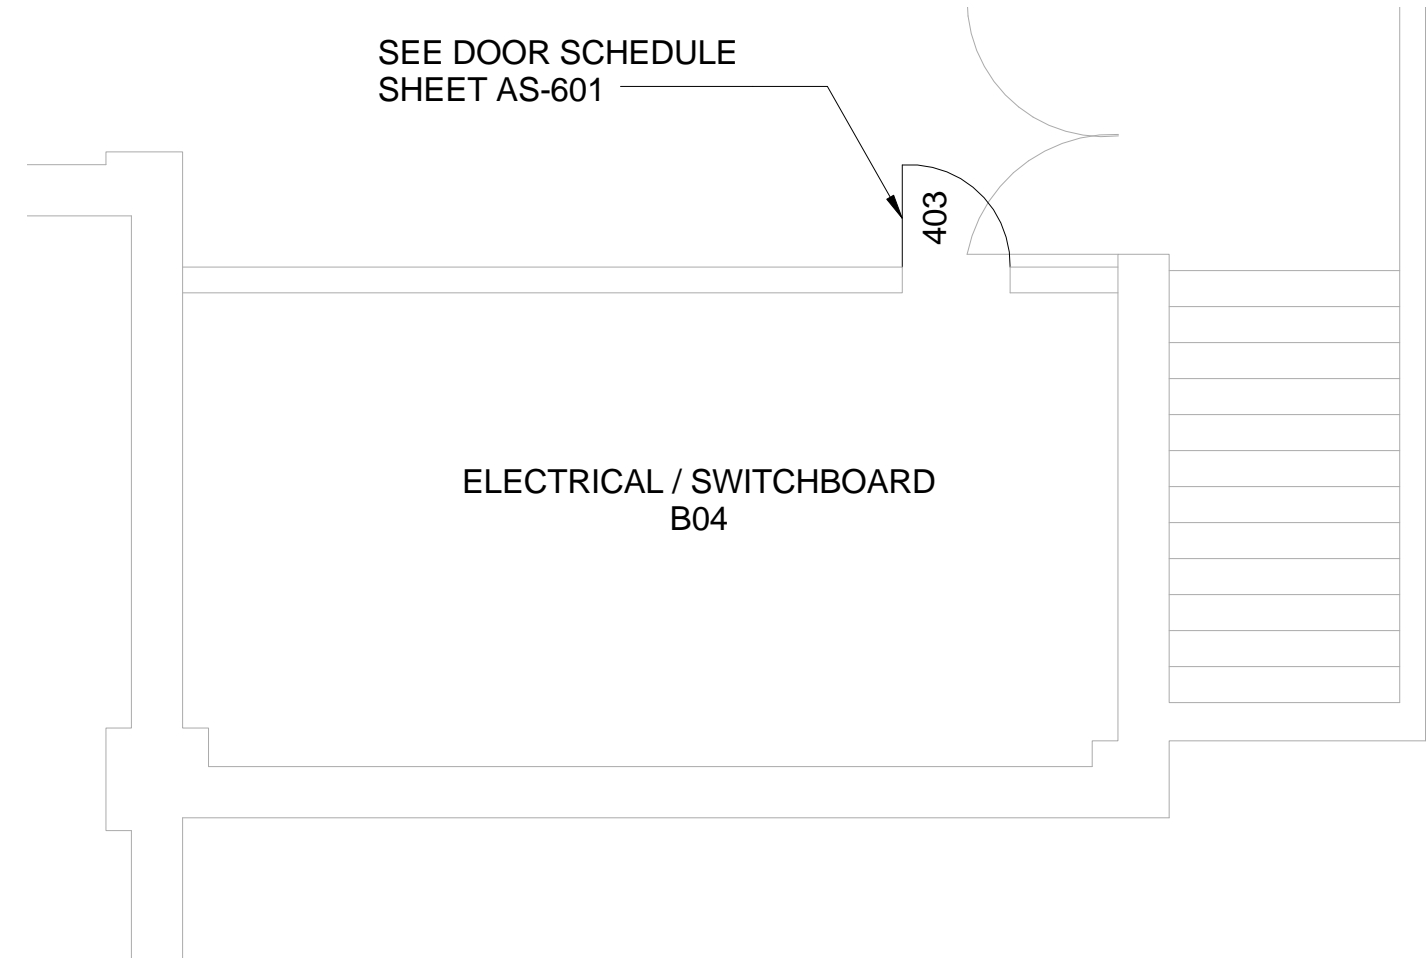

D2 PARTIAL PLAN - BLDG. #4 LOBBY
1/4" = 1'-0"

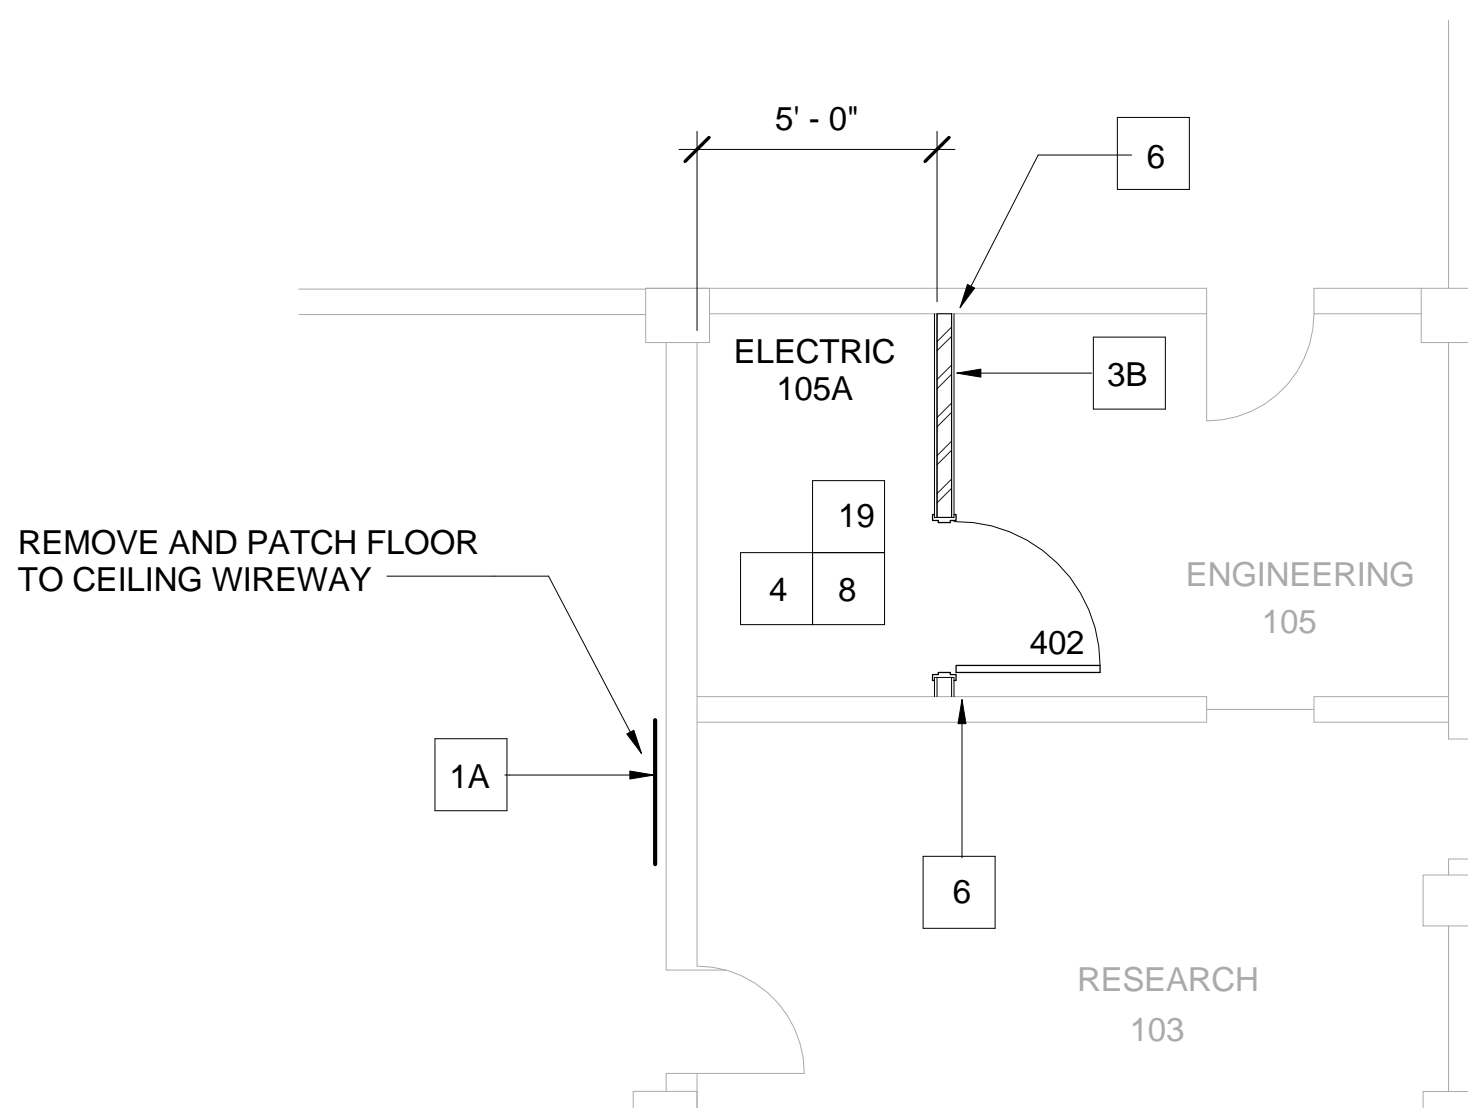


C1 PARTIAL PLAN - BLDG. #4 ELECTRIC 105A
1/4" = 1'-0"

COMPLETELY REMOVE EXISTING WATER DAMAGED WALL FINISH FOR THE FULL LENGTH OF WALL. REPLACE WITH NEW M.R. GYP. BD. FULL HGT. (FLOOR TO CEILING). PAINT TO MATCH EXISTING. INSTALL NEW COVE BASE TO MATCH EXISTING.

REMOVE PORTION OF EXISTING WATER DAMAGED CEILING FINISH. PATCH AND REPAIR TO MATCH EXISTING. PAINT ENTIRE CEILING.

COMPLETELY REMOVE EXISTING WATER DAMAGED WALL FINISH FOR THE FULL LENGTH OF WALL. REPLACE WITH NEW M.R. GYP. BD. FULL HGT. (FLOOR TO UNDERSIDE OF STRUCTURE). PAINT TO MATCH EXISTING. INSTALL NEW COVE BASE TO MATCH EXISTING.


EXISTING WINDOWS TO BE COVERED. SEE DETAIL E1 SHEET AS-501

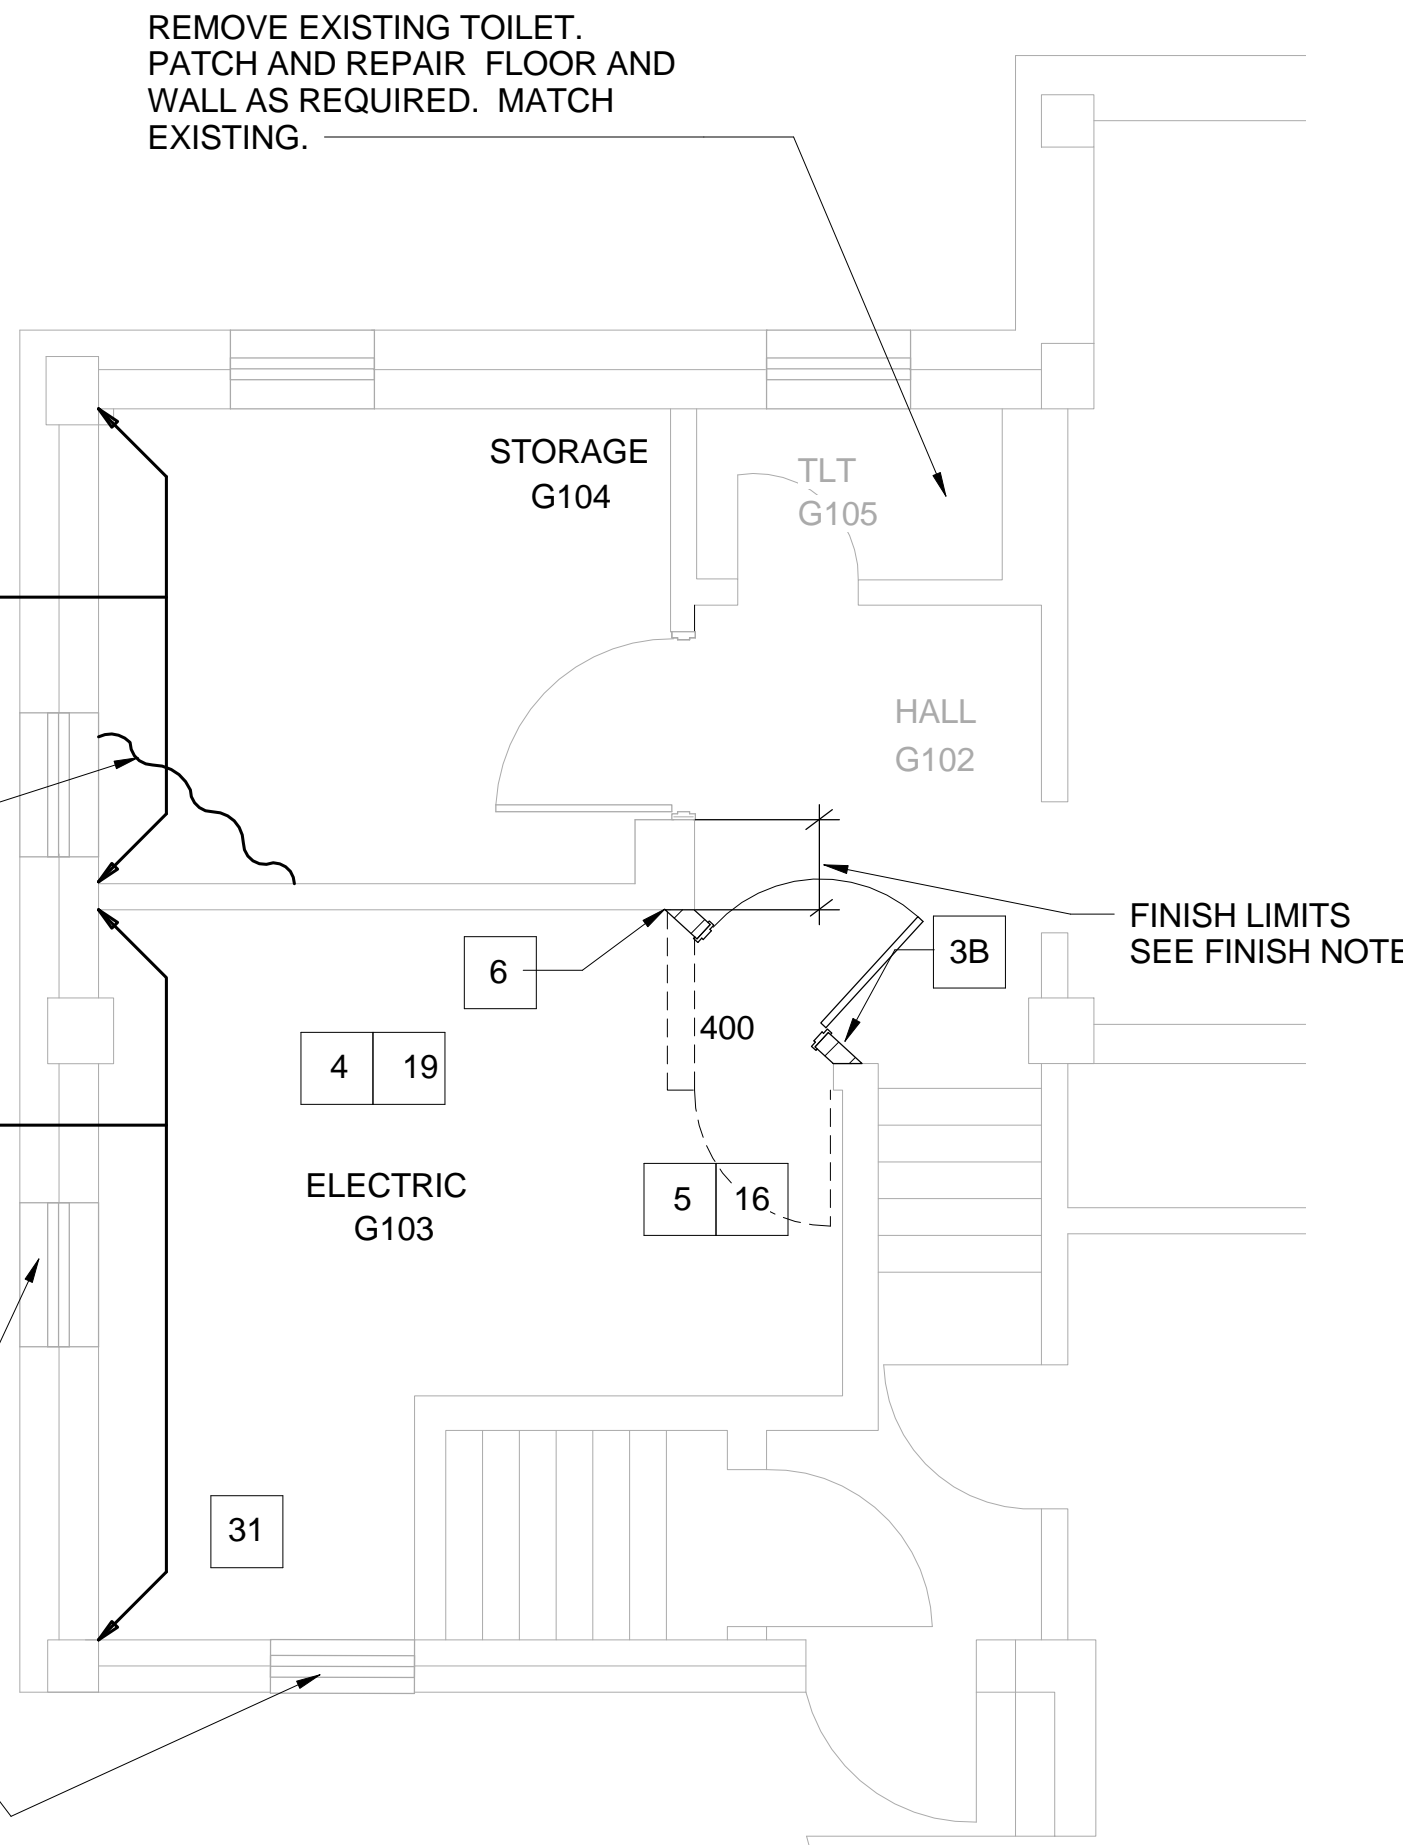


D1 PARTIAL PLAN - BLDG. #4 ELECTRIC G103
1/4" = 1'-0"



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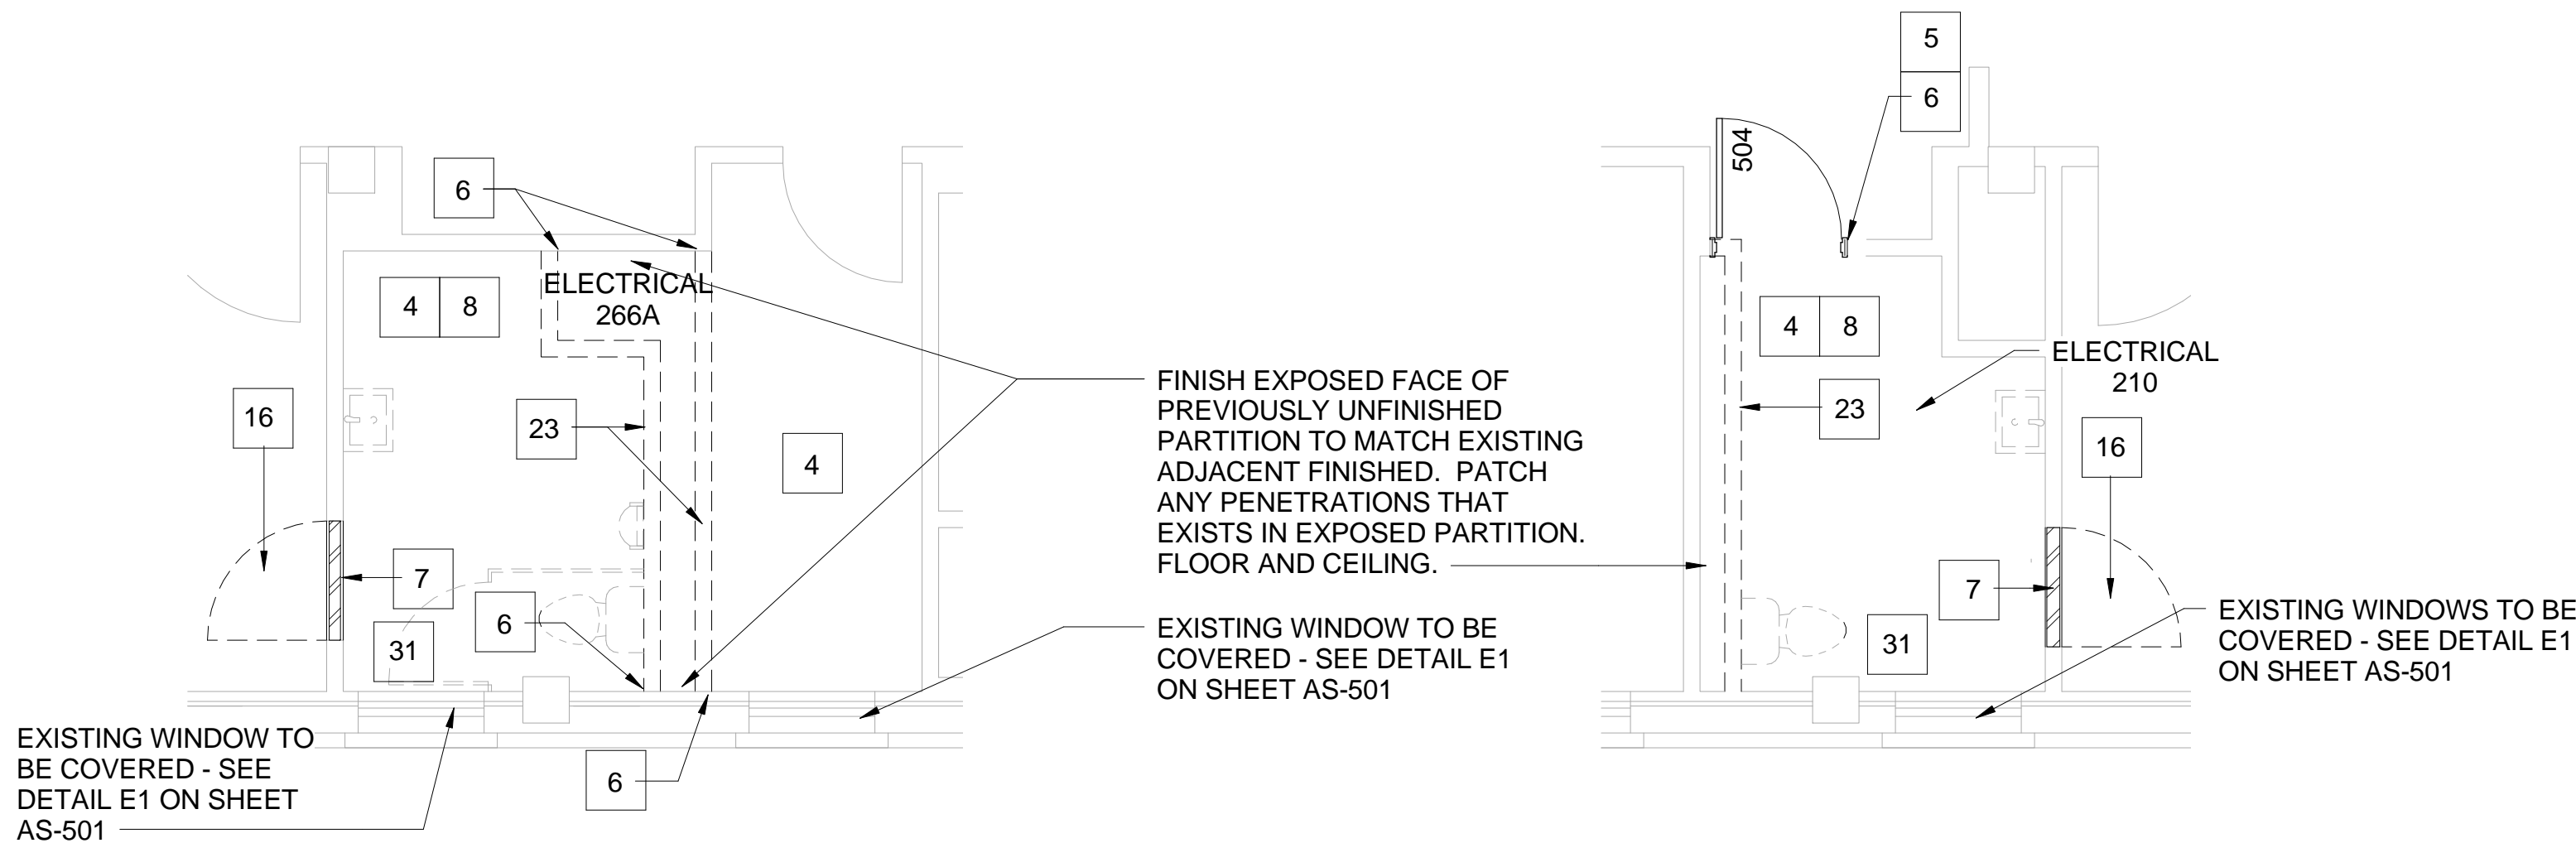
PROJECT TITLE: UPGRADE ELEC. DISTRIBUTION - PHASE 3	
SHEET TITLE: ENLARGED PLANS	
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APPROVED BY:	
BLDG # 4	CHECKED BY: DRAWN BY:

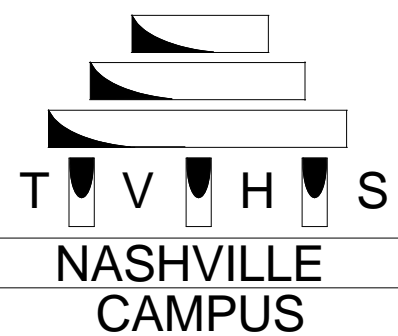DATE: OCTOBER 31, 2012
PROJECT NUMBER: 626A4-1-202
DWG # 4-AS-401 Dwg. 25 of 97

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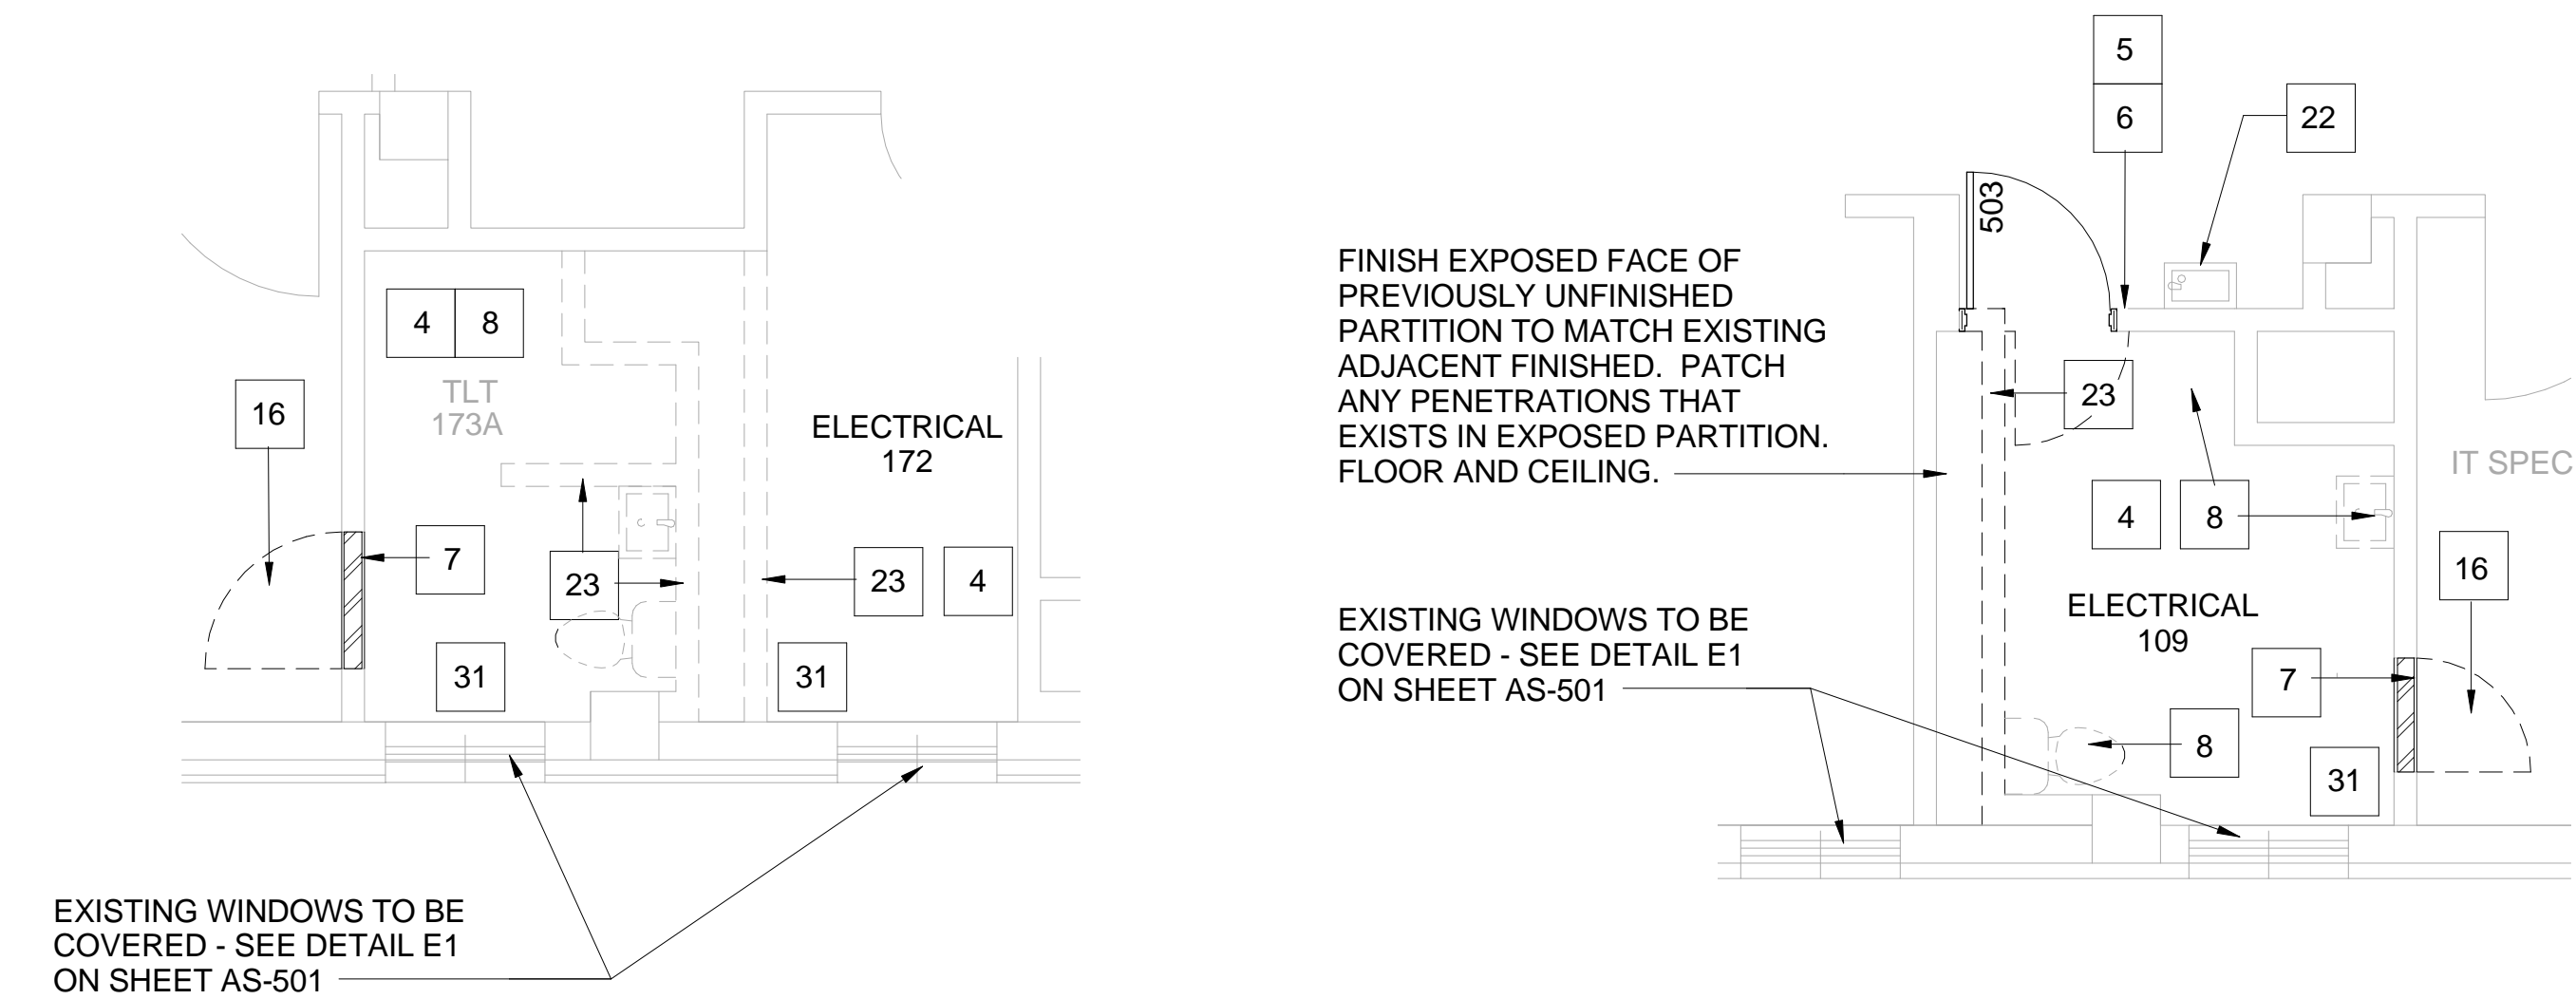
27	N/A
28	N/A
29	N/A
30	REMOVE PORTION OF EXISTING CEILING
31	UPON COMPLETION OF MECHANICAL REMOVAL AND ACM ABATEMENT, PATCH REMAINING VOID TO MATCH EXISTING ADJACENT SURFACES. SEE ACM DRAWINGS.

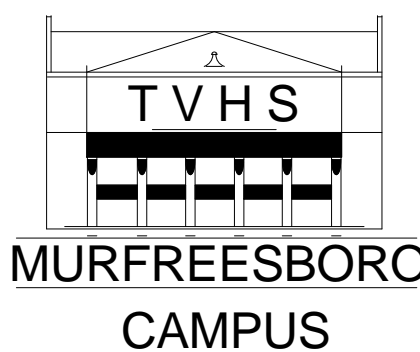KEY NOTES	
1A	N/A
1B	N/A
2	N/A
3A	N/A
3B	NEW WALL: 3 5/8" x 20GA. STL STUDS @ 1'-4" O.C. WITH 5/8" TYPE 'X' FIRE RATED GYP. BD. ON EACH FACE. WALL TO EXTEND TO DECK ABOVE AND FORM A SMOKE-TIGHT SEAL. EXTERIOR WALL FACE TO BE PAINTED (OR RECEIVE VINYL WALL COVERING) TO MATCH SURROUNDING WALLS. SEAL ALL PENETRATIONS. WALLS TO RECEIVE 3 1/2" SOUND BATT INSULATION, UNLESS OTHERWISE NOTED. REMOVE EXISTING FLOORING & CEILING AS REQ'D FOR THE INSTALLATION OF NEW PARTITION. REPLACE, PATCH AND REPAIR TO MATCH SURROUNDING CONDITIONS. NEW PARTITION TO REC'V BASE TO MATCH EXISTING.
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5	REMOVE PORTION OF EXISTING WALL AS REQ'D TO INSTALL A NEW DOOR AND FRAME AS SCHEDULED. PATCH, REPAIR & FINISH ADJACENT WALL, CEILING AND FLOORING AS NEEDED TO MATCH SURROUNDING CONDITIONS.
6	PATCH & REPAIR EXISTING WALL. FINISH TO MATCH SURROUNDING CONDITIONS.
7	IN-FILL OPENING WITH MATERIAL TO MATCH ADJACENT WALL CONSTRUCTION. FINISH TO MATCH SURROUNDING CONDITIONS, INCLUDING WALL & BASE, NEW BASE, PAINT & WALL FINISH TO EXTEND FULL WALL LENGTH. (e.g. INSIDE CORNER TO INSIDE CORNER) PATCH ADJACENT CEILING.
8	DEMO. TOILET PARTITIONS & PLUMBING FIXTURES. PATCH WALLS & FLOOR TO MATCH EXISTING ADJACENT SURFACES. COORDINATE WITH PLUMBING. REMOVALS SHALL INCLUDE MISC. TOILET ACCESSORIES & TOILET PARTITIONS AS APPROPRIATE.
9	N/A
10	EXISTING F.D. CONNECTION TO REMAIN.
11	IN-FILL AT EXISTING LOUVER (OR WINDOW - SEE DETAIL E2 / A501.
12	NEW CHASE WALL: 3 5/8" x 20GA. STL STUDS @ 1'-4" O.C. WITH 2 LAYERS 5/8" TYPE 'X' FIRE RATED GYP. BD. ON EXTERIOR FACE. FINISH TO MATCH EXISTING (BASE & WALL FINISH)
13	N/A
14	N/A
15	N/A
16	REMOVE EXISTING DOOR AND FRAME.
17	N/A
18	N/A
19	REMOVE EXISTING CEILING AND EXPOSE TO STRUCT.
20	N/A
21	N/A
22	EXISTING E.W.C. TO REMAIN. GC TO PROTECT UNIT DURING CONSTRUCTION IN THIS AREA.
23	DEMO. EXISTING WALL, PATCH AND REPAIR CEILING AND FLOORING TO MATCH SURROUNDING CONDITIONS.
24	NEW 4" CMU WALL TO DECK ABOVE. FINISH TO MATCH EXISTING SURROUNDING CONDITIONS. FIELD VERIFY ALL DIMENSIONS.
25	CAREFULLY REMOVE EXISTING EYEWASH & SHOWER TO BE RELOCATED AS NOTED ELSEWHERE.
26	SAW CUT & REMOVE PORTION OF 6" RAISED CONCRETE FLOORING AS REQ'D FOR THE INSTALLATION OF NEW DOOR AND FRAME AS SCHEDULED. PATCH & REPAIR FLOOR SYSTEM TO ACHIEVE A SMOOTH FINISH TO MATCH SURROUNDING CONDITIONS.



C3 PARTIAL PLAN BLDG. #5 - 265 / 266A
1/4" = 1'-0"


D3 PARTIAL PLAN BLDG. #5 - 210
1/4" = 1'-0"



A2 PARTIAL PLAN BLDG. #5 - 172 / 173A
1/4" = 1'-0"

B2 PARTIAL PLAN BLDG. #5 - TLT 109
1/4" = 1'-0"


C2 THIS DETAIL OMITTED
1/4" = 1'-0"

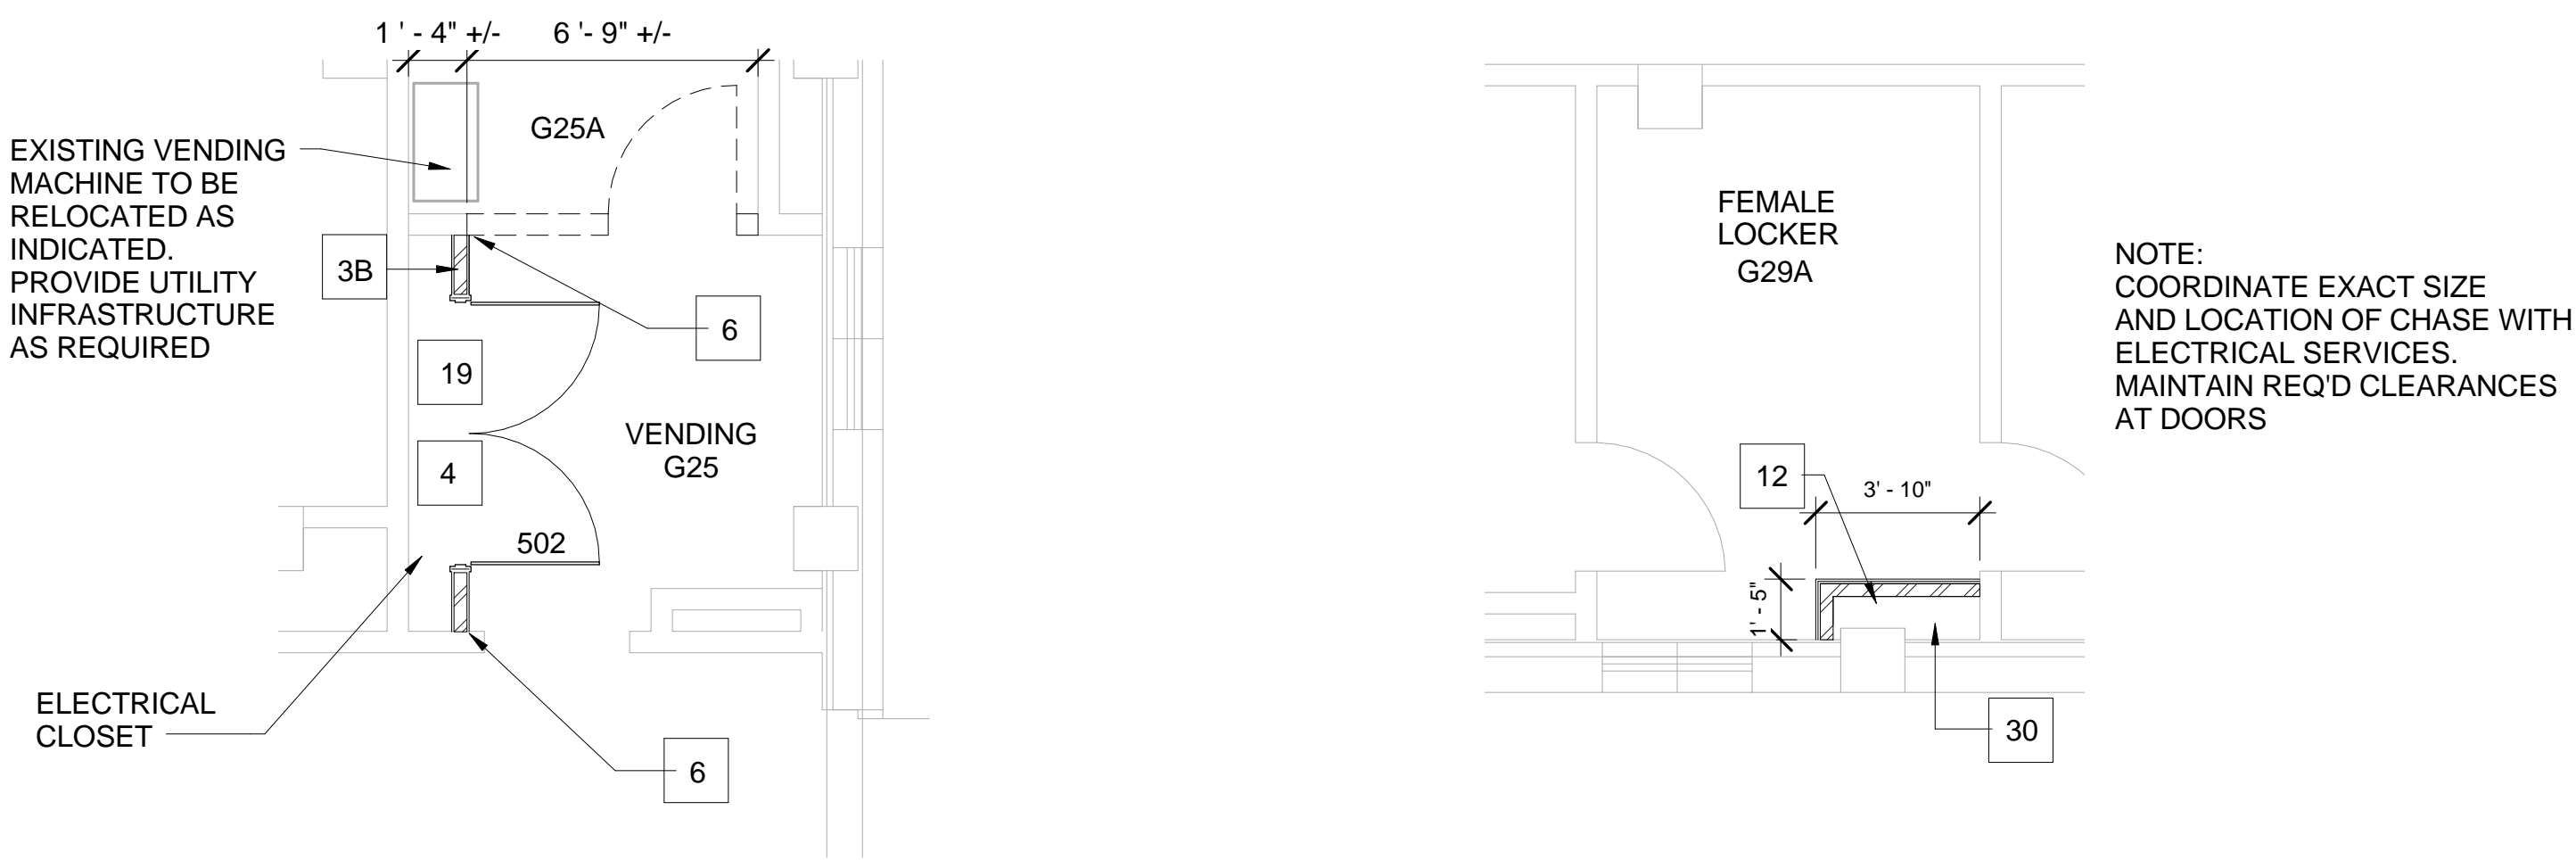

A1 PARTIAL PLAN BLDG. #5 - VENDING
1/4" = 1'-0"

B1 PARTIAL PLAN BLDG. #5 - G29A
1/4" = 1'-0"

C1 PARITAL PLAN - BLDG. #5 LAB G03A
1/4" = 1'-0"

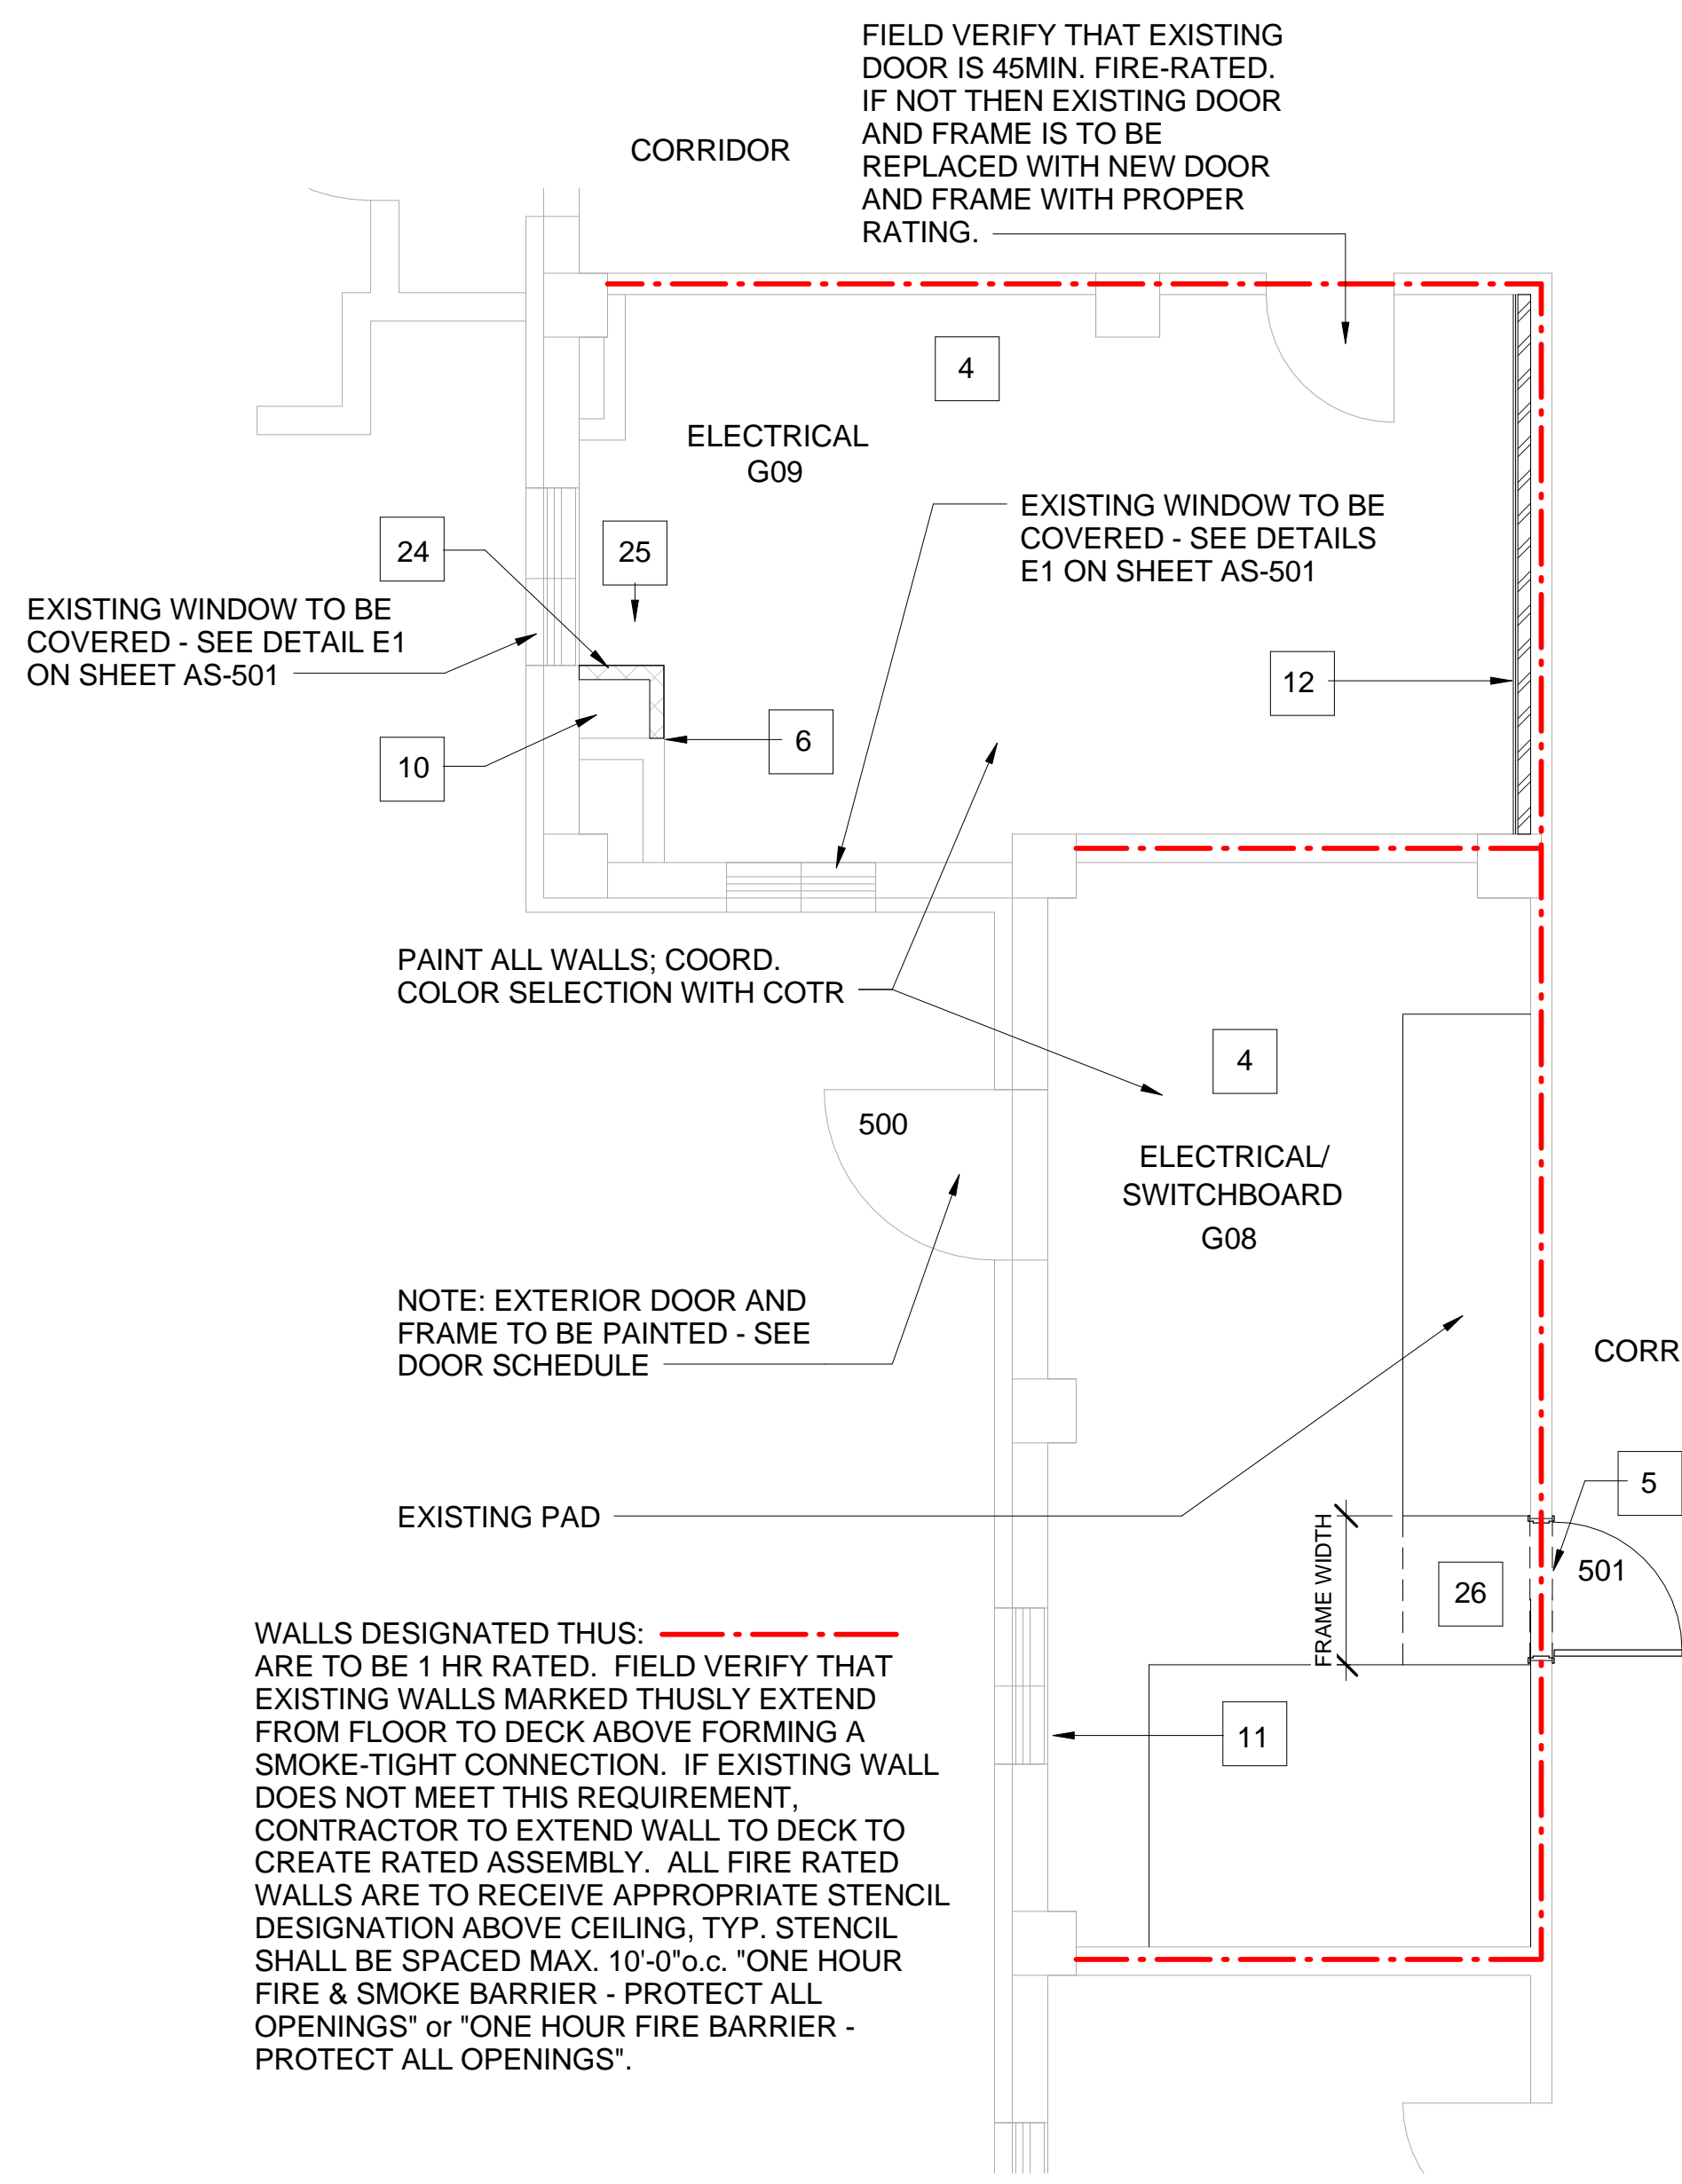


D1 PARTIAL PLAN - BLDG. #5 G08 / G09
1/4" = 1'-0"



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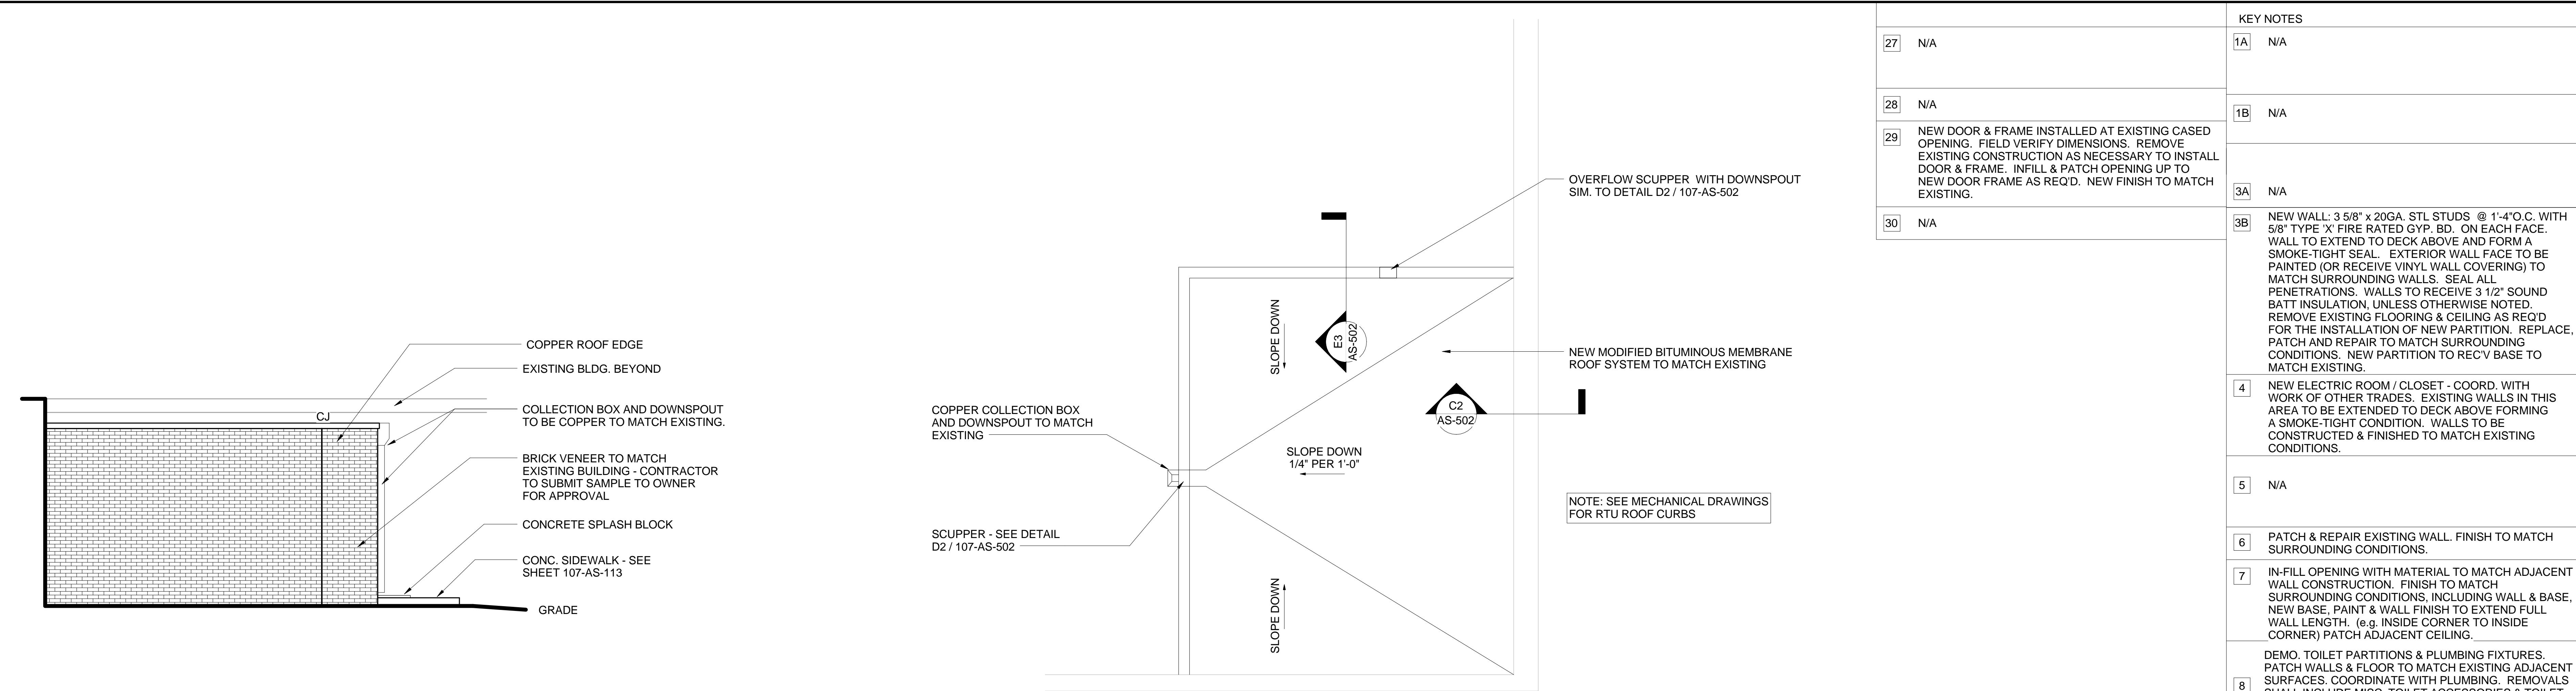


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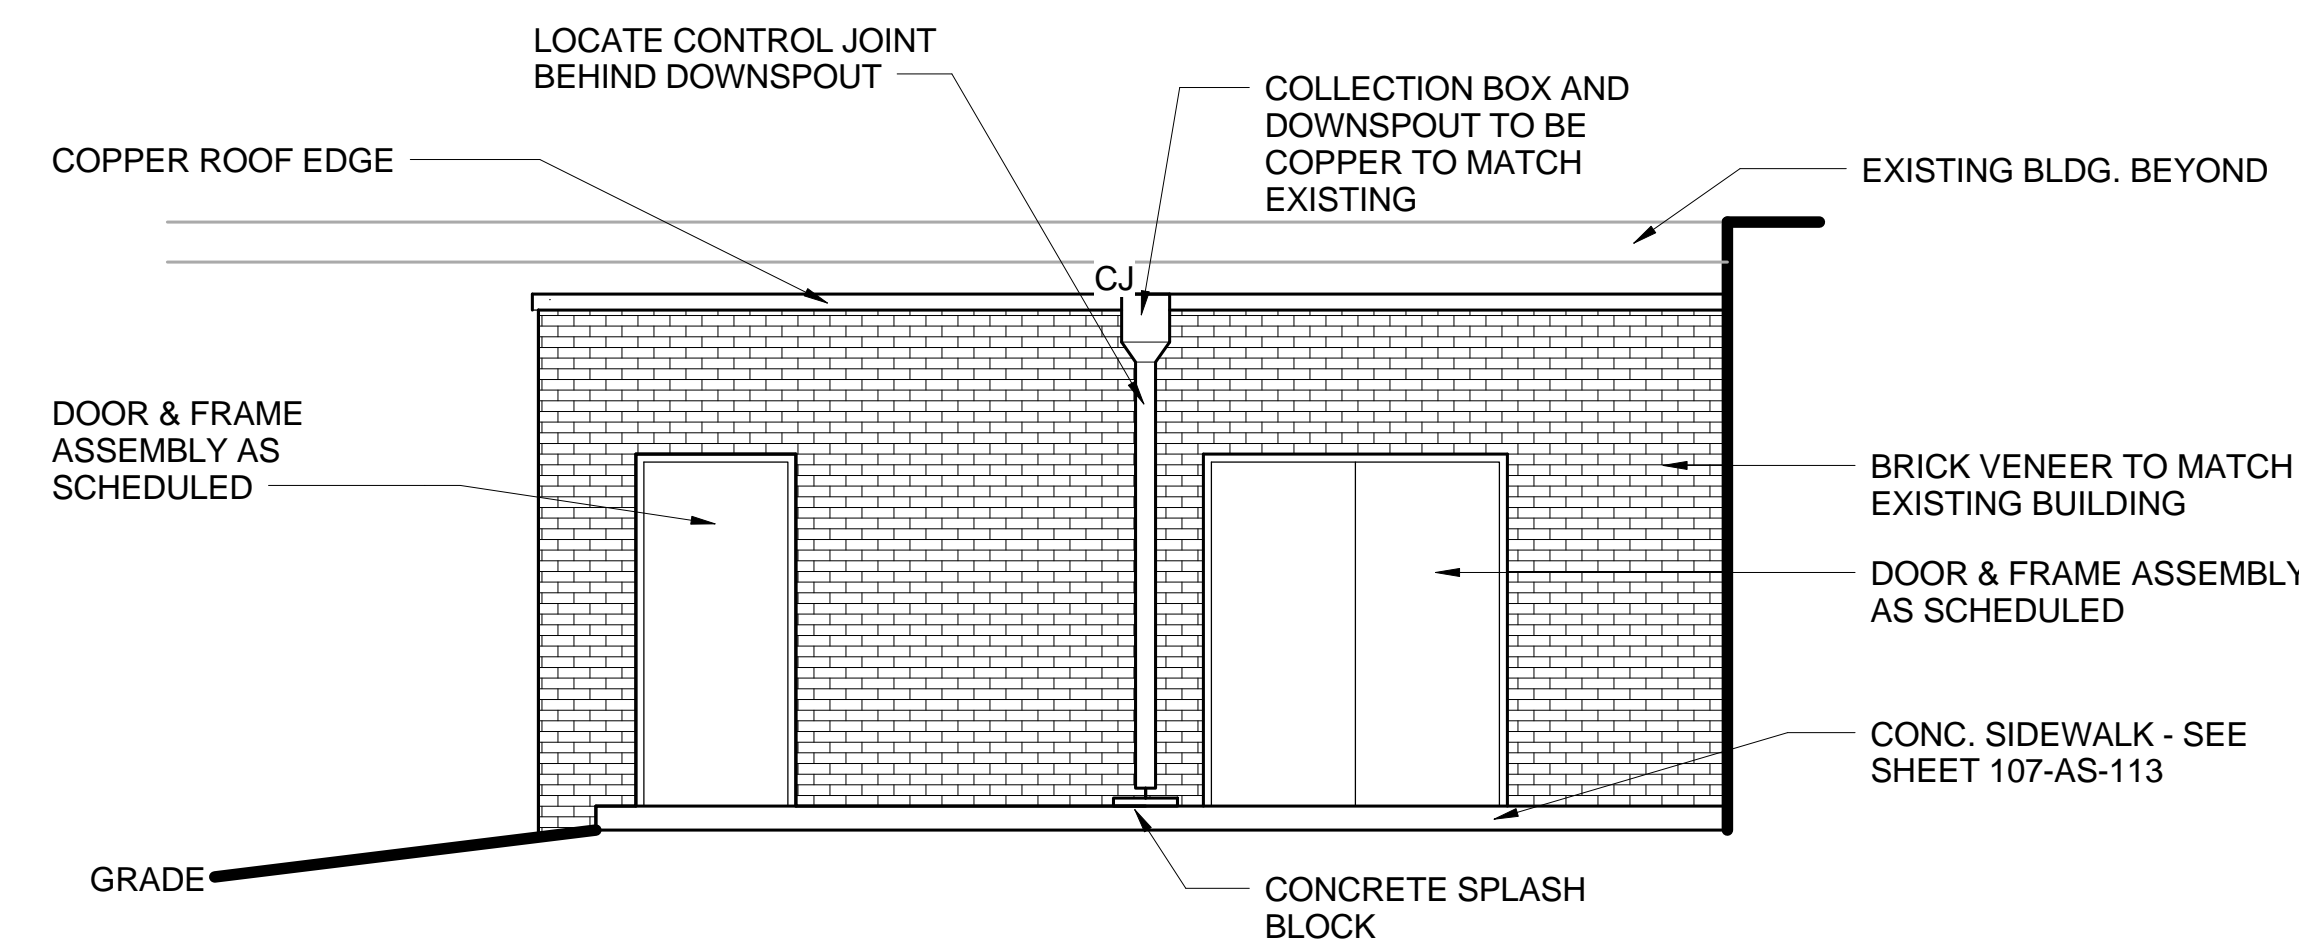


PROJECT TITLE: UPGRADE ELEC. DISTRIBUTION - PHASE 3	DATE: OCTOBER 31, 2012
SHEET TITLE: ENLARGED PLANS	PROJECT NUMBER: 626A4-1-202
APPROVED BY:	DWG # 5-AS-402
APPROVED BY:	Dwg. 26 of 97
BLDG # 5	CHECKED BY:
	DRAWN BY:

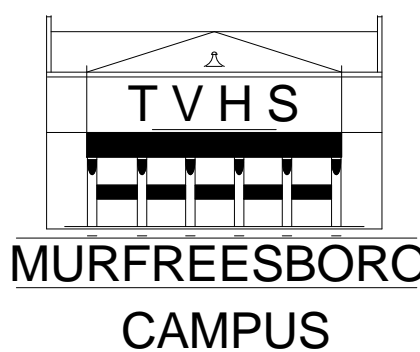
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A3 ELECTRIC ROOM ADDITION - BLDG. #107
SHORT ELEVATION
1/4" = 1'-0"




A2 ELECTRIC ROOM ADDITION - BLDG. #107
LONG ELEVATION
1/4" = 1'-0"




A1 PARTIAL PLAN BLDG. #107 - 101A
1/4" = 1'-0"

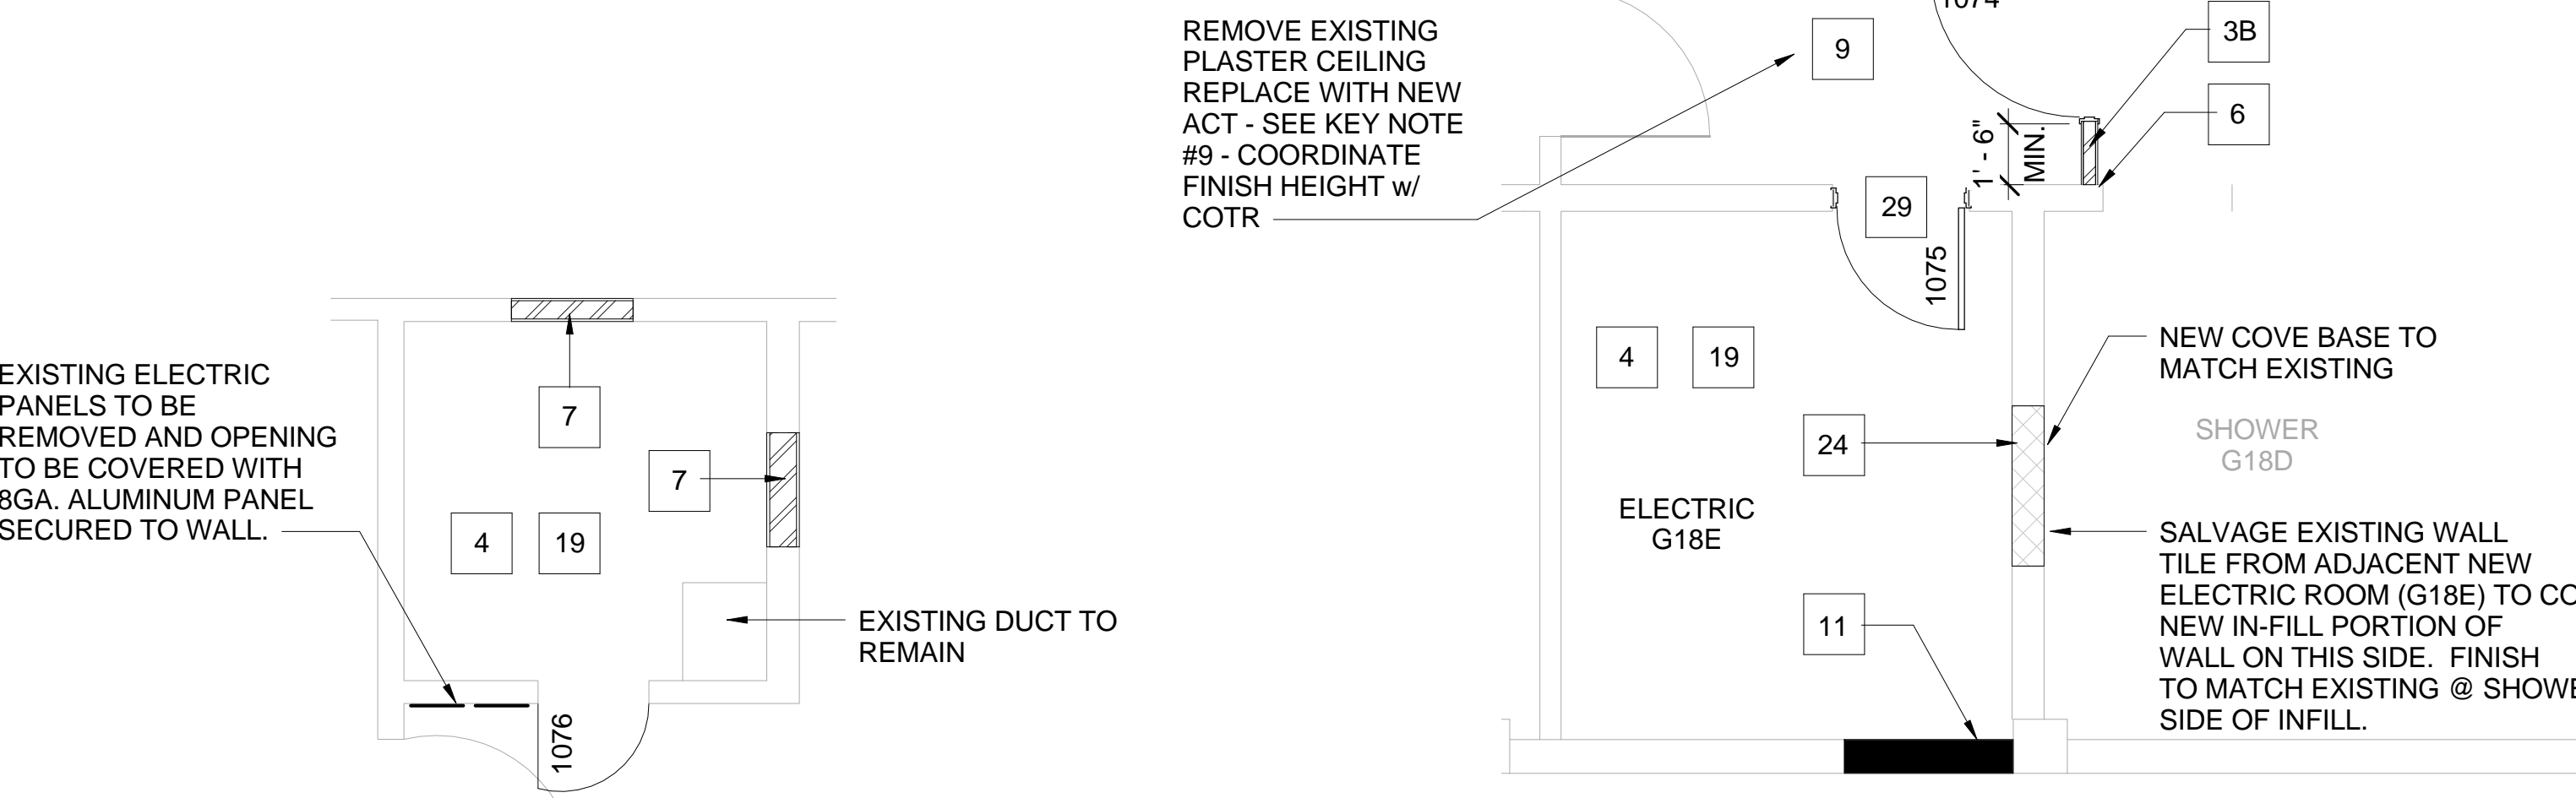
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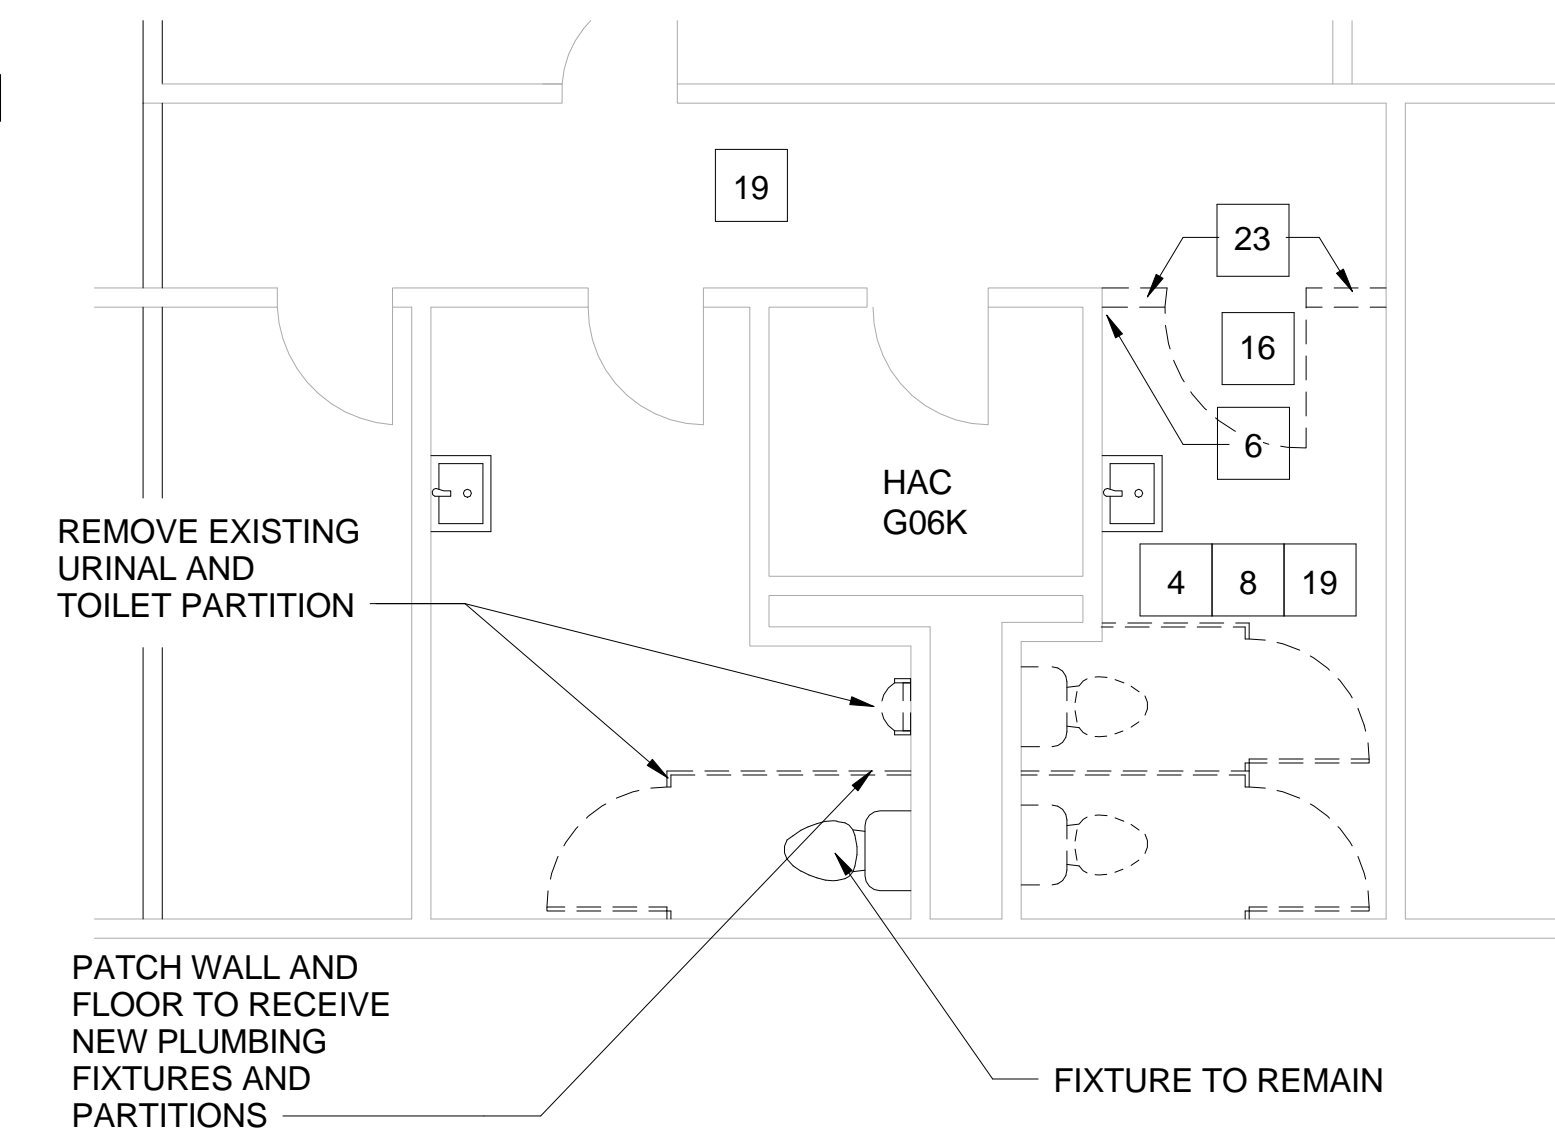
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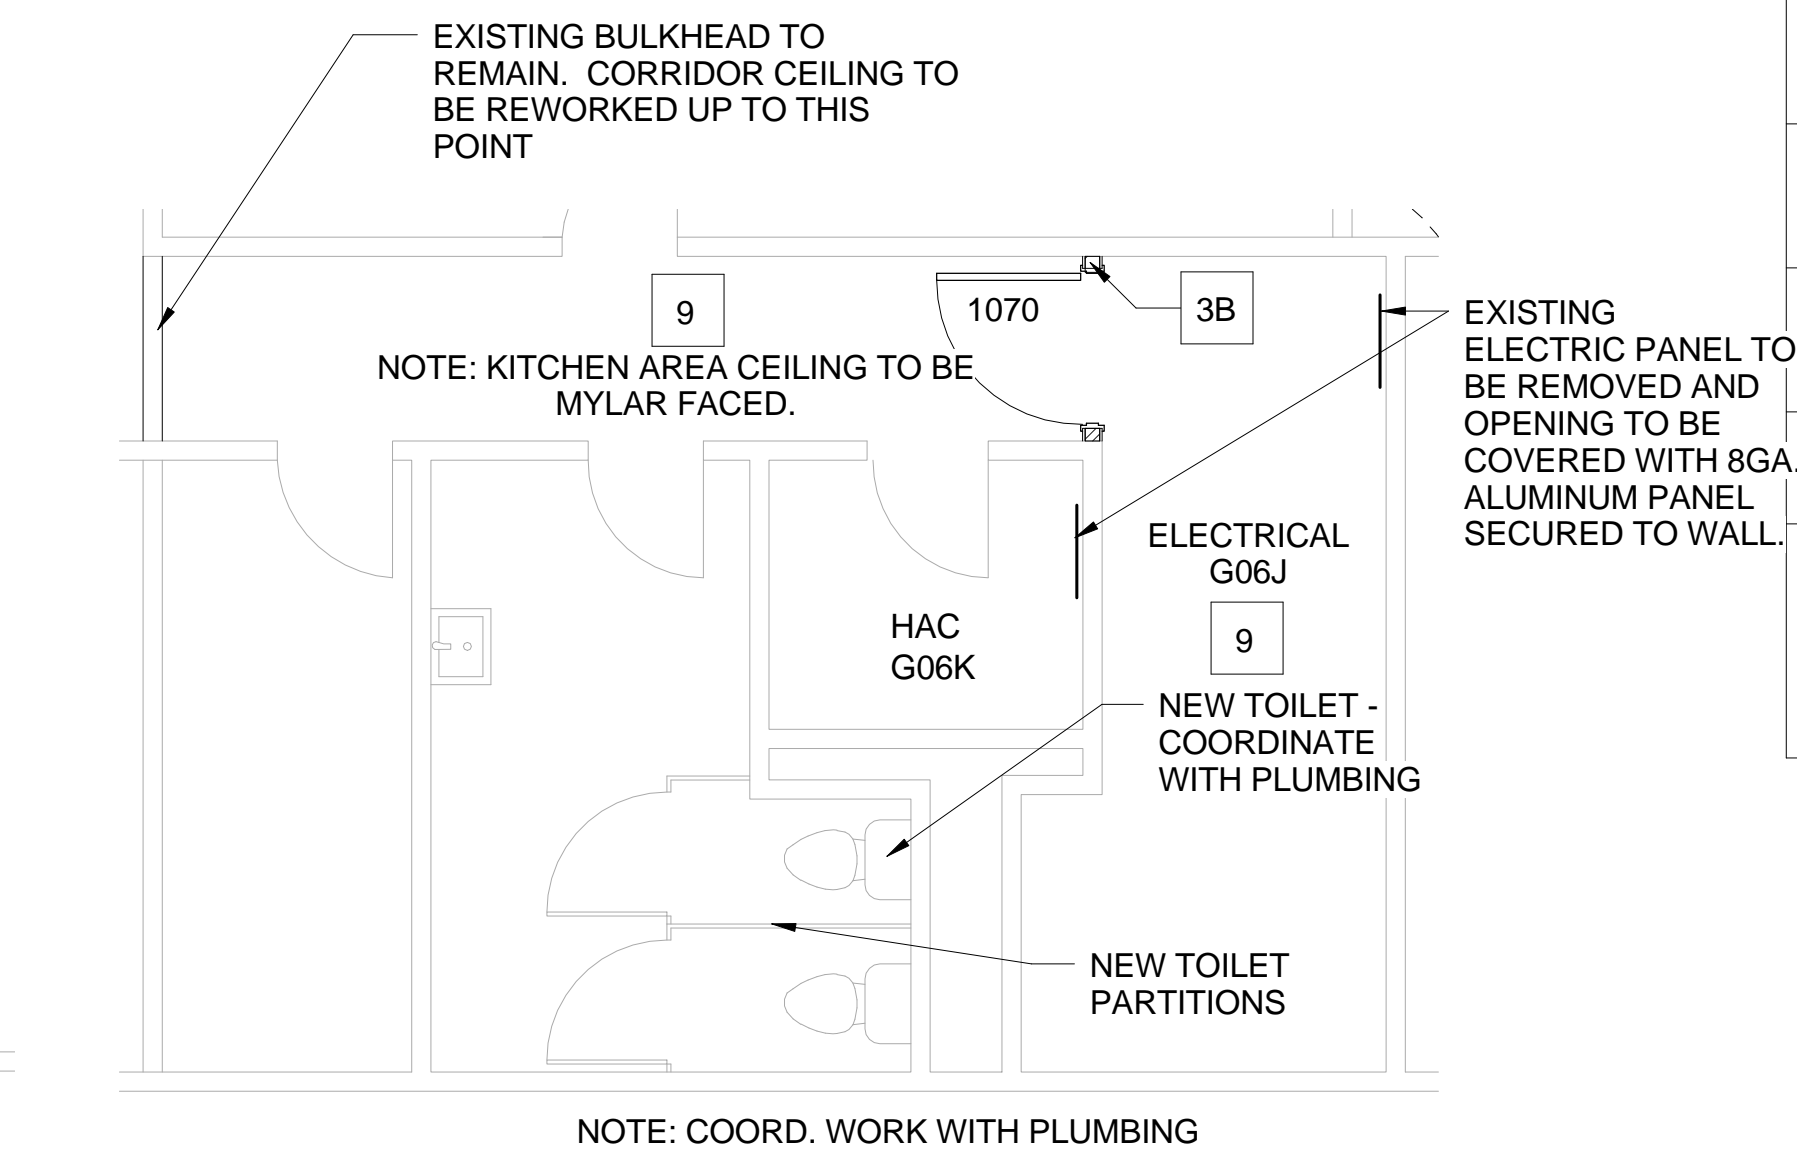
C3 ELECTRIC ROOM ADDITION - ROOF PLAN
1/4" = 1'-0"

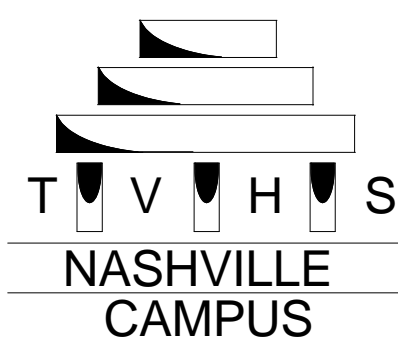

C1 ELECTRIC ROOM ADDITION - BLDG. #107
1/4" = 1'-0"

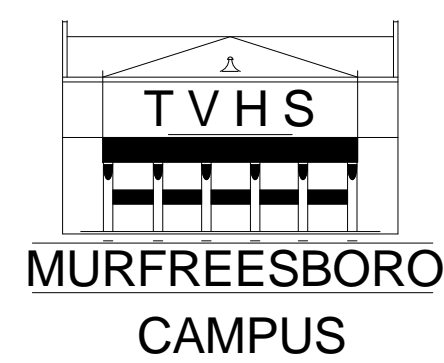

D2 PARTIAL PLAN BLDG. #107 - G06J (DEMO.)
1/4" = 1'-0"

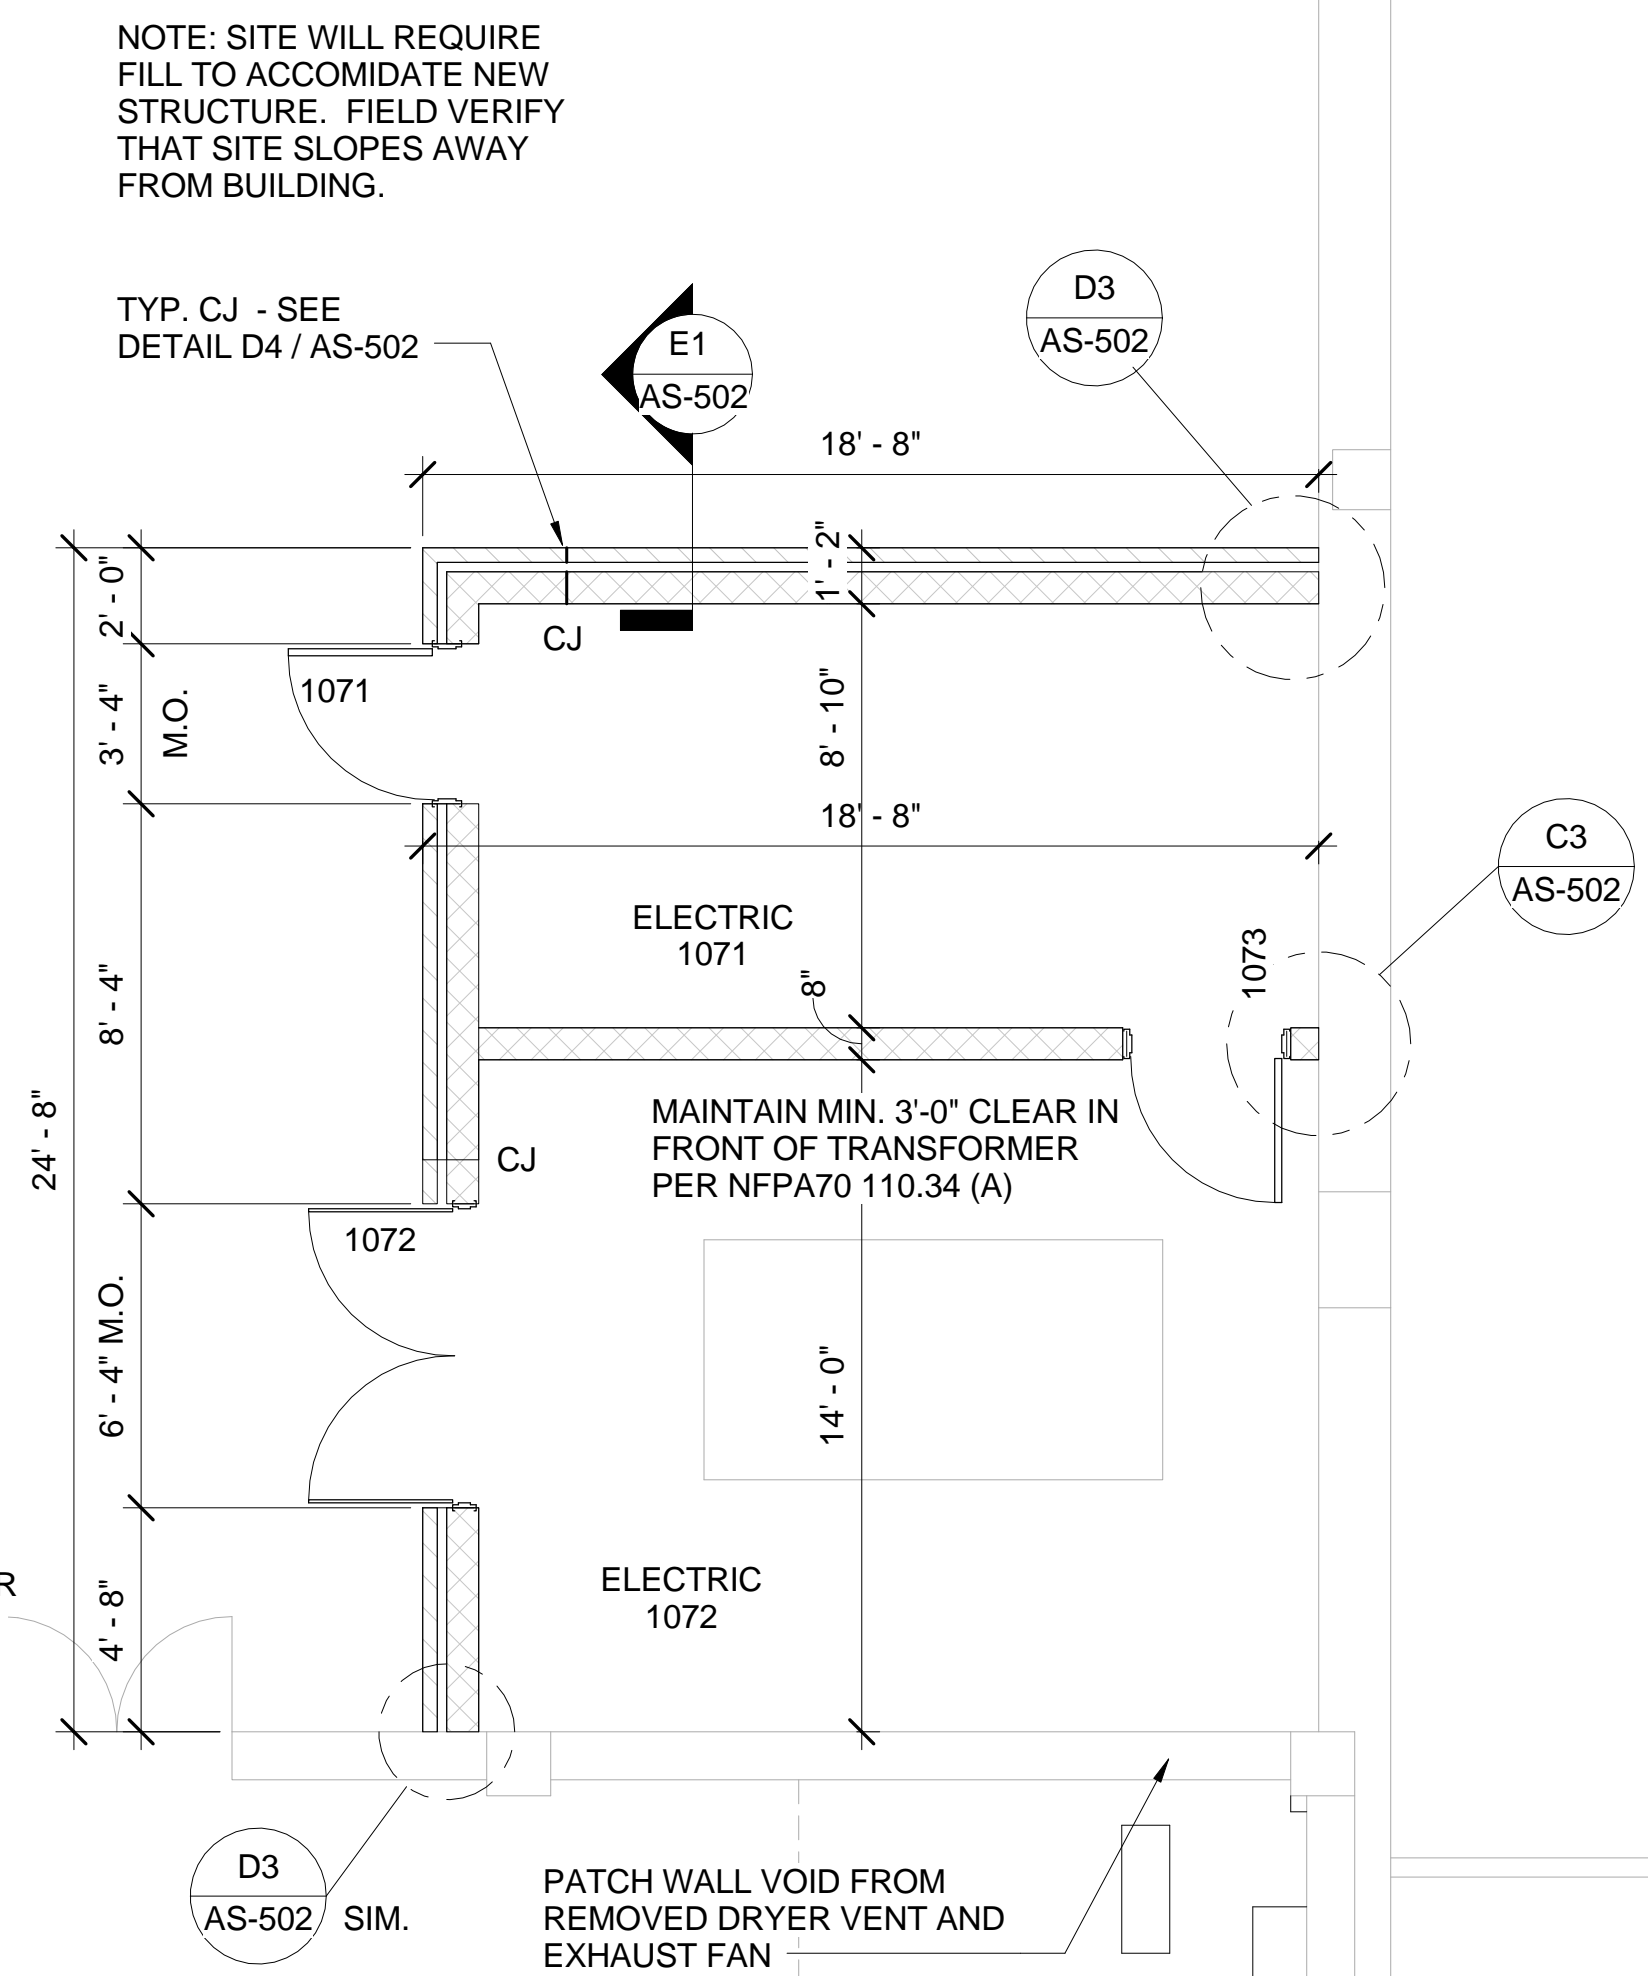

D1 PARTIAL PLAN BLDG. #107 - G06J
1/4" = 1'-0"

27	N/A
28	N/A
29	NEW DOOR & FRAME INSTALLED AT EXISTING CASED OPENING. FIELD VERIFY DIMENSIONS. REMOVE EXISTING CONSTRUCTION AS NECESSARY TO INSTALL DOOR & FRAME. INFILL & PATCH OPENING UP TO NEW DOOR FRAME AS REQ'D. NEW FINISH TO MATCH EXISTING.
30	N/A

KEY NOTES	
1A	N/A
1B	N/A
3A	N/A
3B	NEW WALL: 3 5/8" x 20GA. STL STUDS @ 1'-4" O.C. WITH 5/8" TYPE 'X' FIRE RATED GYP. BD. ON EACH FACE. WALL TO EXTEND TO DECK ABOVE AND FORM A SMOKE-TIGHT SEAL. EXTERIOR WALL FACE TO BE PAINTED (OR RECEIVE VINYL WALL COVERING) TO MATCH SURROUNDING WALLS. SEAL ALL PENETRATIONS. WALLS TO RECEIVE 3 1/2" SOUND BATT INSULATION, UNLESS OTHERWISE NOTED. REMOVE EXISTING FLOORING & CEILING AS REQ'D FOR THE INSTALLATION OF NEW PARTITION. REPLACE, PATCH AND REPAIR TO MATCH SURROUNDING CONDITIONS. NEW PARTITION TO REC'V BASE TO MATCH EXISTING.
4	NEW ELECTRIC ROOM / CLOSET - COORD. WITH WORK OF OTHER TRADES. EXISTING WALLS IN THIS AREA TO BE EXTENDED TO DECK ABOVE FORMING A SMOKE-TIGHT CONDITION. WALLS TO BE CONSTRUCTED & FINISHED TO MATCH EXISTING CONDITIONS.
5	N/A
6	PATCH & REPAIR EXISTING WALL. FINISH TO MATCH SURROUNDING CONDITIONS.
7	IN-FILL OPENING WITH MATERIAL TO MATCH ADJACENT WALL CONSTRUCTION. FINISH TO MATCH SURROUNDING CONDITIONS, INCLUDING WALL & BASE, NEW BASE, PAINT & WALL FINISH TO EXTEND FULL WALL LENGTH. (e.g. INSIDE CORNER TO INSIDE CORNER) PATCH ADJACENT CEILING.
8	DEMO. TOILET PARTITIONS & PLUMBING FIXTURES. PATCH WALLS & FLOOR TO MATCH EXISTING ADJACENT SURFACES. COORDINATE WITH PLUMBING. REMOVALS SHALL INCLUDE MISC. TOILET ACCESSORIES & TOILET PARTITIONS AS APPROPRIATE.
9	REMOVE EXISTING CEILING. REPLACE WITH NEW SUSPD 2x4 GRID WITH ACOUSTICAL CLG. TILE. COORD. WITH OTHER TRADES. ELECTRIC ROOMS ARE TO BE EXPOSED TO STRUCT. ABOVE (EXCLUDING BUILDING 107)
10	N/A
11	IN-FILL AT EXISTING LOUVER (OR WINDOW - SEE DETAILS E1 or E2 / A501.
12	N/A
13	N/A
14	N/A
15	N/A
16	REMOVE EXISTING DOOR AND FRAME.
17	N/A
18	N/A
19	REMOVE EXISTING CEILING AND EXPOSE TO STRUCT.
20	N/A
21	N/A
22	N/A
23	DEMO. EXISTING WALL, PATCH AND REPAIR CEILING AND FLOORING TO MATCH SURROUNDING CONDITIONS. (EXCEPT ROOM G06J)
24	NEW 4" CMU WALL TO DECK ABOVE. FINISH TO MATCH EXISTING SURROUNDING CONDITIONS. FIELD VERIFY ALL DIMENSIONS.
25	N/A
26	N/A



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GHP PROJECT #: 09040.01

PROJECT TITLE:
UPGRADE ELEC. DISTRIBUTION - PHASE 3

SHEET TITLE: **ENLARGED PLANS**

APPROVED BY:

APPROVED BY:

BLDG # **107**

CHECKED BY:

DRAWN BY:


DATE:
OCTOBER 31, 2012

PROJECT NUMBER:
626A4-1-202


DWG #
107-AS-404
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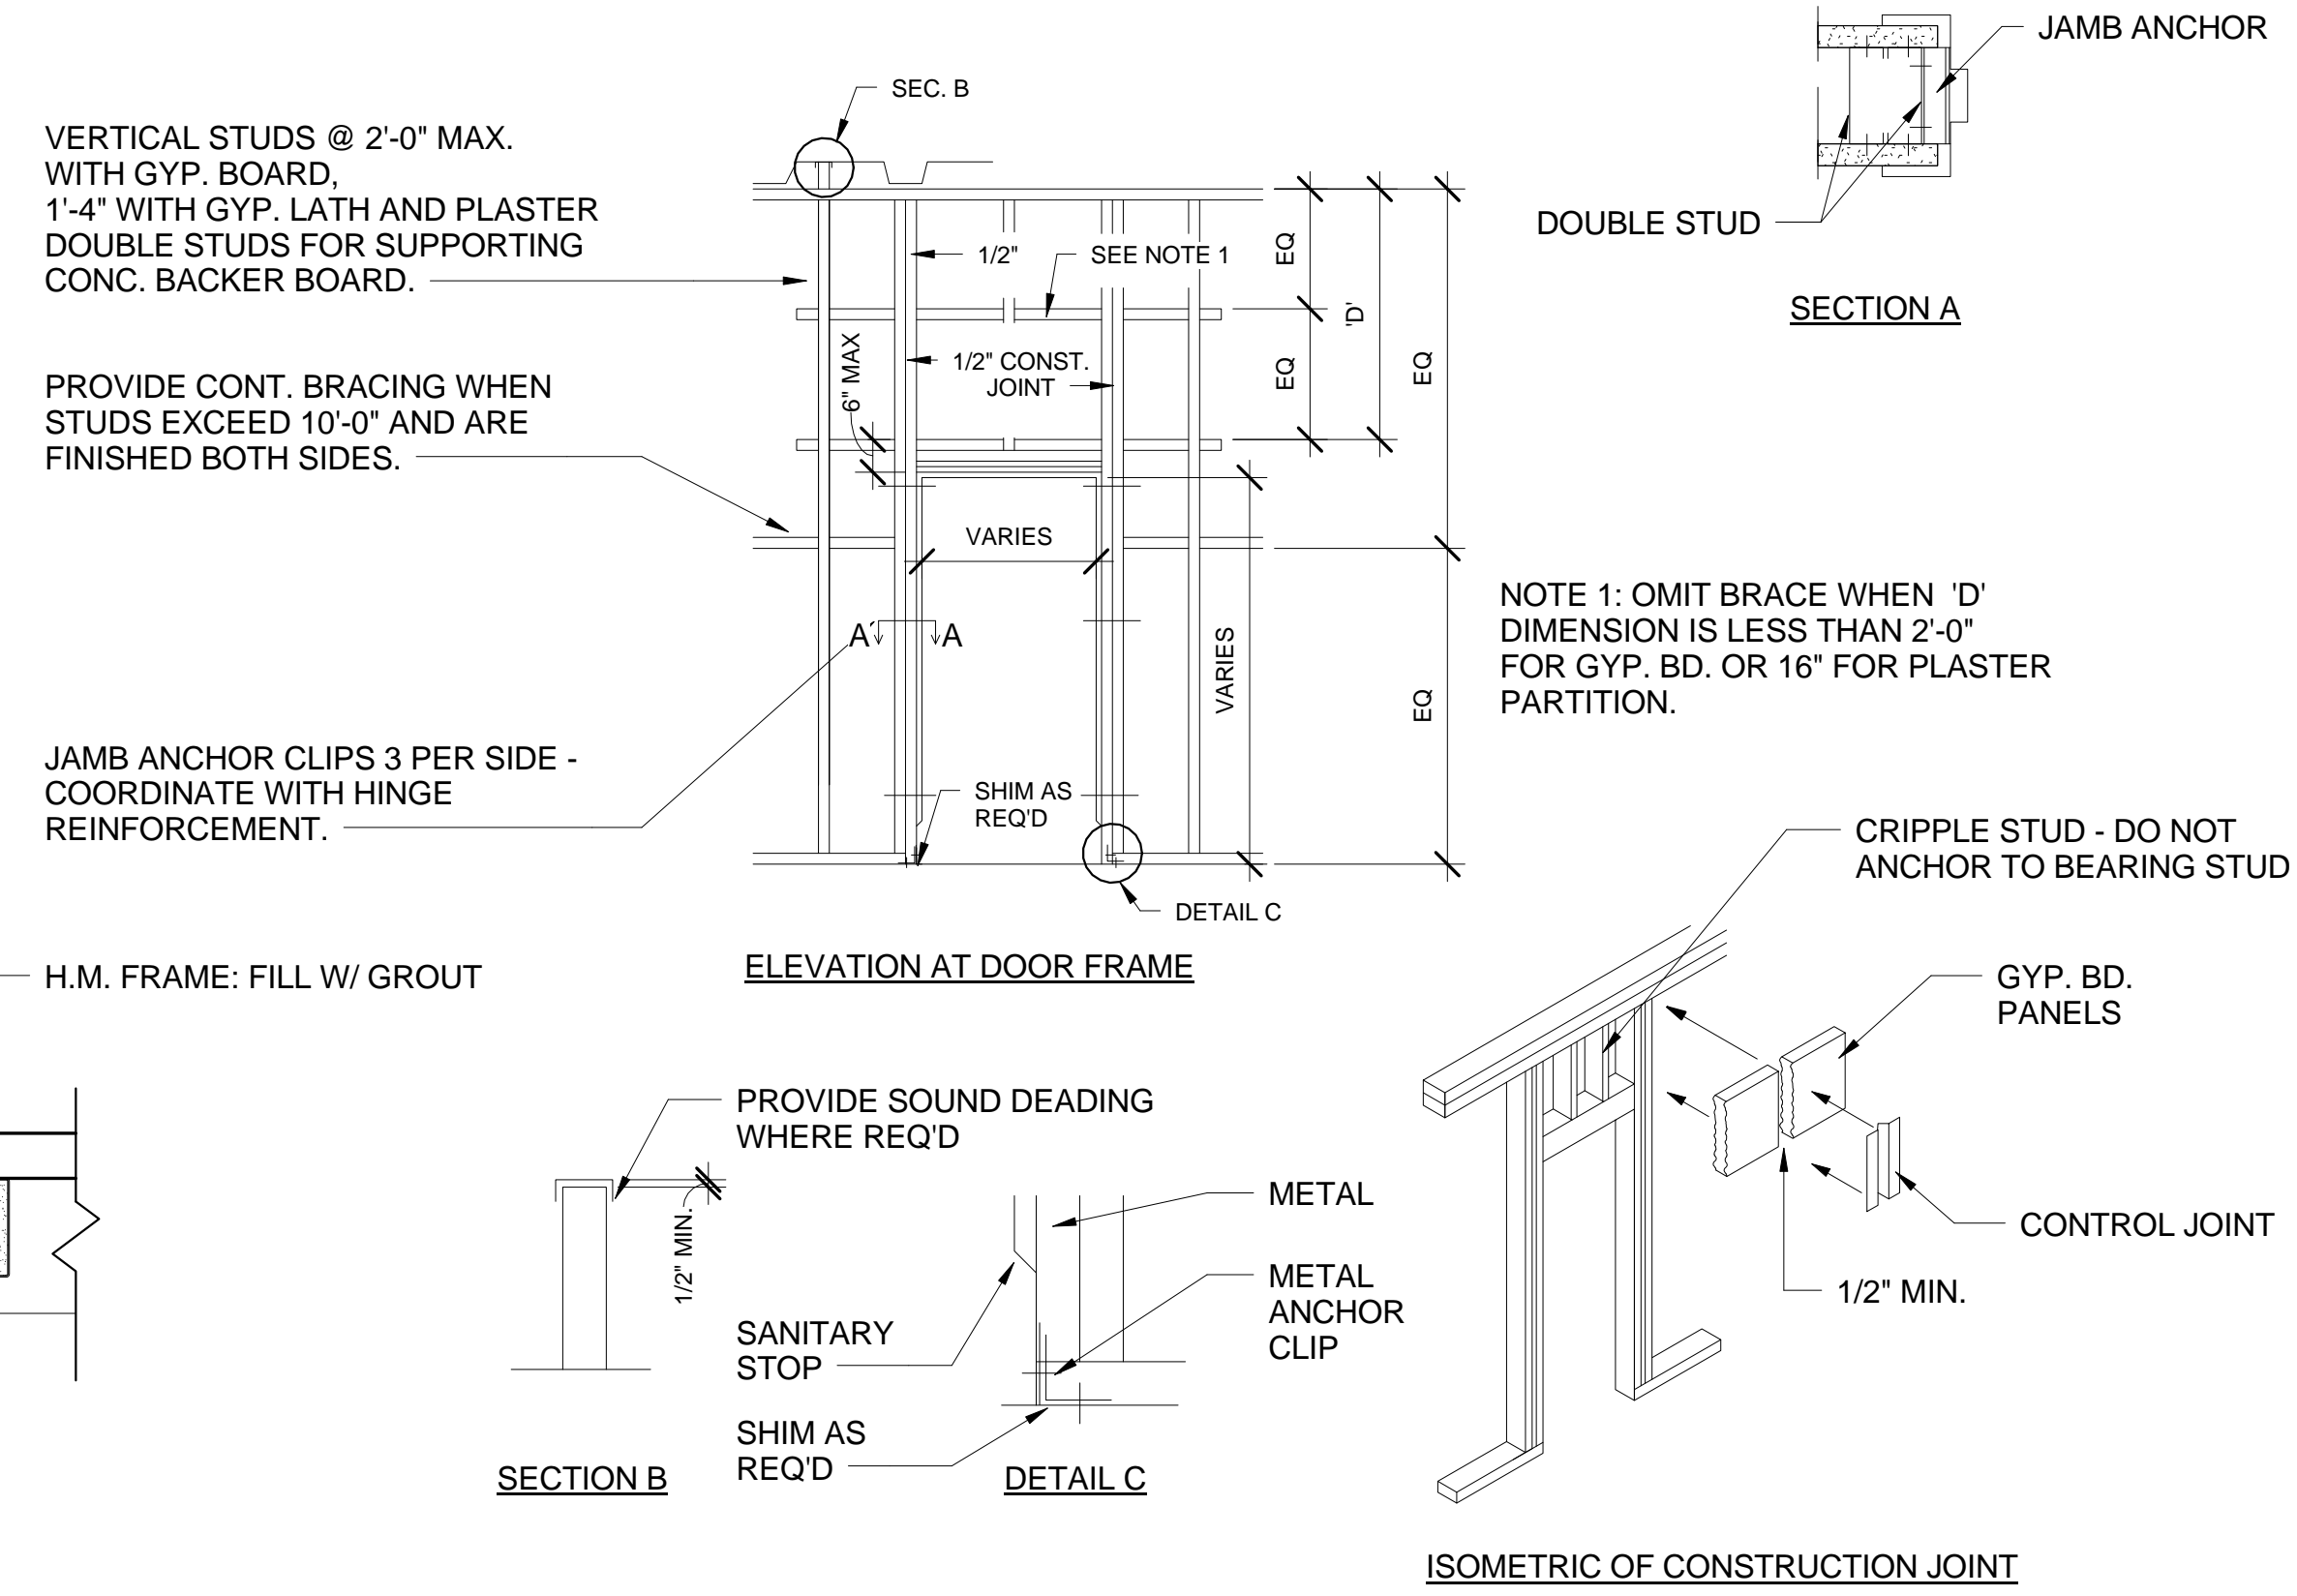
NOTE:
ALL EXTERIOR HOLLOW-METAL DOOR FRAMES TO RECEIVE BACK COATING INSIDE THE FRAMES WITH BITUMINOUS WATER RESISTANT PAINT.




C3 8" CMU DOOR HEAD
1 1/2" = 1'-0"

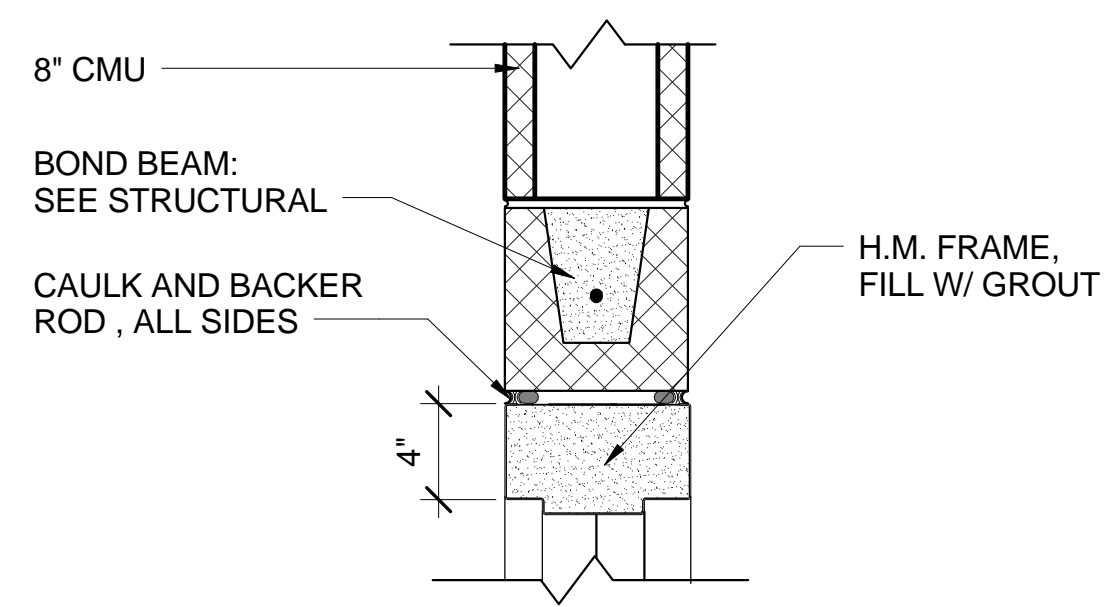


D3 8" CMU DOOR JAMB
1 1/2" = 1'-0"

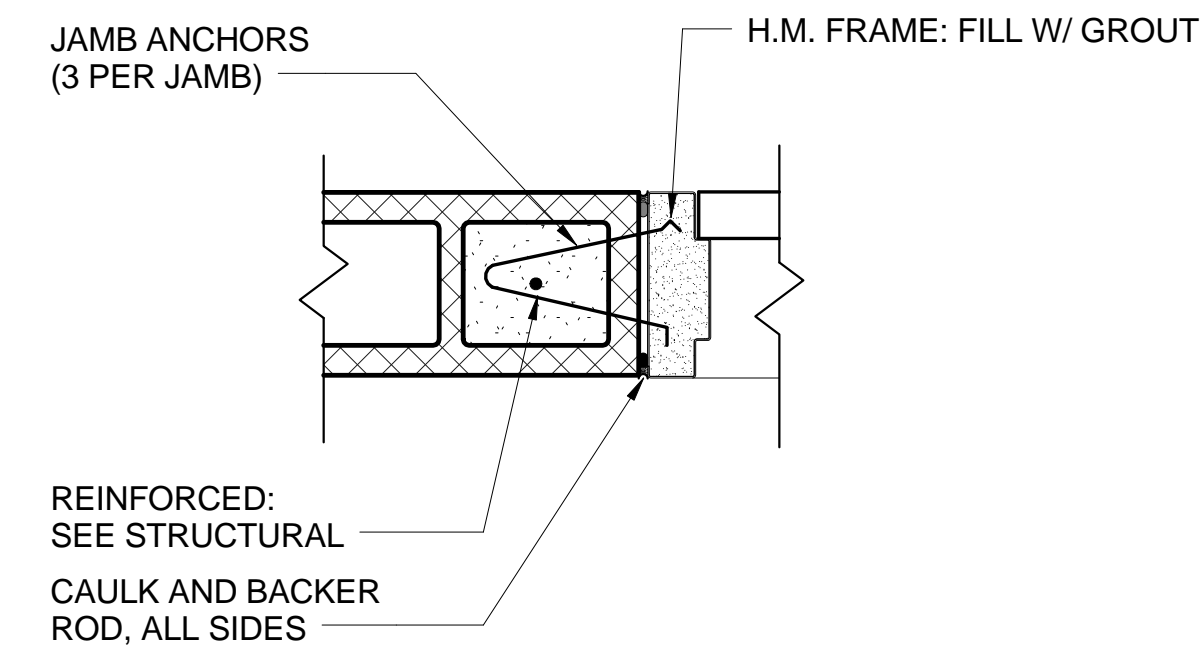


E3 TYP. DOOR FRAMING
NOT TO SCALE

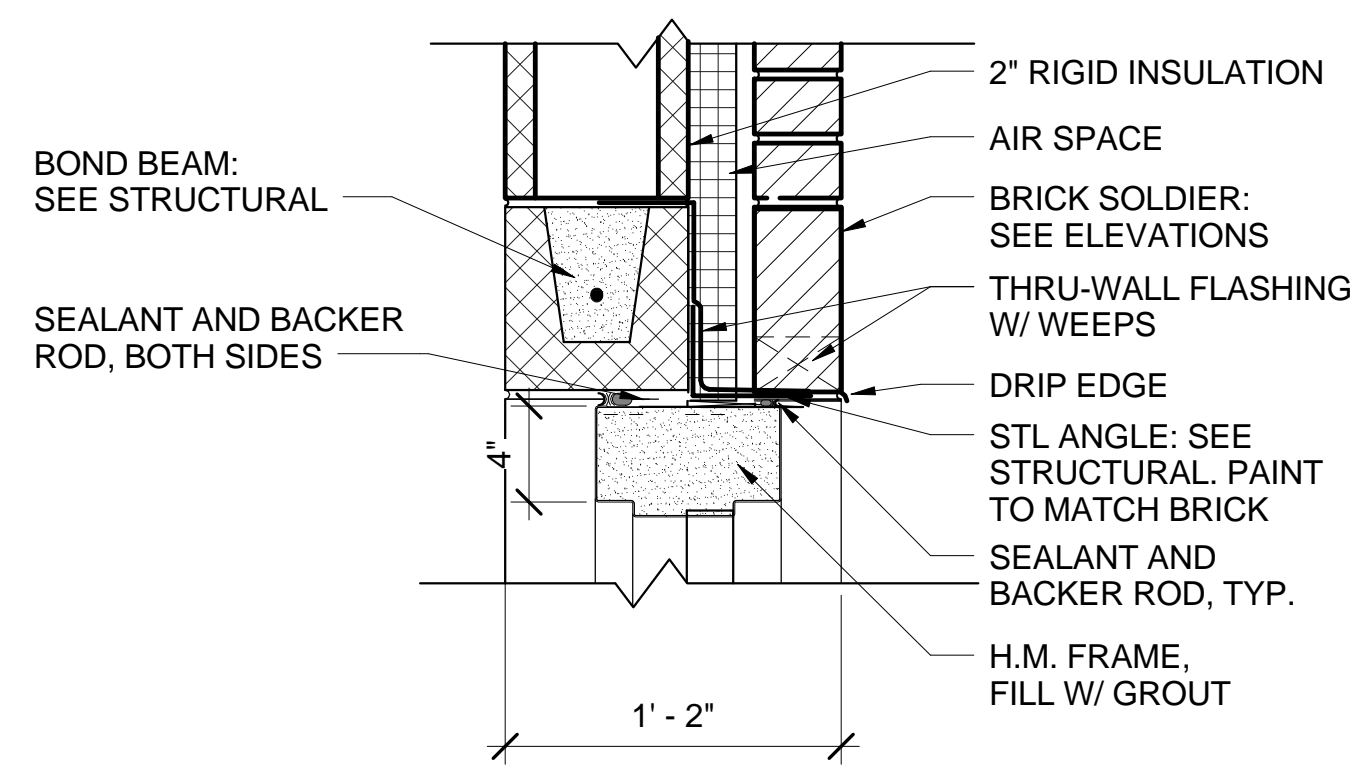


C2 EXT. DOOR HEAD
1 1/2" = 1'-0"

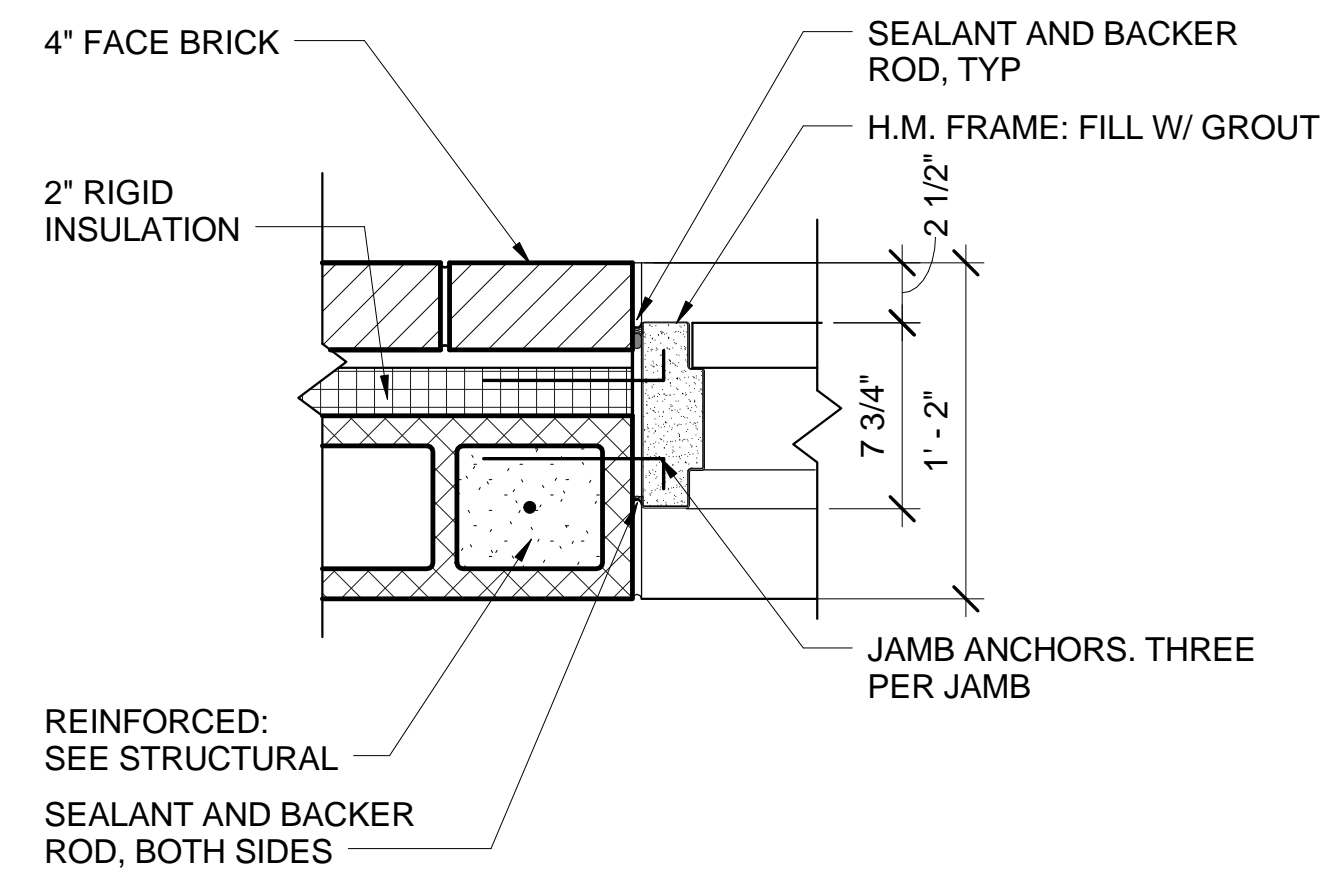


D2 EXT. DOOR JAMB
1 1/2" = 1'-0"

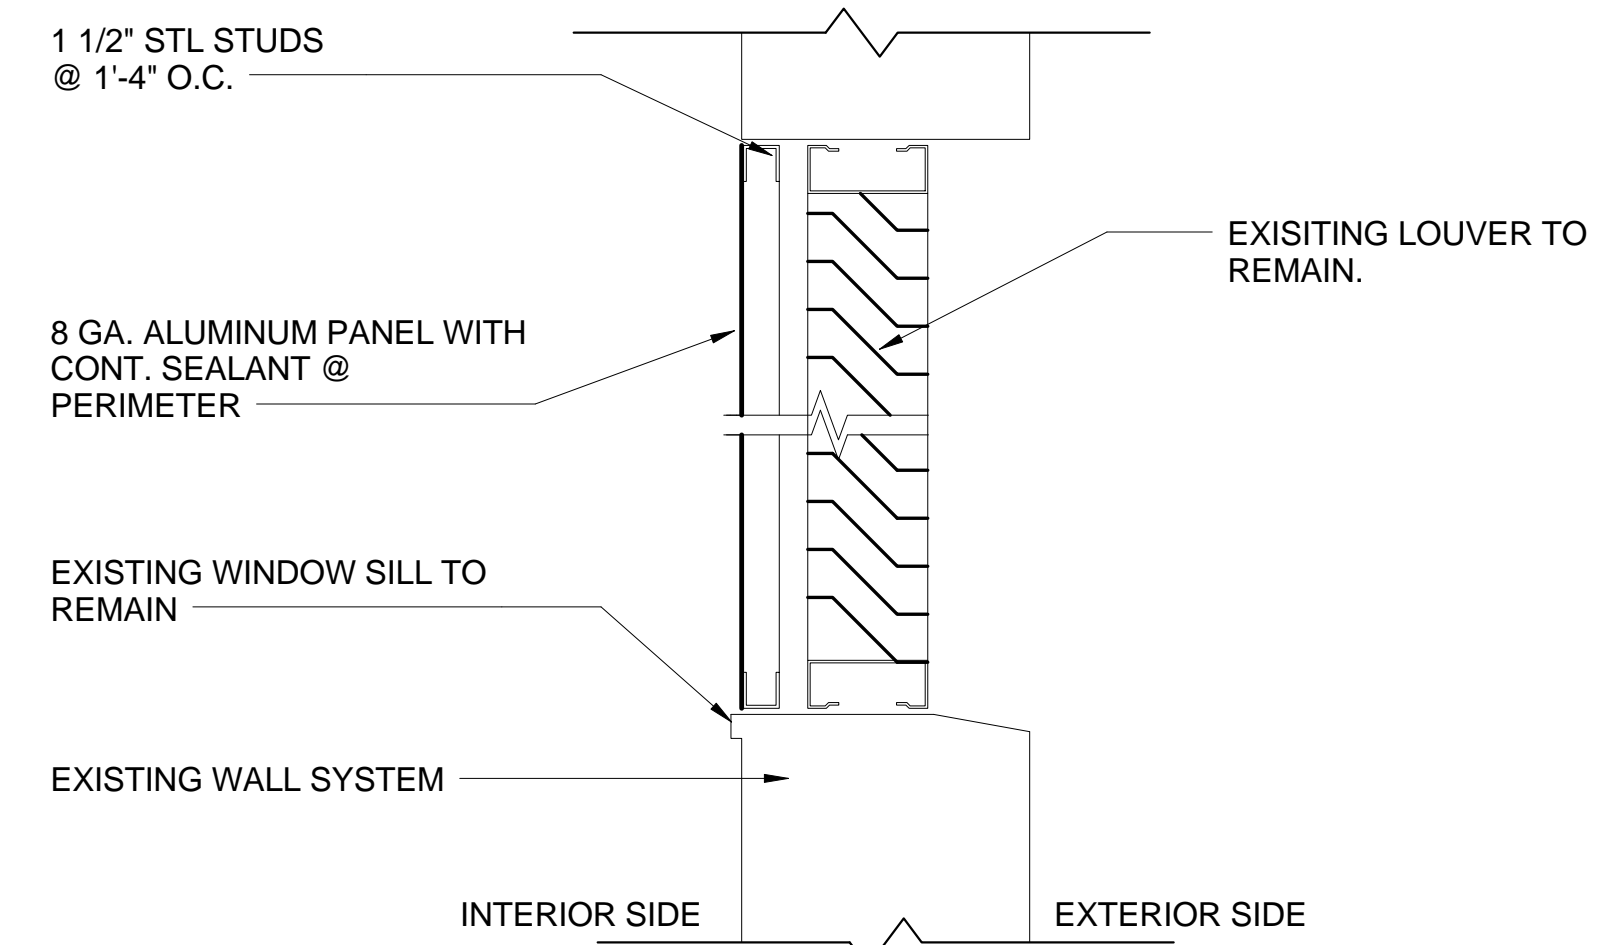


E2 TYP. LOUVER IN-FILL
1 1/2" = 1'-0"

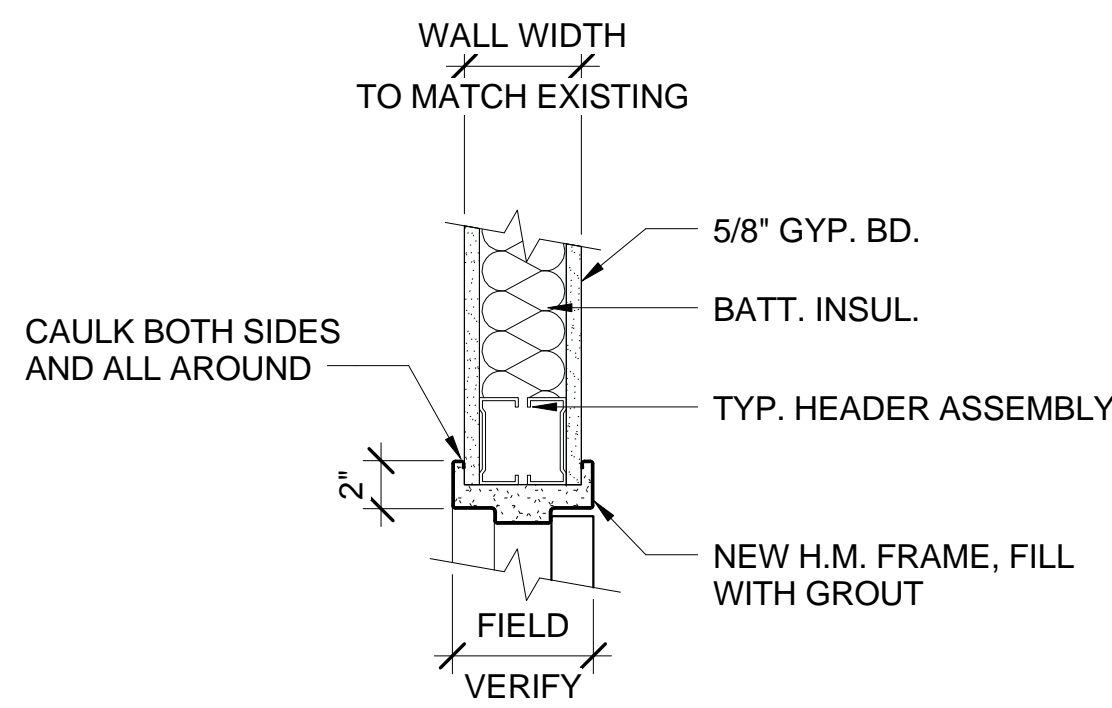


A1 HEAD DETAIL - NEW
1 1/2" = 1'-0"

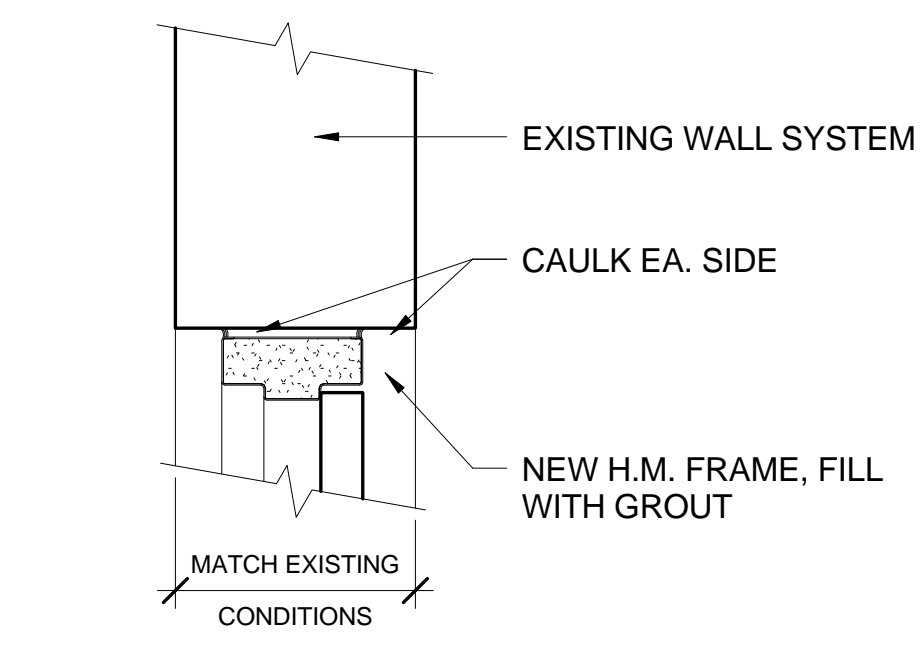


B1 HEAD DETAIL - EXISTING
1 1/2" = 1'-0"

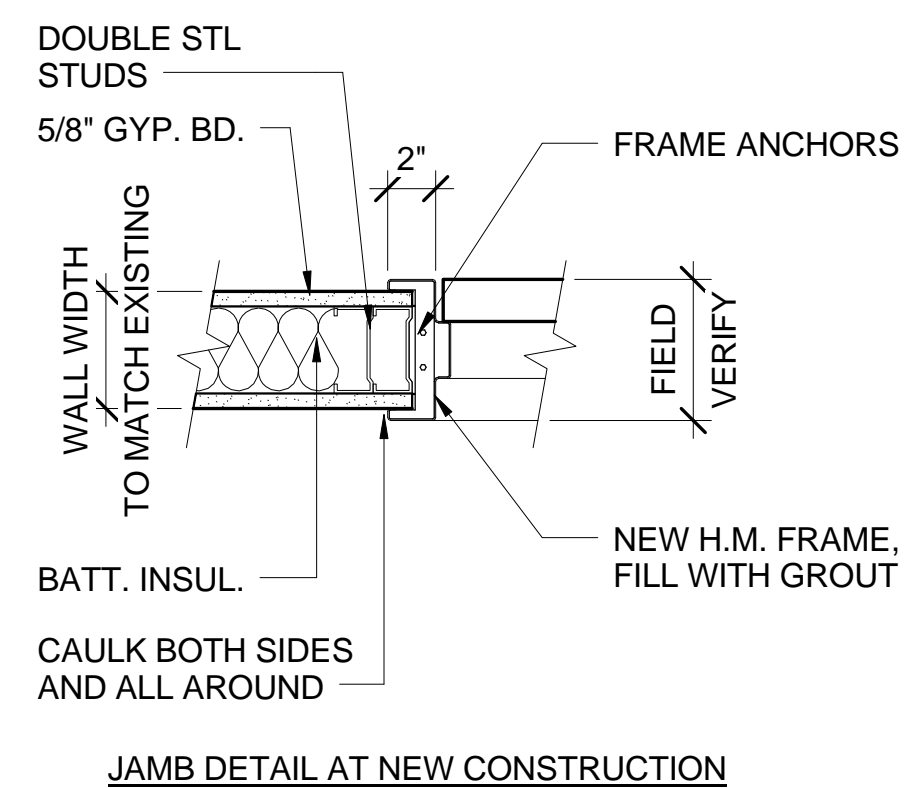

C1 JAMB DETAIL - NEW
1 1/2" = 1'-0"

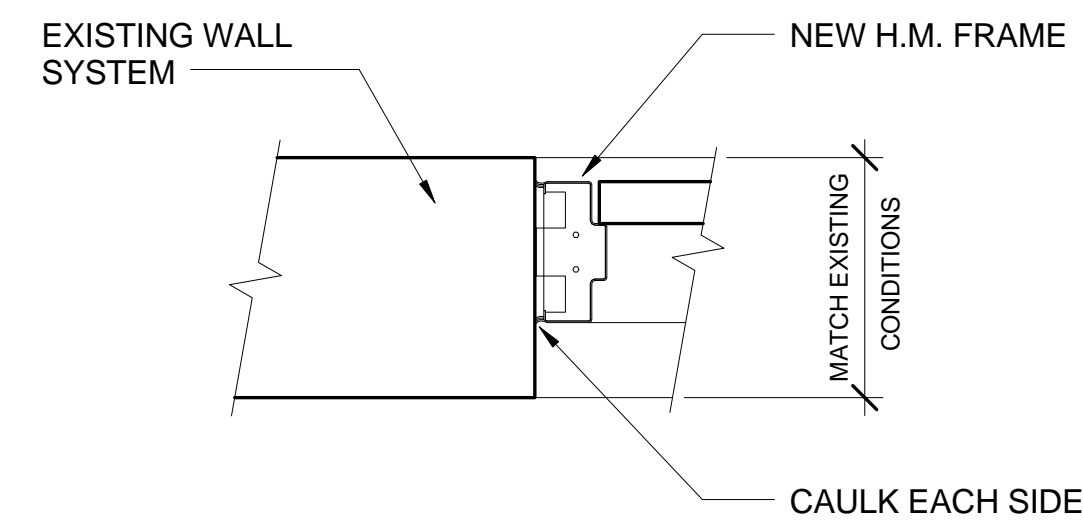


D1 JAMB DETAIL - EXISTING
1 1/2" = 1'-0"

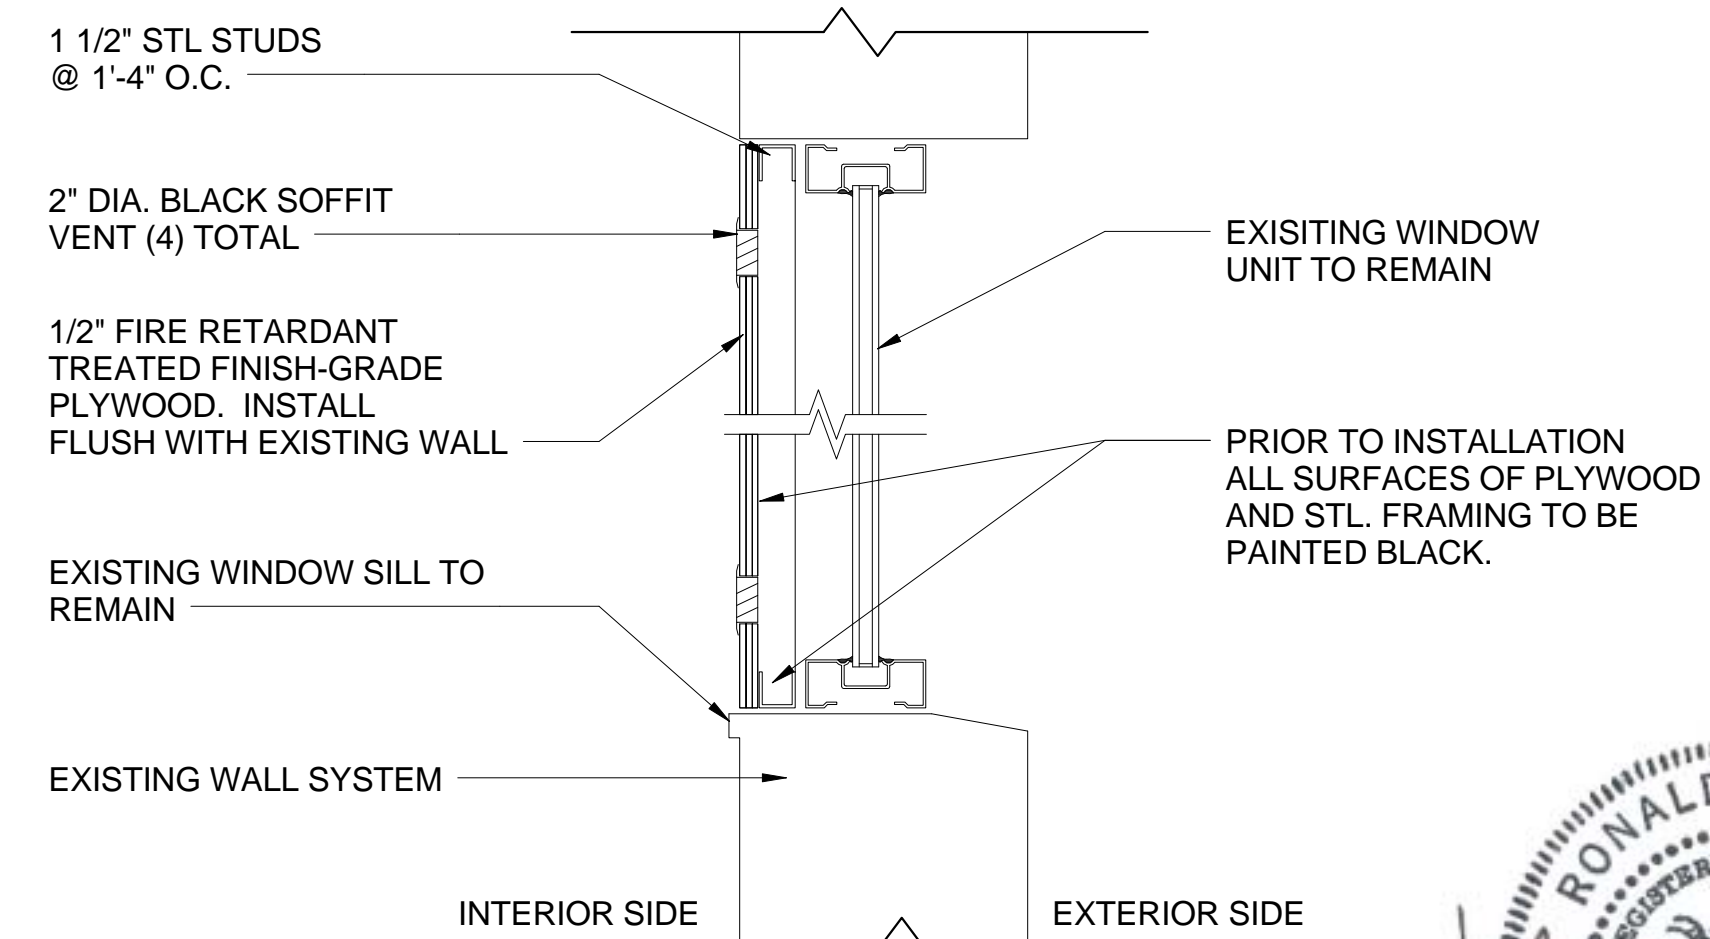


E1 TYP. WINDOW IN-FILL
1 1/2" = 1'-0"



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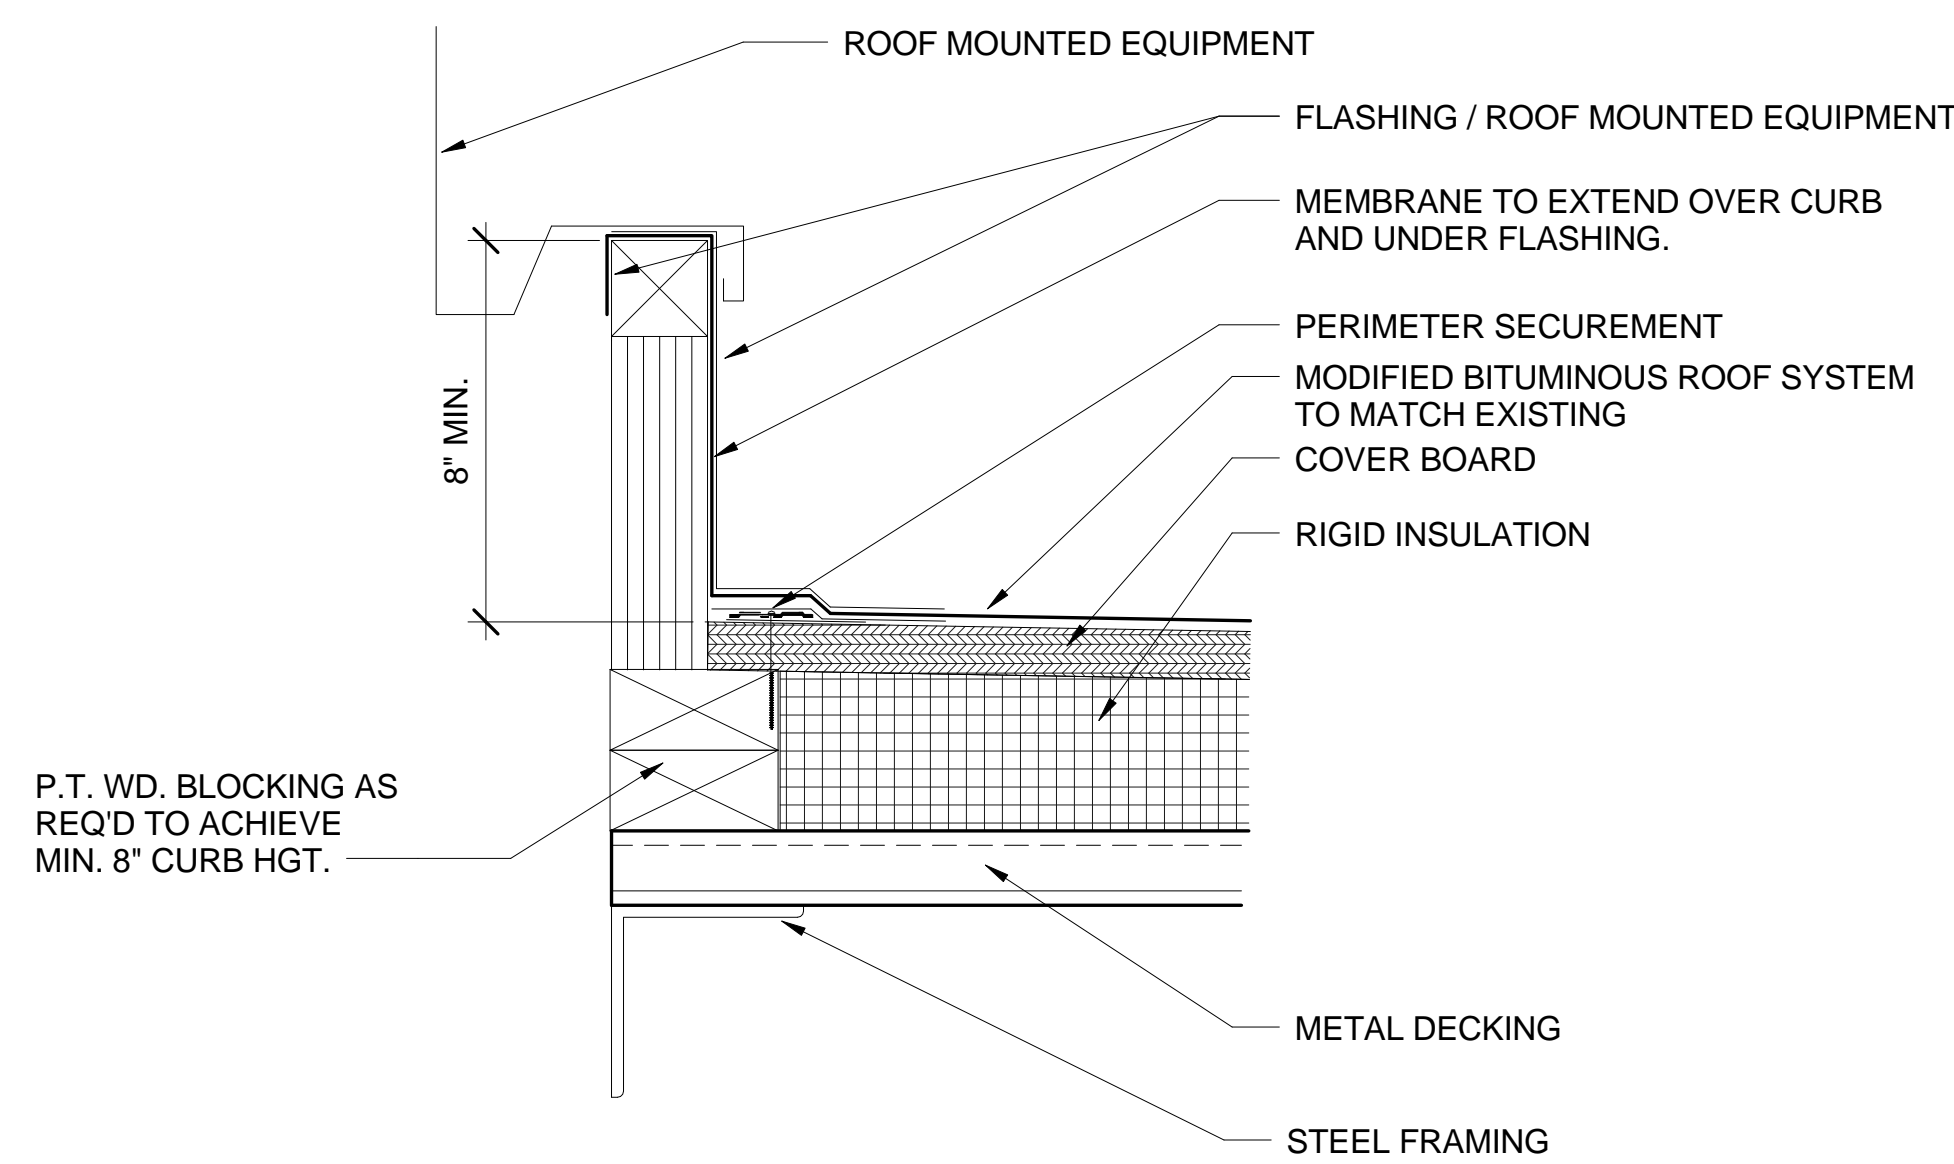
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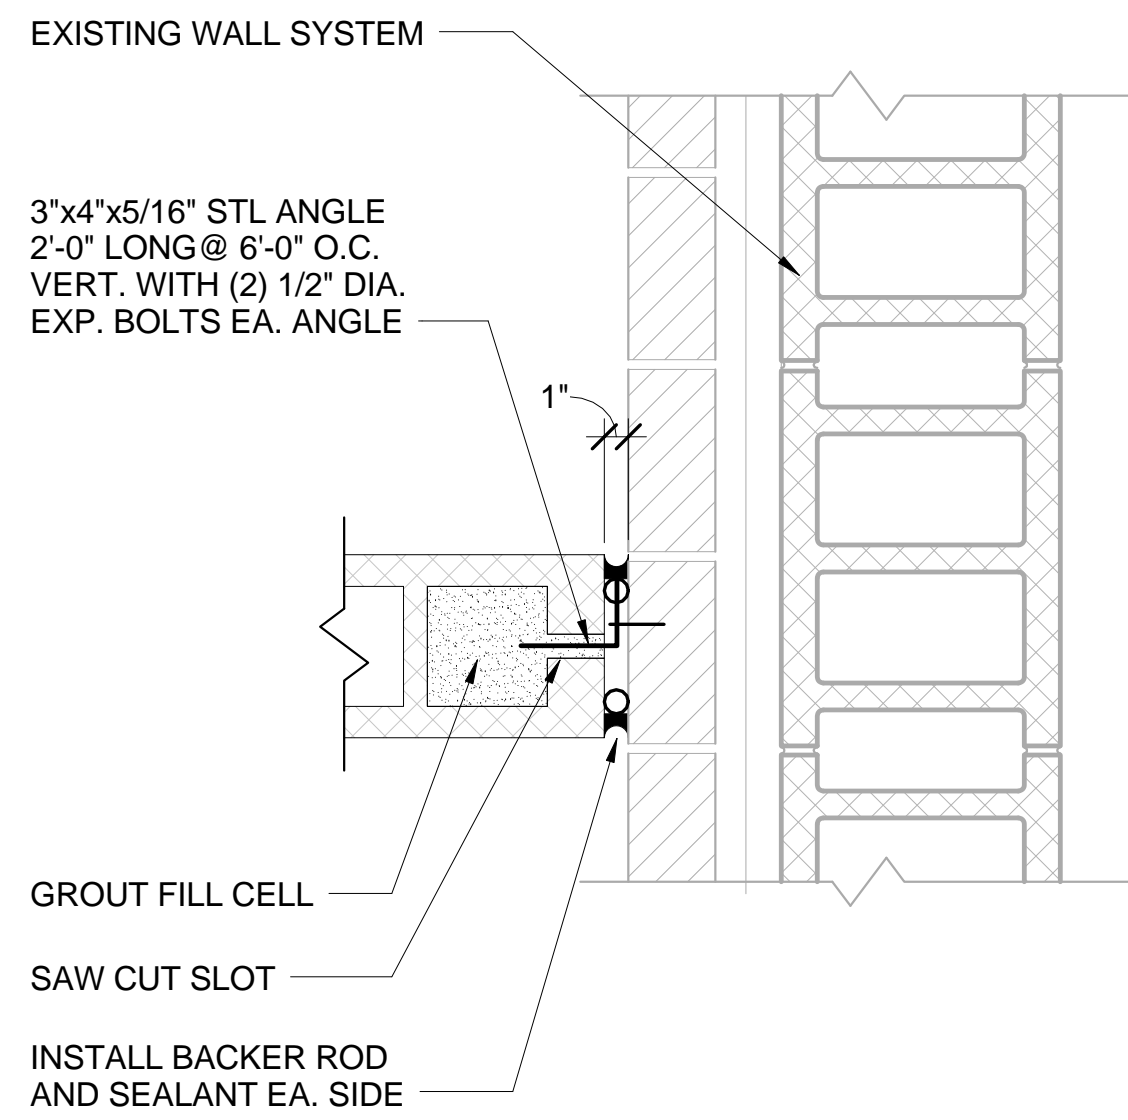
PROJECT TITLE:
UPGRADE ELEC. DISTRIBUTION - PHASE 3
SHEET TITLE: **DETAILS**
APPROVED BY:
APPROVED BY:
BLDG #
CHECKED BY:
DRAWN BY:

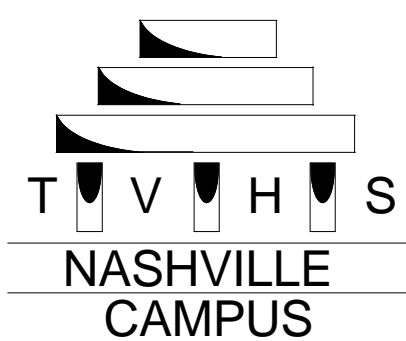DATE:
OCTOBER 31, 2012
PROJECT NUMBER:
626A4-1 1-202
DWG #
AS-501
Dwg. 29 of 97


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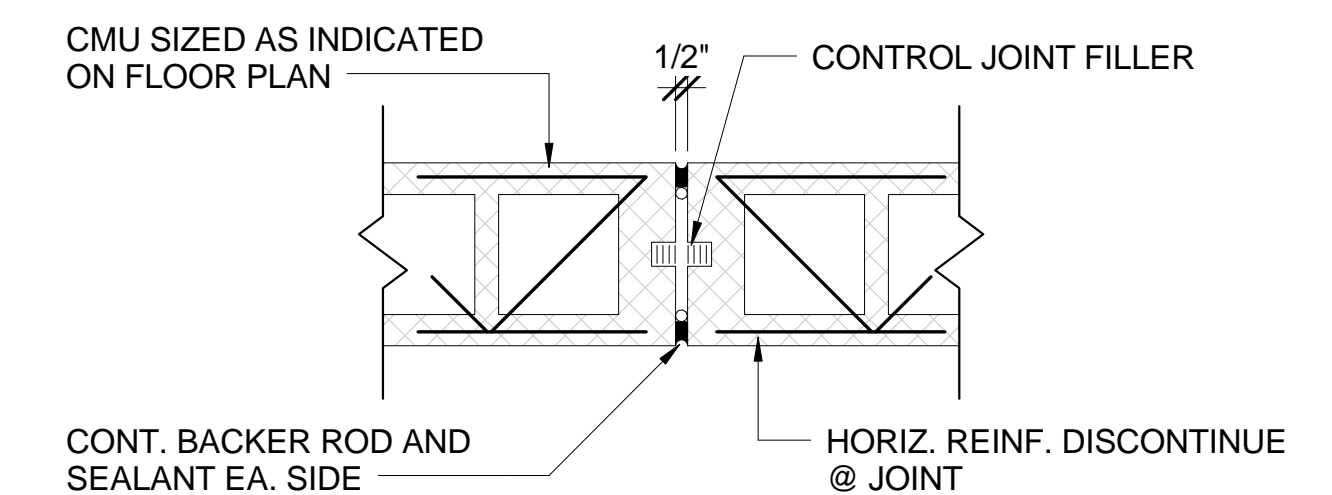
A4 ROOF CURB
3" = 1'-0"

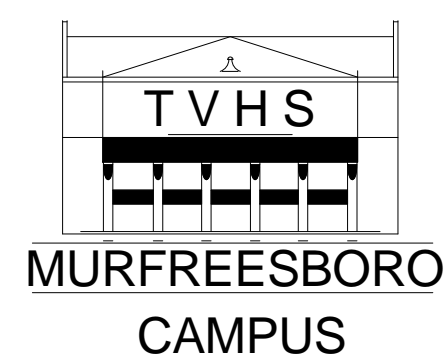


C3 WALL DETAIL - INTERIOR
1 1/2" = 1'-0"




D4 CONTROL JOINT
1 1/2" = 1'-0"

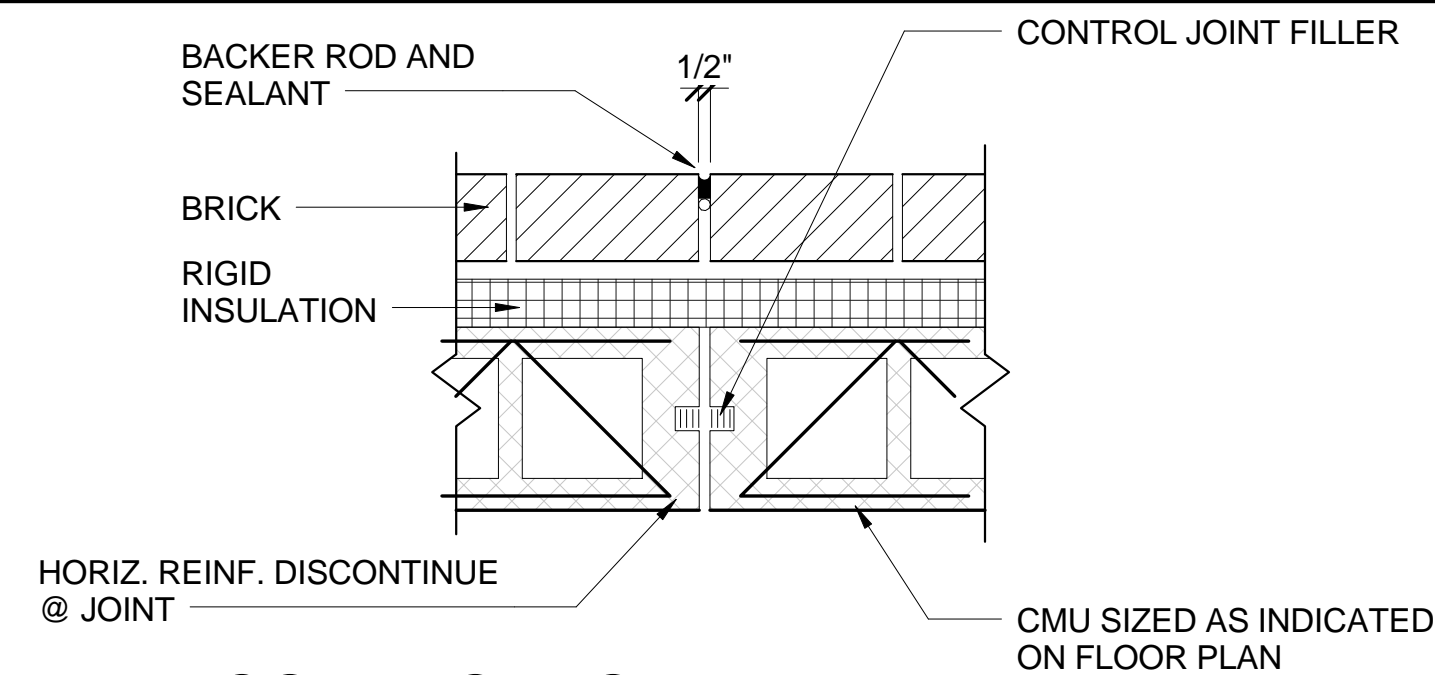


E4 TYP. CONTROL JOINT
1 1/2" = 1'-0"

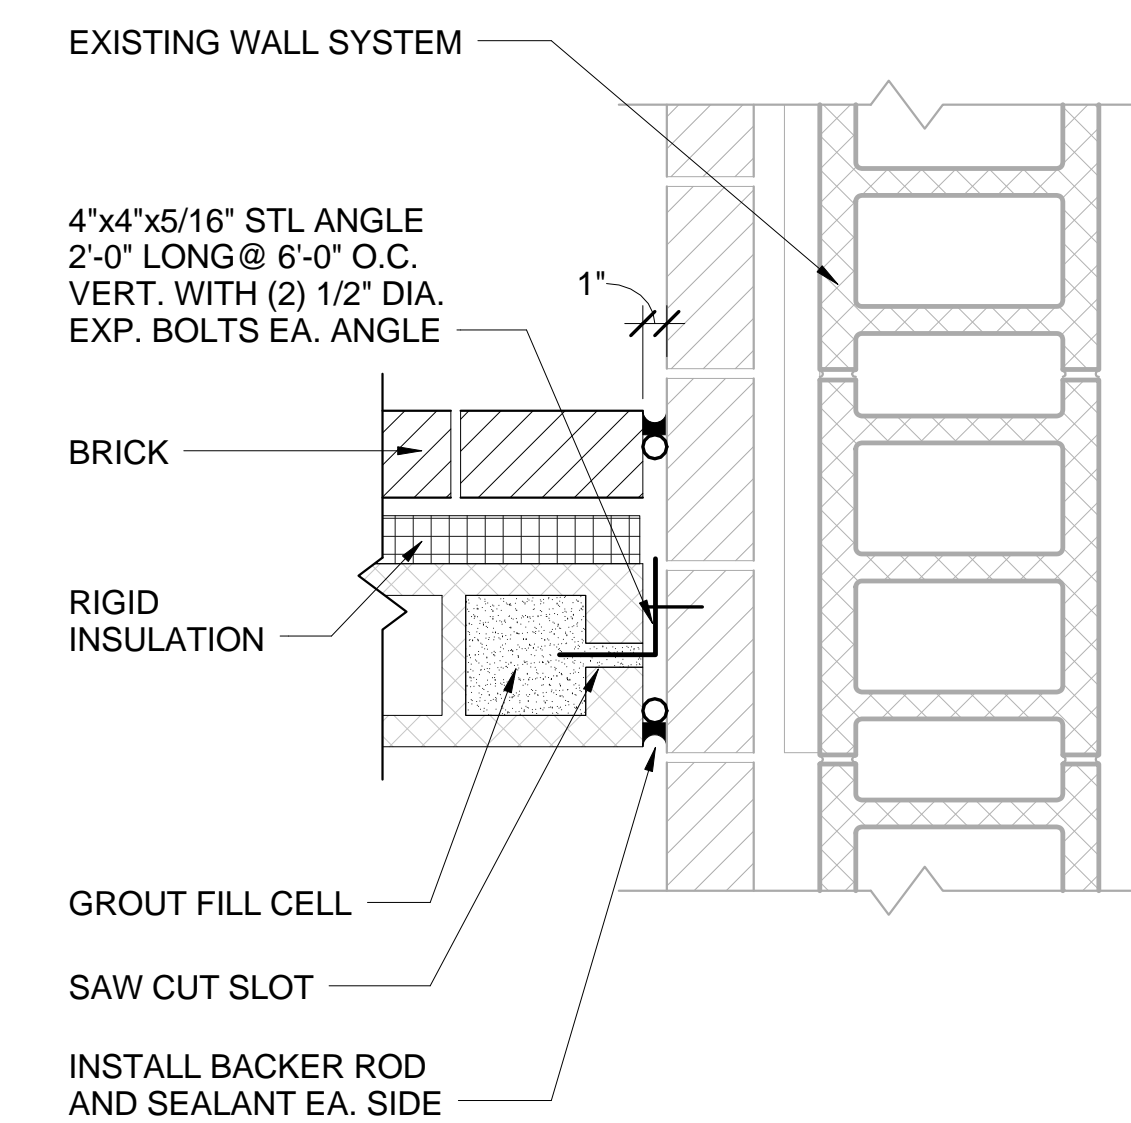


D3 WALL DETAIL - EXTERIOR
1 1/2" = 1'-0"

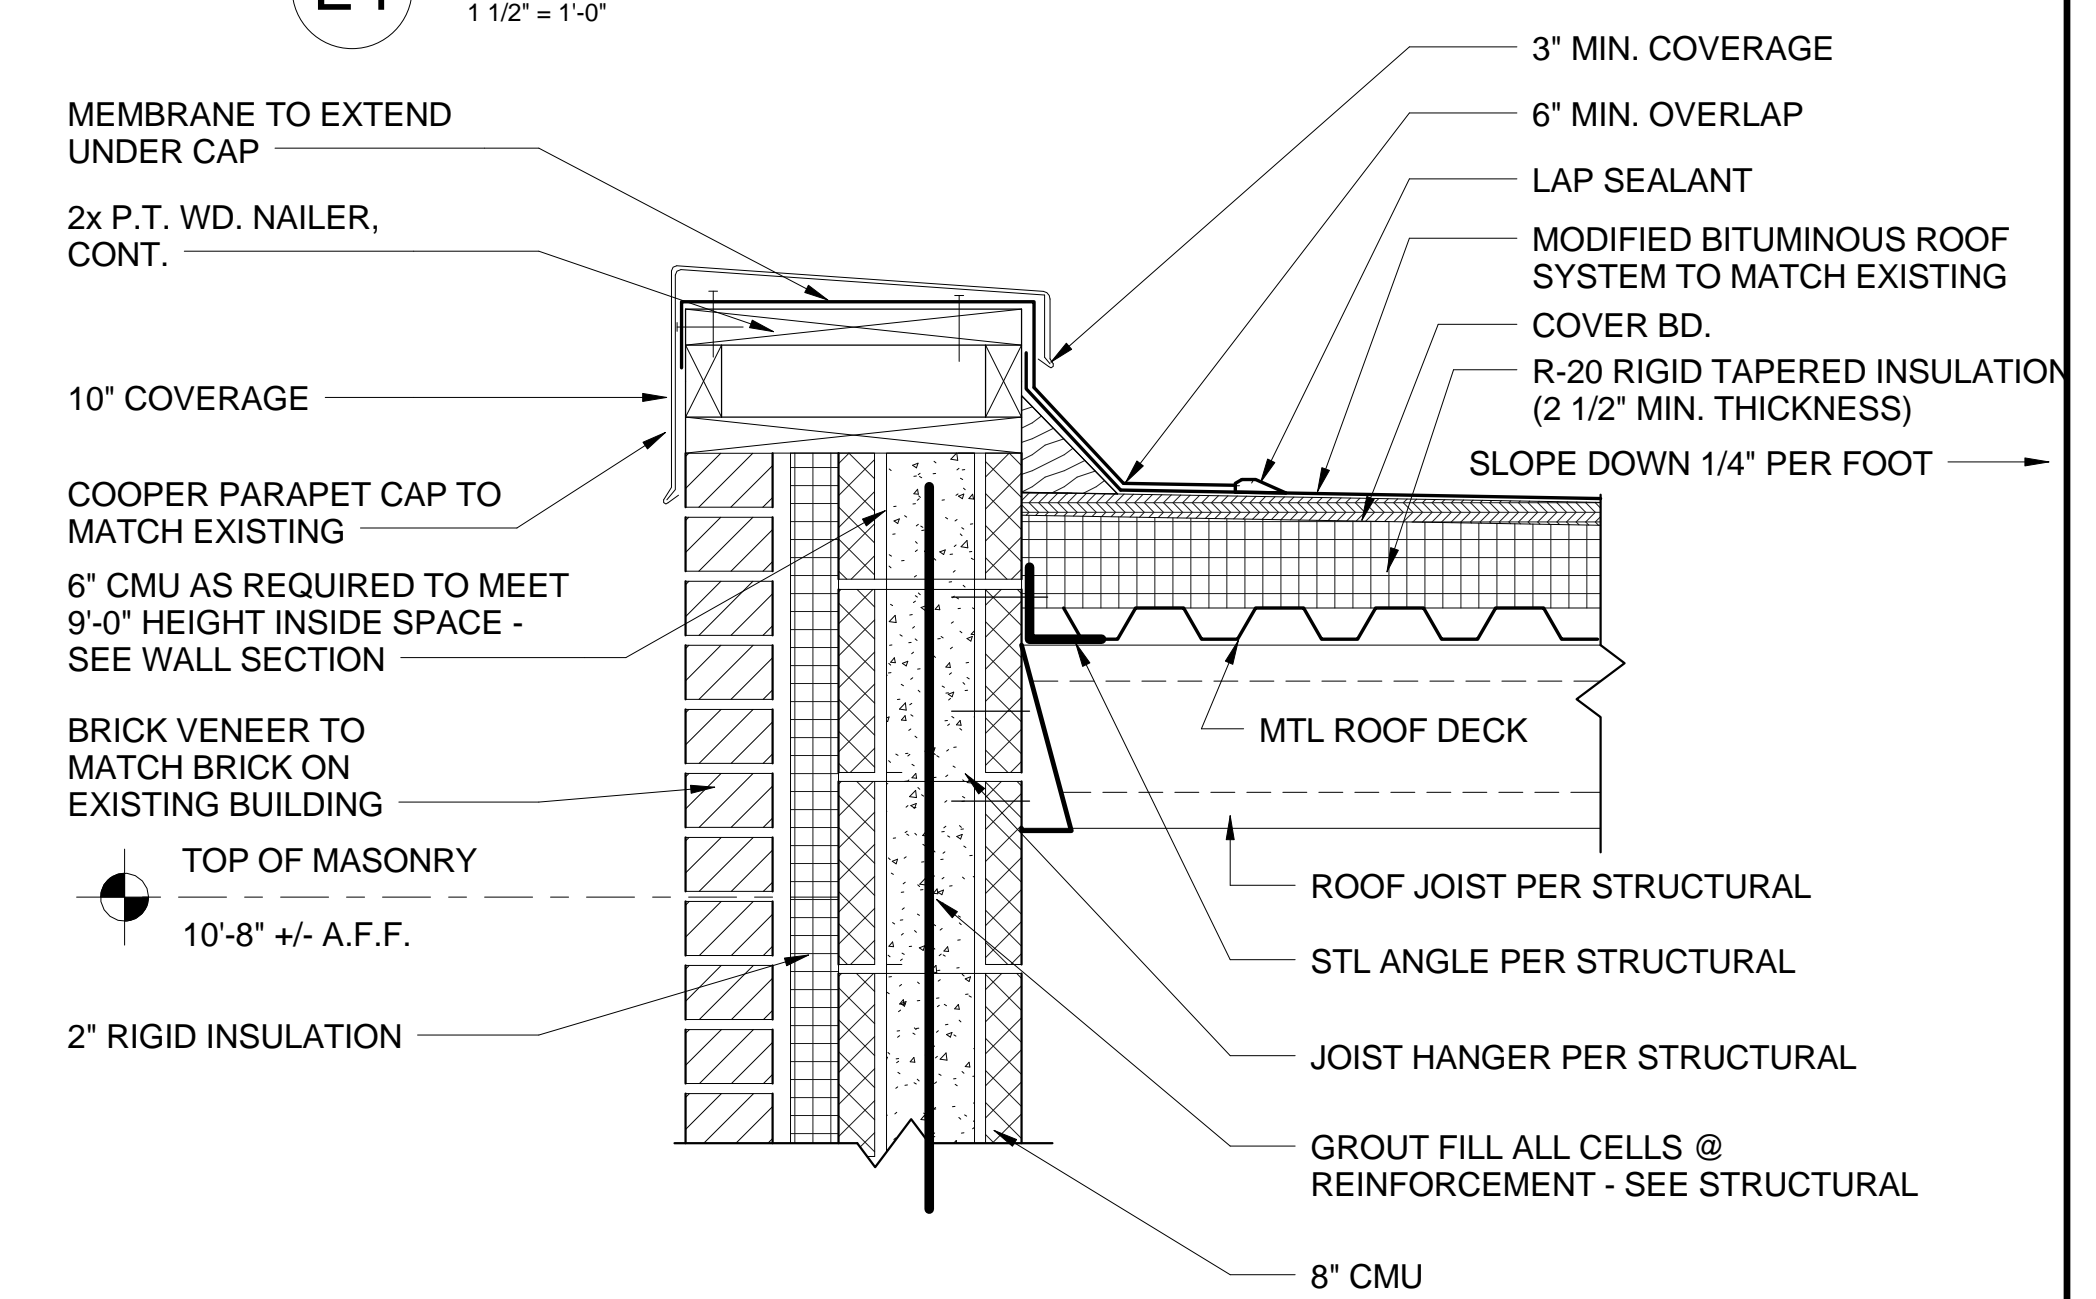


E3 ROOF EDGE DETAIL
1 1/2" = 1'-0"

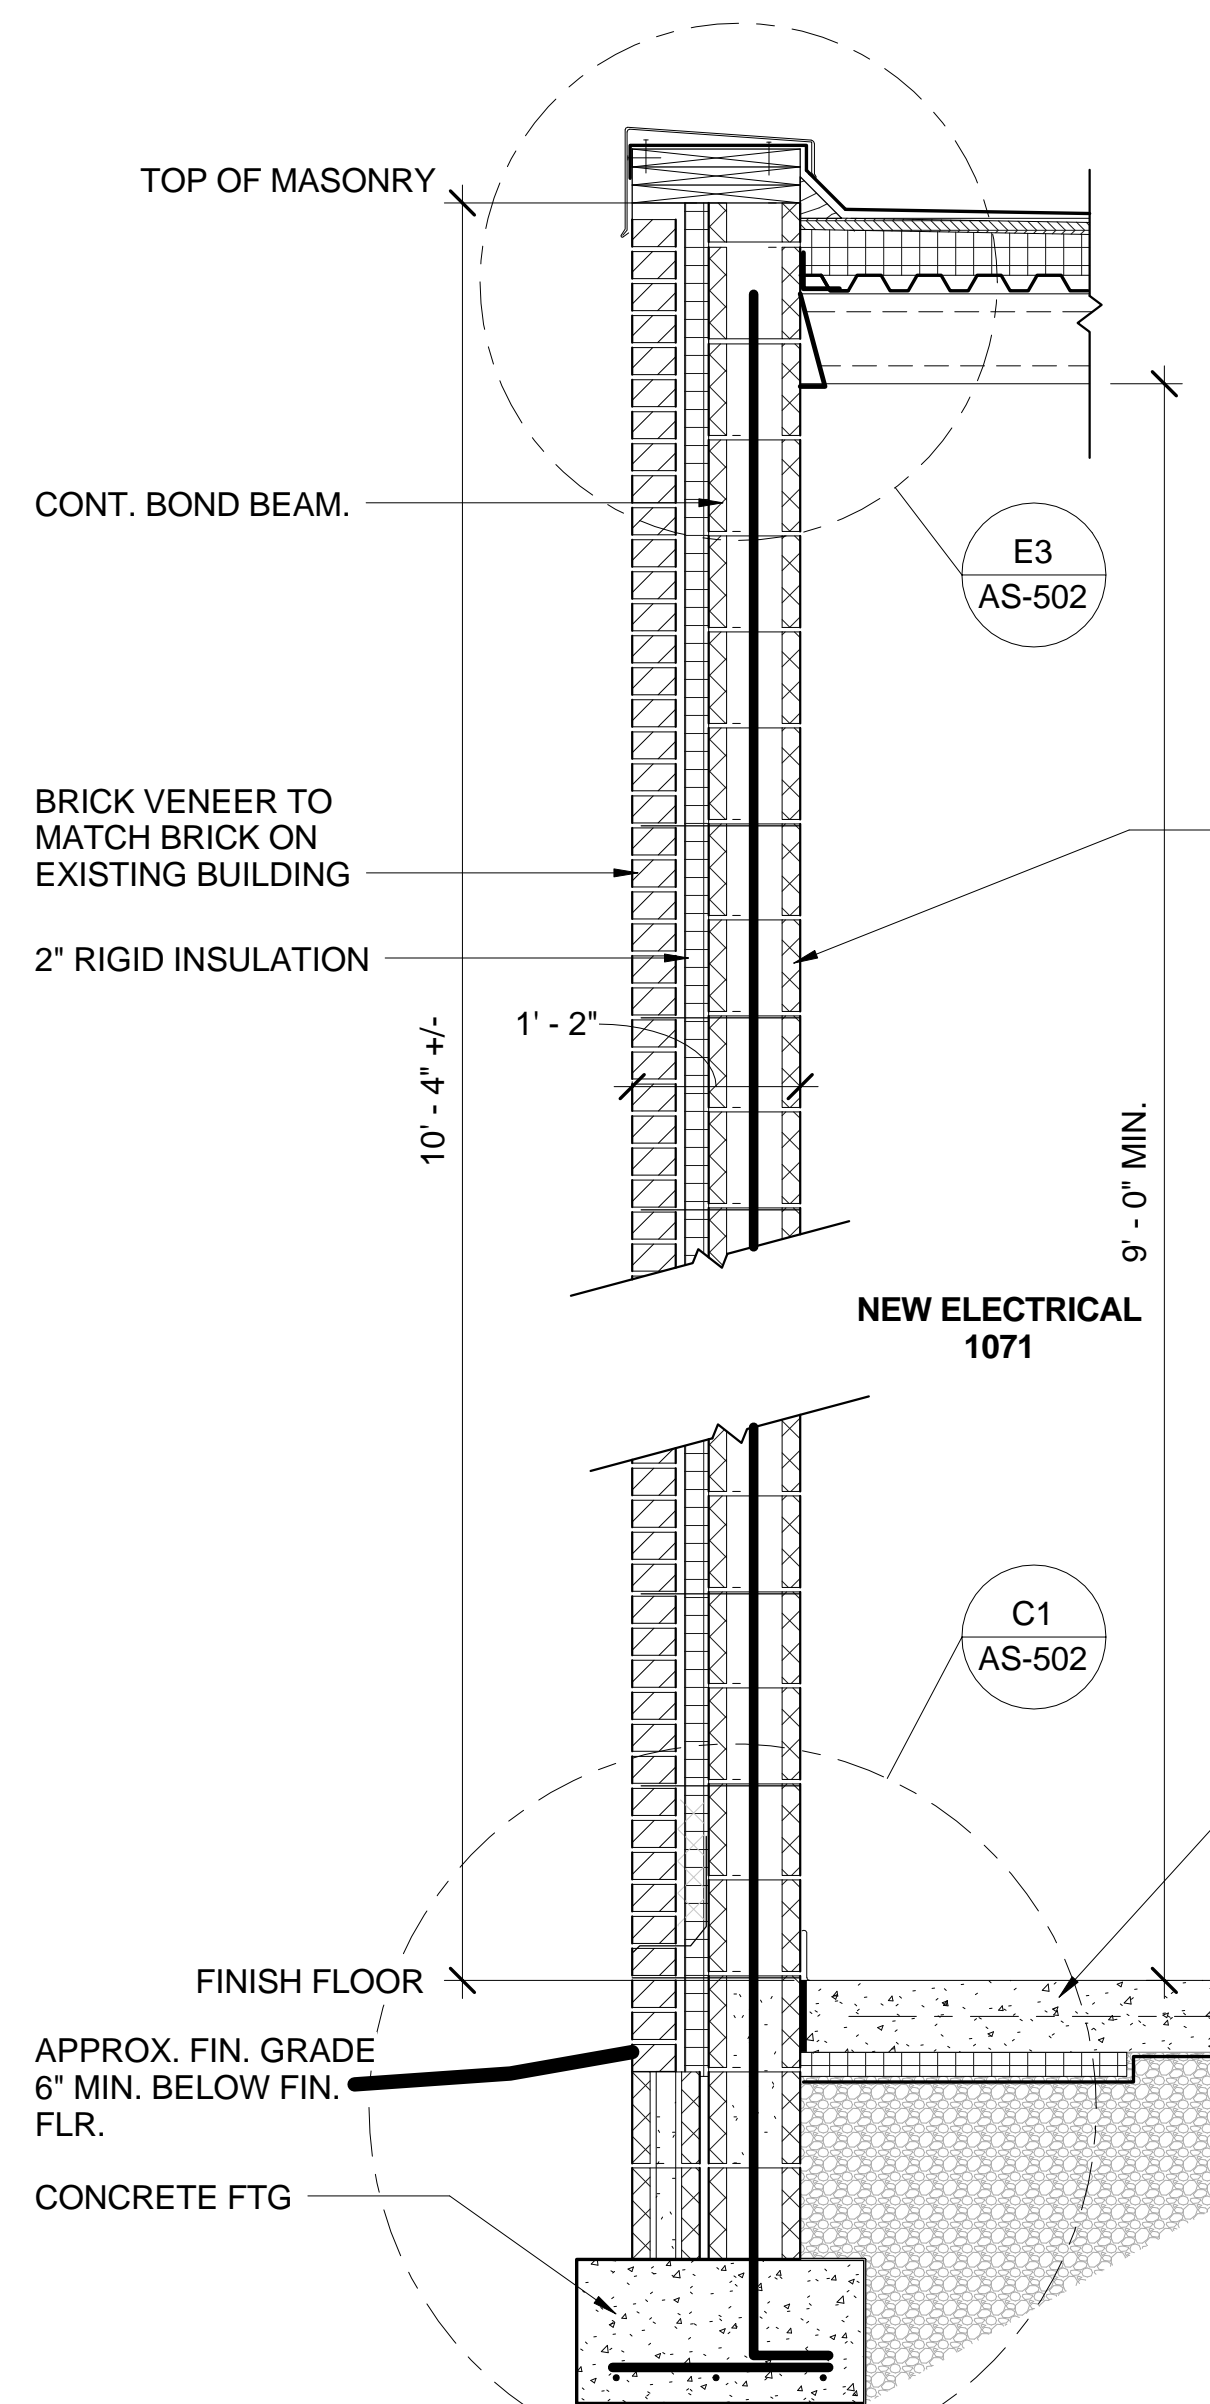


E1 TYP. WALL SECTION - ELECTRIC ROOM ADDITION - BLDG. #107
3/4" = 1'-0"

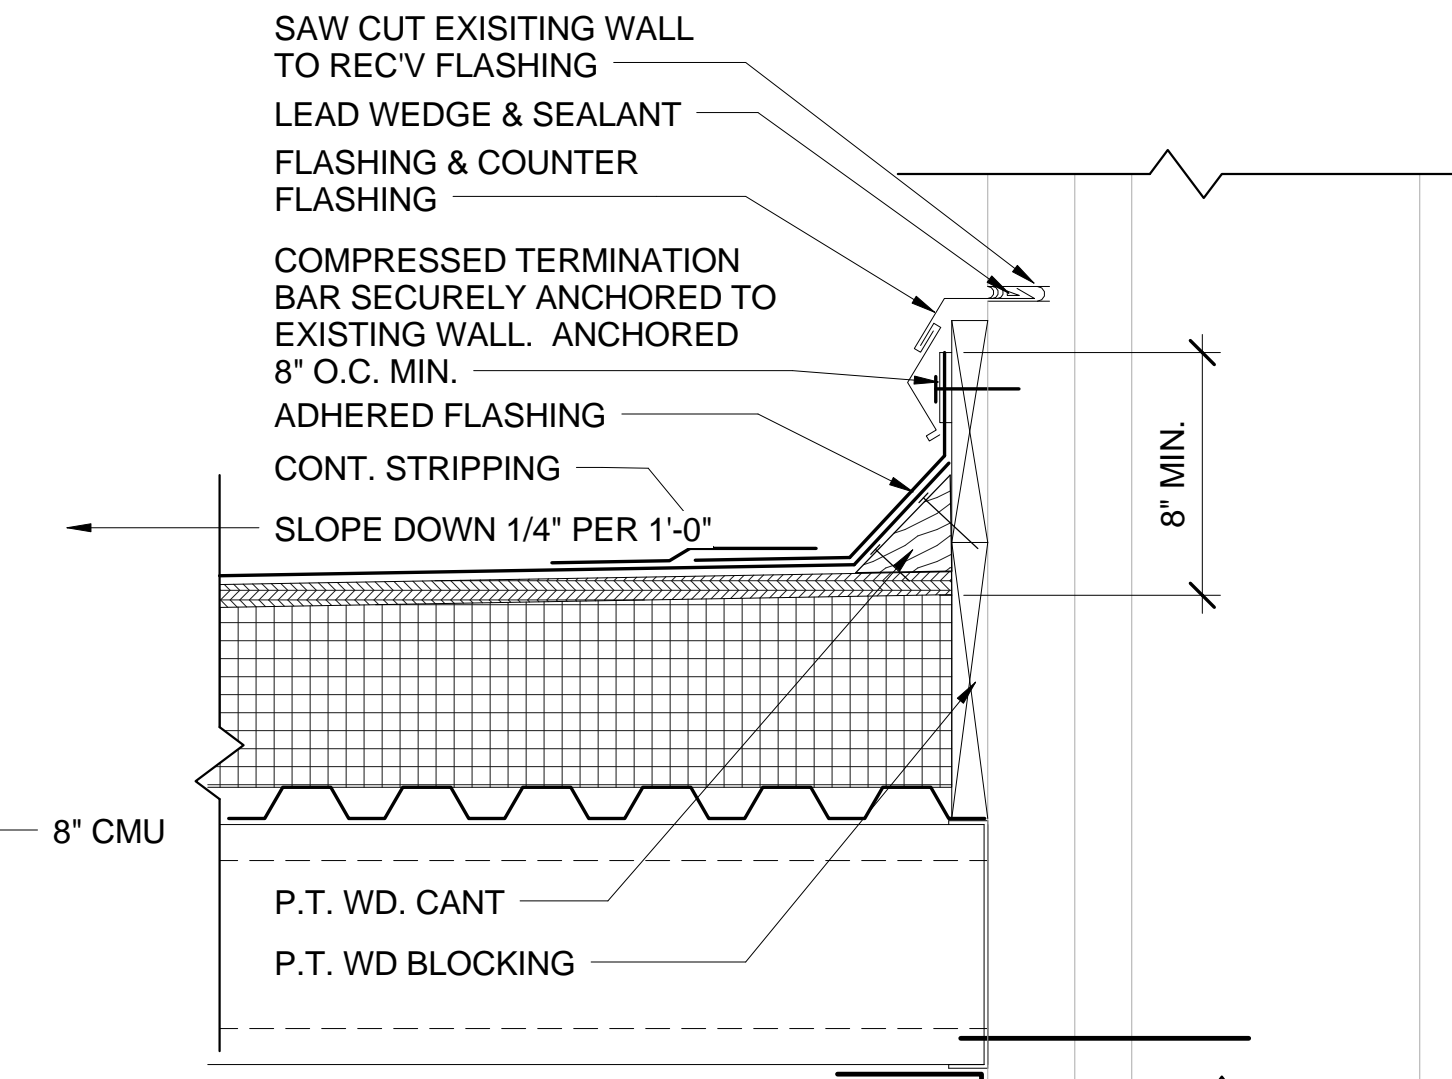

C2 FLASHING DETAIL
1 1/2" = 1'-0"

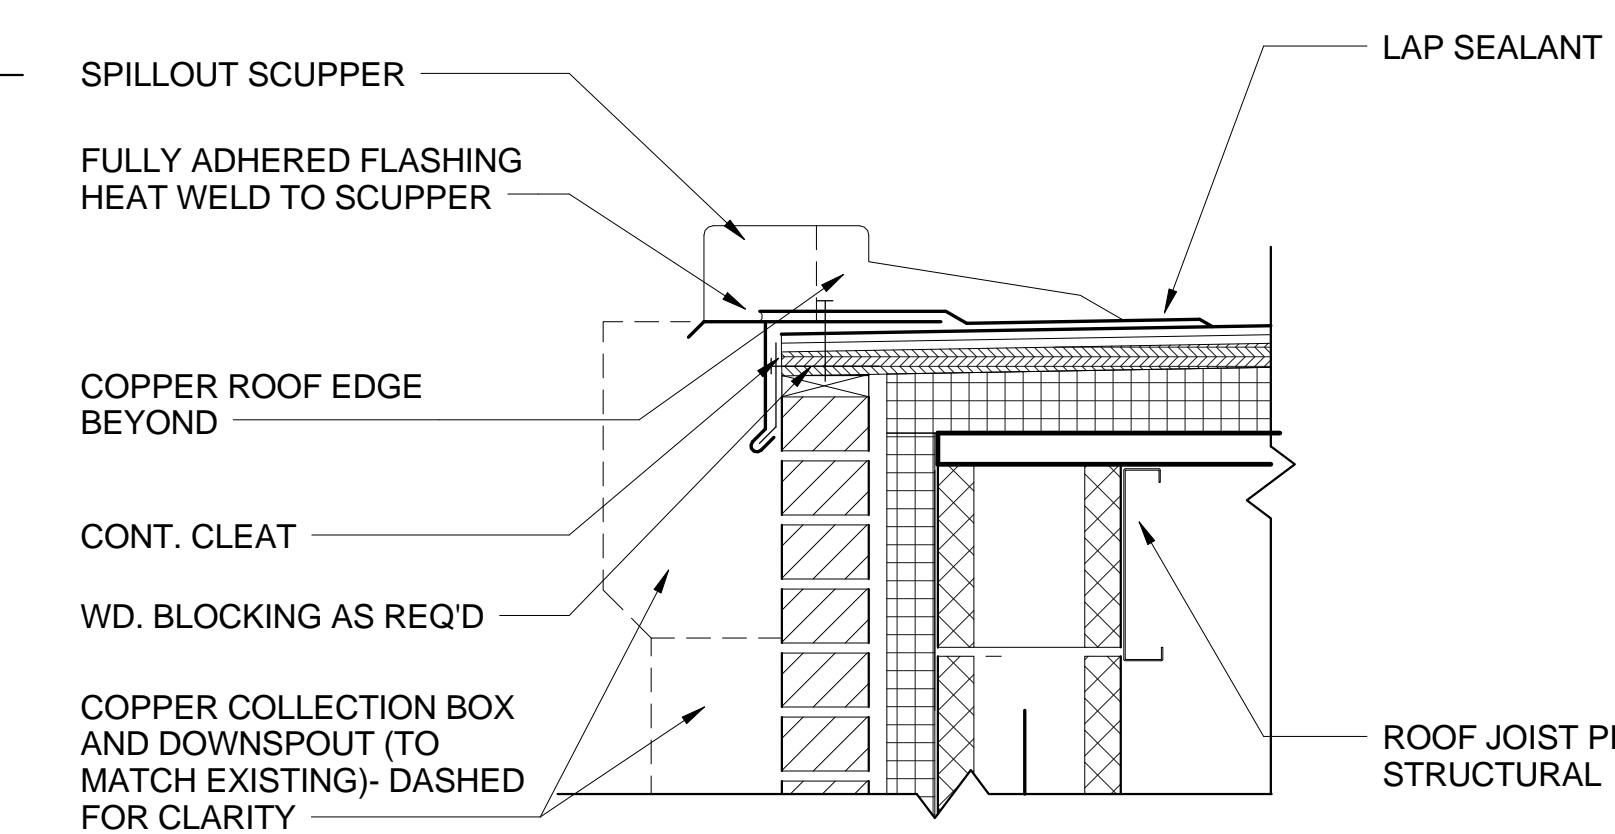


D2 SCUPPER DETAIL
1 1/2" = 1'-0"

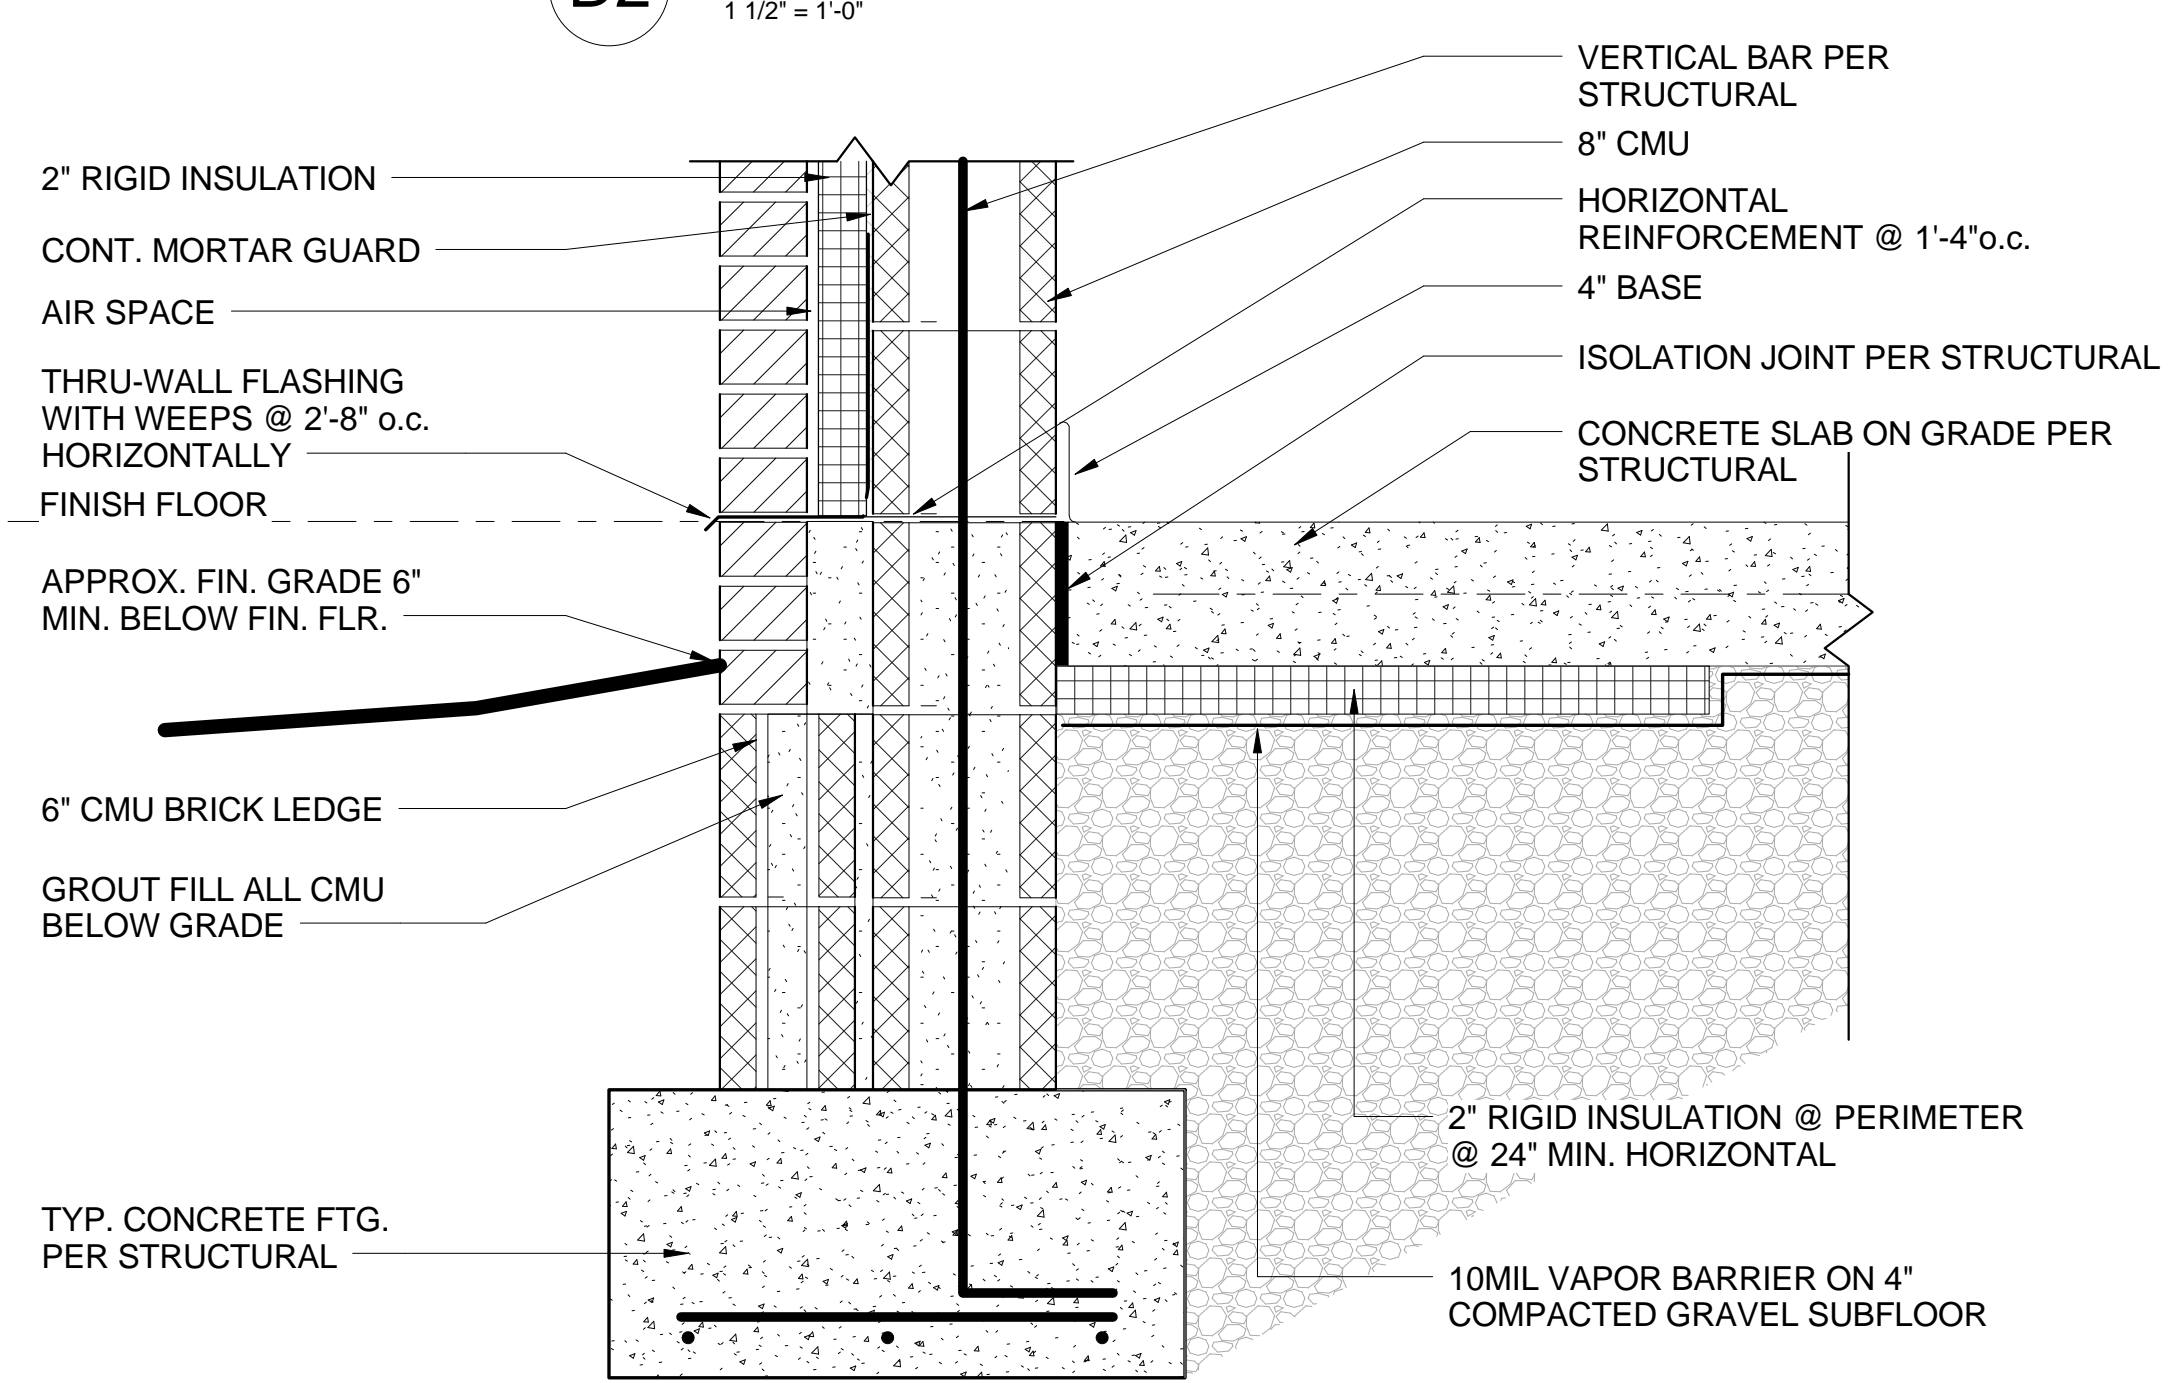


C1 FOOTING DETAIL
1 1/2" = 1'-0"



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GHP PROJECT #: 09040.01

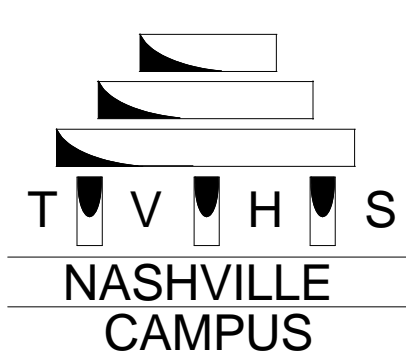PROJECT TITLE:
UPGRADE ELEC. DISTRIBUTION - PHASE 3
SHEET TITLE: **ELECTRICAL ADDITION DETAILS**
APPROVED BY: _____
APPROVED BY: _____
BLDG # _____
CHECKED BY: _____
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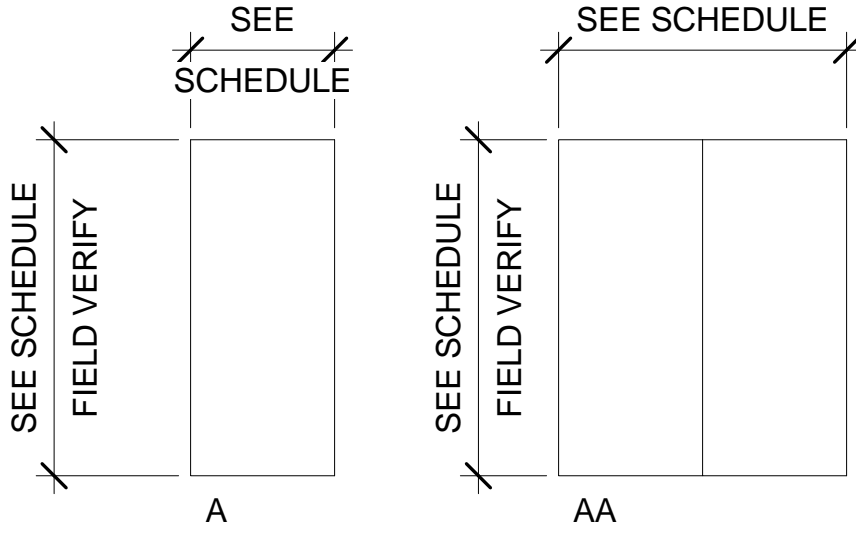
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PROJECT NUMBER:
626A4-1 1-202
DWG #
107-AS-502
Dwg. 30 of 97

Department of
Veterans Affairs

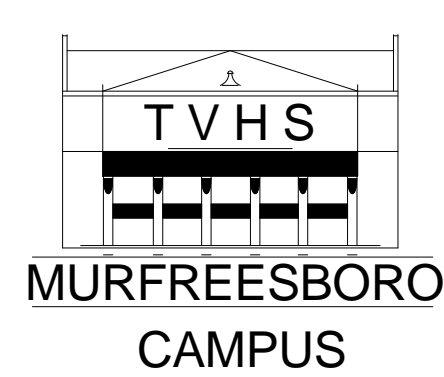
NOTE: DIMENSIONS OF DOORS AT EXISTING OPENINGS ARE APPROXIMATE. CONTRACTOR TO FIELD VERIFY ALL DIMENSIONS.

DOOR SCHEDULE														
DOOR NO.	DOORS					FRAME		FIRE RTG	DETAILS		HARDWARE SET	LOCATION		COMMENTS
	TYPE	WIDTH	HGT	MAT'L	FINISH	MAT'L	FINISH		HEAD	JAMB				
BUILDING #4														
400	A	3'-0"	7'-0"	W.D.	STAIN	H.M.	PAINT	45 MIN.	A1 / AS-501	C1 / AS-501	07	NEW EMERGENCY SYSTEMS ROOM G103		
401	AA	6'-0"	7'-0"	W.D.	STAIN	H.M.	PAINT	-	A1 / AS-501	C1 / AS-501	04	NEW ELECTRIC LOBBY		
402	A	3'-0"	7'-0"	W.D.	STAIN	H.M.	PAINT	-	A1 / AS-501	C1 / AS-501	03	NEW ELECTRIC CLOSET 105A		
403	-	-	-	-	-	H.M.	PAINT	-	A1 / AS-501	C1 / AS-501	05	ELECTRIC B04		EXIST. DOOR & FRAME TO REC'V NEW EXIT DEVICE. PAINT TO MATCH EXISTING EXIT DOORS (DARK BRONZE)
BUILDING #5														
500	-	-	-	H.M.	PAINT	H.M.	PAINT	-	-	-	05	ELECTRICAL / SWITCHBOARD G08		EXIST. DOOR & FRAME TO REC'V NEW EXIT DEVICE. PAINT TO MATCH EXISTING EXIT DOORS (DARK BRONZE)
501	A	3'-0"	7'-0"	W.D.	STAIN	H.M.	PAINT	45 MIN.	B1 / AS-501	D1 / AS-501	08	ELECTRICAL / SWITCHBOARD G08		
502	AA	6'-0"	7'-0"	W.D.	STAIN	H.M.	PAINT	-	A1 / AS-501	C1 / AS-501	04	NEW ELECTRIC CLOSET - VENDING		
503	A	3'-0"	7'-0"	W.D.	STAIN	H.M.	PAINT	-	B1 / AS-501	D1 / AS-501	03	NEW ELECTRIC 109		
504	A	3'-0"	7'-0"	W.D.	STAIN	H.M.	PAINT	-	B1 / AS-501	D1 / AS-501	03	NEW ELECTRIC 210		
BUILDING #6														
600	A	3'-0"	7'-0"	W.D.	STAIN	H.M.	PAINT	45 MIN.	A1 / AS-501	C1 / AS-501	08	NEW MAIN ELECTRICAL SERVICE G12		
601	AA	6'-0"	7'-0"	W.D.	STAIN	H.M.	PAINT	-	B1 / AS-501	D1 / AS-501	04	NEW ELECTRIC CLOSET G19A		
602	A	3'-0"	7'-0"	W.D.	STAIN	H.M.	PAINT	-	B1 / AS-501	D1 / AS-501	03	POLICE EVIDENCE 240		SOLID CORE DOOR
603	A	3'-0"	7'-0"	W.D.	STAIN	H.M.	PAINT	-	B1 / AS-501	D1 / AS-501	03	NEW ELECTRIC 274		
604	A	3'-0"	7'-0"	W.D.	STAIN	H.M.	PAINT	45 MIN.	B1 / AS-501	D1 / AS-501	08	NEW MAIN ELECTRICAL SERVICE G12		
BUILDING #107														
1070	A	3'-0"	7'-0"	W.D.	STAIN	H.M.	PAINT	-	A1 / AS-501	C1 / AS-501	03	NEW ELECTRIC G06J		
1071	A	3'-0"	7'-0"	H.M.	PAINT	H.M.	PAINT	-	B1 / AS-501	D1 / AS-501	09	NEW ELECTRIC ADDITION 1071		PAINT TO MATCH EXISTING EXIT H.M. DOORS (DARK BRONZE)
1072	AA	6'-0"	7'-0"	H.M.	PAINT	H.M.	PAINT	-	B1 / AS-501	D1 / AS-501	10	NEW ELECTRIC ADDITION 1072		PAINT TO MATCH EXISTING EXIT H.M. DOORS (DARK BRONZE)
1073	A	3'-0"	7'-0"	H.M.	PAINT	H.M.	PAINT	45 MIN.	C3 / AS-501	D3 / AS-501	02	NEW ELECTRIC ADDITION 1072		PAINT TO MATCH EXISTING EXIT H.M. DOORS (DARK BRONZE)
1074	A	3'-8"+/-	7'-0"	W.D.	STAIN	H.M.	PAINT	-	A1 / AS-501	C1 / AS-501	01	LOCKER ROOM G18C		
1075	A	3'-0"	7'-0"	W.D.	STAIN	H.M.	PAINT	-	B1 / AS-501	D1 / AS-501	03	NEW ELECTRIC G18E		
1076	-	-	-	-	-	-	-	-	B1 / AS-501	D1 / AS-501	05	NEW ELECTRIC 101A		EXIST. DOOR & FRAME TO REC'V NEW EXIT DEVICE

DOOR TYPES



FRAME TYPES

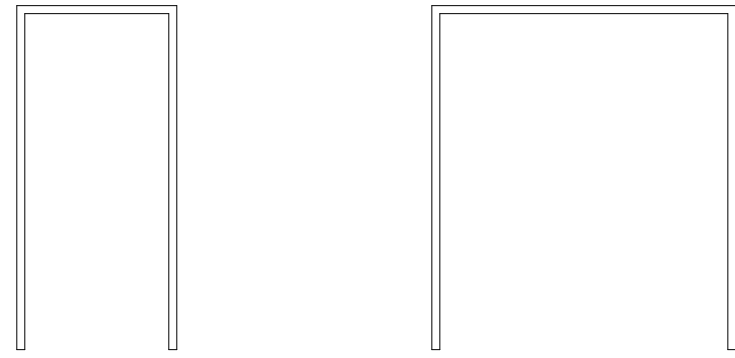

NOTE: 2" JAMB FRAME WIDTH TYPICAL. 2" HEAD FRAME @ MASONRY INCREASE TO MAX. 4" TO SUIT MASONRY COURSING.


ALL EXISTING OPENING DIMENSION TO BE FIELD VERIFIED.

GENERAL NOTES


- ALL 7'-0" TALL DOORS RECEIVE THREE (3) HINGES, TYP.
- DOORS TALLER THAN 7'-0" TO RECEIVE FOUR OR MORE HINGES.
- ALL HOLLOW METAL FRAMES TO RECEIVE THREE (3) SILENCERS.
- AT CENTERLINE OF DOOR WHERE FLOOR MATERIAL CHANGES, PROVIDE DOOR THRESHOLD OR TRANSITION STRIP.
- PROVIDE AN ALUMINUM THRESHOLD AT ALL EXTERIOR DOORS UNLESS NOTED OTHERWISE.
- WEATHERSTRIP ALL EXTERIOR DOORS - TYPICAL (INCLUDING ANY EXISTING DOORS ON RENOVATION PROJECTS THAT ARE INCLUDED IN SCOPE OF WORK).
- THIS NOTE OMITTED.
- PROVIDE SMOKE SEALS FOR ALL DOORS IN THE SMOKE WALLS, PEMKO S88 OR EQUAL.
- THIS NOTE OMITTED.
- PAINT ALL EXTERIOR HOLLOW METAL DOORS AND FRAMES TO BLEND WITH BRICK COLOR.



REVISION	DATE

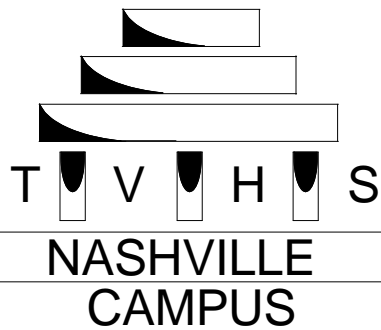

Tennessee Valley Healthcare System

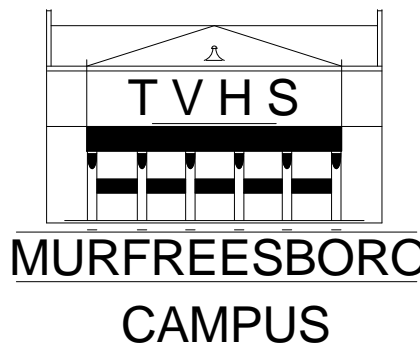

PROJECT TITLE: UPGRADE ELEC. DISTRIBUTION - PHASE 3		
SHEET TITLE: DOOR SCHEDULE		
APPROVED BY:		
APPROVED BY:		
BLDG #	CHECKED BY:	DRAWN BY:

DATE: OCTOBER 31, 2012
PROJECT NUMBER: 626A4-1 1-202
DWG # AS-601 Dwg. 31 of 97

Department of
Veterans Affairs