


three inches = one foot  
 one and one half inches = one foot  
 one inch = one foot  
 three quarters inch = one foot  
 one half inch = one foot  
 three eighths inch = one foot  
 one quarter inch = one foot  
 one eighth inch = one foot

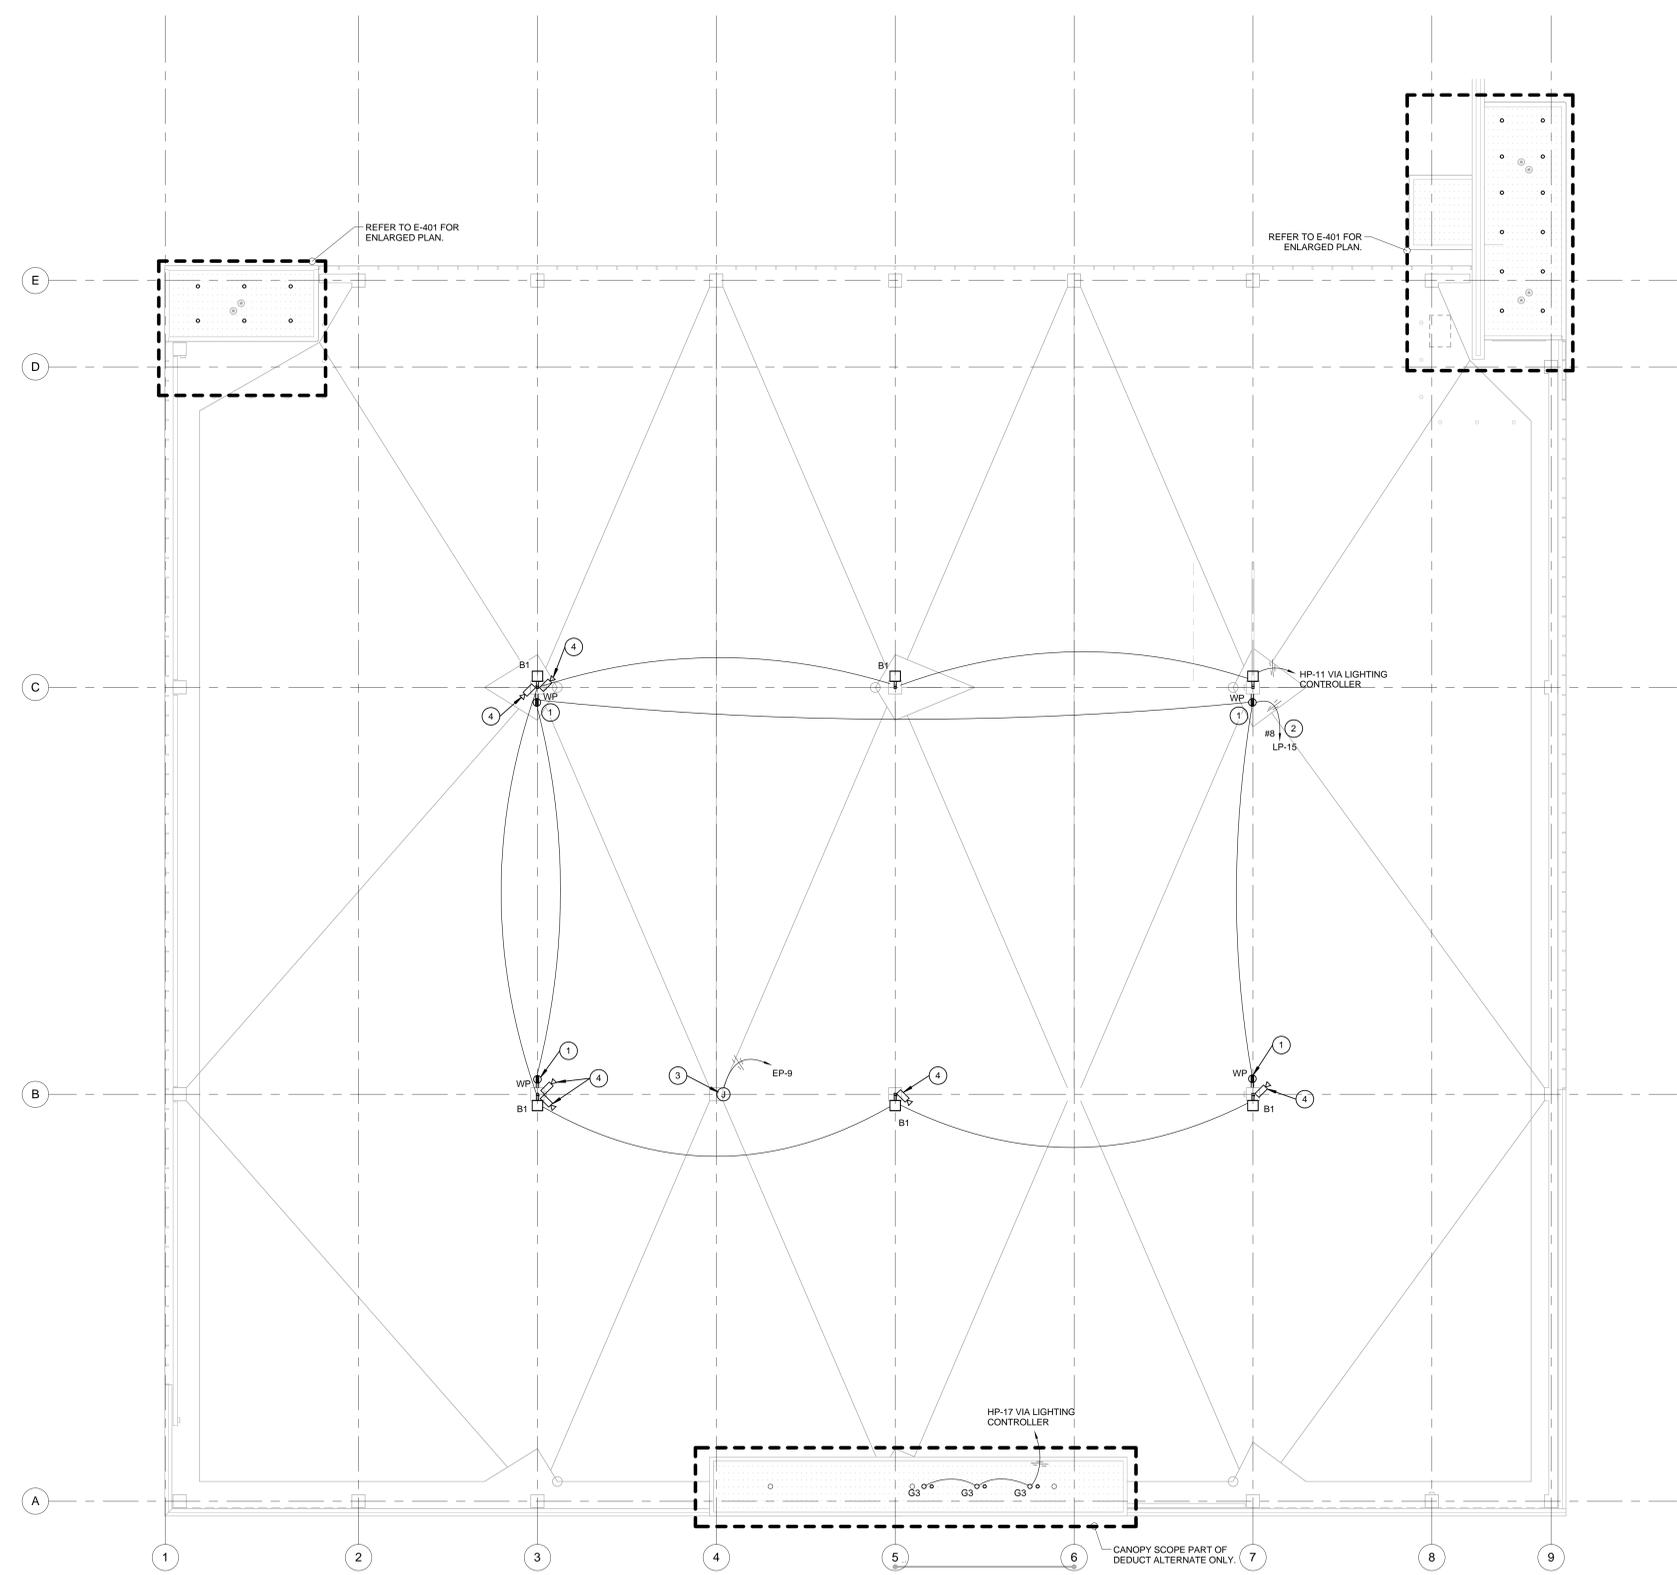

**General Notes**

**Key Notes**

1. CONCEAL CONDUIT AND WIRING TO RECEPTACLE FROM SLAB OR DECK IN COLUMN.
2. PROVIDE HOME RUN WIRE SIZE AS INDICATED. REFER TO E-001 FOR ADDITIONAL WIRING INFORMATION.
3. POWER CONNECTION FOR EMERGENCY PHONE TOWER. COORDINATE REQUIREMENTS WITH TELEDATA INSTALLER. REFER TO TE-SERIES DRAWINGS.
4. POLE MOUNTED CCTV CAMERA HEATERS. CONNECT TO CIRCUIT EP-23. REFER TO E-611 AND TE-SERIES DRAWINGS FOR MORE INFORMATION.

**1 SECOND LEVEL ELECTRICAL PLAN**  
 3/32" = 1'-0"

FINAL SUBMITTAL

No.	Description	Date
DD#1		07/09/2012
DD#2		08/13/2012
CD#1		09/24/2012
CD#2		11/02/2012
	FINAL SUBMITTAL	05/07/2013
Revisions:		Date

CONSULTANTS	

ARCHITECT/ ENGINEERS	
Westlake Reed Leskosky	
The Huntington Building 925 Euclid Avenue, Suite 1900 Cleveland, Ohio 44115-1407 216.522.1350	

Drawing Title	LEVEL 2 ELECTRICAL PLAN
Approved: Project Director	

Project Title		VA Erie Parking Structure	
Location		Erie, PA	
Date	Checked	Drawn	
9/24/2013	MSB	SRH	
Project Number		11159.00	
Building Number			
Drawing Number		E-102	

**Office of Construction and Facilities Management**  
 Department of Veterans Affairs