




4 SECOND LEVEL NORTHWEST ENLARGED PLAN
1/4" = 1'-0"

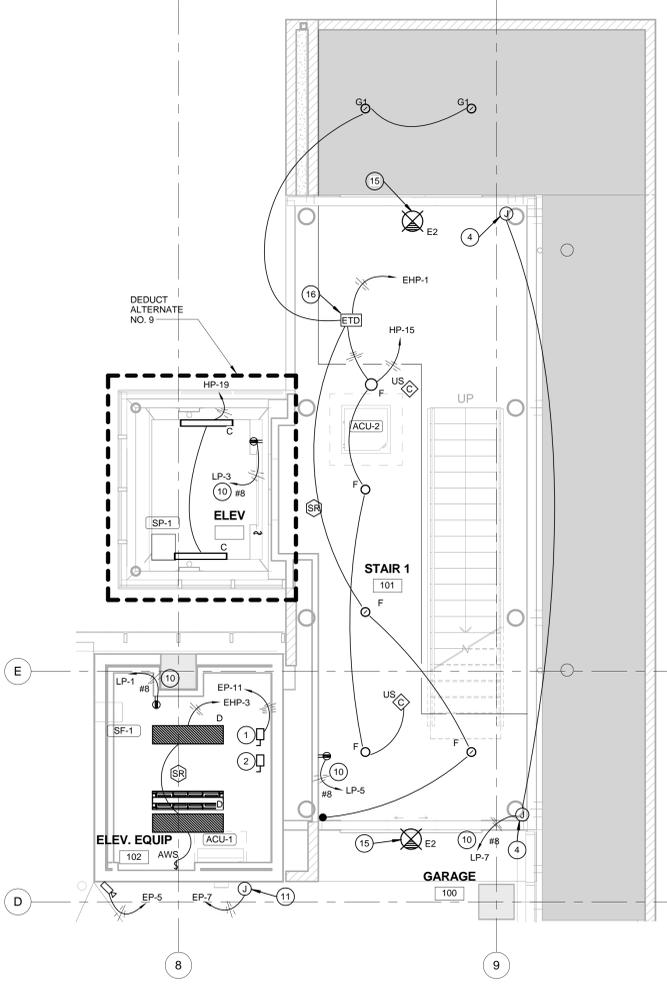


1 FIRST LEVEL NORTHEAST ENLARGED PLAN
1/4" = 1'-0"

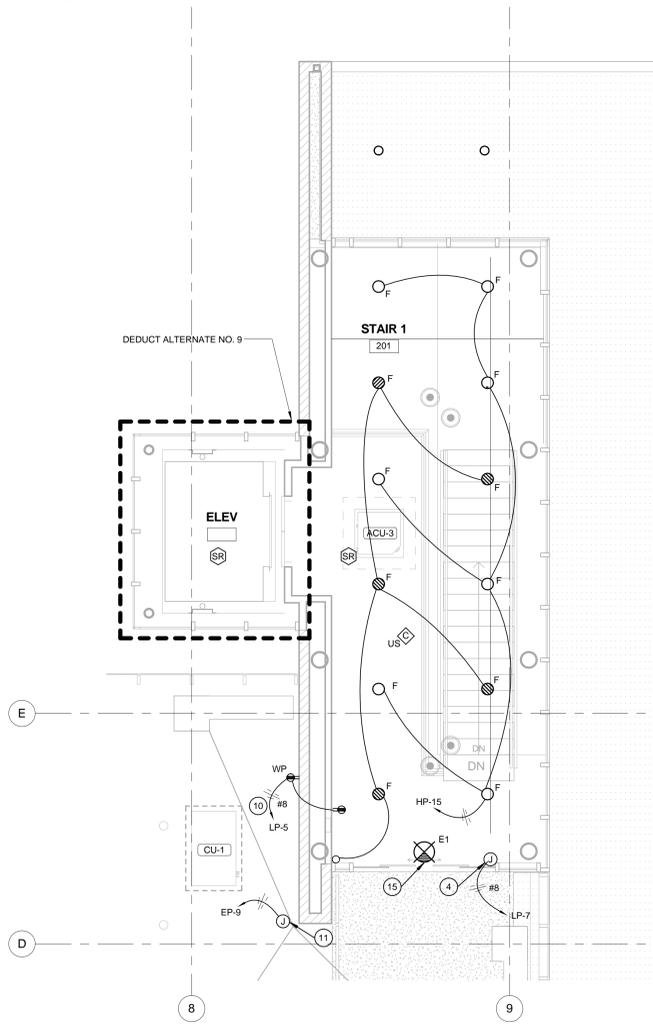

2 SECOND LEVEL NORTHEAST ENLARGED PLAN
1/4" = 1'-0"

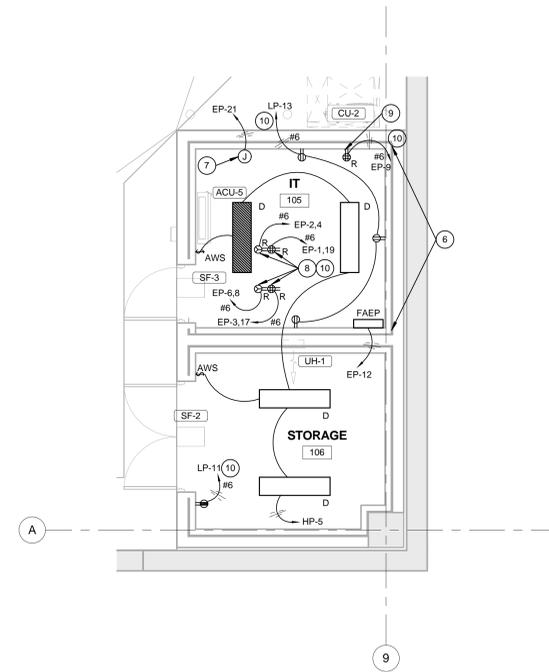

5 FIRST LEVEL SOUTHEAST ENLARGED PLAN
1/4" = 1'-0"

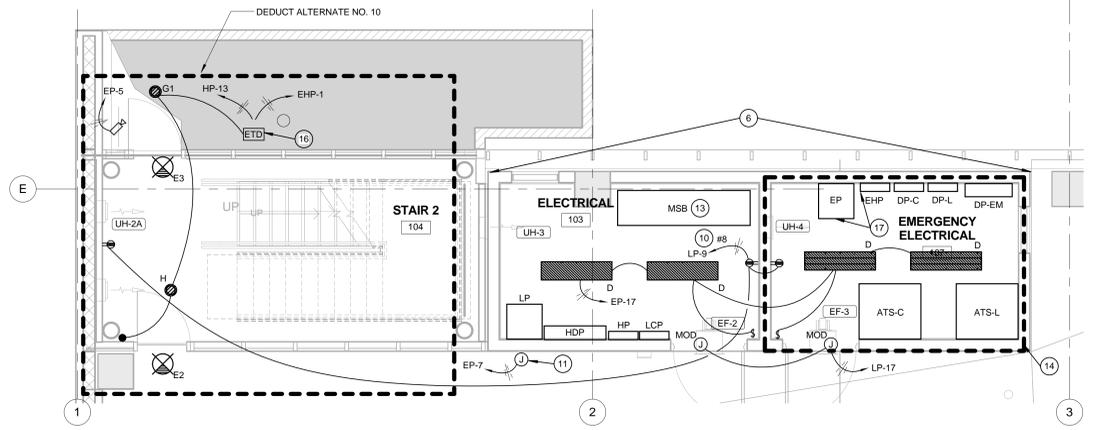

3 FIRST LEVEL NORTHWEST ENLARGED PLAN
1/4" = 1'-0"

General Notes

1. CONDUIT FOR EQUIPMENT IN PUBLIC AREAS OF GARAGE SHALL BE CONCEALED IN STRUCTURAL SLAB, COLUMNS, OR WALLS.
2. REFER TO ARCHITECTURAL DRAWINGS FOR LIGHTING AND OTHER EQUIPMENT LOCATIONS.

Key Notes

1. 30 AMP DISCONNECT SWITCH WITH 20 AMP FUSES FOR ELEVATOR CAB LIGHTING.
2. ELEVATOR DISCONNECT SWITCH, REFER TO ONE-LINE DIAGRAM. PROVIDE POWER WIRING TO ELEVATOR CONTROLLER AND/OR ELEVATOR MACHINE AS REQUIRED.
3. NOT USED.
4. POWER FOR AUTOMATIC DOOR OPERATOR. VERIFY REQUIREMENTS WITH DOOR MANUFACTURER PRIOR TO INSTALLATION.
5. MECHANICAL EQUIPMENT LOCATED ON ROOF ABOVE.
6. REFER TO ES-102 FOR DUCT BANK INFORMATION FOR THIS AREA.
7. POWER CONNECTION FOR DOOR SECURITY PANEL. REFER TO TE-SERIES DRAWINGS.
8. RECEPTACLES MOUNTED ON IT RACK POWER POLE. REFER TO DETAIL ON SHEET E-502 FOR REQUIREMENTS.
9. RECEPTACLE FOR IT WALLFIELD TO BE MOUNTED AT 48" AFF.
10. PROVIDE HOME RUN WIRE SIZE AS INDICATED. REFER TO E-001 FOR ADDITIONAL WIRING INFORMATION.
11. POWER CONNECTION FOR EMERGENCY PHONE TOWER. COORDINATE REQUIREMENTS WITH TELEDATA INSTALLER. REFER TO TE-SERIES DRAWINGS.
12. EMERGENCY POWER TRANSFER DEVICES MOUNTING LOCATION.
13. PROVIDE PLACARD INDICATING "GARAGE SERVICE SWITCH" ON CIRCUIT BREAKER SERVING PANEL, "HDP".
14. DISTRIBUTION EQUIPMENT IN EMERGENCY ELECTRICAL ROOM INSTALLED IN CLC PROJECT UNO. REFER TO ONE-LINE DIAGRAM.
15. EXIT SIGN CONNECTED TO EHP-1 AHEAD OF LIGHTING CONTROLS AND EMERGENCY POWER TRANSFER DEVICE.
16. EMERGENCY POWER TRANSFER DEVICE SHOWN HERE FOR CLARITY ONLY. MOUNT ON WALL IN EMERGENCY ELECTRICAL ROOM.
17. DISTRIBUTION EQUIPMENT PROVIDED IN THIS PROJECT. COORDINATE EMERGENCY PANEL INSTALLATION WITH CLC CONTRACTOR.

No.	Description	Date
DD#1		07/09/2012
DD#2		08/13/2012
CD#1		09/24/2012
CD#2		11/02/2012
	FINAL SUBMITTAL	05/07/2013
Revisions:		Date

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Drawing Title	
ELECTRICAL ENLARGED PLANS	
Approved: Project Director	

Project Title		
VA Erie Parking Structure		
Location Erie, PA		
Date	Checked	Drawn
9/24/2013	MSB	SRH
Project Number		Drawing Number
11159.00		E-401

Office of Construction and Facilities Management
Department of Veterans Affairs

FINAL SUBMITTAL