


three inches = one foot
one and one half inches = one foot
one inch = one foot
three quarters inch = one foot
one half inch = one foot
three eighths inch = one foot
one quarter inch = one foot
one eighth inch = one foot

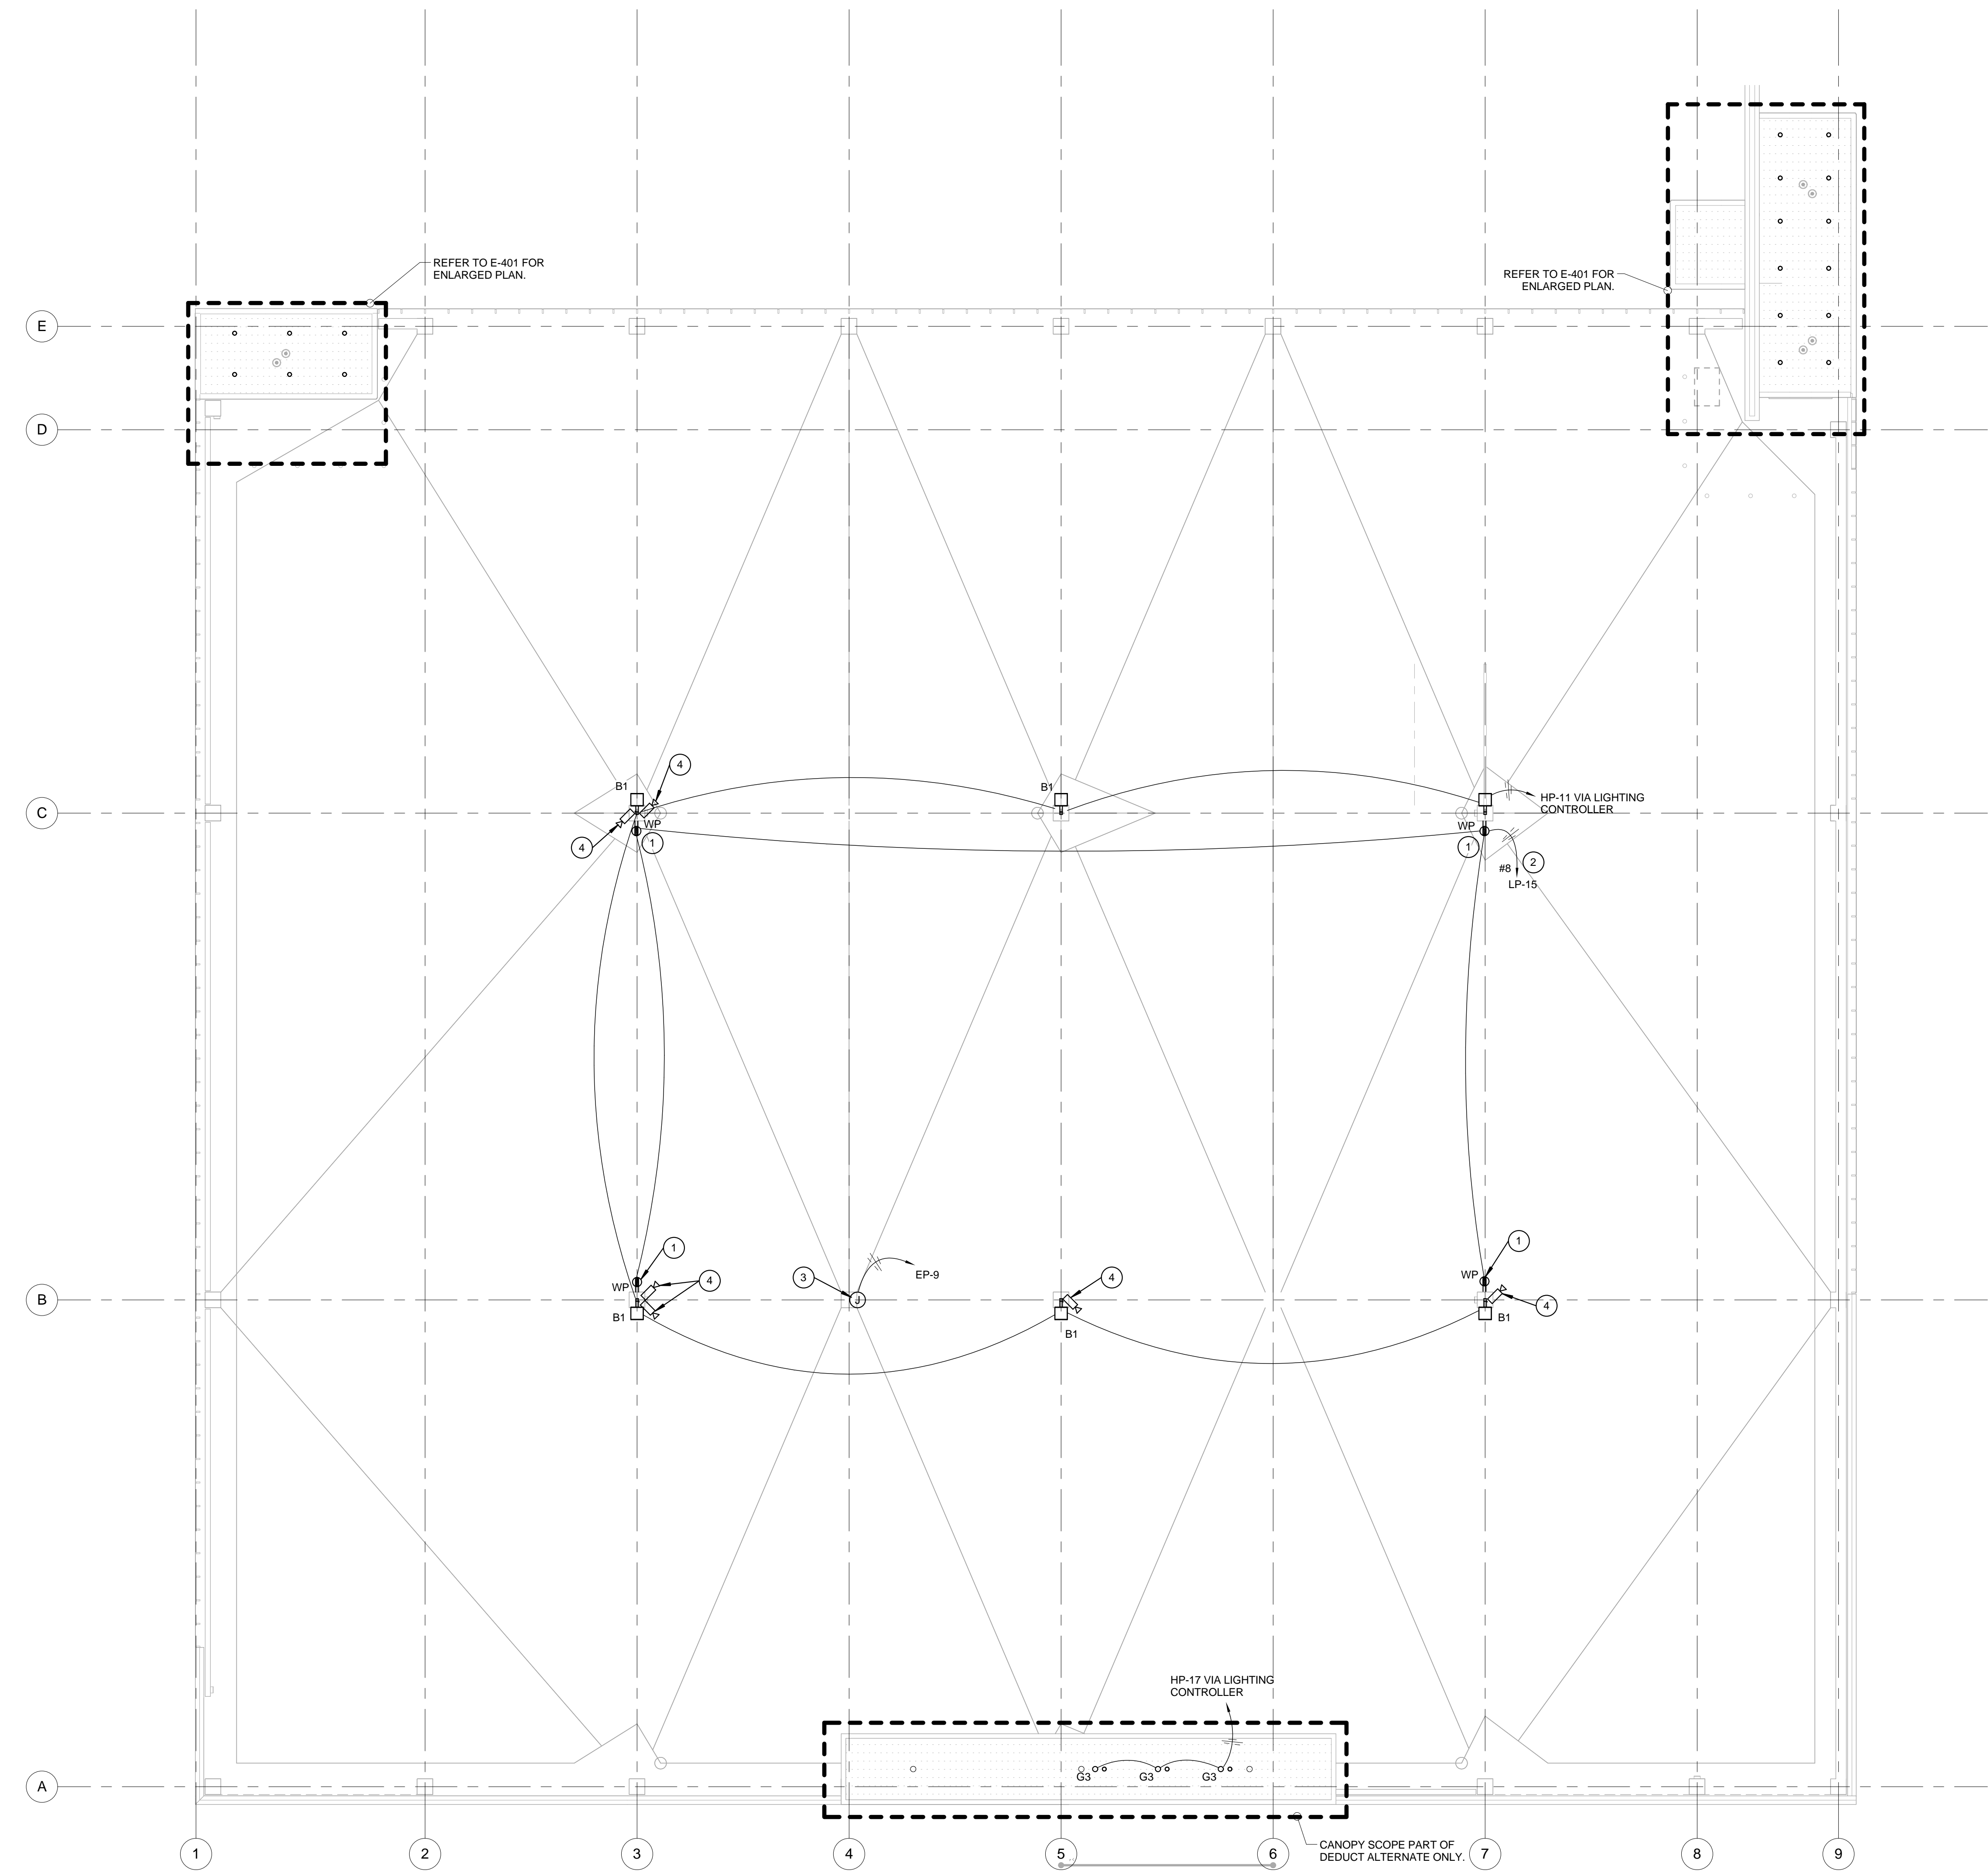

General Notes

Key Notes

1. CONCEAL CONDUIT AND WIRING TO RECEPTACLE FROM SLAB OR DECK IN COLUMN.
2. PROVIDE HOME RUN WIRE SIZE AS INDICATED. REFER TO E-001 FOR ADDITIONAL WIRING INFORMATION.
3. POWER CONNECTION FOR EMERGENCY PHONE TOWER. COORDINATE REQUIREMENTS WITH TELEDATA INSTALLER. REFER TO TE-SERIES DRAWINGS.
4. POLE MOUNTED CCTV CAMERA HEATERS. CONNECT TO CIRCUIT EP-23. REFER TO E-611 AND TE-SERIES DRAWINGS FOR MORE INFORMATION.

1 SECOND LEVEL ELECTRICAL PLAN
3/32" = 1'-0"

No.	Description	Date
	DD#1	07/09/2012
	DD#2	08/13/2012
	CD#1	09/24/2012
	CD#2	11/02/2012
	FINAL SUBMITTAL	05/07/2013
Revisions:		Date

CONSULTANTS

ARCHITECT/ ENGINEERS
Westlake Reed Leskosky

The Huntington Building
925 Euclid Avenue, Suite 1900
Cleveland, Ohio
44115-1407
216.522.1350

Drawing Title
LEVEL 2 ELECTRICAL PLAN

Approved: Project Director

Project Title
VA Erie Parking Structure

Location
Erie, PA

Date
9/24/2013

Checked
MSB

Drawn
SRH

Project Number
11159.00

Building Number

Drawing Number

E-102

FINAL SUBMITTAL

Office of
Construction
and Facilities
Management

