


three inches = one foot
 one and one half inches = one foot
 one inch = one foot
 three quarters inch = one foot
 one half inch = one foot
 one quarter inch = one foot
 three eighths inch = one foot
 one eighth inch = one foot
 one eighth inch = one foot

K:\201504 VA Lake City Upgrade EMS\1504_74_M112.dwg 2-27-14 06:29:13 PM dslanley

BID ITEM SUMMARY:
BASE BID: PROVIDE ALL EQUIPMENT AND WORK INDICATED ON PLANS.
BID ALTERNATE 1: SAME AS BASE BID, EXCEPT DEDUCT THE REPLACEMENT OF FLOOR/FIELD CONTROLLERS AND REUSE AND RECONFIGURE FOR NEW BAGNET. EXISTING PANELS TO BE EXAMINED. NEWER EXISTING PANELS SHALL BE RECONFIGURED TO WORK IN OPEN PROTOCOL BAGNET FORMAT. OLDER UNCONFIGURED / UNCONFIGURABLE PANELS SHALL BE REPLACED WITH NEW.
BID ALTERNATE 2: SAME AS BASE BID, EXCEPT DEDUCT THE CONVERSION OF ALL PNEUMATIC ACTUATED VALVES AND DAMPERS. PNEUMATIC CONTROLLERS TO BE UPDATED AND RECONFIGURED TO WORK IN OPEN PROTOCOL BAGNET FORMAT.


NOTE:
 THE CONTRACTOR IS RESPONSIBLE TO VERIFY, LOCATE, AND ACCOUNT FOR ALL EXISTING CONTROL POINTS, PANELS, AND CONTROLLERS. INSPECT ALL PANELS PRIOR TO REPLACEMENT AND / OR RECONFIGURATION.

NOTE:
 THE EXISTING VALVES SHOWN ARE APPROXIMATE SIZES ONLY. IT IS THE INTENT OF THE CONSTRUCTION DOCUMENT FOR THE EXISTING PNEUMATIC VALVE ACTUATORS TO BE UPGRADED TO DDC. THE EXISTING CONTROL VALVES ARE TO REMAIN IN SERVICE UNLESS OTHERWISE NOTED.

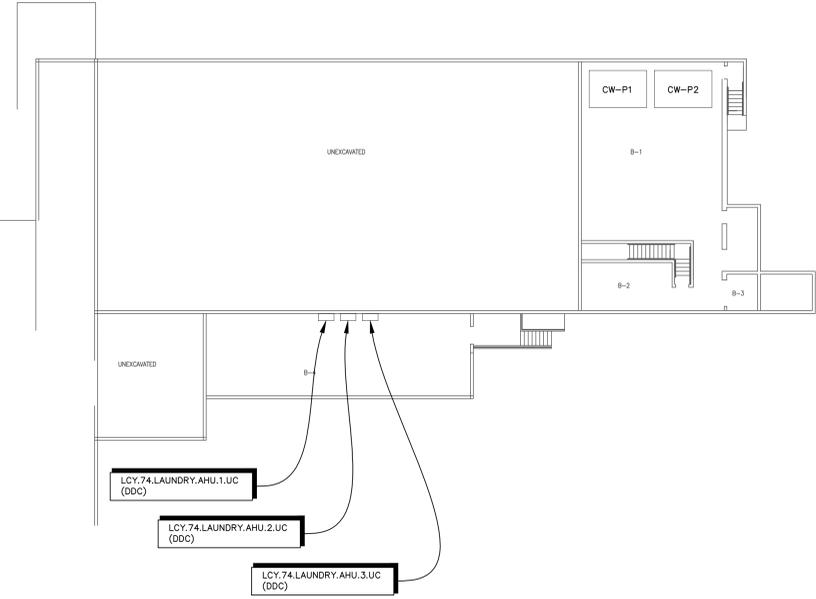

**BUILDING 74
 FLOOR PLAN - MECHANICAL
 BASEMENT**

SCALE: 1/16" = 1'-0"

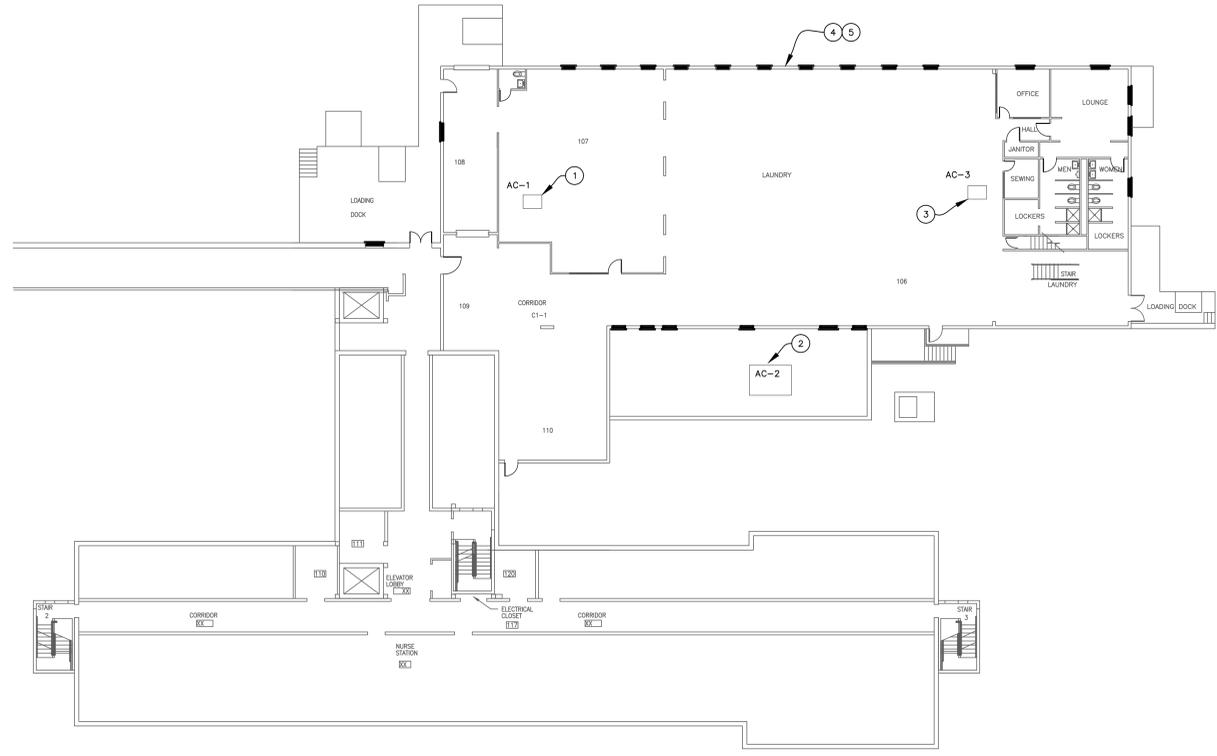

**BUILDING 74
 FLOOR PLAN - MECHANICAL
 FIRST FLOOR**

SCALE: 1/16" = 1'-0"

- MECHANICAL NOTES:**
- ① REFER TO SHEET MH407 DETAIL 1
 - ② REFER TO SHEET MH407 DETAIL 2
 - ③ REFER TO SHEET MH407 DETAIL 3
 - ④ REFER TO SHEET MH407 DETAIL 4
 - ⑤ REFER TO SHEET MH407 DETAIL 5

CONSULTANTS:

Mark E. Armitter, P.E.
 Florida PB No. 53973



ARCHITECT/ENGINEERS:



550 North Reo Street
 Suite 203, Tampa, FL 33609
 813.289.4700
 COA # 8304

Drawing Title
 BUILDING 74 FLOOR
 PLAN - MECHANICAL

Approved Project Director

Project Title
 UPGRADE EMS

Location
 LAKE CITY, FLORIDA

Date
 01/03/2014

Checked
 MEA

Drawn
 DKS

Project Number
 573A-12-200

Building Number

Drawing Number
 MH110
 Dwg. 12 of 30

FINAL BID DOCUMENTS

Office of
 Construction
 and Facilities
 Management

