




one-eighth inch = one foot  
one-quarter inch = one foot  
three-eighths inch = one foot  
one-half inch = one foot  
three-quarters inch = one foot  
one inch = one foot

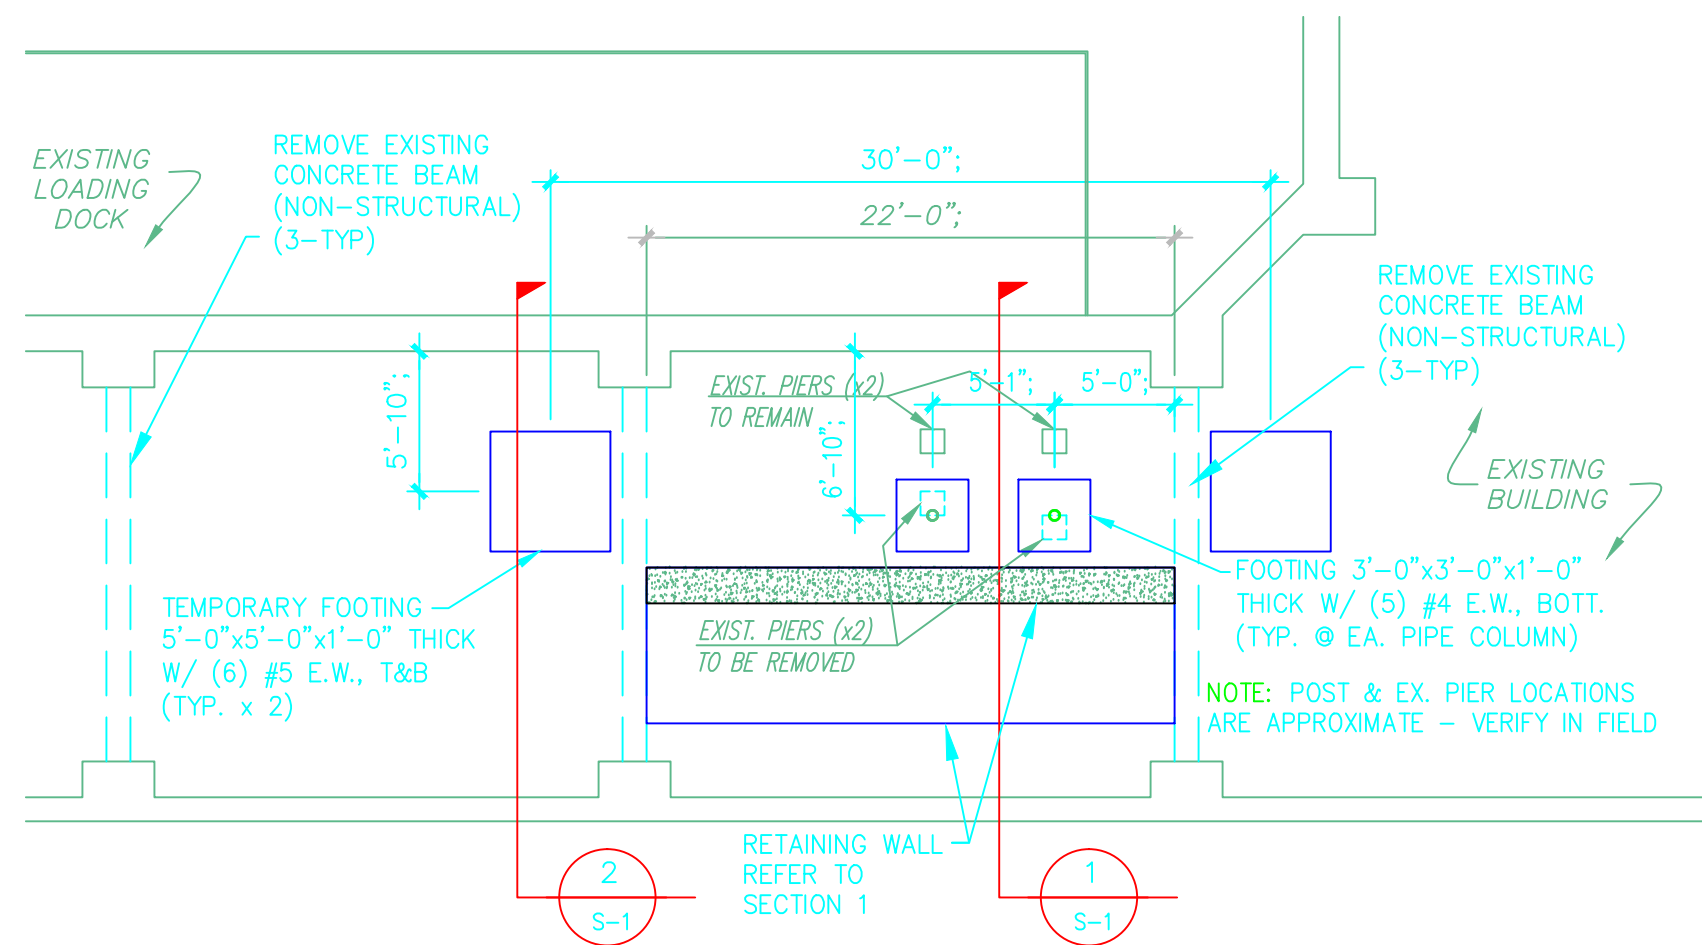

FOOTINGS & RETAINING WALL PLAN

SCALE: 1/8" = 1'-0"



- 1.) EXCAVATE EXISTING SOIL AS REQUIRED TO INSTALL FOOTINGS.
- 2.) BOTTOM OF ALL FOOTINGS TO SIT ON LEVEL, UNDISTURBED SOIL. IMMEDIATELY NOTIFY RESIDENT ENGINEER OF ANY DISCREPANCY FOUND.

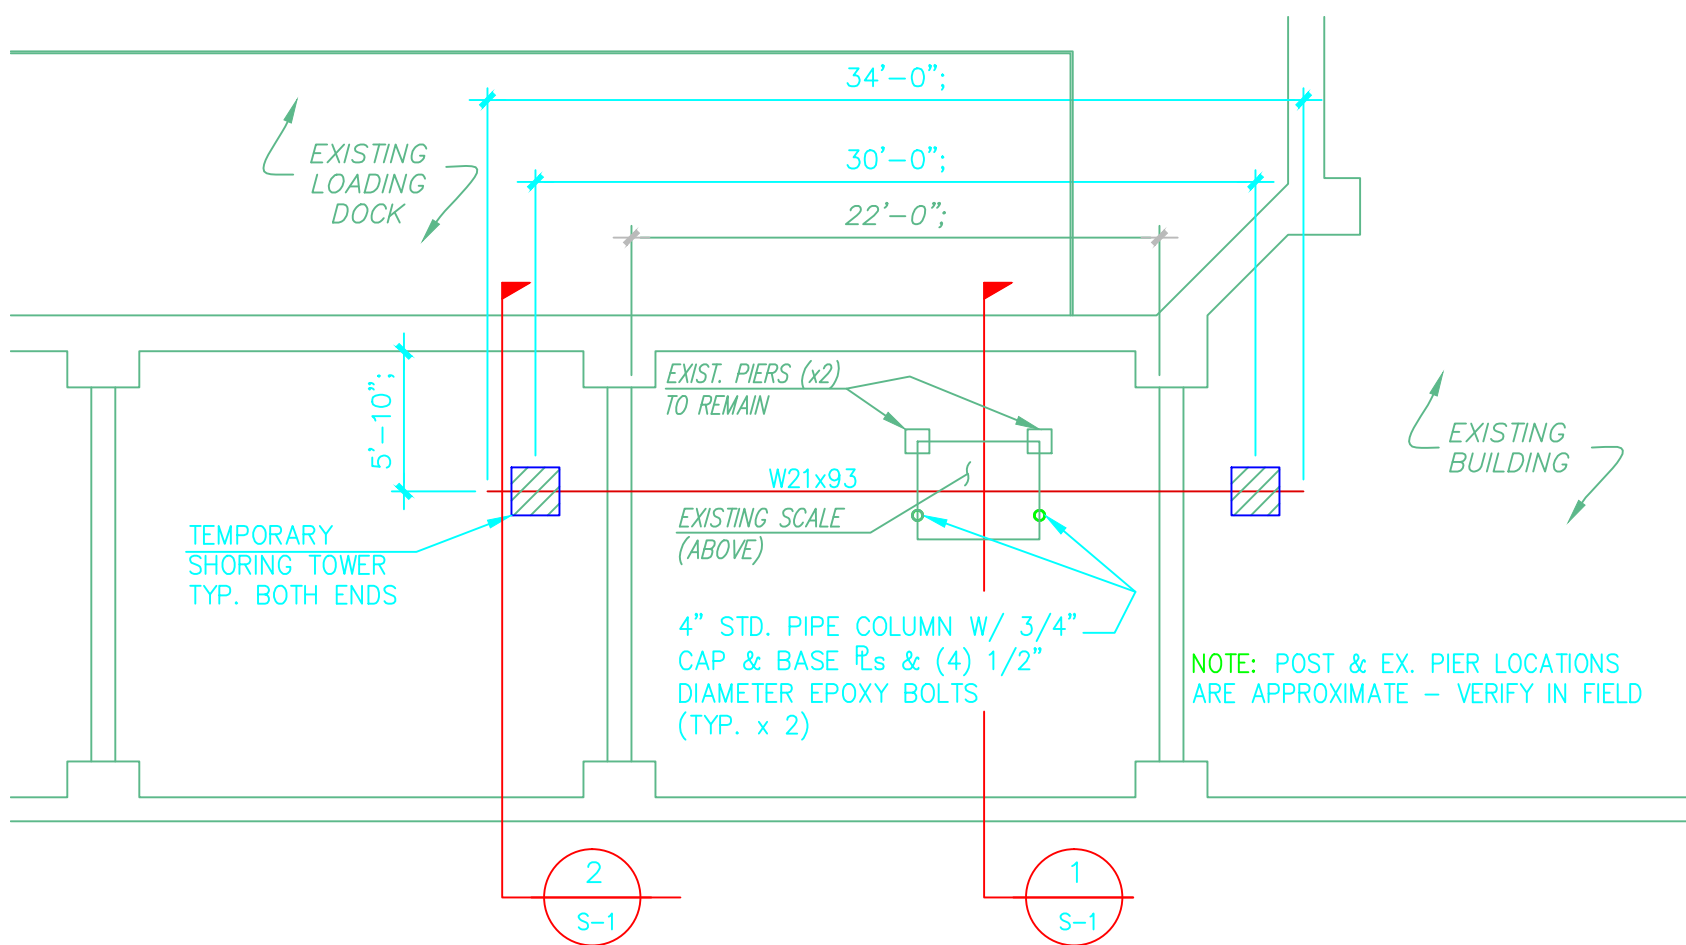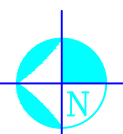

PARTIAL FRAMING PLAN



SCALE: 1/8" = 1'-0"

- 1.) INSTALL NEW BEAM (-2") FROM UNDERSIDE OF EX. CONSTRUCTION. DRY PACK SOLID W/ NON-SHRINK GROUT. RELOCATE/RESUPPORT INTERFERING CONDUIT AS REQUIRED.

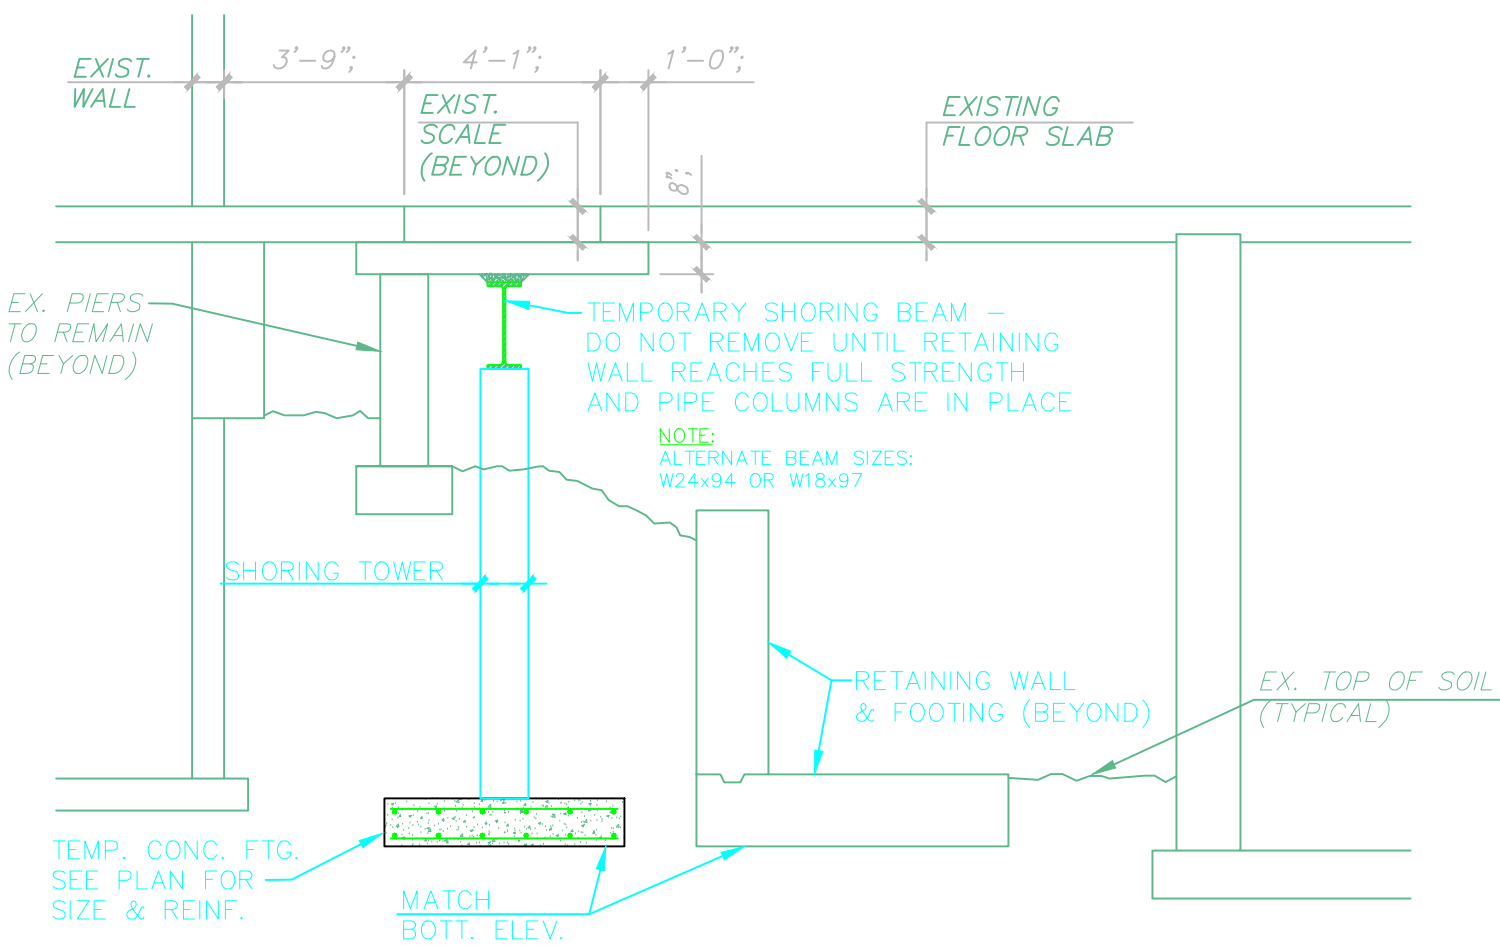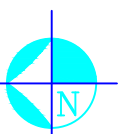



SECTION 2

SCALE: 1/4" = 1'-0"

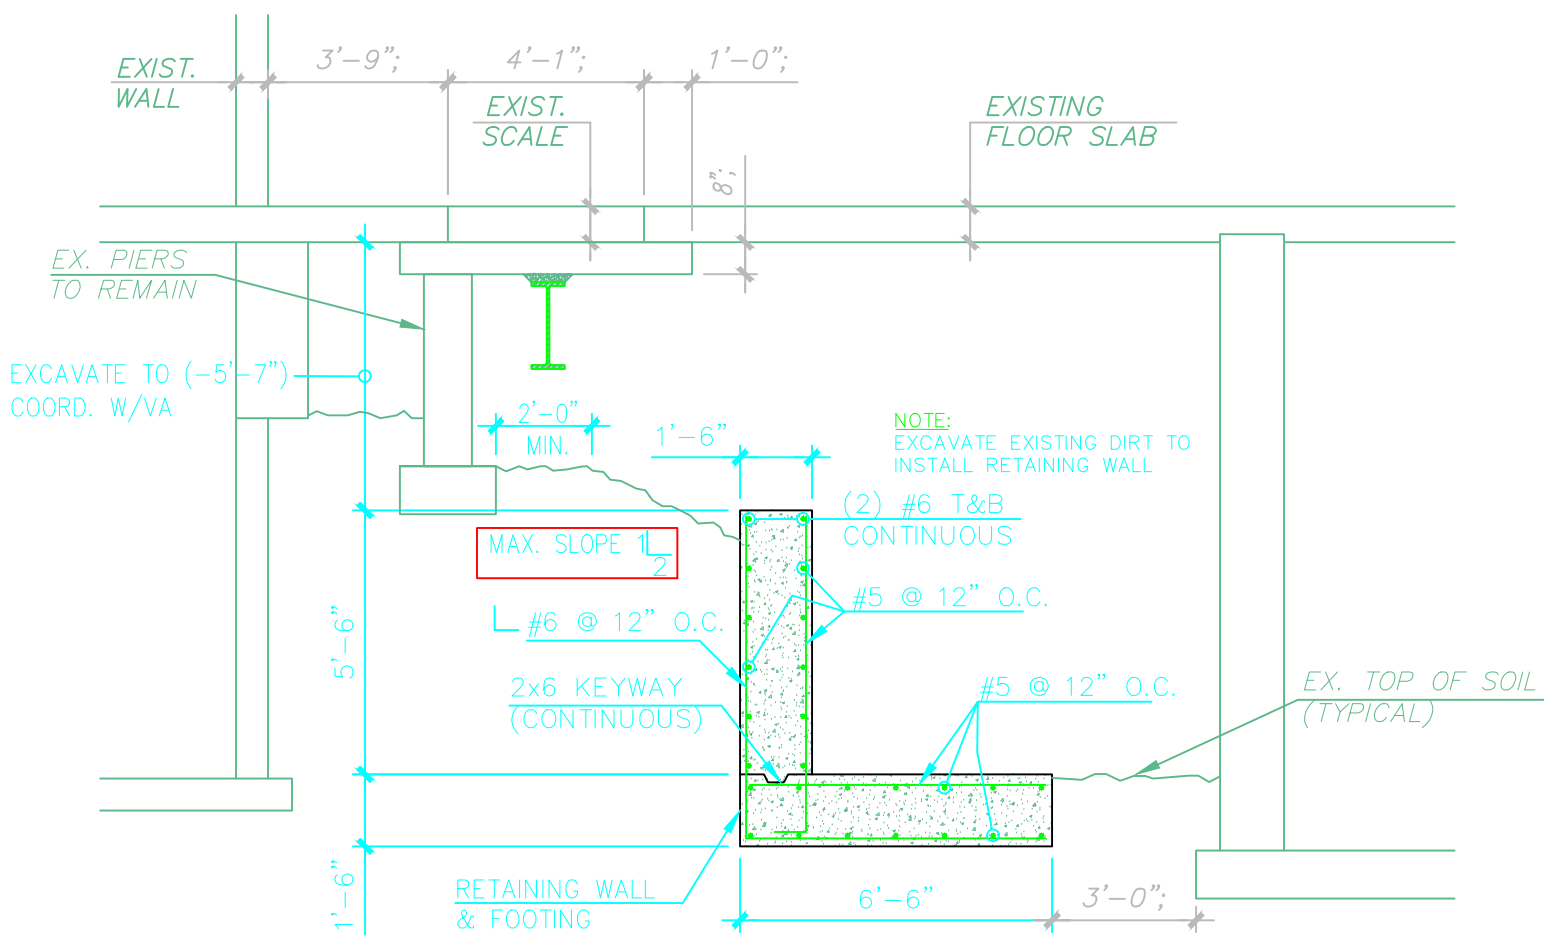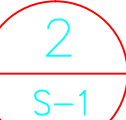

SECTION 1

SCALE: 1/4" = 1'-0"

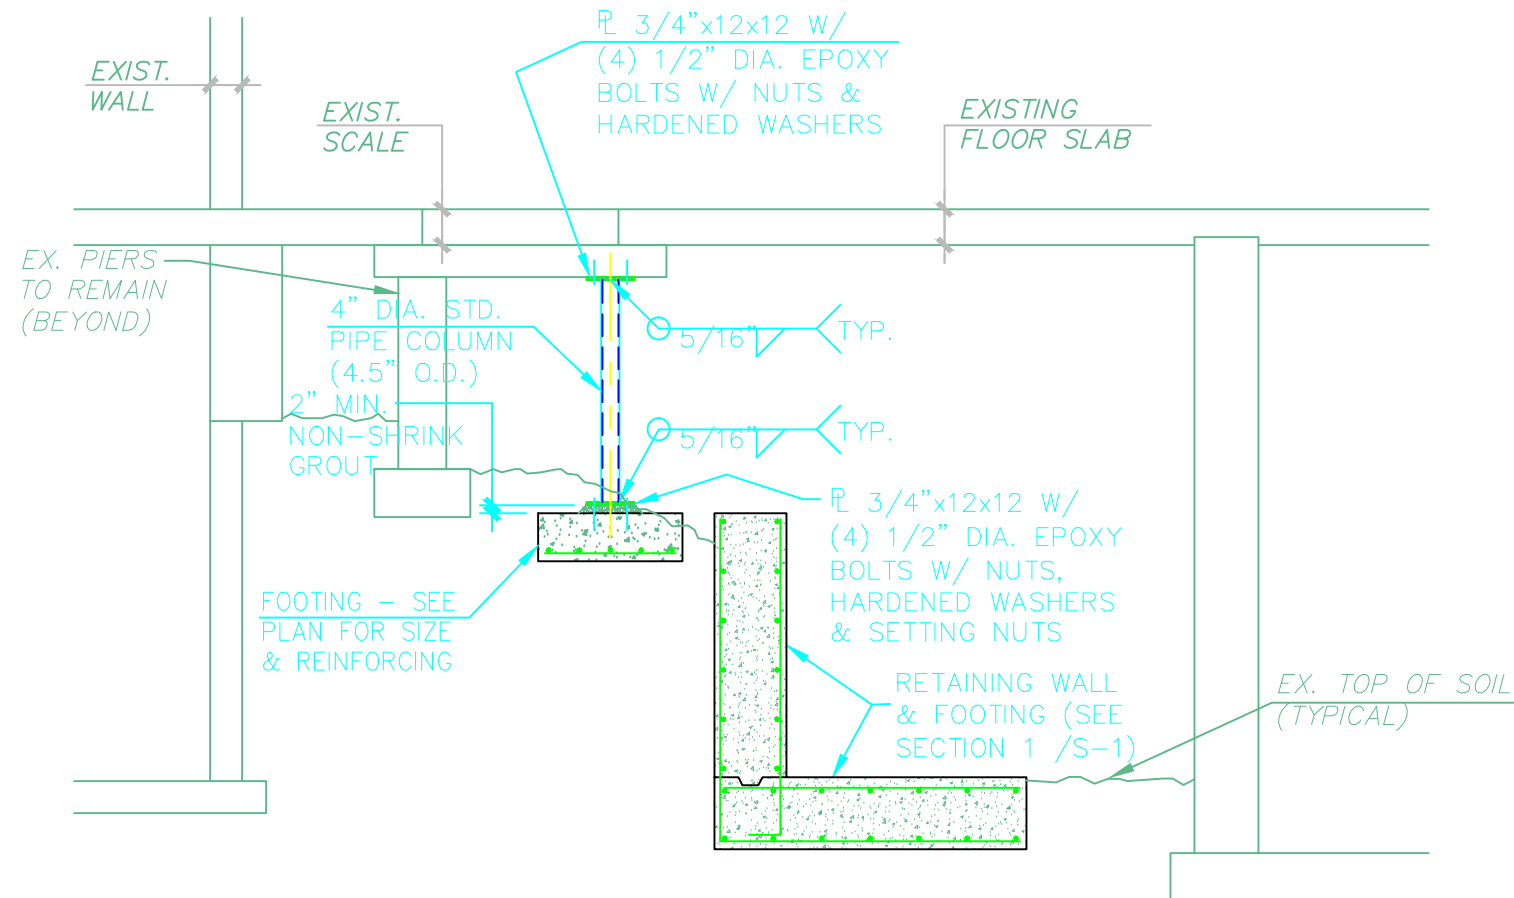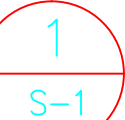

PIPE COLUMN DETAILS

SCALE: 1/4" = 1'-0"


GENERAL NOTES:

- 1.) ALL WIDE-FLANGE STRUCTURAL STEEL SHAPES TO BE ASTM A992. ALL PIPE COLUMNS TO BE ASTM A53, GRADE B. ALL OTHER STEEL SHAPES AND PLATES TO BE ASTM A-36 (Fy = 36 ksi MIN.).
- 2.) DETAIL, FABRICATE, & INSTALL ALL STEEL IN CONFORMANCE WITH APPLICABLE AISC, NYS DOL, & OSHA STANDARDS.
- 3.) CONTRACTOR TO VERIFY ALL CONDITIONS AND DIMENSIONS IN FIELD. IMMEDIATELY NOTIFY RESIDENT ENGINEER OF ANY DISCREPANCY FOUND.
- 4.) PROVIDE SHORING / BRACING / PROTECTION OF EXISTING CONSTRUCTION AS REQ'D.
- 5.) STEEL SHALL NOT BE FABRICATED UNTIL EXISTING FIELD CONDITIONS & DIMENSIONS ARE VERIFIED.
- 6.) ALL PERMANENT STEEL TO BE FIREPROOFED. REFER TO SPECIFICATIONS.

STRUCTURAL DESIGN CRITERIA


NOTE: ALL LOADS SHALL BE DETERMINED IN ACCORDANCE WITH THE "BUILDING CODE OF NEW YORK STATE" (2010)

TYPE	DESCRIPTION	DESIGN CRITERIA
FLOOR LIVE LOAD	PUBLIC SPACE	100 PSF
ROOF LIVE LOAD		NOT APPLICABLE
SNOW LOAD		NOT APPLICABLE
WIND LOAD (MAIN WIND RESISTING SYSTEM)		NOT APPLICABLE
WIND LOAD (COMPONENTS & CLADDINGS)		NOT APPLICABLE
EARTHQUAKE LOAD		NOT APPLICABLE

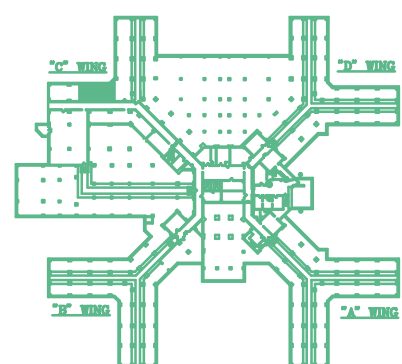

KEYPLAN

SCALE: N.T.S.

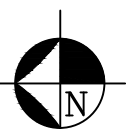

VA WESTERN NEW YORK HEALTHCARE SYSTEM 3495 BAILEY AVENUE BUFFALO, NEW YORK 14215	
Issue For Bid	02/03/14
Revisions	Date

CLINICAL ENGINEERING	DATE	ENGINEERING MANAGER	DATE
INFECTION CONTROL	DATE	CARELINE MANAGER	DATE
SAFETY OFFICER	DATE	CHIEF OF STAFF	DATE

Drawing Title	PLANS AND SECTIONS
Project Title	SCALE SUPPORT
MEDICAL CENTER DIRECTOR	DATE
ASSOCIATE MEDICAL CENTER DIRECTOR	DATE

Building Number	1
Checked DTC	
Drawn KMH	
Location	V.A.M.C. BUFFALO, NEW YORK

Date	February 3, 2014
Station No.	528
14-s21	S-1

