


FARGO VA HEALTH CARE SYSTEM EXPAND IMAGING AND LAB

Fargo, North Dakota

Project Number: 437-CSI-105

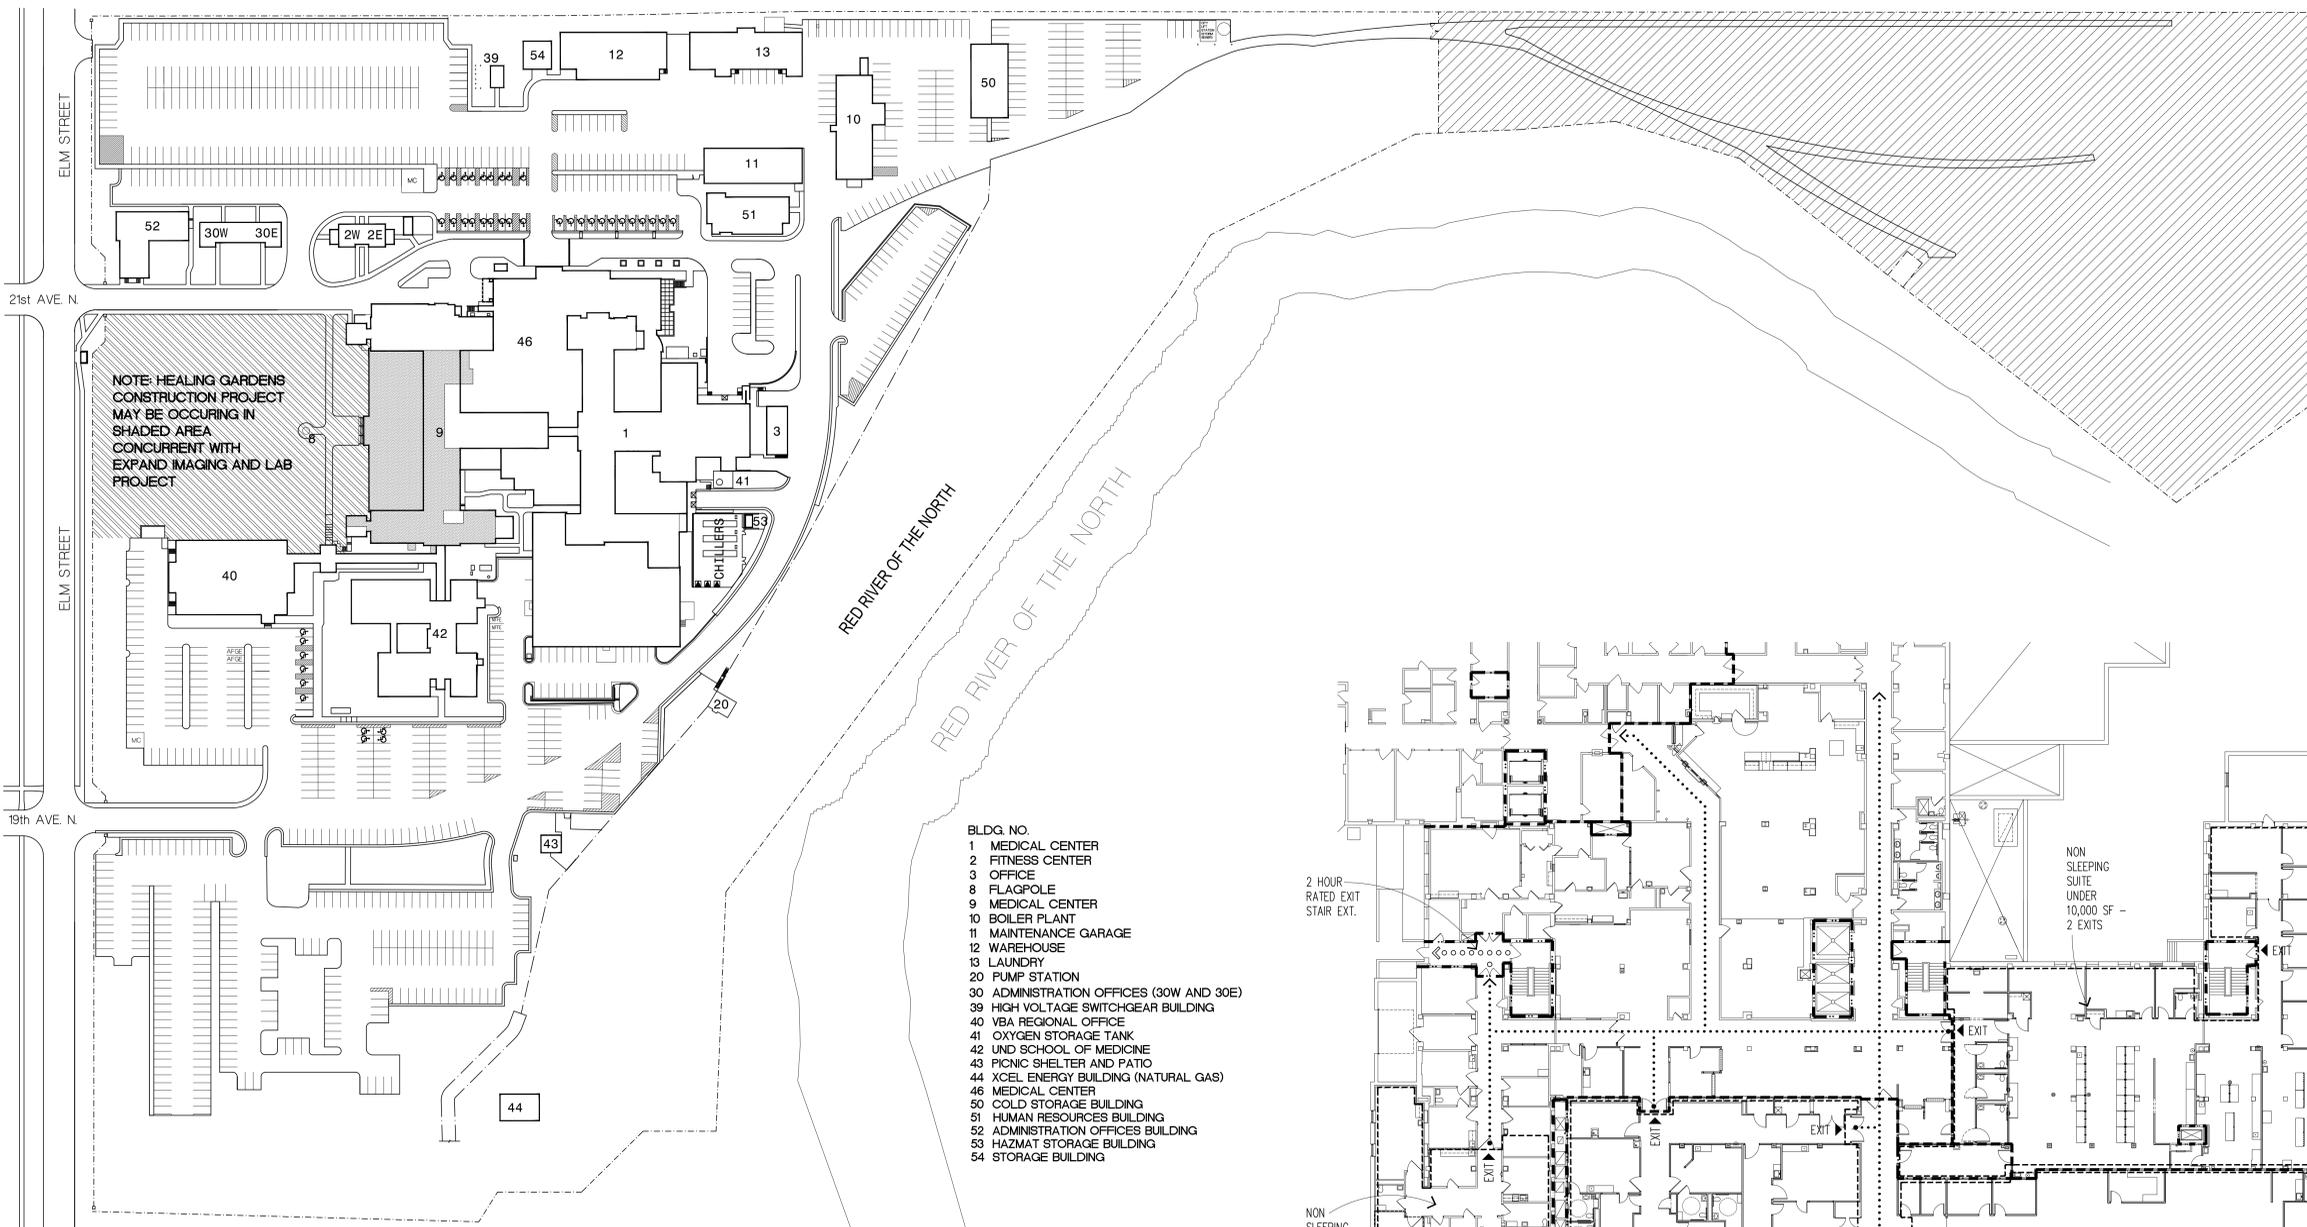


KEY TO SITE PLAN

CONTRACTOR STAGING AREA. SHARED WITH VA AND OTHER CONTRACTORS.

CONSTRUCTION AREA

SITE PLAN
1"-60'-0"

- BLDG. NO.**
- 1 MEDICAL CENTER
 - 2 FITNESS CENTER
 - 3 OFFICE
 - 8 FLAGPOLE
 - 9 MEDICAL CENTER
 - 10 BOILER PLANT
 - 11 MAINTENANCE GARAGE
 - 12 WAREHOUSE
 - 13 LAUNDRY
 - 20 PUMP STATION
 - 30 ADMINISTRATION OFFICES (30W AND 30E)
 - 39 HIGH VOLTAGE SWITCHGEAR BUILDING
 - 40 VBA REGIONAL OFFICE
 - 41 OXYGEN STORAGE TANK
 - 42 UND SCHOOL OF MEDICINE
 - 43 PICNIC SHELTER AND PATIO
 - 44 XCEL ENERGY BUILDING (NATURAL GAS)
 - 46 MEDICAL CENTER
 - 50 COLD STORAGE BUILDING
 - 51 HUMAN RESOURCES BUILDING
 - 52 ADMINISTRATION OFFICES BUILDING
 - 53 HAZMAT STORAGE BUILDING
 - 54 STORAGE BUILDING

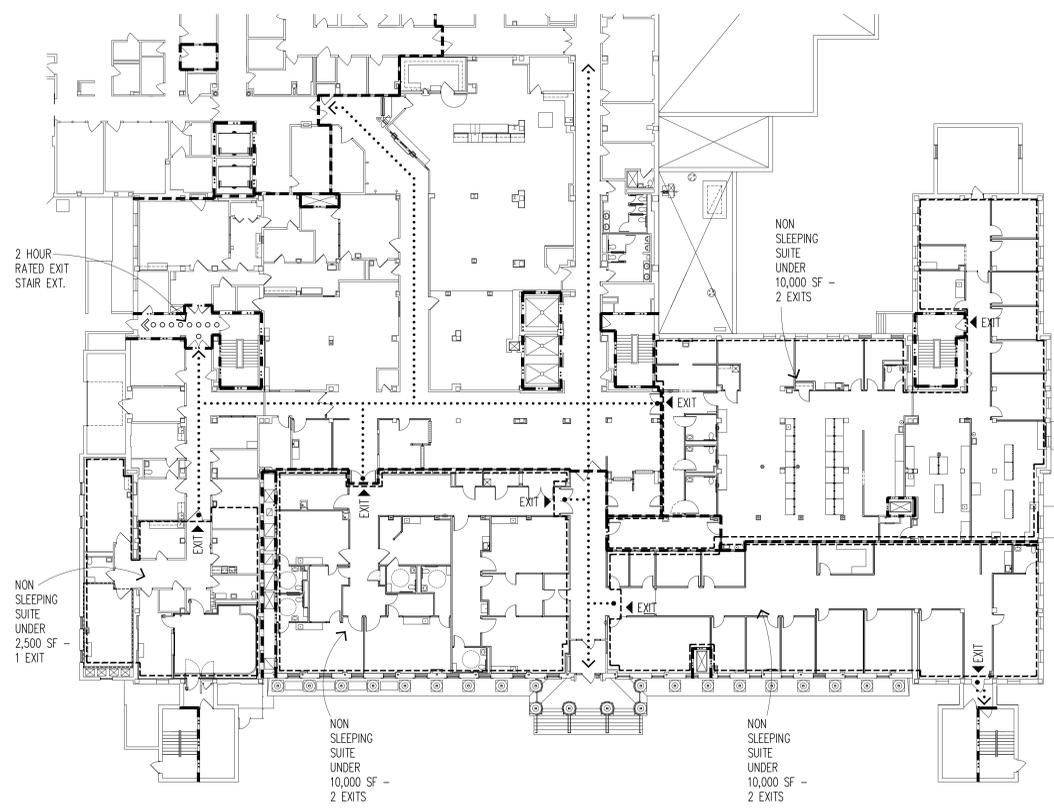

FIRST FLOOR EXIT ANALYSIS
1"-20'-0"

- GENERAL**
- X1 COVER SHEET
 - X2 SYMBOLS, LEGEND, ABBREVIATIONS AND GENERAL NOTES
 - X3 PHASING PLANS
- ARCHITECTURAL**
- A1 FIRST FLOOR DEMOLITION PLAN
 - A2 FIRST FLOOR REMODELING PLAN
 - A2.1 FIRST FLOOR DIMENSION PLAN
 - A3 IMAGING EQUIPMENT PLAN
 - A4 LABORATORY EQUIPMENT PLAN
 - A5 DIRECTOR'S SUITE EQUIPMENT PLAN AND COLOR LOCATION DIAGRAM
 - A6 SCHEDULES
 - A7 INTERIOR ELEVATIONS
 - A8 INTERIOR ELEVATIONS AND DETAILS
 - A9 BUILDING SECTIONS AND DETAILS
 - A10 BASEMENT REFLECTED CEILING DEMOLITION PLAN
 - A11 FIRST FLOOR REFLECTED CEILING DEMOLITION PLAN
 - A12 FIRST FLOOR REFLECTED CEILING PLAN
 - A13 FIRST FLOOR SIGNAGE DEMOLITION PLAN
 - A14 FIRST FLOOR SIGNAGE PLAN
- ASBESTOS ABATEMENT**
- AB1 FIRST FLOOR ASBESTOS ABATEMENT PLAN
- STRUCTURAL**
- S1 FIRST FLOOR EQUIPMENT SUPPORT
 - S2 SECOND FLOOR EQUIPMENT SUPPORT
- FIRE PROTECTION**
- FP1 BASEMENT AND FIRST FLOOR FIRE PROTECTION DEMOLITION PLANS
 - FP2 BASEMENT AND FIRST FLOOR FIRE PROTECTION PLANS
- PLUMBING**
- P1 BASEMENT PLUMBING DEMOLITION PLAN
 - P2 FIRST FLOOR PLUMBING DEMOLITION PLAN
 - P3 FIRST FLOOR MEDICAL GAS DEMOLITION PLAN
 - P4 BASEMENT PLUMBING PLAN
 - P5 FIRST AND SECOND FLOOR PLUMBING PLANS
 - P6 FIRST FLOOR MEDICAL GAS PLAN
- HVAC**
- H1 LARGE SCALE MECHANICAL ROOM HVAC PIPING DEMOLITION PLANS
 - H2 FIRST FLOOR HVAC PIPING DEMOLITION PLAN
 - H3 FIRST FLOOR VENTILATION DEMOLITION PLAN
 - H4 LARGE SCALE MECHANICAL ROOM HVAC PIPING REMODELING PLAN
 - H5 FIRST AND SECOND FLOOR HVAC PIPING PLANS
 - H6 LARGE SCALE MECHANICAL ROOM VENTILATION PLAN AND SECTIONS
 - H7 FIRST FLOOR VENTILATION PLAN
 - H8 MECHANICAL ROOF PLAN
 - H9 IMAGING/ADMINISTRATION HEATING PIPING SCHEMATIC
 - H10 HVAC PIPING SCHEMATICS
 - H11 MECHANICAL DETAILS
 - H12 PLUMBING RISERS AND MECHANICAL ABBREVIATIONS AND SYMBOLS
 - H13 MECHANICAL SCHEDULES
 - H14 MECHANICAL CONTROL DIAGRAMS
- ELECTRICAL**
- E1 ELECTRICAL SYMBOLS LEGEND AND LUMINAIRE SCHEDULE
 - E2 BASEMENT CEILING PLAN - ELECTRICAL
 - E3 BASEMENT AND FIRST FLOOR DEMOLITION PLAN - ELECTRICAL
 - E4 FIRST FLOOR REMODELING PLAN - LIGHTING
 - E5 FIRST FLOOR REMODELING PLAN - POWER
 - E6 LARGE SCALE FIRST FLOOR REMODELING PLAN - POWER MECHANICAL ROOMS - POWER
 - E7 FIRST FLOOR REMODELING PLAN - SYSTEMS
 - E8 CT SCAN - ELECTRICAL PLAN, NOTES AND DETAILS
 - E9 CT SCAN - POWER SCHEMATIC AND DETAILS
 - E10 RADIOGRAPHIC FLUOROSCOPIC - ELECTRICAL PLAN, NOTES AND DETAILS
 - E11 RADIOGRAPHIC - ELECTRICAL PLAN, NOTES AND DETAILS
 - E12 RADIOGRAPHIC - ELECTRICAL PLAN, NOTES AND DETAILS
 - E13 CHEST ROOM - ELECTRICAL PLAN, NOTES AND DETAILS
 - E14 EXISTING ELECTRICAL ONE-LINE DIAGRAM
 - E15 REVISED ELECTRICAL ONE-LINE DIAGRAM
 - E16 ELECTRICAL SCHEDULES
 - E17 ELECTRICAL SCHEDULES
 - E18 ELECTRICAL DETAILS

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Dept. of Veterans Affairs
Health Care System
2101 Elm Street North
Fargo, ND 58102

IMAGE GROUP
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403 CENTER AVENUE, SUITE 300
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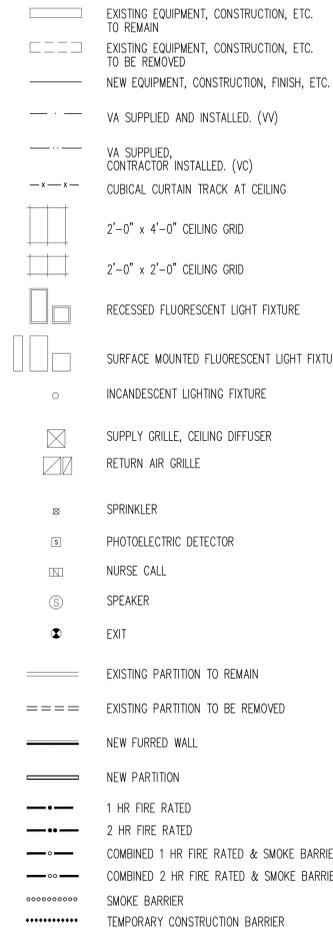
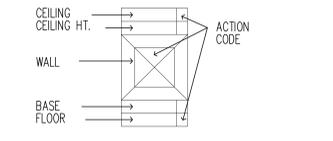
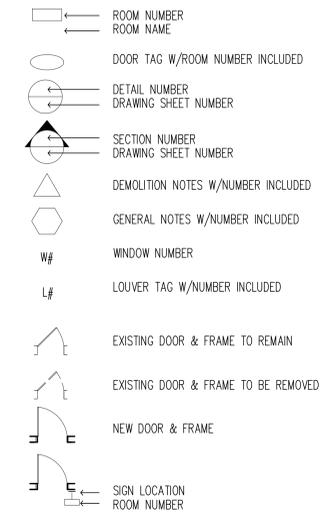
IMAGE GROUP INC., Architecture & Interiors
SOLEN & LARSON ENGINEERING, Structural Engineers
OBERMILLER NELSON ENGINEERING, Mechanical Engineers
MEN ENGINEERING, Electrical Engineers
TRIO ENVIRONMENTAL, Environmental Consultants

I hereby certify that this plan specification, or report was prepared by me or under my direct supervision, and that I am duly Registered Architect under the laws of the State of North Dakota.


Russell M. Mays
Date: 1/31/2014 Reg. No. 378

Drawing Title COVER SHEET		Project Title EXPAND IMAGING AND LABORATORY		Date JANUARY 31, 2014	Department of Veterans Affairs
VA Project No. 437-CSI-105		Contract No. VA263-P-1217 VA263-C		Scale AS SHOWN	
Building No. 9, 46	AutocAD File Name COVERDWG	Designed By RM	Checked By RM	Drawn By KS	
Location FARGO VA HEALTH CARE SYSTEM FARGO, ND		Drawing No. X1		Dwg. 1 of 61	

DRAFTING SYMBOLS



GENERAL MATERIALS

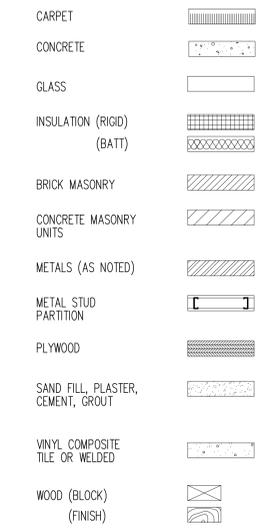

STANDARD ABBREVIATIONS

AB	ANCHOR BOLT	(N)	NEW
A/C	AIR CONDITIONED	NIC	NOT IN CONTRACT
ACT	ACOUSTICAL CEILING TILE	NL	NEOPRENE LATEX
ADU	AIR CONDITIONING UNIT	NOM	NOMINAL
AD	ACCESS DOOR		
ADJ	ADJUSTABLE	OC	ON CENTER
ADD	AUTOMATIC DOOR OPERATOR	OD	OUTSIDE DIMENSION
AFF	ABOVE FINISHED FLOOR	OPG	OPENING
ALUM	ALUMINUM		
AP	ACCESS PANEL	P	PAINT
ARCH	ARCHITECTURAL	PART	PARTITION
AT	ACOUSTICAL TILE	PBPU	PATIENT BEDSIDE POWER UNIT
		PH	PHARMACY FURNITURE
		PL	PLASTER
		PTD	PAPER TOWEL DISPENSER
		PMP	PREFINISHED METAL PARTITION
BB	BULLETIN BOARD	QT	QUARRY TILE
BD	BOARD		
BLDG	BUILDING		
		(R)	REMOVE
CONC	CONCRETE	RCP	RADIANT CEILING PANEL
CAB	CABINET	(REL)	RELOCATE(D)
CB	CHALK BOARD	REQ'D	REQUIRED
CC	MATERIAL & INSTALLATION BY CONTRACTOR	REV	REVERSE
		RM	ROOM
CCT	CUBICLE CURTAIN TRACK	RO	ROUGH OPENING
CCU	CORONARY CARE UNIT		
CEM	CEMENT	SBP	SMOKE BARRIER PARTITION
CI	CAST IRON	SCHED	SCHEDULE
CG	CORNER GUARD	SFTU	STRUCTURAL FACING TILE UNIT
CJ	CONTROL JOINT	SIM	SIMILAR
CLC	CEILING	SPE	SPECIFIC ONE
CLG	CLEAR GLASS	SS	STAINLESS STEEL
CLGL	CLOSET	SV	SHEET VINYL
CMU	CONCRETE MASONRY UNIT	SVT	SOLID VINYL TILE
COL	COLUMN		
CONST	CONSTRUCTION	TEL	TELEPHONE
CPT	CARPET	TER	TERRAZZO
CT	CERAMIC TILE	TOIL	TOILET
CTR	COUNTER		
		VIN	VINYL
DET	DETAIL	VC	MATERIAL BY V.A., INSTALLED BY CONTRACTOR
DF	DRINKING FOUNTAIN	VCT	VINYL COMPOSITION TILE
DIA	DIAMETER	VL	LAB FURNITURE
DIAG	DIAGONAL	VP	VINYL PLANK
DIM	DIMENSION	VS	STERILIZATION EQUIPMENT
DISP	DISPENSER	VV	MATERIAL AND INSTALLATION BY V.A.
DL	DENTAL LABORATORY	VWC	VINYL WALL COVERING
DS	DOWN SPOUT		
DSB	DOUBLE STRENGTH "B"	W	WALL COVERING
DW	QUALITY GLASS	WC	WATER CLOSET
DWC	DUMBEWAITER DRAWING	W/C	WHEEL CHAIR
		WD	WOOD
EEG	ELECTRO ENCEPHALOGRAPHIC	WI	WROUGHT IRON
EU	EXPANSION JOINT	WVF	WELDED VINYL FLOORING
EKG	ELECTRO CARDIOGRAPH		
ELEV	ELEVATION, ELEVATOR		
ELEC	ELECTRICAL		
ENT	EAR, NOSE, & THROAT		
EP	ELECTRICAL PANEL		
EPY	EPOXY		
EQUIP	EQUIPMENT		
EXIST	EXISTING		
EXP	EXPOSED EXPANSION		
EXT	EXPOSED STRUCTURE		
EXT	EXTERIOR		
EW	ELECTRICAL WATER COOLER		
EIFS	EXTERIOR INSULATION & FINISHING SYSTEM		
FAC	FIRE APPARATUS CLOSET		
FCU	FAN COIL UNIT		
FD	FLOOR DRAIN		
FI	FILM ILLUMINATOR		
FL	FINISH		
FL	PHOTOGRAPHIC DARK ROOM EQUIPMENT		
FLASH	FLASHING		
FS	FULL SIZE		
FEC	FIRE EXTINGUISHER CABINET		
GA	GAUGE		
GALV	GALVANIZED		
GB	GRAB BAR		
GC	GENERAL CONTRACTOR		
GWB	GYP/SUM WALL BOARD		
H	LABORATORY FUME HOOD		
HAC	HOUSEKEEPING AIDES CLOSET		
HM	HOLLOW METAL		
HT	HEIGHT		
HDW	HARDWARE		
HSP	HIGH STRENGTH PLASTER		
HW	LAB WASHING EQUIPMENT		
HR	HANDRAIL		
ICU	INTENSIVE CARE UNIT		
ID	INSIDE DIAMETER		
INSUL	INSULATION		
INT	INTERIOR		
IPU	ISOLATED POWER UNIT		
IV	INTRA-VENOUS		
JT	JOINT		
K	KITCHEN EQUIPMENT		
KC	KEEN'S CEMENT		
KIT	KITCHEN		
LAM	LAMINATE		
LAV	LAVATORY		
LN	LINOLEUM		
MAX	MAXIMUM		
MECH	MECHANICAL		
MET	METAL		
MFR	MANUFACTURER		
MIN	MINIMUM		
MISC	MISCELLANEOUS		
MO	MASONRY OPENING		
MTD	MOUNTED		

GENERAL NOTES

THE FOLLOWING WILL APPLY, UNLESS OTHERWISE NOTED.

- CONTRACTORS STAGING AREA AND PARKING
 - LOCATION EAST OF BUILDING NO. 50, PAST CITY LIFT STATION TO BE USED FOR ALL EQUIPMENT, TRAILER AND VEHICLE PARKING. TO BE SHARED WITH VA AND OTHER CONTRACTORS.
 - OTHER STAGING AREAS TO BE COORDINATED WITH VA ON PER NEED BASIS.
 - RESTORE SITE TO ORIGINAL AND/OR BETTER CONDITION UPON CONSTRUCTION COMPLETION.
- WHERE EXISTING EQUIPMENT, PIPING, CONDUIT, DUCTS, ETC. ARE TO BE REMOVED, SUCH REMOVAL SHALL INCLUDE ALL ANCHORS, HANGERS, OR HARDWARE, ETC.
- WHERE EXISTING CEILING ARE TO BE REMOVED, SUCH REMOVAL SHALL INCLUDE ALL PLASTER, GYPSUM WALLBOARD, ACOUSTICAL TILE, ALL METAL LATH, SUPPORT CHANNELS, CEILING TEES, AND HANGER WIRE, UNLESS OTHERWISE NOTED.
- NEW WORK SHALL LINE WITH AND MATCH EXISTING WORK EXCEPT WHERE OTHERWISE DIMENSIONED OR DETAILED.
- WHERE THE FLOOR SURFACE IS NOT EVEN BETWEEN EXISTING ROOMS WHICH ARE BEING CONSOLIDATED INTO ONE NEW ROOM, THE FLOOR SURFACES SHALL BE MADE EVEN IN PREPARATION FOR THE NEW CONTINUOUS FLOOR FINISH AT NO ADDITIONAL COST TO THE GOVT.
- ALL EXISTING HOLES IN EXISTING FLOOR OR ATTIC SLABS WHICH ARE NOT BEING USED FOR NEW VERTICAL PIPING, DUCTS, CONDUIT, ETC., SHALL BE CLOSED WITH CONCRETE TO THE FULL DEPTH OF THE EXISTING SLAB.
- ALL NEW HORIZONTAL AND VERTICAL PIPING, DUCTS AND CONDUIT REQUIRED BY THIS CONTRACT, SHALL BE RUN CONCEALED FROM VIEW (EXCEPT IN MECHANICAL EQUIPMENT ROOMS, TELEPHONE CLOSETS, SIGNAL CLOSETS, ELECTRICAL CLOSETS, AND ELECTRICAL EQUIPMENT ROOMS). PROVIDE FURRING AS NECESSARY. SUCH FURRING WHETHER AT WALLS OR CEILINGS, SHALL BE FINISHED TO MATCH NEW AND/OR EXISTING ADJACENT SURFACES. THE CONTRACTOR SHALL REFER TO ALL HVAC, ELECTRICAL AND PLUMBING DRAWINGS TO DETERMINE WHERE ANY SUCH PIPES, DUCTS OR CONDUIT OCCUR.
- NEW FINISHES APPLIED PATCH TO MATCH TO EXISTING FLOORS, WALLS AND PARTITIONS. IF FINISH CANNOT BE MATCHED, ALL NEW FINISH SHALL BE PROVIDED AT NO ADDITIONAL COST TO THE GOVT.
- WHERE EXISTING CT FINISH IS BEING REMOVED, A CONCRETE TOPPING SHALL BE APPLIED TO THE REMAINING FLOOR SURFACE TO MAKE IT SMOOTH AND EVEN IN PREPARATION FOR THE APPLICATION OF A NEW CONTINUOUS FLOOR FINISH.
- ALL PARTITIONS, UNLESS OTHERWISE SHOWN OR DETAILED, SHALL BE METAL STUDS AND OF THICKNESS TO ADEQUATELY COVER PIPING, CONDUITS, ETC.
- ALL DIMENSIONS ARE TO THE CENTER LINE OF NEW STUD WALLS AND NEW COLUMNS. EXISTING WALLS, EXISTING COLUMNS AND NEW MASONRY WALLS ARE DIMENSIONED TO THE FACE OF FINISH.
- ALL EXISTING PARTITIONS WITHIN THE REMODELING AREAS WHICH ARE DESIGNATED FIRE OR SMOKE RATED PARTITIONS, AS WELL AS ALL CORRIDOR PARTITIONS SHALL BE IMPROVED TO CONFORM TO THE STANDARDS FOR NEW FIRE RATED PARTITIONS AS FOLLOWS:

EXISTING PARTITIONS TO REMAIN SHALL BE MADE CONTINUOUS FROM THE FLOOR SLAB TO THE UNDERSIDE OF THE FLOOR OR ROOF SLAB ABOVE, INCLUDING CONTINUITY THROUGH THE CONCEALED SPACE ABOVE THE SUSPENDED CEILING. ALL EDGES AND PENETRATIONS SHALL BE FIRE CAULKED CONTINUOUSLY AND SEALED TIGHTLY. PARTITIONS SHALL BE TIGHTLY FITTED AND SEALED AROUND ALL PENETRATIONS SUCH AS DUCTS, PIPES, CONDUIT AND AROUND ALL FRAMING MEMBERS SUCH AS BEAMS, JOISTS AND CONCRETE RIBS.
- PROVIDE A VINYL STRIP UNDER ALL DOORS WHERE NEW OR EXISTING FINISHES AND ADJACENT FLOORS ARE AT DIFFERENT LEVELS AND WHERE ADJACENT FLOOR FINISHES ARE OF DIFFERENT MATERIALS UNLESS OTHERWISE DETAILED.
- UNLESS OTHERWISE SHOWN ON THE REFLECTED CEILING PLANS, ALL ACOUSTICAL CEILING TILE GRIDS SHALL BE CENTERED IN EACH ROOM WITH EITHER A TILE OR GRID AT THE CENTER.
- UNLESS OTHERWISE DETAILED, WHERE EXISTING WALLS OR PARTITIONS ARE REMOVED AND A DIFFERENCE IN CEILING HEIGHTS OCCURS IN ONE ROOM OR AREA, THE SPACE BETWEEN THE CEILING SHALL BE SQUARED OFF HORIZONTALLY AND VERTICALLY WITH FURRING CHANNELS AND FINISHED WITH THE MATERIALS AS CALLED FOR BY THE INDICATED ROOM FINISH.
- EXISTING DOORS, WHICH SWING INTO ROOMS WHERE NEW FLOOR FINISH IS ABOVE ADJACENT FLOORS, SHALL BE CUT OFF NO MORE THAN 3/4" GAP AT BOTTOM TO CLEAR NEW FINISHED FLOOR.
- WORK AT THE DISCRETION OF THE VA MAY BE SHUT DOWN AND RESCHEDULED BY DUE TO CRITICAL AREAS OR SPECIAL NEEDS OF PATIENTS AND STAFF AT NO ADDITIONAL COST TO THE GOVERNMENT.
- CONTRACTOR TO VERIFY ALL EXISTING SITE CONDITIONS.
- CONTRACTOR TO PROVIDE PROTECTION AGAINST DAMAGE, INCLUDING WATER PENETRATION, TO EXISTING STRUCTURE AND FINISHES WHERE DEMOLITION AND NEW CONSTRUCTION OCCURS.
- ALL EXISTING EQUIPMENT, SIGNAGE AND ART SALVAGED FOR REUSE TO BE REINSTALLED BY CONTRACTOR AT SAME LOCATIONS IF POSSIBLE. UTILIZE ALTERNATE LOCATIONS AT OWNER'S DISCRETION.
- ALL TEMPORARY CONSTRUCTION PARTITIONS SHALL BE 1 HOUR RATED. DOORS SHALL HAVE CLOSERS AND LOCKING HARDWARE.
- ALL WALL OR FLOOR PENETRATIONS (NEW OR ABANDONED EXISTING) UNDER THIS PROJECT SHALL BE SEALED, FILLED OR PROTECTED IMMEDIATELY TO MAINTAIN ALL SMOKE AND FIRE PASSAGE SITUATIONS. USE APPROVED FIRE/SMOKE STOP MATERIAL OR EQUIVALENT CONSTRUCTION.
- WHETHER EXISTING OR NEW, NO CABLES, DUCTS, CONDUIT, PIPES, INSULATION, ETC. SHALL BE ALLOWED TO TOUCH OR REST ON SPRINKLER PIPING. ABOVE-CEILING INSPECTIONS WILL BE CONDUCTED AND ANY VIOLATIONS WILL REQUIRE CORRECTION.

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	 <p> Dept. of Veterans Affairs Health Care System 2101 Elm Street North Fargo, ND 58102 </p>	 <p> IMAGE GROUP INC. 403 CENTER AVENUE, SUITE 300 MOORHEAD, MN 56560 </p>	<p> I hereby certify that this plan specification, or report was prepared by me or under my direct supervision, and that I am duly Registered Architect under the laws of the State of North Dakota. </p> <p style="text-align: right;"> <i>Russell Murray</i> Date: 1/31/2014 Reg. No. 378 </p>		<table border="1" style="width: 100%; border-collapse: collapse;"> <tr> <td colspan="2">Drawing Title</td> <td colspan="2">Project Title</td> <td colspan="2">Date</td> </tr> <tr> <td colspan="2" style="text-align: center;">SYMBOLS, LEGEND, ABBREVIATIONS AND GENERAL NOTES</td> <td colspan="2" style="text-align: center;">EXPAND IMAGING AND LABORATORY</td> <td colspan="2" style="text-align: center;">JANUARY 31, 2014</td> </tr> <tr> <td colspan="2">VA Project No.</td> <td colspan="2">Contract No.</td> <td colspan="2">Scale</td> </tr> <tr> <td colspan="2" style="text-align: center;">437-CSI-105</td> <td colspan="2" style="text-align: center;">VA263-P-1217 VA263-C</td> <td colspan="2" style="text-align: center;">NO SCALE</td> </tr> <tr> <td colspan="2">Building No.</td> <td colspan="2">AutoCAD File Name</td> <td colspan="2">Drawing No.</td> </tr> <tr> <td colspan="2" style="text-align: center;">9, 46</td> <td colspan="2" style="text-align: center;">LEGEND.DWG</td> <td colspan="2" style="text-align: center;">X2</td> </tr> <tr> <td colspan="2">Location</td> <td colspan="2">Location</td> <td colspan="2">Dwg. 2 of 61</td> </tr> <tr> <td colspan="2"></td> <td colspan="2" style="text-align: center;">FARGO VA HEALTH CARE SYSTEM FARGO, ND</td> <td colspan="2"></td> </tr> </table>	Drawing Title		Project Title		Date		SYMBOLS, LEGEND, ABBREVIATIONS AND GENERAL NOTES		EXPAND IMAGING AND LABORATORY		JANUARY 31, 2014		VA Project No.		Contract No.		Scale		437-CSI-105		VA263-P-1217 VA263-C		NO SCALE		Building No.		AutoCAD File Name		Drawing No.		9, 46		LEGEND.DWG		X2		Location		Location		Dwg. 2 of 61				FARGO VA HEALTH CARE SYSTEM FARGO, ND				
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