


# WTP Generator, Propane and ATS


666-14-811S  
VAMC Sheridan, WY  
June 10, 2014

SHERIDAN VAMC

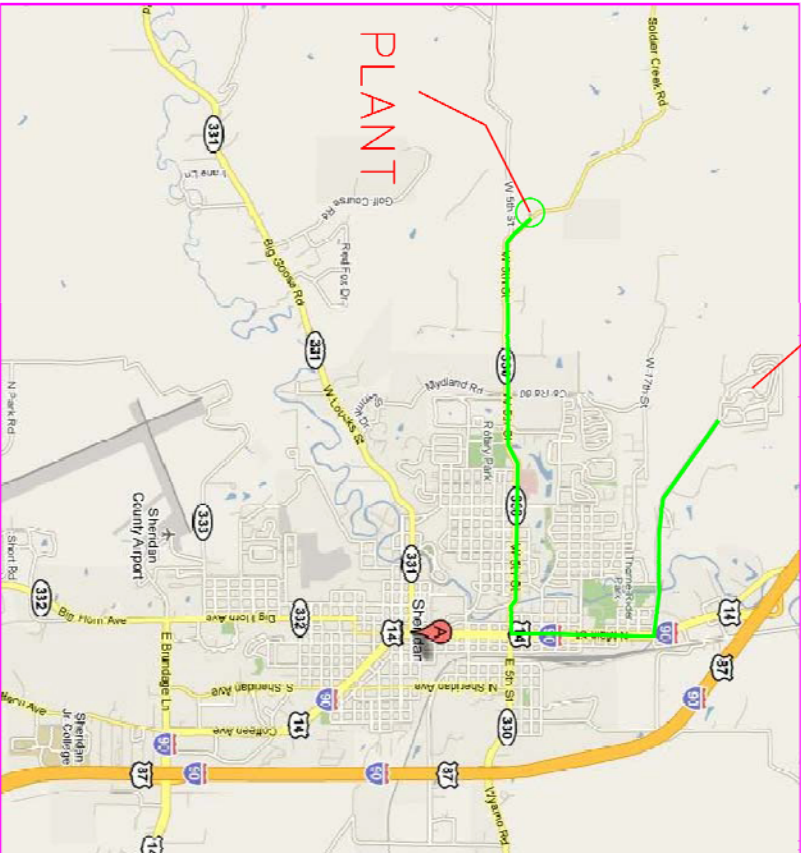


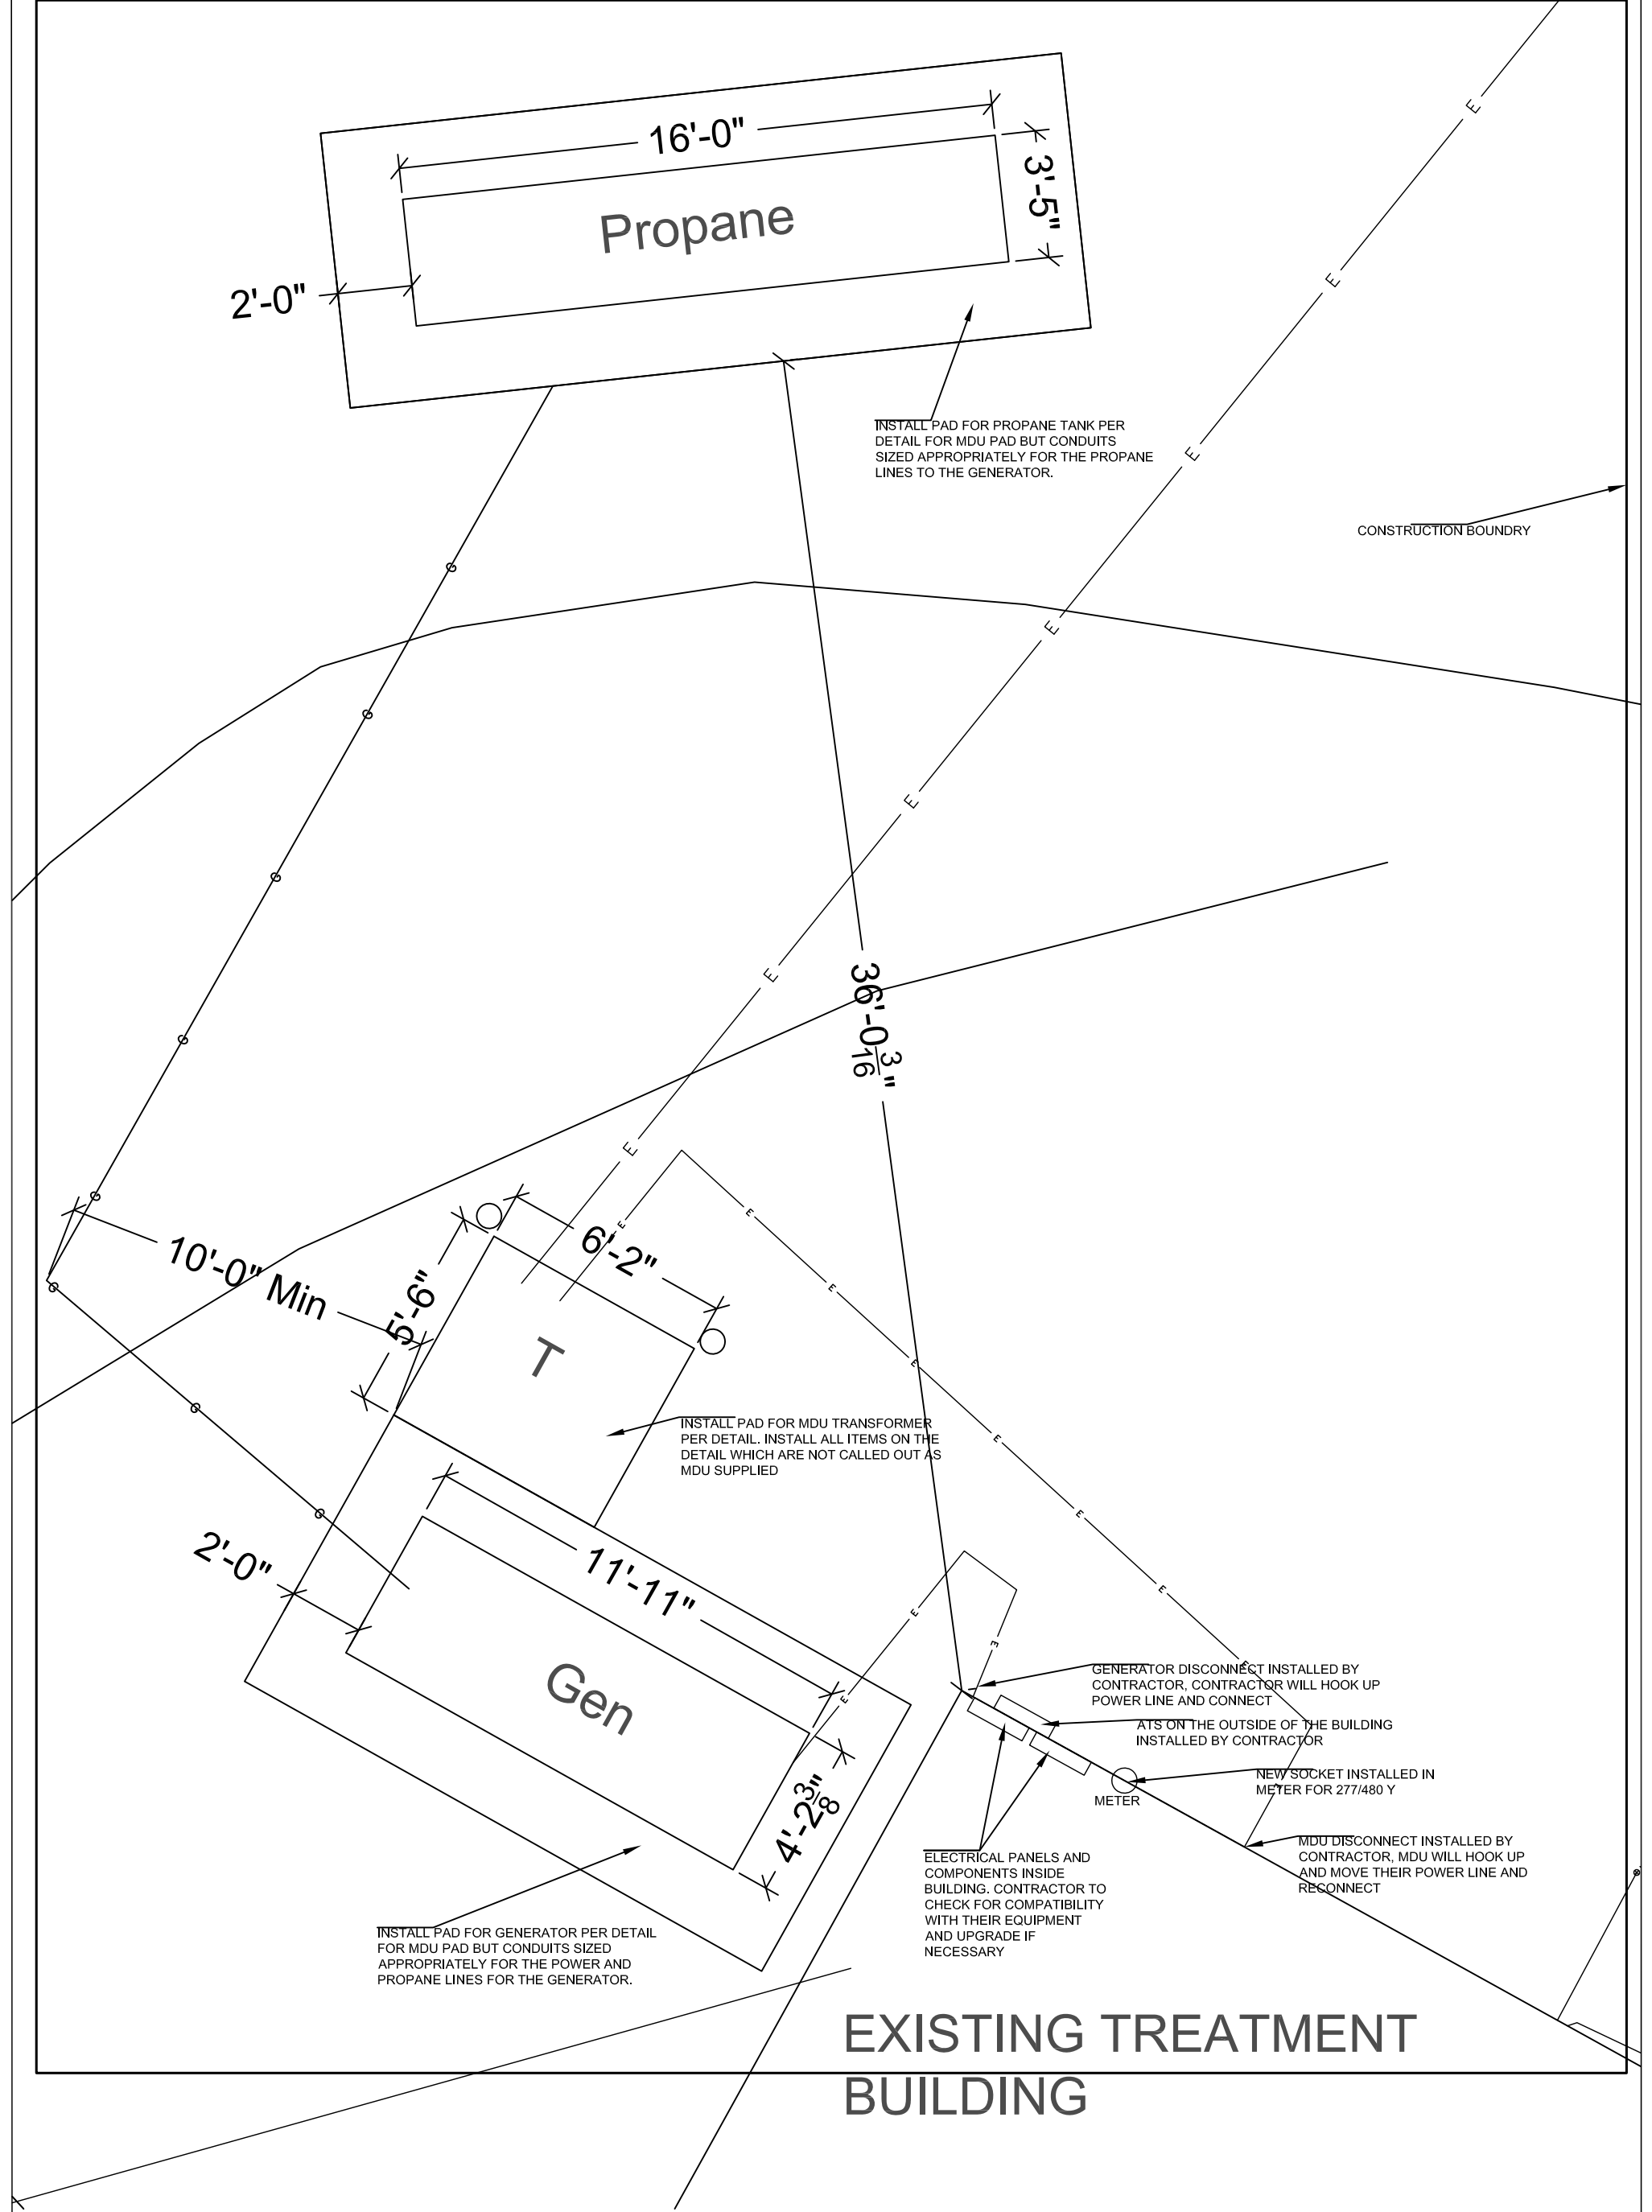
VICINITY MAP  
SCALE: NTS

TREATMENT  
PLANT

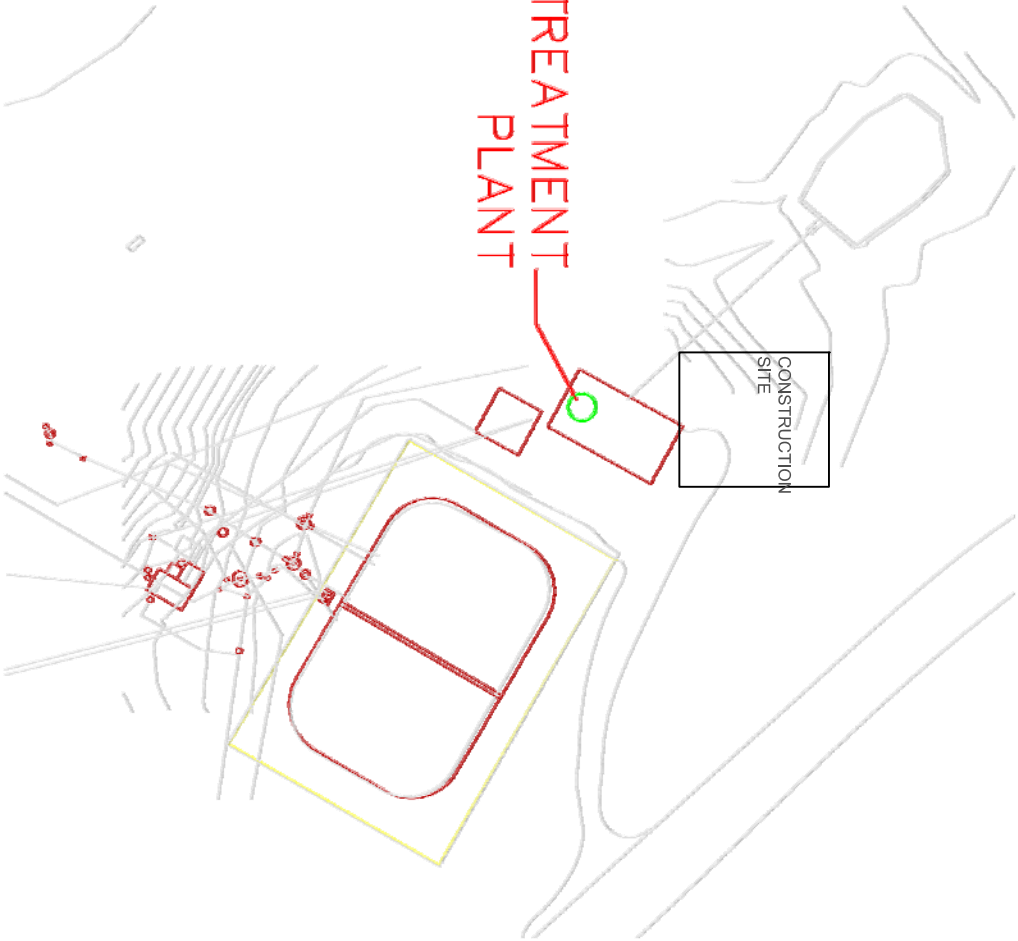


SITE PLAN  
SCALE: NTS


Project Title WTP Generator, Propane and ATS	Drawing Title		Revision		Office of Facilities Management 	Drawing Number
	Title Page		-			
	Location VAMC Sheridan, WY	Project Number 666-14-811S	Date June 10, 2014			Dwg 1 of 4




Project Title WTP Generator, Propane and ATS	Drawing Title Plan View		Revision -	Office of Facilities Management  Department of Veterans Affairs	Drawing Number
	Location VAMC Sheridan, WY	Project Number 666-14-811S	Date June 10, 2014		

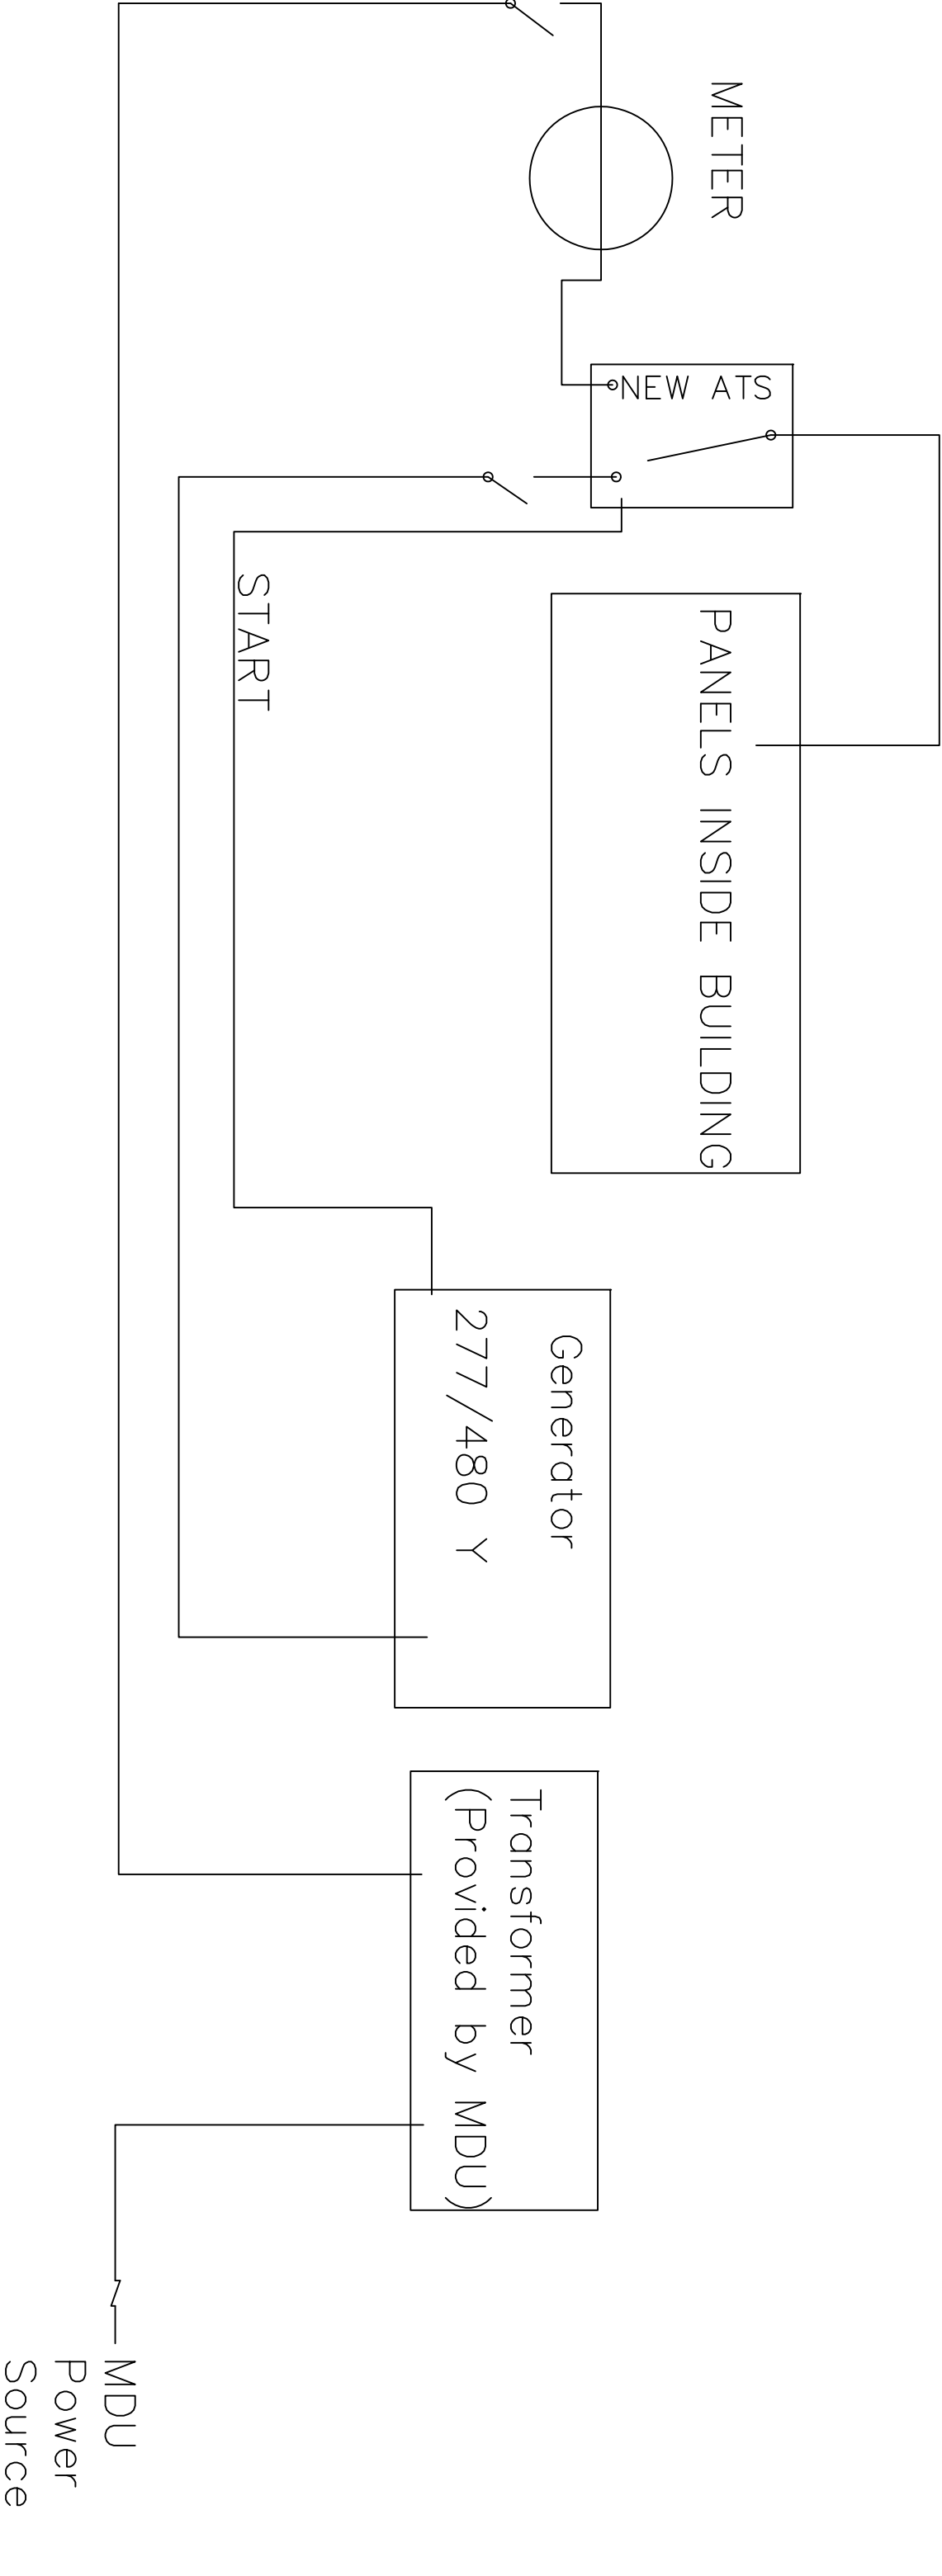

Not to Scale

Project Title  WTP Generator, Propane and ATS	Drawing Title		Revision		Office of Facilities Management   Department of Veterans Affairs	Drawing Number
	One Line		-			
	Location	Project Number	Date			
	VAMC Sheridan, WY	666-14-81IS	June 10, 2014			
						Dwg. 3 of 4

NOTE: Entire pad must be 5' from ANY building.

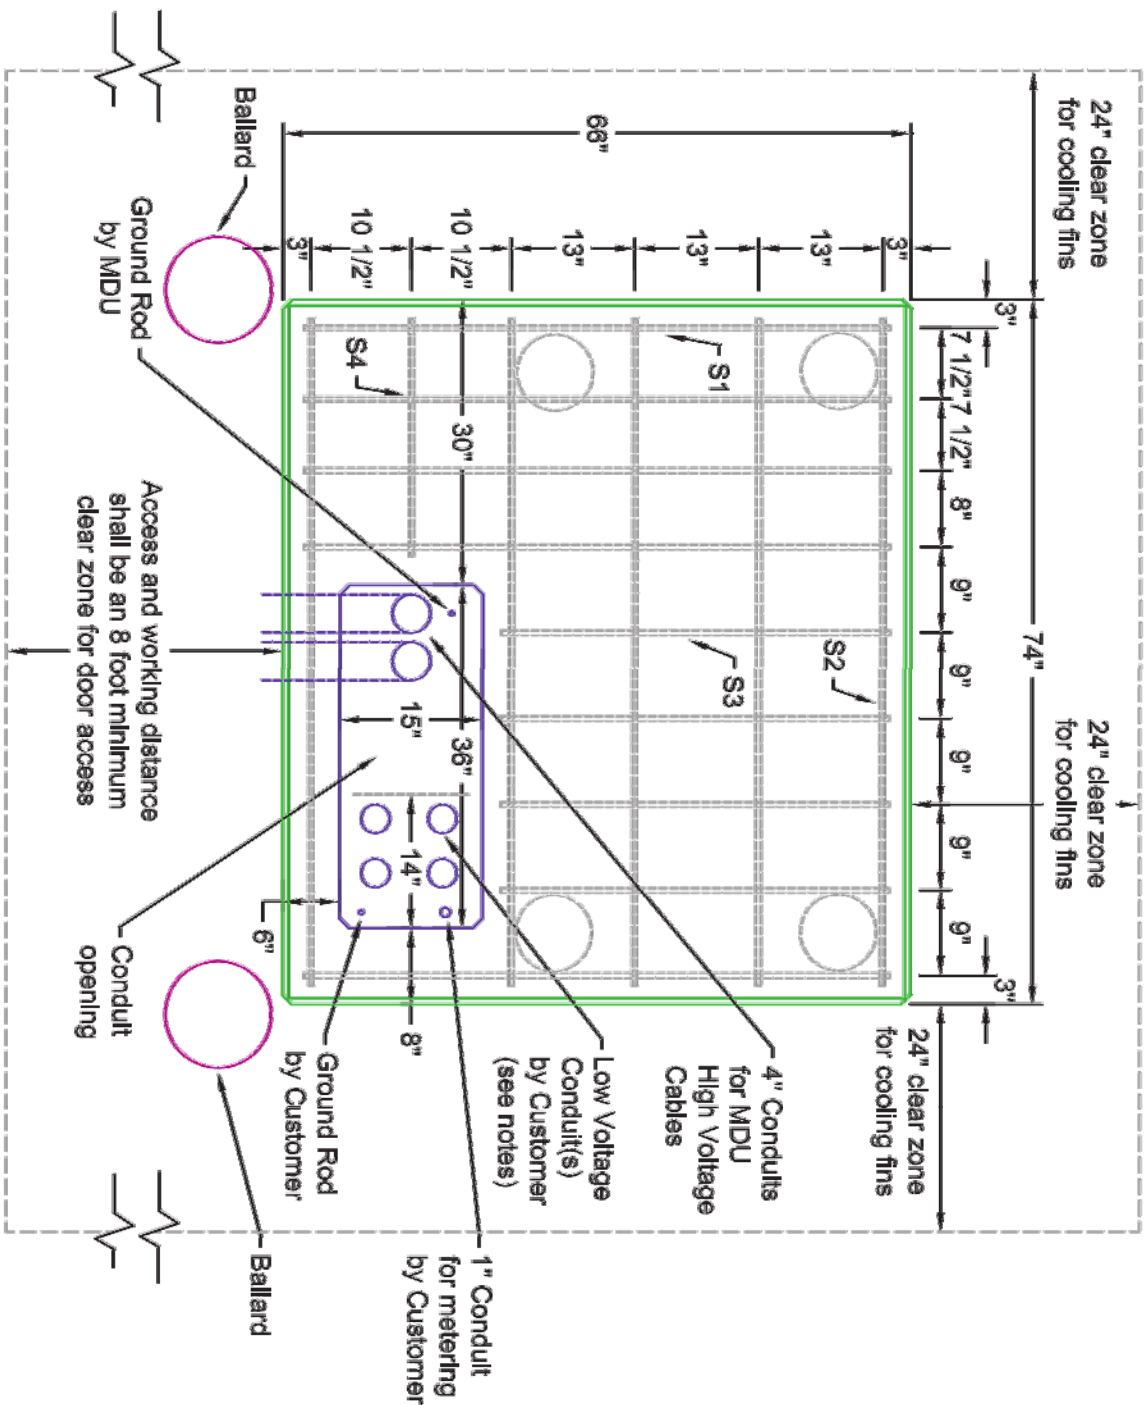

TRANSFORMER LOCATION

1. Entire pad must be five feet from any building.
2. All oil-filled padmounted transformers must be installed so any flow of oil resulting from a failure of the transformer will flow away from any structure.
3. A transformer should be located away from traffic areas or protected with ballards such as concrete filled pipes or steel bumper posts, provided by the customer. When locating pad, consider overhead clearance for possible transformer replacement.
4. Compact soil to avoid tilting and settling. Columns required except on undisturbed soil.

STEEL REINFORCING ROD

MARK	QTY.	SIZE	LENGTH
S1	5	1/2"	62"
S2	5	1/2"	70"
S3	4	1/2"	41"
S4	1	1/2"	25"

NOTES:

1. Transformer pad, service cable, conduit, and ground rod or mat for service cable grounding are furnished by customer; connections by company.
2. Reinforcing steel must be secured with the wire at all intersections.
3. All exposed edges and corners to have 1" chamfer.
4. Minimum of 1.2 Cubic Yards of concrete required.
5. Low voltage conduits by customer must be installed within 14" area noted.
6. Where the customer has more than four parallel conductors, a CT/Transition Cabinet and conduits to the transformer location may be required.
7. Top surface shall be level for concrete pad.

CONCRETE PAD

FOR 3-PH TRANSFORMER

SIZES 45 THROUGH 300 KVA



**ELECTRIC DISTRIBUTION STANDARDS**

SCALE: 1/2" = 1'

DRAWING NO: 19-803

APPROVED:	
DLA	
DATE:	04/11/14
3/28/2014	CIV
6/2/1999	CAH
6/2/1999	CAH
CHANGE FRONT CLEAR ZONE & CENTER	
MOVE CONDUIT OPENING 7" TO THE RIGHT	

Project Title	Drawing Title	Revision	Office of Facilities Management	Drawing Number
WTP Generator, Propane and ATS	Details for Concrete	-		
	Location	Date	Department of Veterans Affairs	Dwg 4 of 4
	VAMC Sheridan, WY	June 10, 2014		