
PROJECT NUMBER: 656-12-339 RECONFIGURE/EXPAND BUILDINGS 28 & 9 FOR RESIDENTIAL REHABILITATION TREATMENT PROGRAM

ST. CLOUD, MINNESOTA

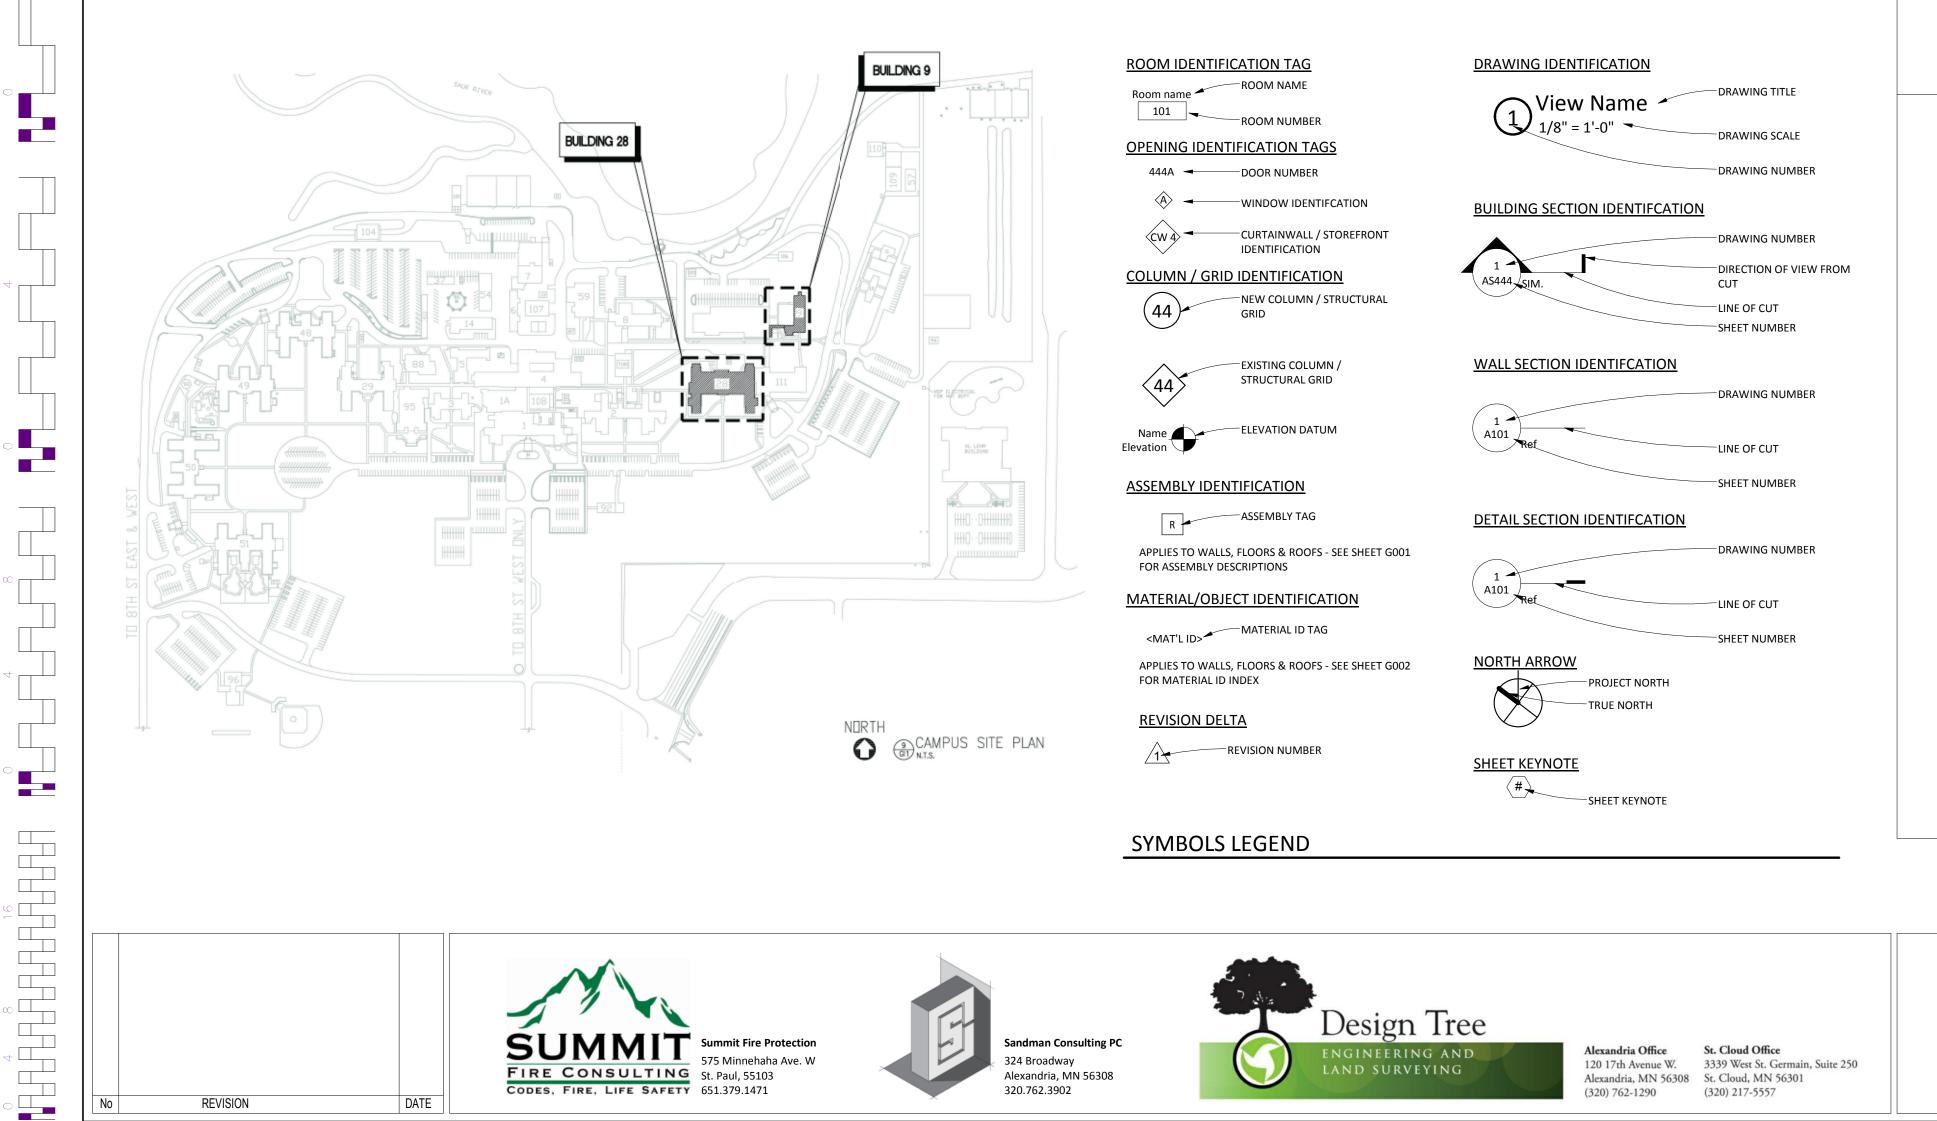

PROJECT TEAM OWNER **ARCHITECT** STRUCTURAL ENGINEER MECH/ELEC ENGINEER **FIRE PROTECTION CIVIL ENGINEER Summit Fire Protection** VA Healthcare System JLG Architects Sandman Consulting PC Design Tree Engineering Design Tree Engineering 3339 West St. Germaine, Suite 250 4801 Veterans Drive 525 Broadway 324 Broadway 575 Minnehaha Ave. W 3339 West St. Germaine, Suite 250 St. Cloud, MN 56303-2099 St. Cloud, MN 56301 Alexandria, MN 56308 Alexandria, MN 56308 St. Cloud, MN 56301 St. Paul, MN 55103 Fax: 320.217.5597 Phone: 320.255.6346 Fax: 320.255.6342 Phone: 320.759.9030 Phone: 320.762.3902 Phone: 320.217.5557 Phone: 651.251.1880 Phone: 320.217.5557 Dan Miller, Principal Joe Nicholson, PE, SE Chris Schaefer, Mechanical Lewis Anderson, PE Gina Dullinger Gary Johnson Email: gary.johnson@va.gov Phone: 320.762.0324 Phone: 320.762.3902 Email: crs@designtreeengineering.com Phone: 651.379.1471 Email: gmd@designtreeengineering.com Email: dmiller@jlgarchitects.com Email: joe@sc-pc.com Email: landerson@summitfire.com Robert Klein, COR Dan Johnson, Electrical Email: robert.klein@va.gov Email: dlj@designtreeengineering.com



GENERAL NOTES

All dimensions on drawings are approximate; Drawings are not to be scaled. It is the responsibility of the contractor to verify all field conditions and physical dimensions that influence the construction

site prior to submitting their bids and they are encouraged to do so. Contractor shall adhere strictly to State and Federal Occupational Safety and Health Administration (OSHA) Standards.

Contractor shall park only in the designated parking areas and are not to park on the lawn areas; the only exception is to load or unload

Contractor is responsible for the safeguarding of their tools and equipment. All tools and equipment are not to be left unattended and are to be secured at all times when the contractor is not present, or the construction site is not supervised by the contractor.

All VA property is to be safeguarded from damage. Any damaged VA property is to be restored to original condition prior to damage or replaced completely. This includes installation, labor, and procurement

Contractor must control demolition and construction dust from facility by erecting a dust barrier and ventilation with hepa filters. If venting to outside, the contractor will insure negative air pressure is maintained in encapsulated work area. When transporting debris, wet down

NUMBER

SHEET NAME

All demolished material becomes the property and the responsibility

of the contractor with the exception of specified items designated either in the plans or verbally requested by the COR to be retained by the VA. Offsite disposal of the demolished items is the responsibility

regulations and is to be enclosed for the first eight feet above ground at end of each working day, until dismantled. Ladders must be removed and locked up at the end of each working day to prevent

unauthorized persons from having access.

Clean all debris from construction site to the satisfaction of the COR. Contractor is responsible for erecting a barrier around work site to fence may be a plastic snow fence at open trench areas. All other

Provide swinging mandoor gate with emergency egress Coordinate construction materials and location of fence with COR

Fencing to be 8'-0" high with top and bottom rail.

be overcut by 6" or more to accommodate full width rolls of sod. Top lawn. Sod to be thoroughly saturated with water upon placement. The contractor is responsible for watering new sod until established lawn restoration acceptance by the COR.

Access to all buildings and parking areas must be maintained

Contractors are to coordinate all work with the Contracting Officers

SITE LOCATOR



NUMBER

MATERIALS

SHEET NAME

BLDG.

NUMBER

SHEET INDEX

NUMBER	SHEET NAME	NUMBER	NUMBER	SHEET NAME	NUMBER	NUMBER	SHEET NAME	NUMBER
00 Comeral			1004	DOOM FINISH COUEDING	20	DI 100	DITIMDING DI ANI DACEMENT DEMO	20
00_General	00\/FD		1001	ROOM FINISH SCHEDULE	28	PL100	PLUMBING PLAN - BASEMENT DEMO PLUMBING PLAN - FIRST FLOOR	28
GI000	COVER		I100	BASEMENT FINISH FLOOR PLAN	28	PL101		28
GI001	CODE SHEET	28	I101	FIRST FLOOR FINISH FLOOR PLAN	28	PL102	PLUMBING PLAN - SECOND FLOOR	28
GI002	PHASING PLAN	28	I102	SECOND FLOOR FINISH FLOOR PLAN	28	PL103	PLUMBING PLAN - ROOF	28
GI003	TYPICAL ASSEMBLIES		1202	WALL FINISH PLAN	28	P401	ENLARGED PLANS	28
GI004	MOUNTING HEIGHTS		1302	LEVEL 2 FURNITURE PLAN	28	P501	PLUMBING DETAILS	28
04 05 31			04 04			P601	PLUMBING SCHEDULES	28
01_Civil	OITE DEMOLITICAL DI ANI		04_Structural	OFNEDAL NOTEO		P701	PLUMBING WASTE AND VENT ISOMETRIC	28
CD101	SITE DEMOLITION PLAN		S001	GENERAL NOTES		P702	PLUMBING WASTE AND VENT ISOMETRIC	28
CG101	SITE GRADING & DRAINAGE		S100	FOUNDATION PLAN	28	P703	PLUMBING DOMESTIC WATER ISOMETRIC	28
CG102	EROSION CONTROL PLAN		S120	BUILDING 9 PLANS	9	P704	PLUMBING DOMESTIC WATER ISOMETRIC	28
CU101	UTILITY PLAN		S200	FIRST FLOOR PLAN	28	P705	PLUMBING STORM WATER ISOMETRIC	28
C501	EROSION CONTROL/SWPPP DETAILS		S201	SECOND FLOOR PLAN	28			
C502	CIVIL DETAILS		S202	ROOF PLAN	28	07_Electrical		
C503	CIVIL DETAILS		S203	ATTIC FRAMING PLAN	28	E001	ELECTRICAL INDEX	
C504	SWPPP NARRATIVE		S300	FOUNDATION DETAILS	28	ED100	DEMO PLAN - BASEMENT	28
			S301	BUILDING 9 DETAILS	9	ED101	DEMO PLAN - FIRST FLOOR	28
02_Architectur			S400	FRAMING DETAILS	28	ED102	DEMO PLAN - SECOND FLOOR	28
AS001	SITE PLAN		S401	FRAMING DETAILS	28	ES100	ELECTRICAL SITE PLAN	
HA100	ABATEMENT PLANS	28				ES101	ENLARGED ELECTRICAL SITE PLAN	
AD100	BASEMENT DEMOLITION PLAN	28	05_Mechanica	I		EP100	POWER PLAN - BASEMENT	28
AD101	FIRST FLOOR DEMOLITION PLAN	28	M001	MECHANICAL INDEX	28	EP101	POWER PLAN - FIRST FLOOR	28
AD102	SECOND FLOOR DEMOLITION PLAN	28	MD100	HVAC PLAN - BASEMENT DEMO	28	EP102	POWER PLAN - SECOND FLOOR	28
AD201	DEMO ROOF PLANS & ELEVATIONS	28	MD101	HVAC PLAN - FIRST FLOOR DEMO	28	EP103	POWER PLAN - ATTIC	28
AD700	DEMO RCP	28	MD102	HVAC PLAN - SECOND FLOOR DEMO	28	EL100	LIGHTING PLAN - BASEMENT LEVEL	28
AS100	BASEMENT FLOOR PLAN	28	MD103	ENLARGED HVAC PLAN - DEMOLITION	28	EL101	LIGHTING PLAN - FIRST FLOOR	28
AS101	FIRST FLOOR PLAN	28	MH100	HVAC PLAN - BASEMENT	28	EL102	LIGHTING PLAN - SECOND FLOOR	28
AS102	SECOND FLOOR PLAN	28	MH101	HVAC PLAN - FIRST FLOOR	28	EL103	LIGHTING PLAN - ATTIC	28
AS103	ATTIC PLAN	28	MH102	HVAC PLAN - SECOND FLOOR	28	ET100	TELECOM PLAN - BASEMENT	28
AS104	ROOF PLAN	28	MH103	HVAC PLAN - SECOND FLOOR AREA A	28	ET101	TELECOM PLAN - LEVEL ONE	28
AS111	UNIT PLANS	28	MH104	HVAC PLAN - SECOND FLOOR AREA B	28	ET102	TELECOM PLAN - SECOND FLOOR	28
AS120	BUILDING 9 LINK PLANS	9	MH105	HVAC PLAN - SECOND FLOOR AREA C	28	E400	ENLARGED PLANS	28
AS131	PROJECT ALTERNATES	28	MH106	HVAC PLAN - SECOND FLOOR AREA D	28	E401	BUILDING 9 LINK PLANS	9
AS151	PLAN DETAILS	28	MH107	HVAC PLAN - ATTIC	28	E500	ELECTRICAL DETAILS	28
AS151	INTERIOR DETAILS	28	MP100	HYDRONIC PLAN - BASEMENT	28	E501	ELECTRICAL DETAILS	28
AS201	EXTERIOR ELEVATIONS		MP101	HYDRONIC PLAN - BASEMENT HYDRONIC PLAN - FIRST FLOOR		E502	ELECTRICAL DETAILS	28
		28			28			
AS301	BUILDING SECTIONS	28	MP102	HYDRONIC PLAN - SECOND FLOOR	28	E503	ELECTRICAL DETAILS	28
AS302	BUILDING SECTIONS	28	MP103	HYDRONIC PLAN - ATTIC	28	E600	POWER RISER DIAGRAM - DEMOLITION	28
AS401	WALL SECTIONS	28	M401	BUILDING 9 LINK PLAN	9	E601	POWER RISER DIAGRAM/DETAILS	28
AS402	WALL SECTIONS	28	M402	ENLARGED MECHANICAL PLANS	28	E602	SCHEDULES	28
AS420	LINK SECTIONS/DETAILS	9	M403	ENLARGED MECHANCIAL PLANS	28	E603	SCHEDULES	28
AS501	EXTERIOR DETAILS	28	M501	MECHANICAL DETAILS	28			
AS502	EXTERIOR DETAILS	28	M502	MECHANICAL DETAILS	28	08_Fire Protect		
AS520	LINK SCHEDULES, PLANS & DETAILS	9	M503	MECHANICAL DETAILS	28	FD101	DEMO FIRE PROTECTION PLAN - LEVEL 1,2 & AT	TIC 28
AS601	ARCHITECTURAL SCHEDULES	28	M601	MECHANICAL SCHEDULES	28	F100	BASEMENT FIRE PROTECTION PLAN	28
AS700	BASEMENT REFLECTED CEILING PLAN	28	M602	MECHANICAL SCHEDULES	28	F101	FIRST FLOOR FIRE PROTECTION PLAN	28
AS701	FIRST FLOOR REFLECTED CEILING PLAN	28	M701	MECHANICAL FLOW DIAGRAM	28	F102	SECOND FLOOR FIRE PROTECTION PLAN	28
AS702	SECOND FLOOR REFLECTED CEILING PLAN	28	M702	HYDRONIC SCHEMES	28	F103	ATTIC FIRE PROTECTION PLAN	28
AS801	VERTICAL CIRCULATION	28				F120	BUILDING 9 LINK FIRE PROTECTION PLAN	9
AS901	INTERIOR ELEVATIONS	28	06_Plumbing					
AS920	CASEWORK DETAILS	28	PD100	PLUMBING PLAN - BASEMENT DEMO	28			
			PD101	PLUMBING PLAN - FIRST FLOOR DEMO	28			
03_Interiors			PD102	PLUMBING PLAN - SECOND FLOOR DEMO	28			
_			PD103	ENLARGED PLUMBING DEMO PLANS	28			
				- · · · · · · · ·	-			

ABBREVIATIONS

A (O	ALD CONDITIONED	DDI	DOUBLE.	0.4	OALIGE	MEOU	MEGUANIGAL	DEV	DEVIOLONIO	TUDU	TUDOLIOU
A/C	AIR CONDITIONER	DBL	DOUBLE	GA	GAUGE	MECH	MECHANICAL	REV	REVISIONS	THRU	THROUGH
ACT	ACOUSTIC CEILING TILE	DTL.	DETAIL	GAL	GALLON	MEMB	MEMBRANE	R.H.	RIGHT HAND	THLD	THRESHOLD
AC PNL	ACOUSTIC PANEL	DIA()	DIAMETER	GALV	GALVANIZED	MTL	METAL	R.I.	ROUGH-IN	T.O	TOP OF
AFF	ABOVE FINISH FLOOR	DIM `	DIMENSION	G.B.	GRAB BAR	MFGR	MANUFACTURER	R.L.	RAIN LEADER	T.O.B.	TOP OF BEAM
ALT	ALTERNATE	DIV	DIVISION	G.C.	GENERAL CONTRACTOR	M.H.	MAN HOLE	RM	ROOM		TOP OF FOUNDATION
APPROX	APPROXIMATE	DN	DOWN	GEN	GENERAL	MKBD	MARKERBOARD	R.O.	ROUGH OPENING		TOP OF FLOOR
A.B.	ANCHOR BOLT	DS	DOWNSPOUT	GL	GLASS	MIN	MINIMUM	R&S	ROD & SHELF	T.O.FTG.	TOP OF FOOTING
A.H.U.	AIR HANDLING UNIT	D.T.	DRAIN TILE	GWB	GYPSUM WALL BOARD	MISC	MISCELLANEOUS	R.T.	RUBBER TILE	TLT	TOILET
ALUM	ALUMINUM	DW	DISHWASHER	GYP	GYPSUM	M.L.	METAL LATH	R.T.U.	ROOF TOP UNIT	T.P.	TELEPHONE POLE
A.P.	ACCESS PANEL	()	DEGREE	H.B.	HOSE BIB	M.O.	MASONRY OPENING	RUB	RUBBER	T.P.D.	TOILET PAPER DISPENSER
ARCH	ARCHITECTURAL	ĎÍSP	DISPENSER	H.C.	HOSE CABINET	MULL	MULLION	RCP	REFLECTED CEILING PLAN	TR	TREAD
ASPH	ASPHALT	DWG	DRAWING	H.D.	HEAVY DUTY	MTD	MOUNTED	REC	RECEPTICLE	TRANSF	TRANSFORMER
		DWL	DOWEL					RS	ROUGH SAWN	TYP	TYPICAL
BSMT	BASEMENT			HD HT	HEAD HEIGHT	N.I.C.	NOT IN CONTRACT	S.A.	SUPPLY AIR	TEL	TELEPHONE
BD	BOARD	EA	EACH	HDBD	HARDBOARD	NOM	NOMINAL	S.B.	SPLASH BLOCK	T.O.C.	TOP OF CURB
BLDG	BUILDING	E.C.	ELECTRICAL CONTRACTOR	HDWE	HARDWARE	N.T.S.	NOT TO SCALE	SC	SEALED CONCRETE	T.O.W.	TOP OF WALL
BLKG	BLOCKING	E.J.	EXPANSION JOINT	HM	HOLLOW METAL	NEC	NATIONAL ELECTRIC CODE	SCHED	SCHEDULE	UG	UNDERGROUND
B.O.	BOTTOM OF	ELEC	ELECTRICAL	HORIZ	HORIZONTAL	NO	NUMBER	S.D.	SEE DETAIL	U.H.	UNIT HEATER
B.P.	BUILDING PAPER	ELEV	ELEVATION	HT	HEIGHT			SECT	SECTION	UNEX	UNEXCAVATED
BRG	BEARING	E.P.	ELECTRICAL PANEL	HTG	HEATING	O.C.	ON CENTER	SF	SQUARE FOOT	UNFIN	UNFINISHED
B.U.R.	BUILT UP ROOFING	EQ	EQUAL	HTR	HEATER	O.D.	OUTSIDE DIAMETER	SGL	SINGLE	U.N.O.	UNLESS NOTED OTHERWISE
5.0	20.21 0. 1.001	EQUIP	EQUIPMENT	H.W.	HOT WATER	0.F.	OUTSIDE FACE	S.G.T.	STRUCTURAL GLAZED TILE	U.S.	URINAL SCREEN
CAB	CABINET	E.W.	EACH WAY	HDCP	HANDICAPPED	O.H.	OVERHEAD	SHT	SHEET	U.V.	UNIT VENTILATOR
C.B.	CATCH BASIN	E.W.C.	ELECTRIC WATER COOLER	HVAC		OPG	OPENING	SI	SQUARE INCH	U.T.R.	UNISEX TOILET ROOM
CC	CONTRACTOR PROVIDED	EXH	EXHAUST	111710	TIE/ (TIIVO/ VEIVTIE/ (TIIVO// VO	OPP	OPPOSITE	SIM	SIMILAR	0.1.14.	ONIOEX FOREET TOOM
00	CONTRACTOR INSTALLED	EXP	EXPANSION	I.J.	ISOLATION JOINT	O.F.D.	OVERFLOW DRAIN	S.I.P.	STRUCTURAL INSULATED PANEL	VER	VERIFY
C.C.J.	CONSTRUCTION CONTROL JOINT	EXT	EXTERIOR	INSUL	INSULATION/INSULATING	O.I .D.	OVERT EOW BIVING	SPECS	SPECIFICATIONS	VB	VINYL BASE
CG CG	CORNER GUARD	EXIST	EXISTING	INT	INTERIOR/INTERNAL	PART	PARTITION	01 200	01 E011 10/1110110	VC	VA FURNISHED
CJ	CONTROL JOINT	LAIOT	EXIOTING	INV	INVERT		STIC LAMINATE	SPK	SPEAKER	VO	CONTRACTOR INSTALLED
CLG	CEILING	F/A	FIRE ALARM	ID	INSIDE DIAMETER	PLY	PLYWOOD	SPR	SPRINKLER	VCT	VINYL COMPOSITE TILE
CLR	CLEAR	F.B.	FACE BRICK	ID .	INOIDE DIAMETER	P.V.	PLUMBING VENT	SQ	SQUARE	VENT	VENTILATE(R)(ING)
CMU	CONCRETE MASONRY UNIT	F.C.O.	FLOOR CLEAN-OUT	JAN	JANITOR	P.V.C.	POLYVINYL CHLORIDE	S.S.	STAINLESS STEEL	VERT	VERTICAL VERTICAL
C.O.	CLEAN OUT	F.C.O. F.D.	FLOOR CLEAN-OUT FLOOR DRAIN	JST	JOIST	PREFIN	PREFINISHED	S.S. STL	STEEL	VERT	VOLUME
COL	COLUMN	F.D. F.D.V.	FICOR DRAIN FIRE DEPARTMENT VALVE	J-BOX	JUNCTION BOX	PREP	PREPARED	STOR	STORAGE	VOL V.ST.	VENT STACK
CONC	CONCRETE	F.D.V. F.E.	FIRE EXTINGUISHER	J-DOX	JUNCTION BOX	PLAS	PLASTIC	STRUCT	STRUCTURAL	v.31. V.T.R.	VENT STACK VENT THRU ROOF
CONST	CONSTRUCTION	F.E.C.		KD	KNOCK DOWN		PLAN	SUSP	SUSPENDED		
	CONTINUOUS	F.E.C. F.H.C.	FIRE EXTINGUISHER CABINET	KD	KNOCK DOWN	PLN	PLAN PLATE	SW	SWITCH	VV	VA FURNISHED VA INSTALLED
CONT			FIRE HOSE CABINET	1.417	LAVATORY	()		SVV	SWITCH	\440	
CONTR	CONTRACTOR	FIN	FINISH	LAV	LAVATORY	()	PLUS OR MINUS	TD	TACKECARE	VWC	VINYL WALL COVERING
CPT	CARPET	F.O.	FINISHED OPENING		LOADING DOCK	о т	OLIA DDV/TIL E	TB	TACKBOARD	VWF	VINYL WALL FABRIC
C.T.	CERAMIC TILE	FLR	FLOOR		LEFT HAND	Q.T.	QUARRY TILE	T.C.	TALL CABINET	14//	NA/ITH
CTR	CENTER	FND	FOUNDATION	L.P.	LOW PRESSURE	QTR	QUARTER	TEMP	TEMPORARY	W/	WITH
C.U.H.	CABINET UNIT HEATER	F.O.S.	FACE OF STUD	LVL	LAMINATED VENEER LUMBER	RAD	RADIUS	T&G	TONGUE & GROOVE	W.C.	WATER CLOSET
CUST	CUSTODIAN	FP	FIRE PROOFING	LAM	LAMINATED	R.A.	RETURN AIR	T.H.	TOWEL HOOK	WD	WOOD
CW	COLD WATER	FT	FOOT/FEET	LGT	LIGHTING	R.A.F.	RETURN AIR FAN			WNDW	WINDOW
()	CENTERLINE	FTG	FOOTING			R.A.G.	RETURN AIR GRILLE			W.H.	WALL HUNG
		FUR	FURRING	MAS	MASONRY	R.D.	ROOF DRAIN			W/O	WITHOUT
		FURN	FURNISH	MAT	MATERIAL	REC	RECESSED			W.P.	WATERPROOF
				MAX	MAXIMUM	REF	REFRIGERATOR			WSCT	WAINSCOT
				M.B.	MOP BASIN	REINF	REINFORCED			WS	WATER SOFTENER
				M.C.	MECHANICAL CONTRACTOR	REQ'D	REQUIRED				

100% CD SET













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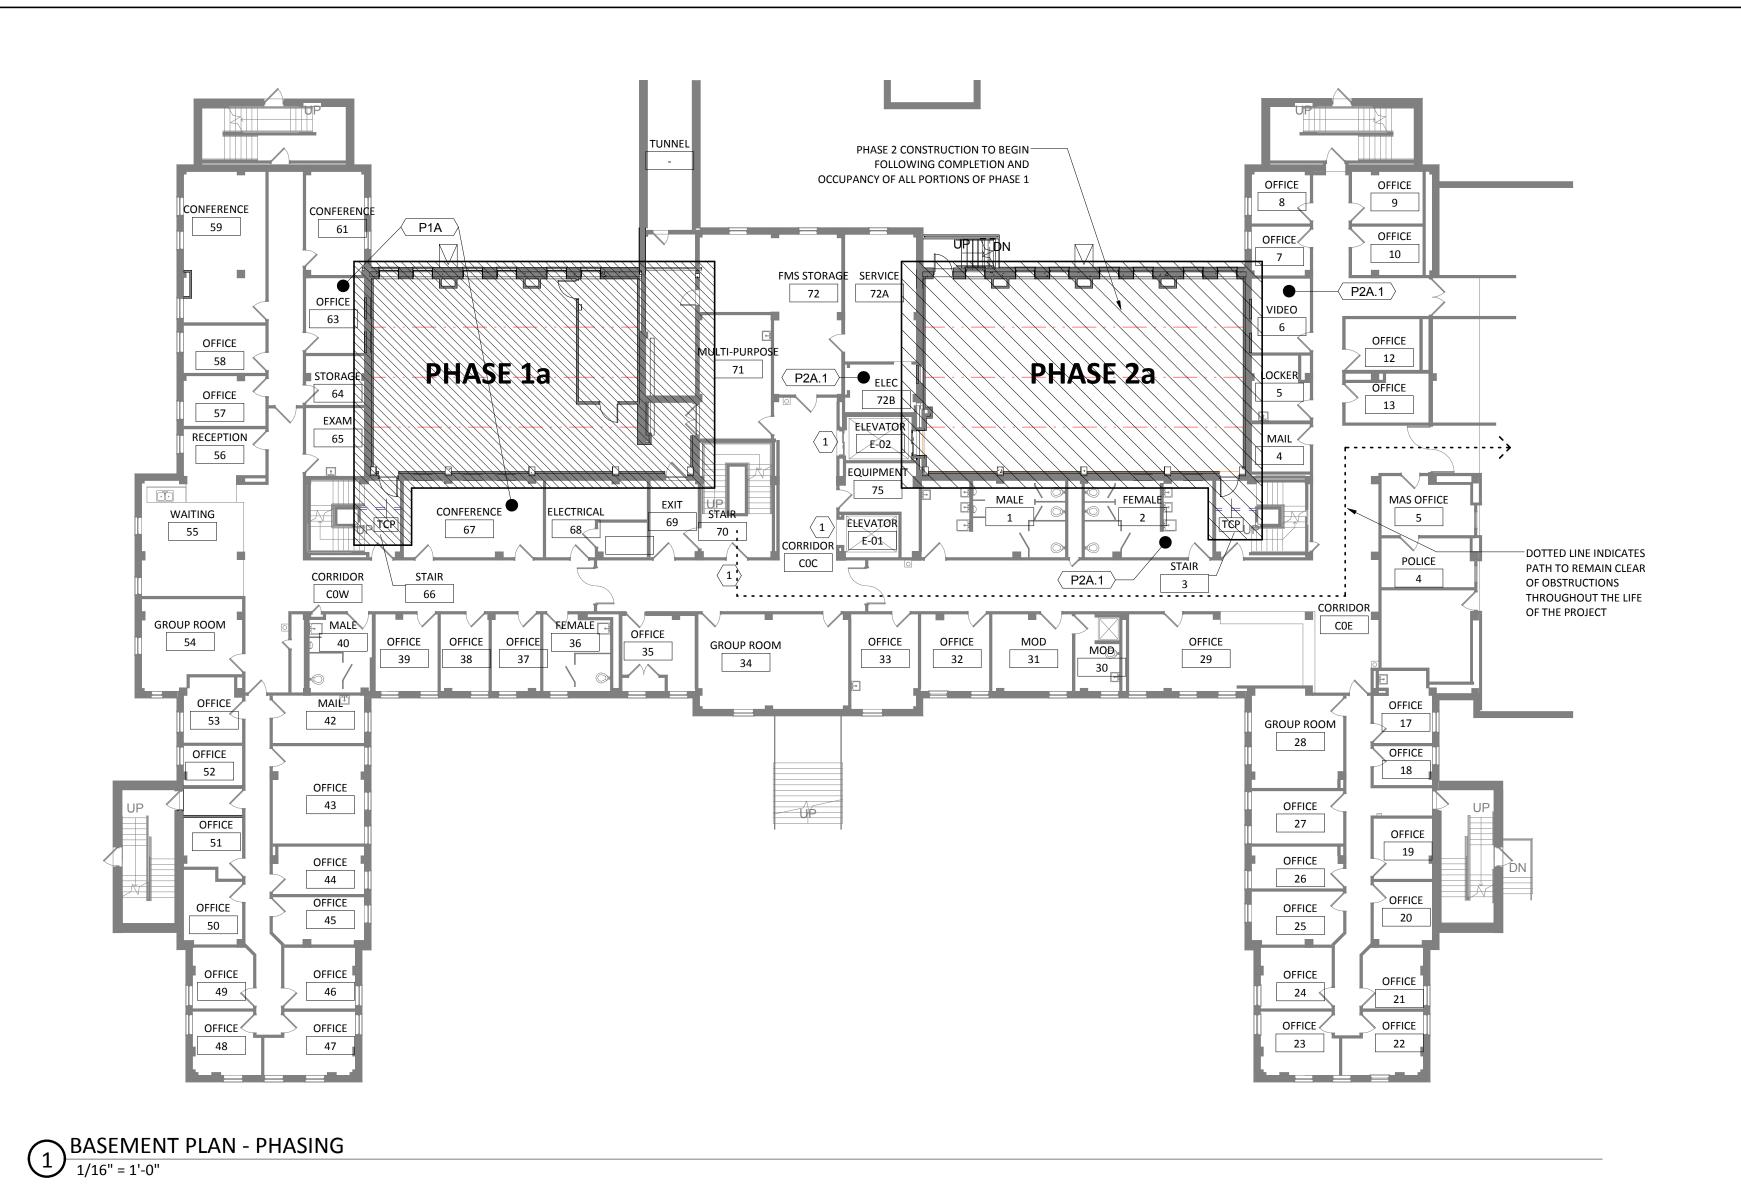


APPROVED: SERVICE LINE DIRECTOR	DATE	APPROVED: INFECTION CONTROL NURSE	DATE	COVED
				COVER
APPROVED: GEMS COORDINATOR	DATE	APPROVED: PATIENT SAFETY	DATE	
				APPROVED: PROJECT DIRECTOR
APPROVED: PROJECTS SECTION MANAGER	DATE	APPROVED: CHIEF OF POLICE	DATE	
				APPROVED: PROJECT DIRECTOR
APPROVED: DIRECTOR FMS	DATE	APPROVED: SAFETY MANAGER	DATE	
ALTROVED. DIRECTOR FIND	DATE	ALTROVED. SALETT MANAGER	DATE	APPROVED: PROJECT DIRECTOR
		I .	11	I



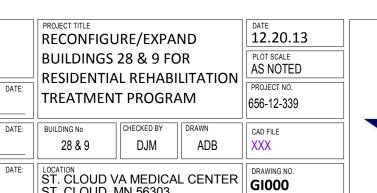



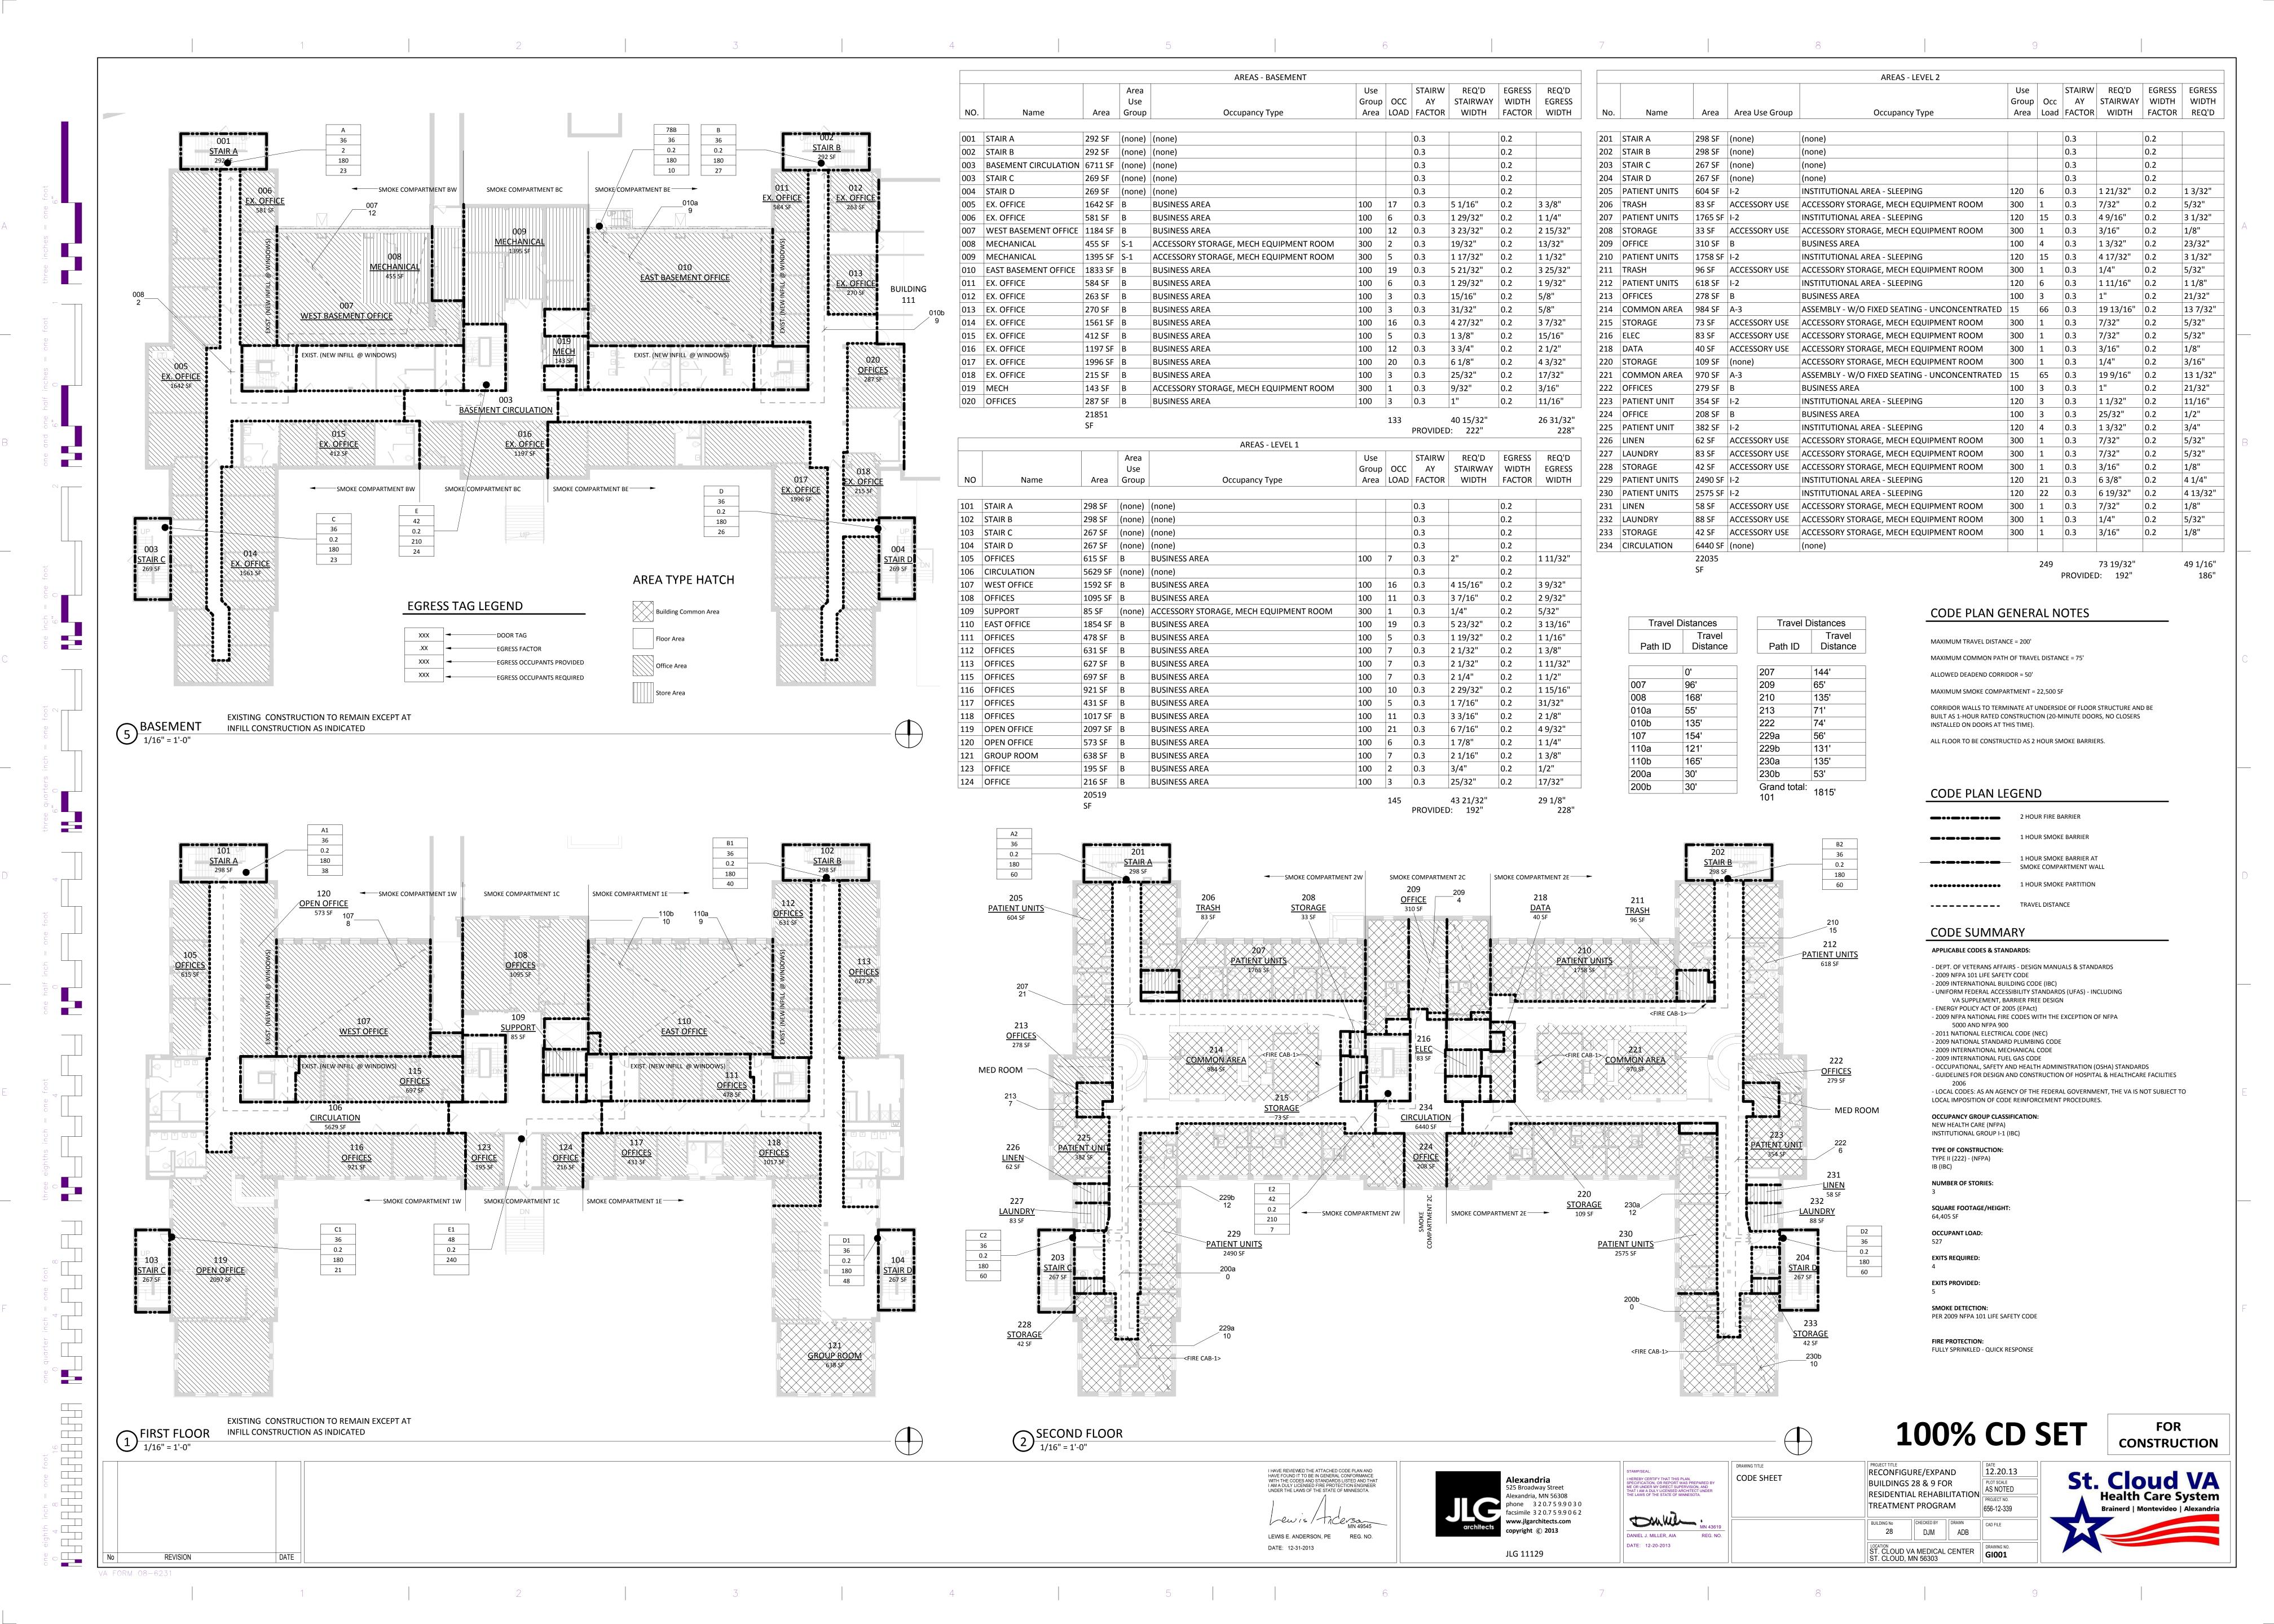

	PHASING SEQUENCE NOTES						
Phase	DURATION OF WORK	NOTE					
P1A							
P1B.1	5 CONSECUTIVE DAYS						
P1B.2	5 CONSECUTIVE DAYS						
P1B.3	1 WEEKEND IN EA. ROOM						
P1B.4	3 WEEKS	CONSTRUCTION SURROUNDING EXIST. CORRIDOR MUST OCCUR WITHIN 3 CONSECUTIVE WEEKS. CORRIDOR MUST BE FULLY OPERATIONAL FOLLOWING TH 3 WEEKS OF BEING CLOSED FOR CONSTRUCTION.					
P1C		NO DEMO MAY OCCUR ON 2ND FLOOR UNTIL INFILL WORK AND WALL SEPARATION TO INFILL WORK IS COMEPLETE, AND THE CONNECTING CORRIDOR IS BACK IN SERVICE. OWNER WILL BE USING AREAS OF SW WING AS TEMP SPACE DURING BASMENT AND FIRST FLOOR WINDOW INFILL WORK.					
P1C.1	3 CONSECUTIVE WEEKENDS						
P1C.2	1 WEEKEND						
P2A.1	5 CONSECUTIVE DAYS						
P2B.1	5 CONSECUTIVE DAYS						
P2C							
P2C.1	1 WEEKEND IN EA. SPACE						
P2C.2	3 CONSECUTIVE WEEKENDS						

PHASING PLAN GENERAL NOTES

- A. COORDINATE ALL CONSTRUCTION SEQUENCING WITH V.A. PROJECT C.O.R. PRIOR TO BEGINNING ANY WORK.
- B. CONSTRUCTION BARRIERS TO BE BUILT AS FOLLOWS:

 FULL HEIGHT TO UNDERSIDE OF STRUCTURE ABOVE

 1-HR RATED WITH ACOUSTIC INSULATION

 -FINISHED ON PATIENT/PUBLIC SIDE
- C. 5'-0" CLEAR MINIMUM DIMENSION TO BE MAINTAINED AT CORRIDORS WITH A CONSTRUCTION BARRIER. CLEAR DIMENSION INCLUDES HANDRAILS, ETC.
- D. SPRINKLER HEADS MUST BE A MINHMUM 4" OFF A WALL.
 TEMPORARILY RELOCATE HEADS AS NEEDED FOR CONSTRUCTION
- BARRIER PLACEMENT.

 E. TEMPORARILY RELOCATE FIXTURES AND DEVICES AS NOTED TO
- F. REPLACE ANY DAMAGED A.C.T. GRID AND CEILING WITH NEW

COMPLETE CONSTRUCTION BARRIER INSTALLATION.

A.C.T. OR FOR THE DAMAGED PIECES. MATCH EXIST.

- G. RETURN TEMPORARILY RELOCATED SPRINKLER HEADS, FIXTURES, AND DEVICES TO ORIGINAL LOCATIONS UNLESS INDICATED
- OTHERWISE.


 H. AT NO TIME THROUGHOUT THE PROJECT MAY THE
- CONSTRUCTION

 WORK OR EQUIPMENT REQUIRED FOR COMPLETING THE WORK
 OBSTRUCT ACCESS TO STAIRS AND ELEVATORS.
- I. DASHED WALLS AND INDICATE TEMPORARY CONSTRUCTION PARTITIONS.

P2B.1 WDW INFILL WORK.

	PHASING KEYNOTES
NO.	NOTE
1	ACCESS TO ELEVATORS AND STAIRS TO BE MAINTAINED THROUGHOUT DURATION OF CONSTRUCTION
2	COORDINATE INSTALL OF CABLE TRAY AND CONDUIT TO/FROM ELEC. RM 234 WITH COR, ACCESS TO STAIR AND ELEVATOR MUST BE MAINTAINED.
3	COORDINATE INSTALL OF NEW FINISHES WITH COR. VERTICULAR CIRCULATION TO REMAIN ACCESSIBLE THROUGHOUT CONSTRUCTION.
4	ROOM 131 BECOMES A CORRIDOR AND DOES NOT GET


TURNED OVER TO OWNER WITHIN 5 DAY PERIOD OF

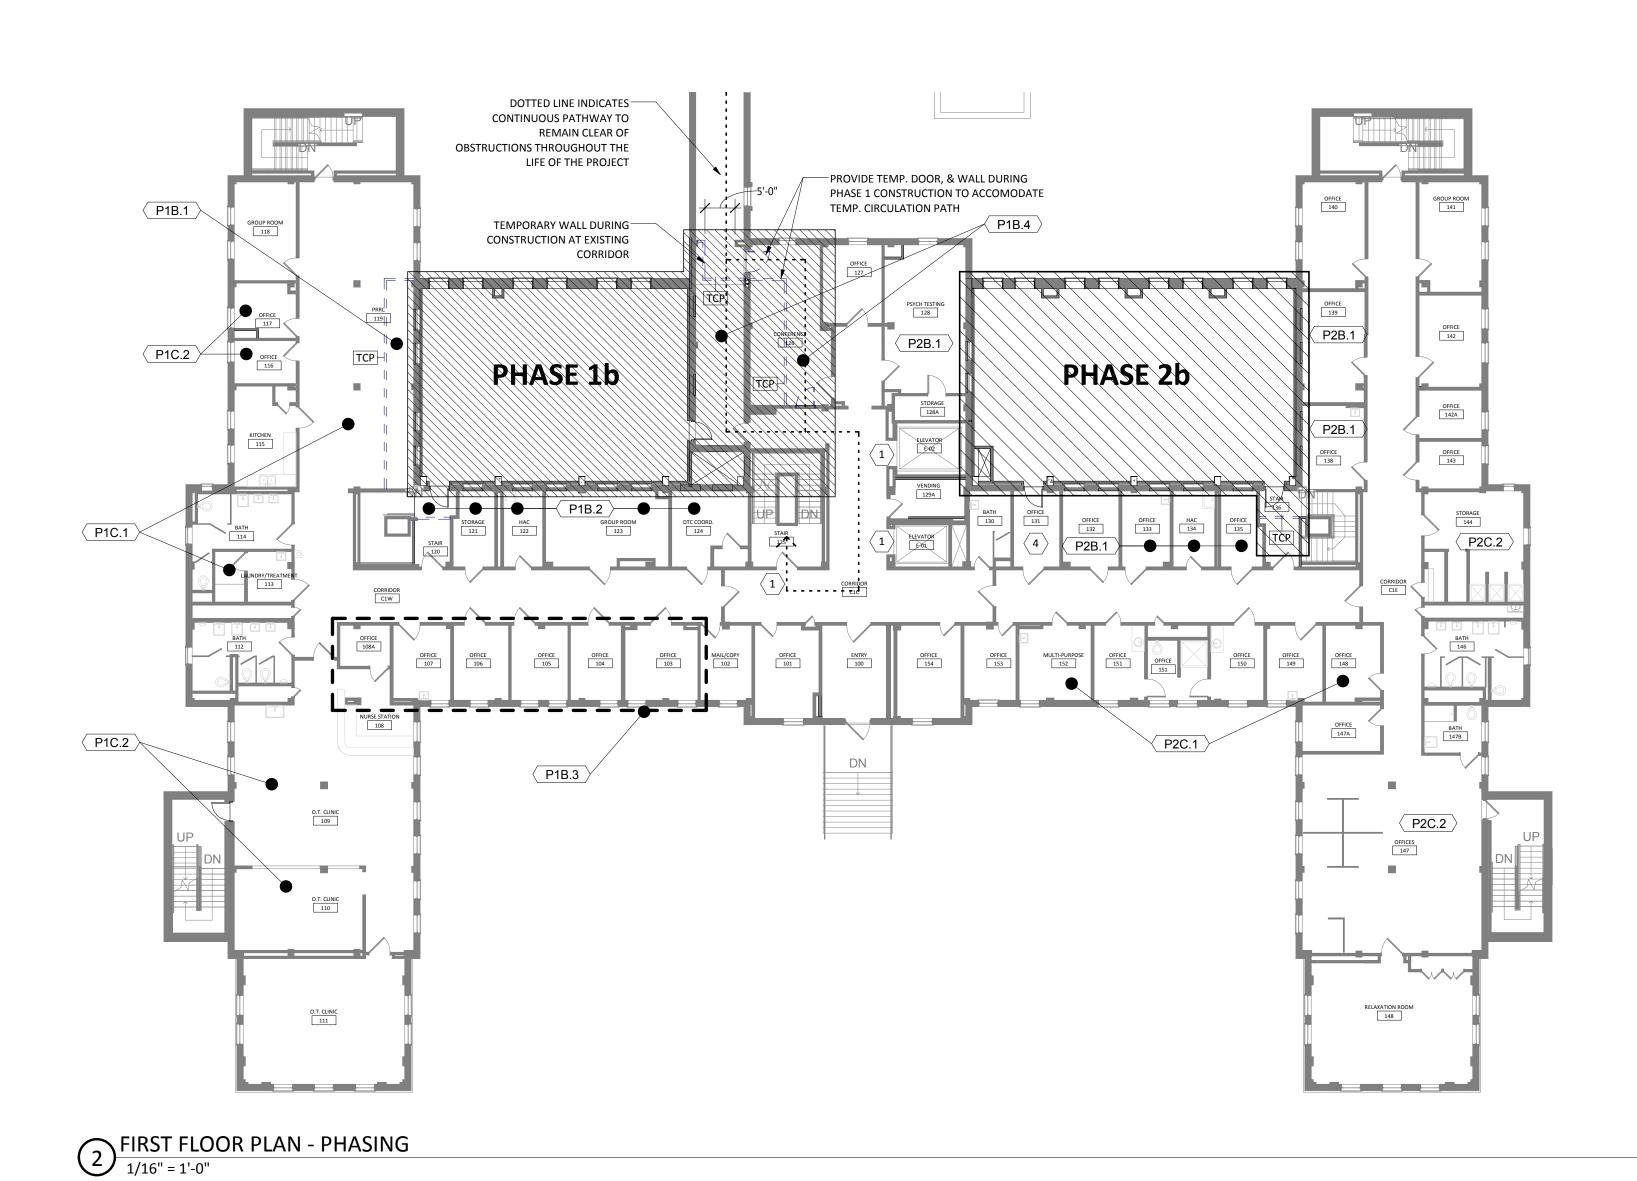

2 5 6

4 8 16

REVISION

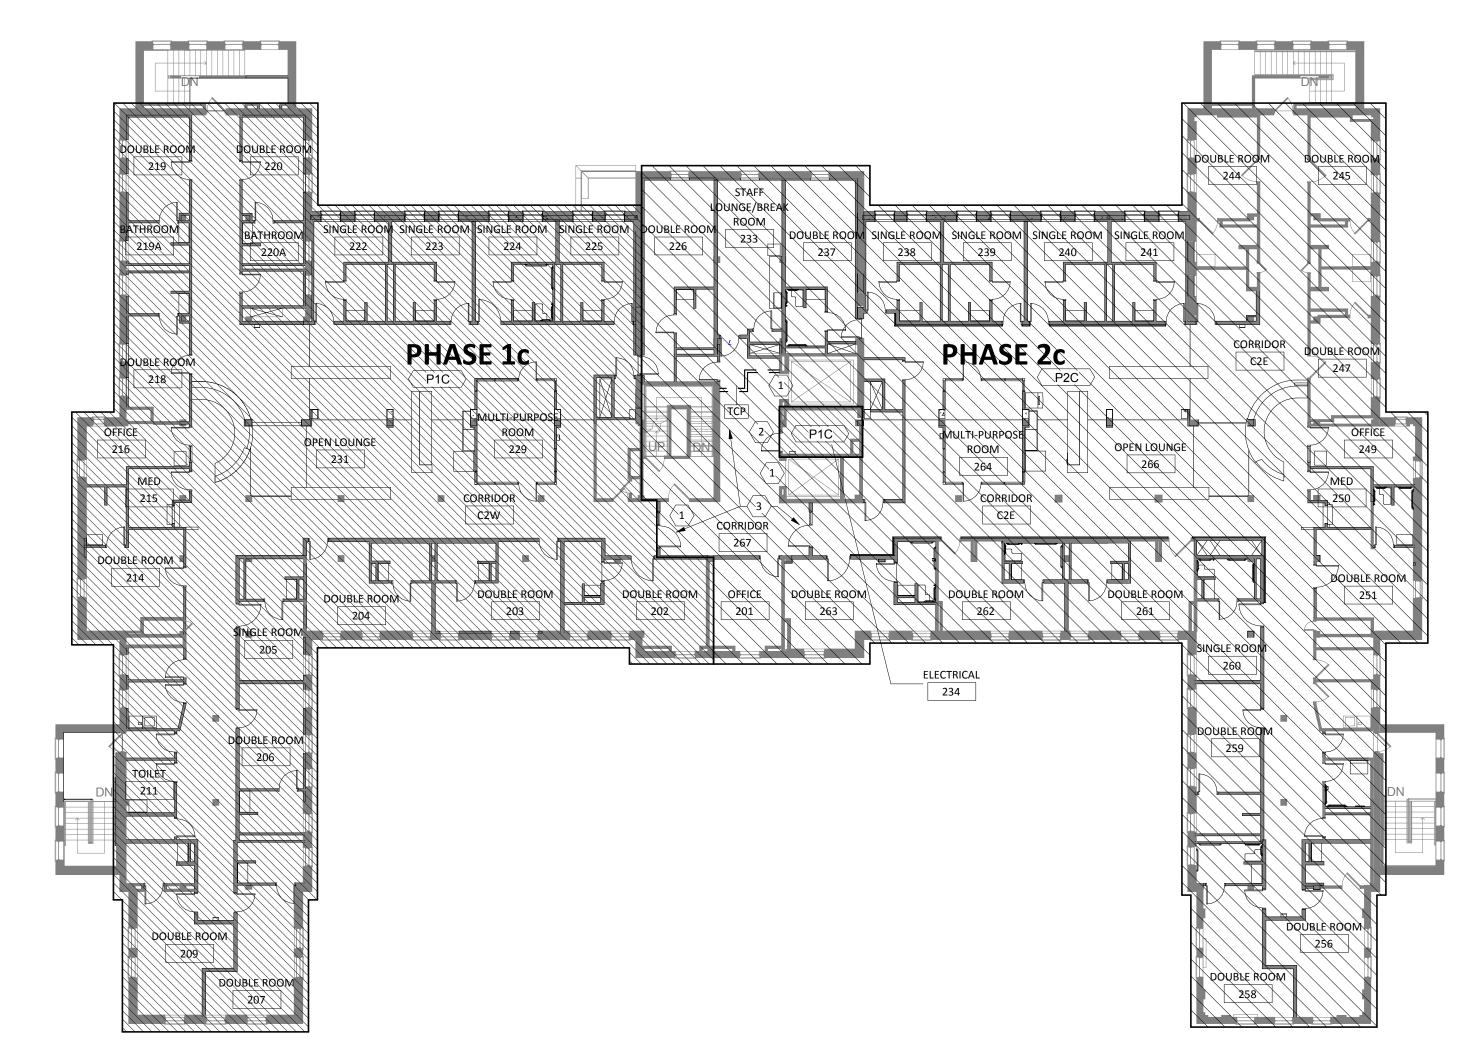


SECOND FLOOR PLAN - PHASING

1/16" = 1'-0"

100% CD SET

ST. CLOUD VA MEDICAL CENTER ST. CLOUD, MN 56303

FOR CONSTRUCTION

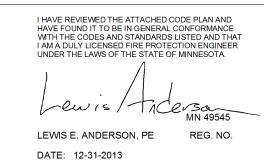





PROJECT TITLE
RECONFIGURE/EXPAND
BUILDINGS 28 & 9 FOR
RESIDENTIAL REHABILITATION
TREATMENT PROGRAM

BUILDING NO
28

CHECKED BY
DJM
DATE
12.20.13
PLOT SCALE
AS NOTED
PROJECT NO.
656-12-339

CAD FILE





PARTITION TYPE M

COMMENTS


WALL BLOCK SIZE G.B. THK INSUL

8 4 9


REVISION

TAG (NOM.) WIDTH (EA. SIDE) THICK. RATING UL NO.


M8 8" 7 5/8" -- -- -- -- -- -- M12 12" 11 5/8" -- -- -- -- --

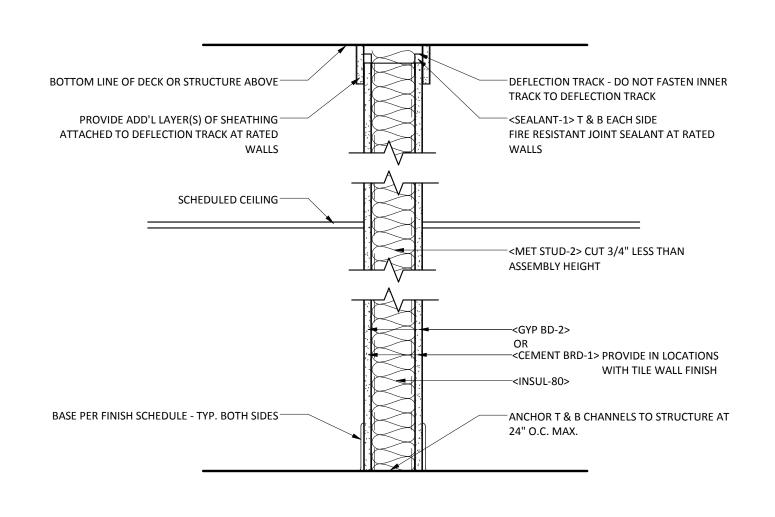

	PARTITION TYPE 1							
WALL			G.B. THK	INSUL				
TAG	STUD SIZE & SPACING	WIDTH	(EA. SIDE)	THICK.	RATING	UL NO.	COMMENTS	
1A	3 5/8" M.S. @ 16" O.C.	4 7/8"	5/8"	FILL CAVITY				
1a	25 GA. 3 5/8" 24" O.C.	4 7/8"	5/8"	3" SAFB		U419	STC 49	
1b	25 GA. 5 1/2" 24" O.C.	7 1/4"	5/8"	3" SAFB		U419	STC 49	

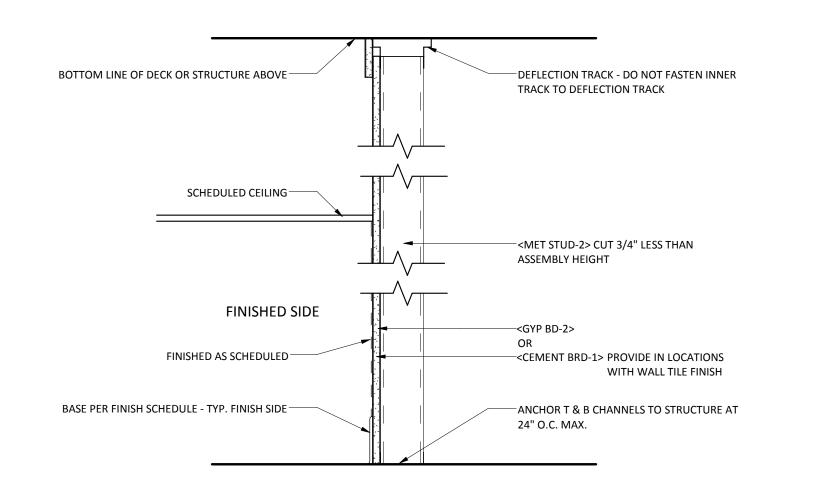



			PARTITIO	ON TYPE 2			
WALL			G.B. THK	INSUL			
TAG	STUD SIZE & SPACING	WIDTH	(EA. SIDE)	THICK.	RATING	UL NO.	COMMENTS
2a	24 GA. 2 1/2" 16" O.C.	3 1/8"	5/8" ONE SIDE	N/A	N/A	N/A	
2b	24 GA. 3 5/8" 16" O.C.	4 1/4"	5/8" ONE SIDE	N/A	N/A	N/A	

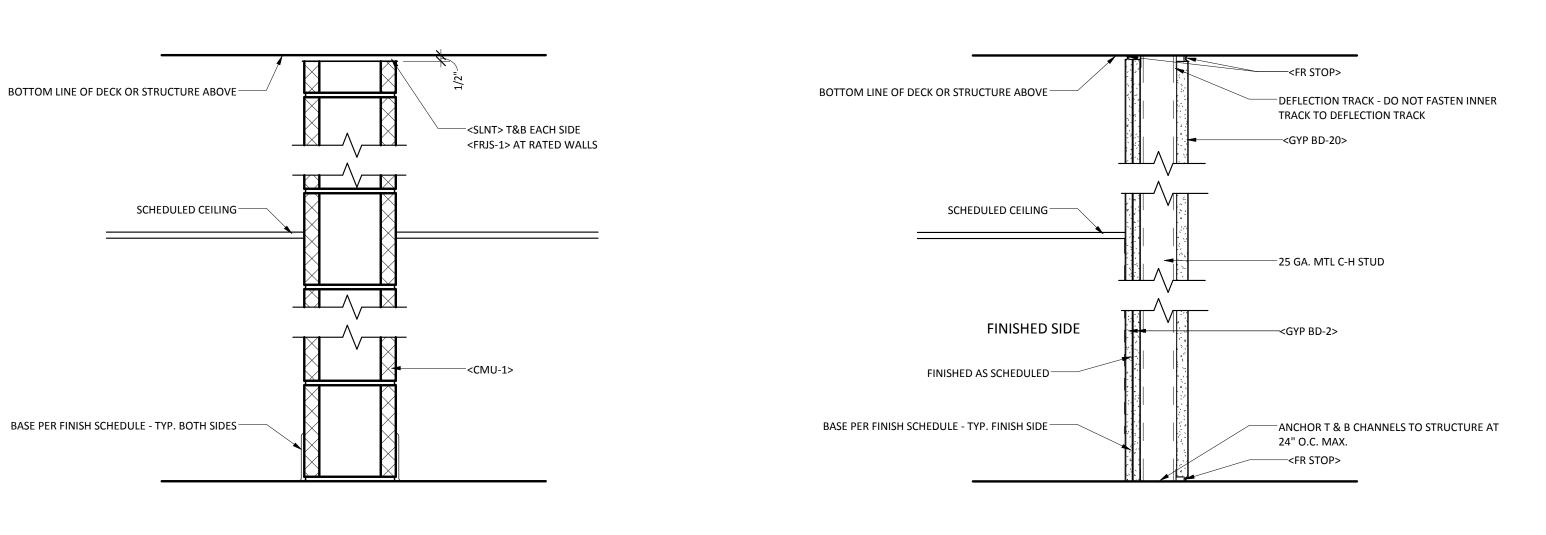

			PARTITION TYPE 3				
WALL				INSUL		UL	
TAG	STUD SIZE & SPACING	WIDTH	G.B. THK (EA. SIDE)	THICK.	RATING	NO.	COMMENTS
3a	25 GA. 4" C-H STUD 16" O.C.	5 1/4"	(2) 5/8" ONE SIDE/1" SHAFT	N/A	2HR	U415	
			LINER				
3b	25 GA. 6" C-H STUD 16" O.C.	7 1/4"	(2) 5/8" ONE SIDE/1" SHAFT	N/A	2HR	U415	
			LINER				


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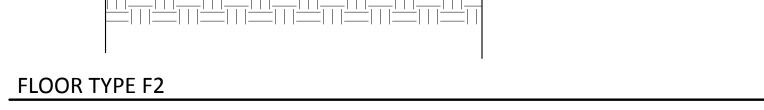


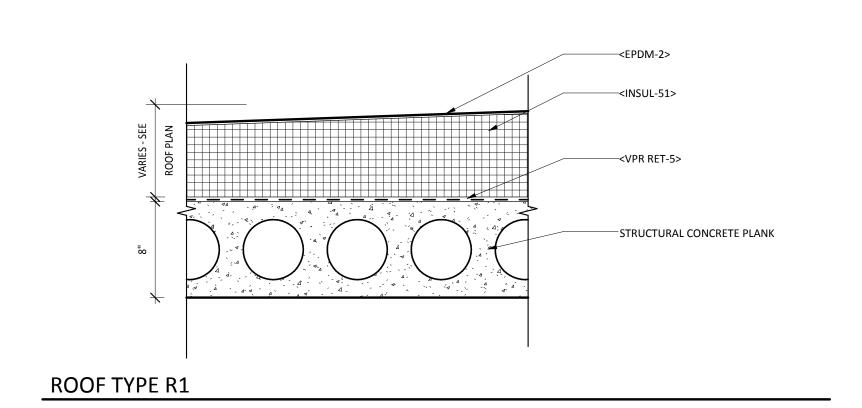


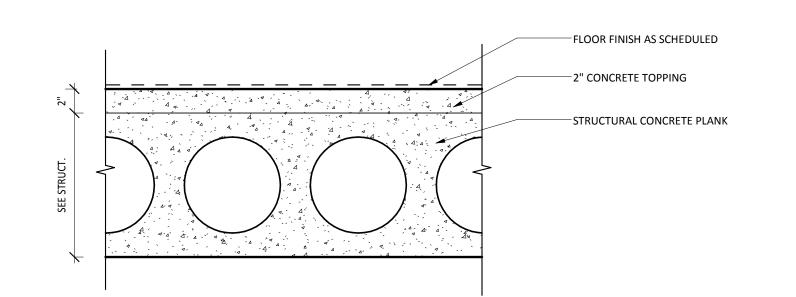
FLOOR TYPE F1

FLOOR TYPE F3



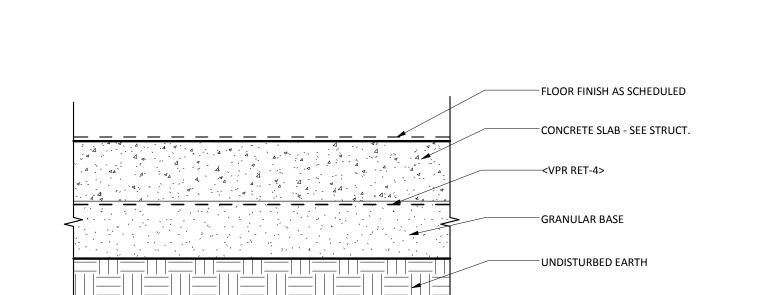


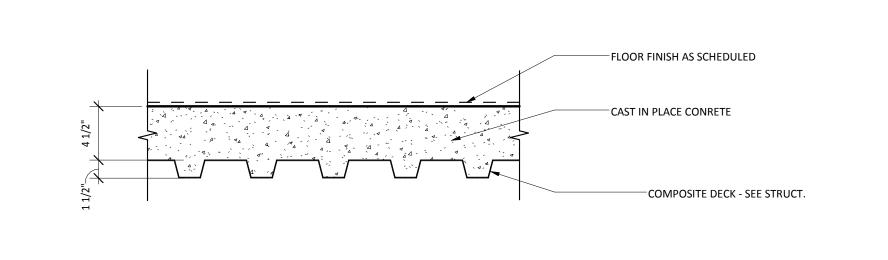

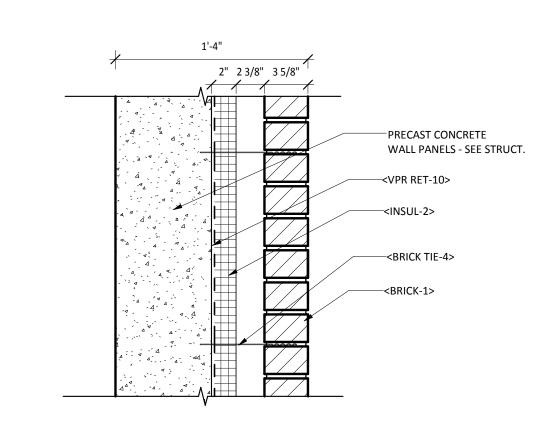


CAVITY WALL WITH PRECAST BACKUP							
	STRUCTURAL	INSULATION					
TAG	THICKNESS	THICKNESS	R-VALUE	COMMENTS			
W1a	0' - 8"	2.5"	15.72				
W1b	0' - 10"	2.5"	15.72				

WALL TYPE W1

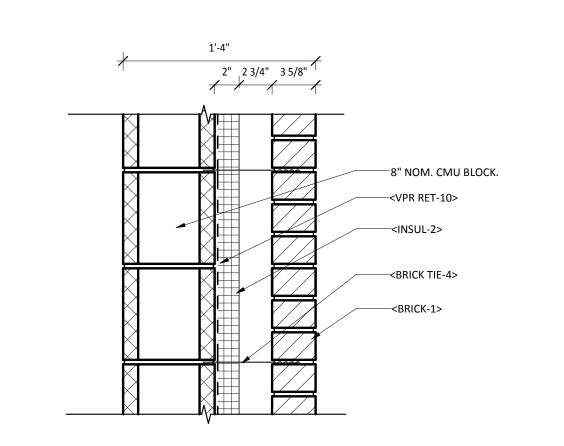

	CA	VITY WALL WITH BLOCK E	BACKUP	
		MIN. EQUIVALENT		
	STRUCTURAL	THICKNESS (IBC Table		
TAG	THICKNESS	7.21.3.2)	R-VALUE	COMMENTS
W2		4.2"	15.72	

WALL TYPE W2

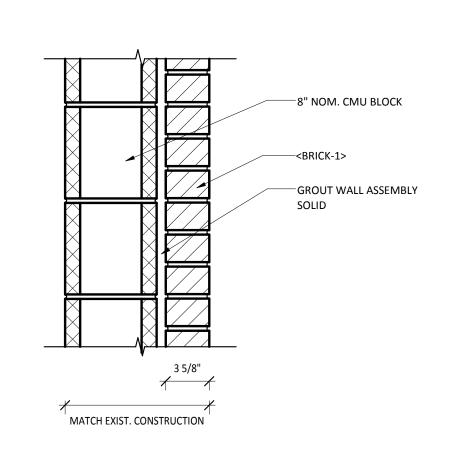

WALL TYPE W3


EXTERIOR WALL AT INFILL LOCATIONS


	SHEET MATERIAL ID LIST
MATERIAL ID	SPEC SECTION & DESCRIPTION
BRICK TIE-4	04 2000 - BRICK TIE SUITABLE FOR BACKUP WALL CONSTRUCTION
BRICK-1	04 2000 - FACE BRICK
CEMENT BRD-1	06 1663 - CEMENT BOARD SHEATHING BEHIND WALL TILE
EPDM-2	07 5300 - FULLY ADHERED EPDM ROOFING SYSTEM
FR STOP	07 8400 - THROUGH PENETRATION FIRESTOPPING
GYP BD-2	09 2116 - 5/8" FIRE-RATED TYPE 'X' GYPSUM BOARD
GYP BD-20	09 2116 - 1" FIRE-RATED TYPE 'X' GYPSUM SHAFT LINER
INSUL-2	07 2100 - EXTRUDED POLYSTYRENE WALL INSULATION
INSUL-51	07 2200 - TAPERED POLYISO OVER FLAT POLYISO ROOF INSULATION
INSUL-80	09 2116 - MINERAL WOOL ACOUSTICAL INSULATION
VPR RET-4	03 3000 - 15 MIL UNDERSLAB VAPOR RETARDER
VPR RET-5	07 2200 - 40 MIL SELF-ADHERED VAPOR BARRIER
VPR RET-10	07 2500 - SELF ADHERED OR LIQUID APPLIED VAPOR RETARDER

100% CD SET






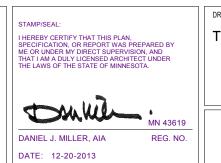

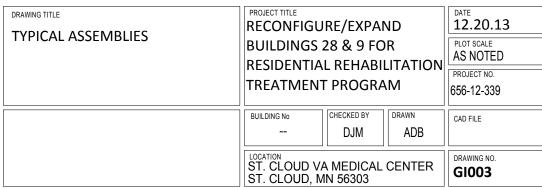



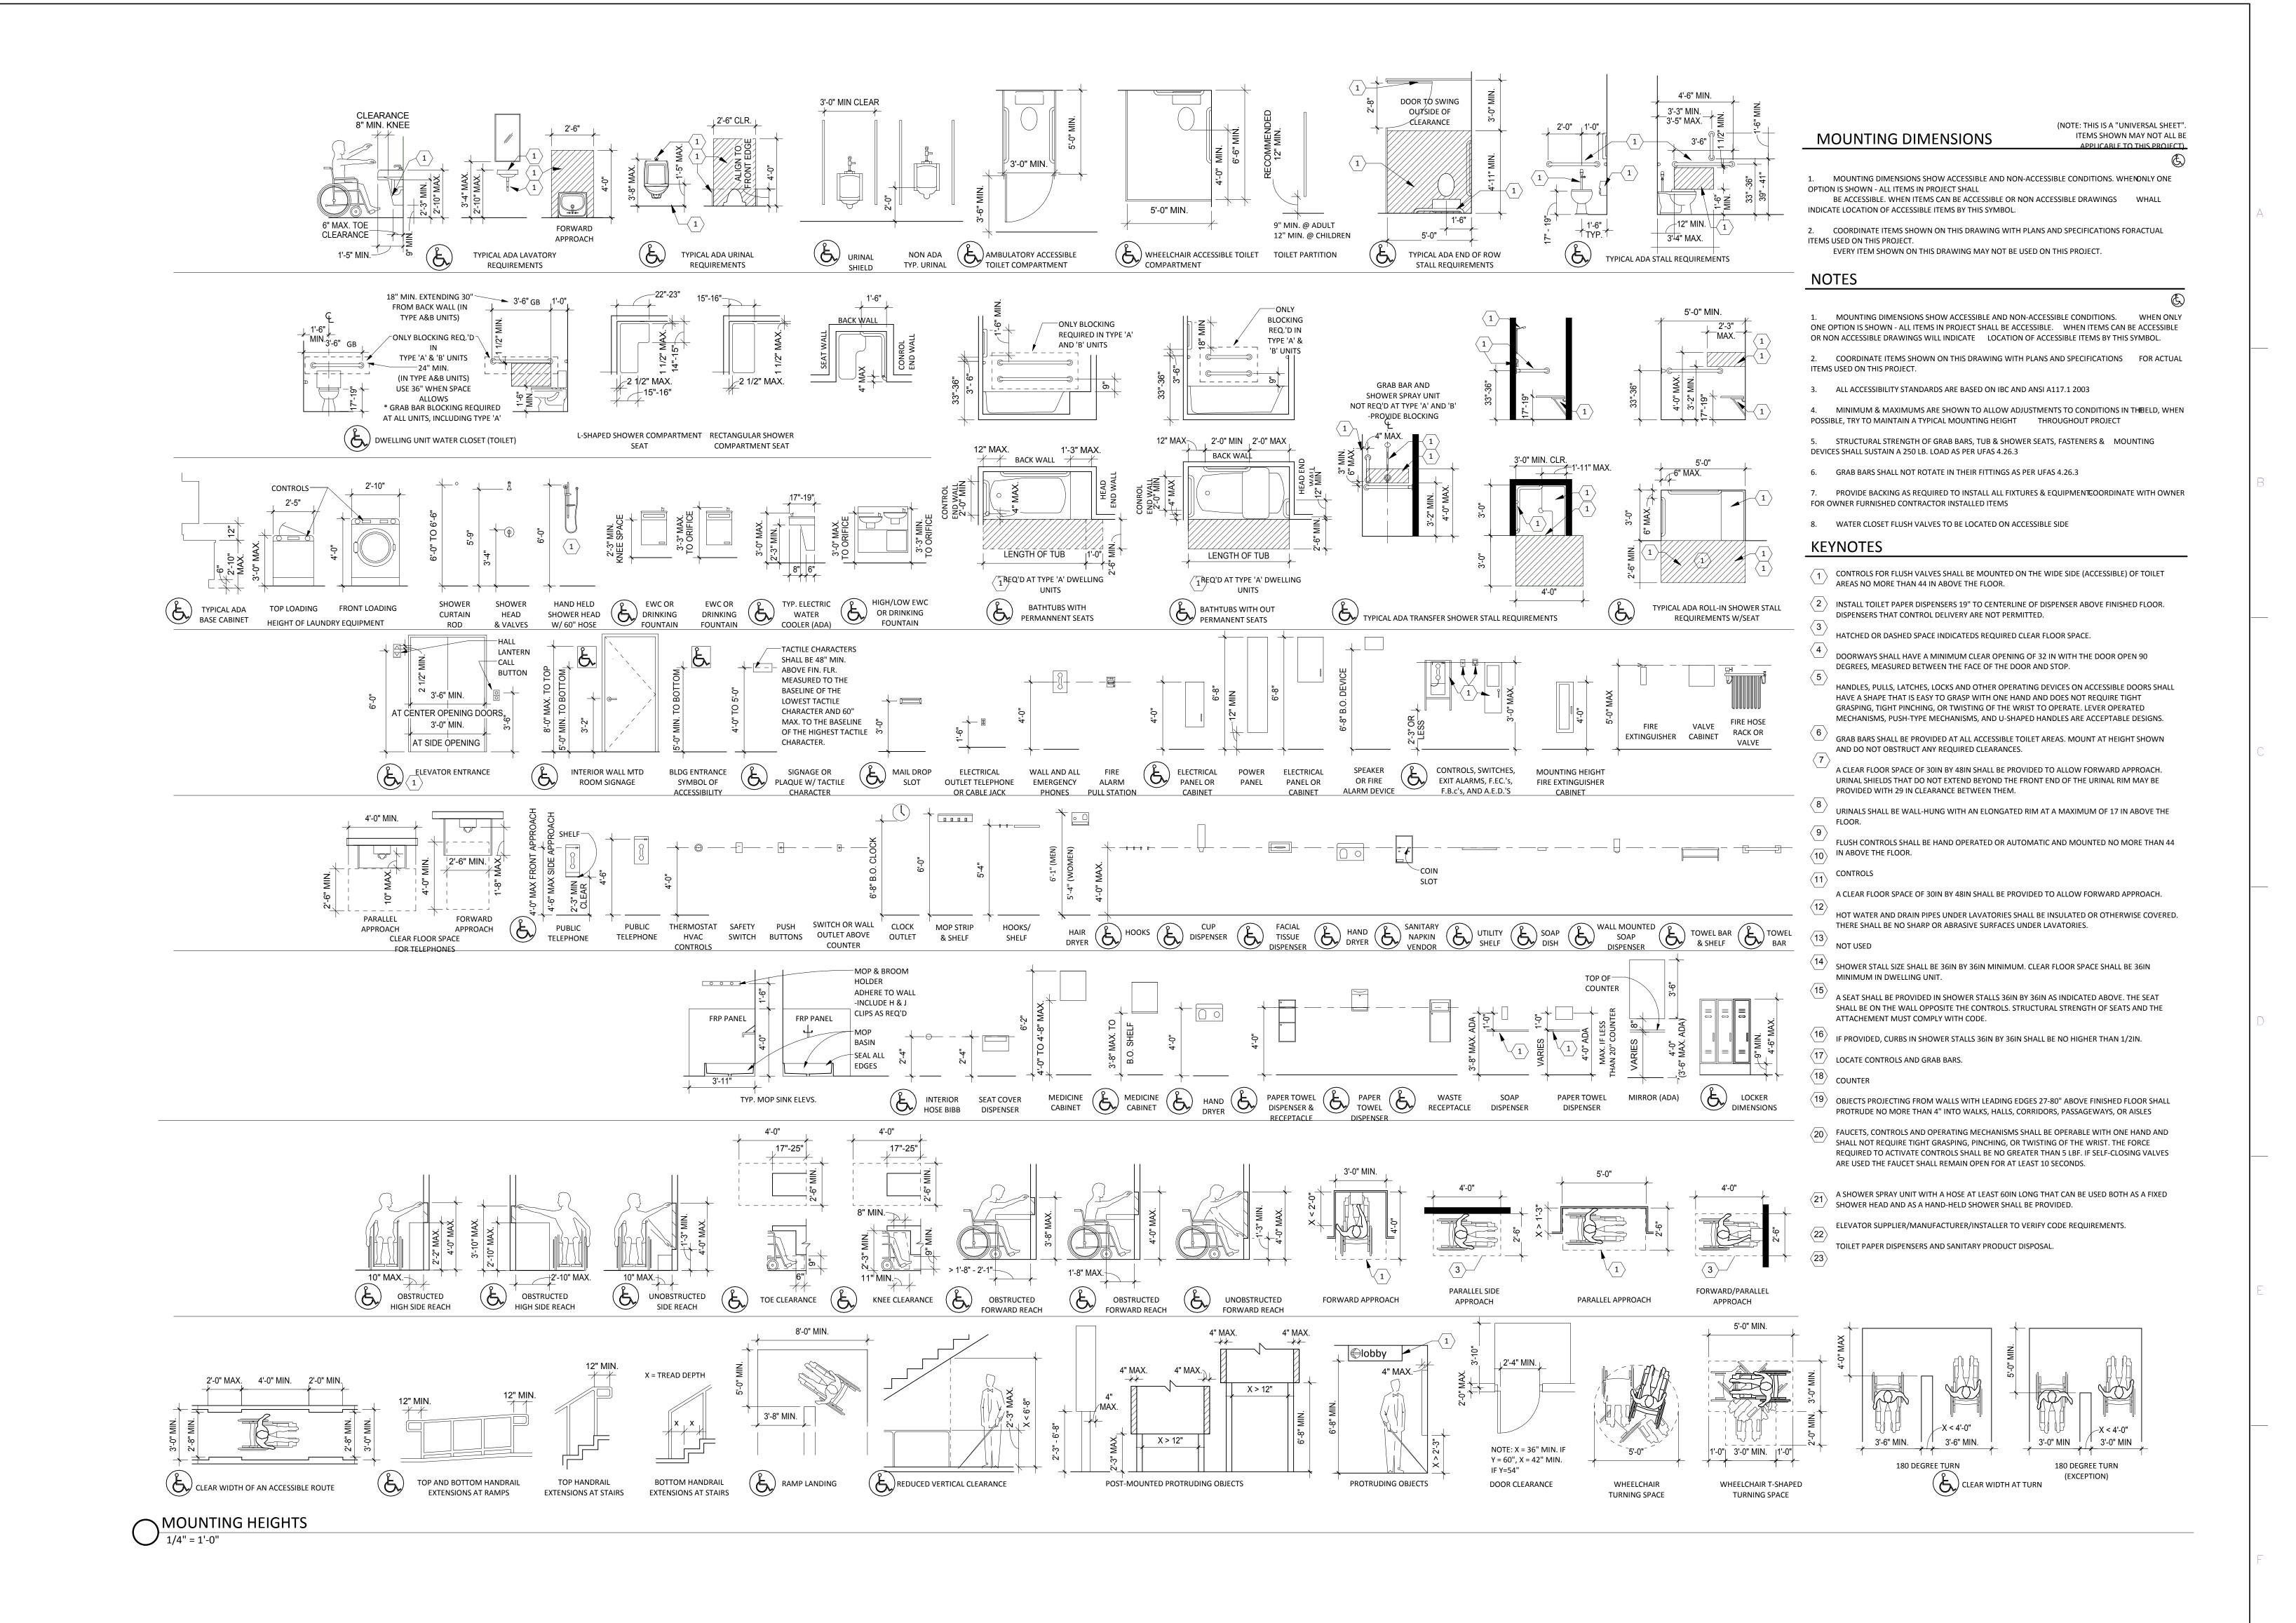

9 4 8


REVISION

100% CD SET





2 5 6

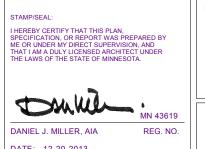





7 8

RECONFIGURE/EXPAND PROJECT TITLE
RECONFIGURE/EXPAND
BUILDINGS 28 & 9 FOR
RESIDENTIAL REHABILITATION
TREATMENT PROGRAM TREATMENT PROGRAM 656-12-339 DJM ADB

ST. CLOUD VA MEDICAL CENTER ST. CLOUD, MN 56303

