


KEYED NOTES:

- 1 AHU IC-AHU22 WILL BE RE-SHEAVED AND REBALANCED TO PROVIDE ADDITIONAL COOLING DURING PHASED CONSTRUCTION. REFER TO PHASING PLAN FOR DETAILS. AFTER AHUS AND HEHUS ARE INSTALLED AND OPERATIONAL, REMOVE IC-AHU22. COMPLETE. REMOVE ALL SUPPLY AND OUTSIDE AIR DUCTWORK. REMOVE ALL DUCTWORK SUPPORTS AND HANGERS. REMOVE ALL CONTROLS AND CONTROL VALVES AND DEVICES. REMOVE ALL CONTROL WIRING AND CONDUIT BACK TO SOURCE. REMOVE ALL PNEUMATIC TUBING BACK TO SOURCE AND CAP AT SOURCE. REMOVE ALL ELECTRICAL WIRING AND CONDUIT BACK TO ELECTRICAL PANEL AND UPDATE DIRECTORY. CONCRETE EQUIPMENT PADS TO REMAIN.
- 2 PATCH WALL TO MATCH EXISTING MATERIAL. PRIME AND PAINT EXTERIOR TO MATCH EXISTING COLOR.
- 3 REMOVE DUCTWORK DOWN TO LEVEL 3. CAP ROOF CURB WATERTIGHT WITH INSULATED CURB CAP.
- 4 REMOVE EXHAUST FAN, CAP ROOF CURB WATERTIGHT WITH INSULATED CURB CAP. DUCTWORK ON LEVEL 3 TO REMAIN. REMOVE ELECTRICAL BACK TO J-BOX ON ROOF. TURN OFF BREAKER AT PANEL BOARD AND UPDATE DIRECTORY.
- 5 REMOVE EXHAUST FAN, REMOVE DUCTWORK DOWN TO LEVEL 3. CAP ROOF CURB WATERTIGHT WITH INSULATED CURB CAP. REMOVE ELECTRICAL BACK TO J-BOX ON ROOF. TURN OFF BREAKER AT PANEL BOARD AND UPDATE DIRECTORY.
- 6 REMOVE/REPLACE EXHAUST FAN, REWORK CURB AS REQUIRED.
- 7 REMOVE EXHAUST FAN, REMOVE EXHAUST STACK. REMOVE DUCTWORK DOWN TO LEVEL 3. CAP ROOF CURBS AND EQUIPMENT PADS WATERTIGHT WITH INSULATED CURB CAP. REMOVE ALL 6" WIRING. ABANDON ALL SUPPORTS IN PLACE. REFLASH AND SEAL AS REQUIRED TO RESTORE WATERPROOFING. REMOVE DISCONNECTS. REMOVE ELECTRICAL BACK TO J-BOX ON ROOF. TURN OFF BREAKER AT PANEL BOARD AND UPDATE DIRECTORY.
- 8 REMOVE GOOSENECK AND 18"16 OUTSIDE AIR DUCT DOWN TO MECHANICAL ROOM. CAP ROOF CURB WATERTIGHT WITH INSULATED CURB CAP.
- 9 REMOVE RELIEF HOOD TO ACCESS MECHANICAL ROOM FOR DEMOLITION AND REMOVAL OF EXISTING EQUIPMENT AND INSTALLATION OF NEW EQUIPMENT. PROVIDE TEMPORARY VENTILATED COVER DURING CONSTRUCTION AS REQD TO MAINTAIN WATERPROOF INTEGRITY OF THE ROOF OPENING. REINSTALL RELIEF HOOD AFTER NEW EQUIPMENT HAS BEEN INSTALLED.
- 10 REMOVE OA-15. REMOVE DUCTWORK BELOW THE ROOF SERVING AHU4. CAP ROOF CURB WATERTIGHT WITH INSULATED CURB CAP.
- 11 ABANDON ALL SUPPORTS IN PLACE. REFLASH AND SEAL PITCH PANS AS REQUIRED TO RESTORE WATERPROOFING.
- 12 REMOVE EV-1 AND ROOF CURB. REMOVE ROOFING AND REPLACE ROOFING AS REQUIRED TO INSTALL NEW EXHAUST FAN. REFER TO HVAC PLANS.
- 13 REMOVE OA DUCT UP TO ROOF. REMOVE OA INTAKE ON ROOF. CAP ROOF CURB WITH INSULATED CURB CAP.
- 14 REMOVE CONTROL PANEL(S) LTCP-1. REMOVE ALL CONTROL WIRING AND CONDUIT BACK TO SOURCE. REMOVE VFD. REMOVE WIRING AND CONDUIT BACK TO PANEL EQ44A (20, 22, 24). UPDATE DIRECTORY. DELIVER VFD TO COR.


GENERAL NOTES:

1. COORDINATE ALL DEMOLITION WORK WITH PHASING PLAN, NEW WORK AND THE COR. ALL ABANDONED CONTROL DEVICES ARE NOT SHOWN FOR CLARITY. REMOVE ALL ABANDONED CONTROL DEVICES SERVING AHU IC-AHU22 AS DIRECTED BY COR.
2. EQUIPMENT REMOVED FROM AND INSTALLED IN THE LEVEL 3 INTERSTITIAL MECHANICAL ROOM SHALL BE HOISTED THROUGH THE RELIEF HOOD ROOF OPENING. DISASSEMBLE EXISTING EQUIPMENT AS REQD BY HOISTING LIMITATIONS. COORDINATE ALL NEW EQUIPMENT SIZES, LIFTING REQUIREMENTS AND SHIPPING SPLITS WITH THE MANUFACTURER.
3. COORDINATE AND SCHEDULE ALL EQUIPMENT DELIVERIES AND CRANEHOISTING REQUIREMENTS WITH THE COR. USE OF THE PARKING LOT TO STAGE EQUIPMENT AND CRANE WILL BE RESTRICTED TO AFTER NORMAL WORKING HOURS AND WEEKENDS AS APPROVED BY THE COR.
4. FIELD VERIFY ALL EXISTING EQUIPMENT, PIPE AND DUCT SIZES AND WATERPROOFING REQUIREMENTS.
5. COORDINATE ALL ROOFING REPAIR AND EQUIPMENT INSTALLATION REQUIREMENTS WITH THE ROOFING COMPANY MAINTAINING THE ROOF WARRANTY AND THE COR.

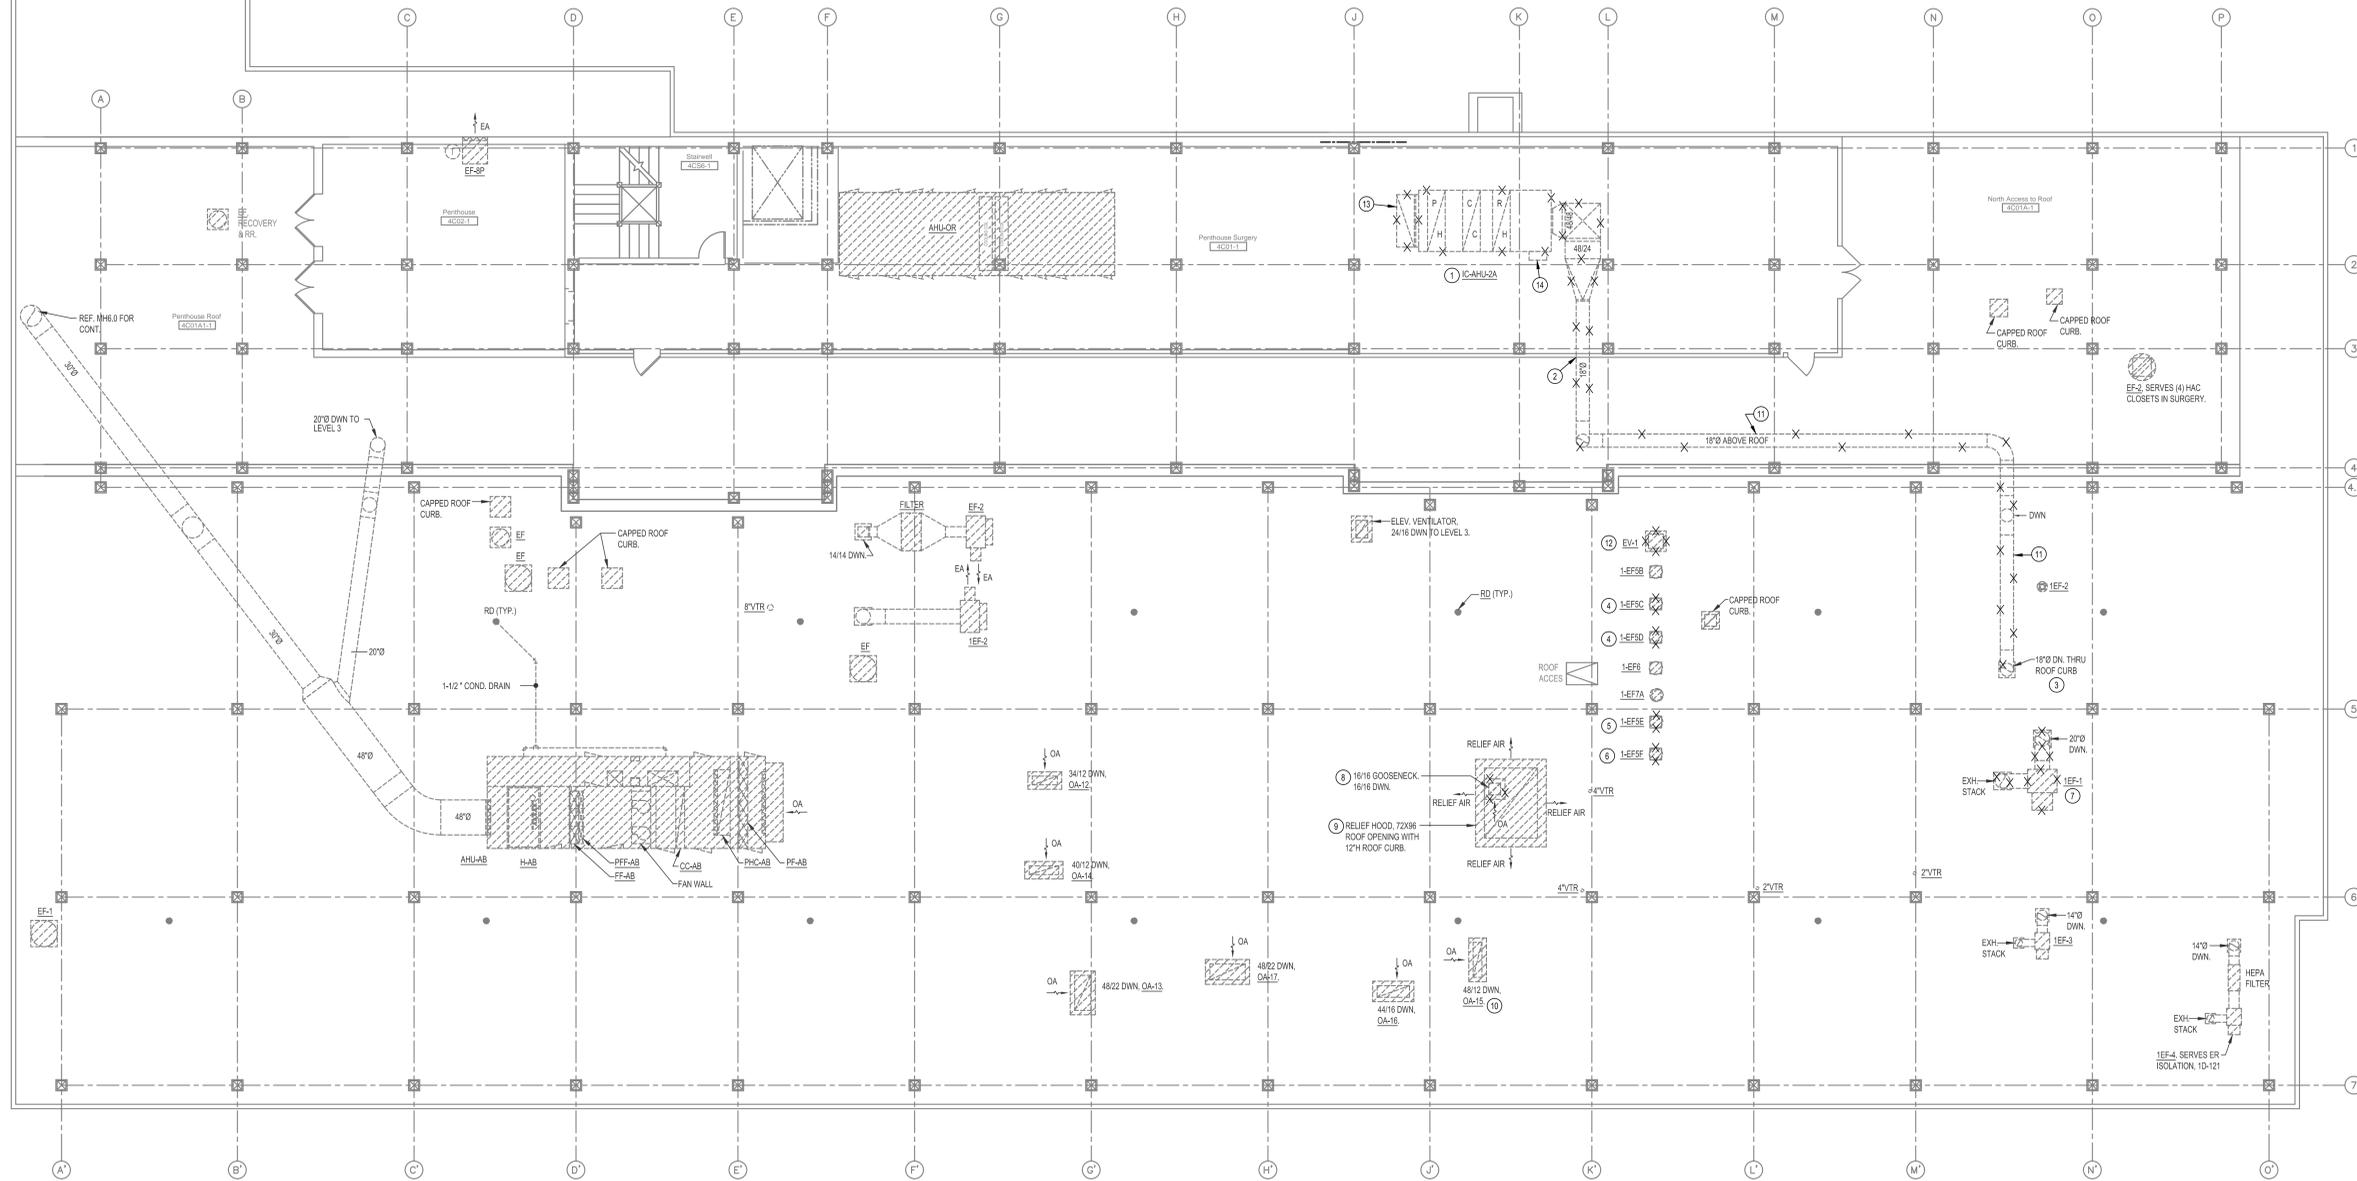

1 LEVEL 4, WING C: PENTHOUSE & ROOF HVAC DEMO PLAN
18'-11"

ASBESTOS NOTE:
IF THE EXECUTION OF THIS WORK REQUIRES THE DISTURBING OF ANY SUBSTANCE WHICH APPEARS TO BE ASBESTOS OR WHICH MAY CONTAIN ASBESTOS FIBER, NOTIFY THE OWNER BEFORE CONTINUING WORK AT THE SUSPECT LOCATION. ANY MATERIAL TESTING POSITIVE SHALL BE REMOVED BY THE OWNER BEFORE WORK CONTINUES.
NOTE: EXISTING CONDITIONS SHOWN WERE DERIVED FROM OWNER FURNISHED DRAWINGS AND FIELD OBSERVATIONS. SOME BUILDING FEATURES AND MEP SYSTEMS ARE NOT SHOWN FOR CLARITY. FIELD VERIFY BUILDING CONSTRUCTION. FIELD VERIFY THE LOCATION, SIZE AND QUANTITY OF ALL EQUIPMENT.
NOTE: REFER TO DETAILS AND SCHEMATICS FOR PIPING, VALVES, FITTINGS AND OTHER APPURTENANCES REQUIRED, BUT NOT SHOWN FOR CLARITY.

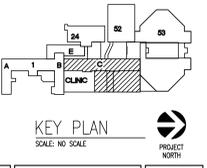

REVISIONS	DESCRIPTION	DATE



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APPROVED:	APPROVED: Interior Designer
APPROVED:	APPROVED:
APPROVED:	APPROVED:
APPROVED:	APPROVED:

APPROVED: Safety Manager	APPROVED: Medical Center Director
APPROVED: Infection Control Nurse	APPROVED: Associate Director
APPROVED: Industrial Hygienist	APPROVED: Chief of Staff
APPROVED: President A.F.G.E. 2250	APPROVED: Chief of Engineering Service

DRAWING TITLE LEVEL 4, WING C: PENTHOUSE & ROOF HVAC DEMO PLAN	PROJECT TITLE REPLACE LABORATORY AIR HANDLING UNITS
PROJECT NO. 623-11-107	CONTRACT NO. VA256-12-C-0295
BUILDING NO. CLINICAL	AUTOCAD FILE NAME:

DATE 8/19/2013	SCALE AS SHOWN	DRAWING NO. MHD3.0
DESIGNED BY:	DRAWN BY:	CHECKED BY:
LOCATION Jack C. Montgomery VA Medical Center		

DEPARTMENT OF VETERANS AFFAIRS

DWG. 11 OF 40