
















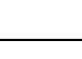

three inches = one foot  
one and one half inches = one foot  
one inch = one foot  
three quarters inch = one foot  
three quarters inch = one foot  
one half inch = one foot  
one half inch = one foot  
three eighths inch = one foot  
one quarter inch = one foot  
one eighth inch = one foot

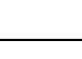
SHEET NOTES																																																																															
<div>SECURITY SHEET INDEX</div> <table><thead><tr><th>SHEET NUMBER</th><th>SHEET NAME</th></tr></thead><tbody><tr><td>TY001</td><td>SECURITY LEGEND AND NOTES</td></tr><tr><td>TY201D</td><td>SECURITY GROUND FLOOR DEMOLITION PLAN</td></tr><tr><td>TY202D</td><td>SECURITY SECOND FLOOR DEMOLITION PLAN</td></tr><tr><td>TY201</td><td>SECURITY GROUND FLOOR PLAN</td></tr><tr><td>TY202</td><td>SECURITY SECOND FLOOR PLAN</td></tr><tr><td>TY301</td><td>SECURITY RISER DIAGRAM</td></tr><tr><td>TY401</td><td>SECURITY DETAILS</td></tr></tbody></table>				SHEET NUMBER	SHEET NAME	TY001	SECURITY LEGEND AND NOTES	TY201D	SECURITY GROUND FLOOR DEMOLITION PLAN	TY202D	SECURITY SECOND FLOOR DEMOLITION PLAN	TY201	SECURITY GROUND FLOOR PLAN	TY202	SECURITY SECOND FLOOR PLAN	TY301	SECURITY RISER DIAGRAM	TY401	SECURITY DETAILS	<div>INSTALLATION NOTES</div> <div><div>A. FURNISH AND INSTALL LOCK POWER SUPPLIES FOR ALL DOOR EQUIPPED WITH ELECTRIC LOCKS, EXCEPT AS FOLLOWS:  IF POWER SUPPLY IS SPECIFIED IN HARDWARE GROUP, POWER SUPPLY SHALL BE FURNISHED BY HARDWARE CONTRACTOR, AND INSTALLED &amp; POWERED BY DIVISION 16. SECURITY CONTRACTOR TO PROVIDE AND INSTALL ALL LOW VOLTAGE WIRING, TERMINATIONS, AND INTERFACE TO ACCESS CONTROL SYSTEM.</div><div>B. ALL EXIT DOORS TO REMAIN FREE OPENING FROM EXIT SIDE.</div><div>C. ON DOUBLE DOORS INSTALL TWO (2) CONTACTS, SERIES THE CIRCUIT AT THE DOORS AND RUN ONE CABLE TO HEAD-END.</div><div>D. ALL CABLES TO BE RUN IN CONDUIT.</div><div>E. PROVIDED BY THE GOVERNMENT.</div><div>F. PROVIDED BY HARDWARE CONTRACTOR.</div><div>G. PROVIDED BY THE GOVERNMENT IT.</div><div>H. ACP POWER 20A DEDICATED ON UPS OR GEN WHERE AVAILABLE.</div><div>I. BY ELECTRICAL CONTRACTOR.</div><div>J. DEVICE PART OF GOVERNMENT FURNISHED EQUIPMENT. CONTRACTOR TO PROVIDE WIRE.</div></div>																																																											
SHEET NUMBER	SHEET NAME																																																																														
TY001	SECURITY LEGEND AND NOTES																																																																														
TY201D	SECURITY GROUND FLOOR DEMOLITION PLAN																																																																														
TY202D	SECURITY SECOND FLOOR DEMOLITION PLAN																																																																														
TY201	SECURITY GROUND FLOOR PLAN																																																																														
TY202	SECURITY SECOND FLOOR PLAN																																																																														
TY301	SECURITY RISER DIAGRAM																																																																														
TY401	SECURITY DETAILS																																																																														
<div>SECURITY DEVICE LEGEND</div> <table><thead><tr><th>SYMBOLS</th><th>DESCRIPTION</th><th>WIRING</th><th>NOTE</th></tr></thead><tbody><tr><td></td><td>120 VAC POWER (IN JUNCTION BOX)</td><td>120 VAC POWER FOR FUTURE SECURITY PANELS</td><td>I</td></tr><tr><td></td><td>ALARM POINT</td><td>1 #18/2 PER CONTACT TO WIRELESS RECEIVERWHERE TWO CONTACTS ARE PRESENT WIRE THE CONTACTS IN SERIES</td><td>C</td></tr><tr><td></td><td>ARMING STATION</td><td>EXISTING WIRING AT THIS DEVICE TO BE MAINTAINED</td><td>--</td></tr><tr><td></td><td>CARD READER</td><td>1 #18/2 PLENUM FOR ALARM CONTACT 2 #18/2 PLENUM FOR REQUEST TO EXIT 1 #18/2 PLENUM FOR ELECTRIFIED HARDWARE 1 #18/8 SHIELDED FOR READER</td><td>A, B, C, J</td></tr><tr><td></td><td>SECURITY WIRELESS ACCESS POINT</td><td>EXISTING WIRING AT THIS DEVICE TO BE MAINTAINED</td><td>--</td></tr></tbody></table>				SYMBOLS	DESCRIPTION	WIRING	NOTE		120 VAC POWER (IN JUNCTION BOX)	120 VAC POWER FOR FUTURE SECURITY PANELS	I		ALARM POINT	1 #18/2 PER CONTACT TO WIRELESS RECEIVERWHERE TWO CONTACTS ARE PRESENT WIRE THE CONTACTS IN SERIES	C		ARMING STATION	EXISTING WIRING AT THIS DEVICE TO BE MAINTAINED	--		CARD READER	1 #18/2 PLENUM FOR ALARM CONTACT 2 #18/2 PLENUM FOR REQUEST TO EXIT 1 #18/2 PLENUM FOR ELECTRIFIED HARDWARE 1 #18/8 SHIELDED FOR READER	A, B, C, J		SECURITY WIRELESS ACCESS POINT	EXISTING WIRING AT THIS DEVICE TO BE MAINTAINED	--	<div>ABBREVIATIONS</div> <table><tbody><tr><td>A.F.F.</td><td>-</td><td>ABOVE FINISHED FLOOR</td><td>U.O.N.</td><td>-</td><td>UNLESS OTHERWISE NOTED</td></tr><tr><td>T.B.D.</td><td>-</td><td>TO BE DETERMINED</td><td>F.O.V.</td><td>-</td><td>FIELD OF VIEW</td></tr><tr><td>N/A</td><td>-</td><td>NOT APPLICABLE</td><td>A.C.P.</td><td>-</td><td>ACCESS CONTROL PANEL</td></tr><tr><td>SH</td><td>-</td><td>SHIELDED</td><td>I.A.P.</td><td>-</td><td>INTRUSION ALARM PANEL</td></tr><tr><td>TW</td><td>-</td><td>TWISTED</td><td>V.I.F.</td><td>-</td><td>VERIFY IN FIELD</td></tr><tr><td>WP</td><td>-</td><td>WEATHER PROOF</td><td>E</td><td>-</td><td>EXISTING</td></tr><tr><td>S.O.C.</td><td>-</td><td>SECURITY OPERATIONS CENTER</td><td>N</td><td>-</td><td>NEW</td></tr><tr><td>RECP</td><td>-</td><td>RECEPTION</td><td></td><td></td><td></td></tr></tbody></table>				A.F.F.	-	ABOVE FINISHED FLOOR	U.O.N.	-	UNLESS OTHERWISE NOTED	T.B.D.	-	TO BE DETERMINED	F.O.V.	-	FIELD OF VIEW	N/A	-	NOT APPLICABLE	A.C.P.	-	ACCESS CONTROL PANEL	SH	-	SHIELDED	I.A.P.	-	INTRUSION ALARM PANEL	TW	-	TWISTED	V.I.F.	-	VERIFY IN FIELD	WP	-	WEATHER PROOF	E	-	EXISTING	S.O.C.	-	SECURITY OPERATIONS CENTER	N	-	NEW	RECP	-	RECEPTION			
SYMBOLS	DESCRIPTION	WIRING	NOTE																																																																												
	120 VAC POWER (IN JUNCTION BOX)	120 VAC POWER FOR FUTURE SECURITY PANELS	I																																																																												
	ALARM POINT	1 #18/2 PER CONTACT TO WIRELESS RECEIVERWHERE TWO CONTACTS ARE PRESENT WIRE THE CONTACTS IN SERIES	C																																																																												
	ARMING STATION	EXISTING WIRING AT THIS DEVICE TO BE MAINTAINED	--																																																																												
	CARD READER	1 #18/2 PLENUM FOR ALARM CONTACT 2 #18/2 PLENUM FOR REQUEST TO EXIT 1 #18/2 PLENUM FOR ELECTRIFIED HARDWARE 1 #18/8 SHIELDED FOR READER	A, B, C, J																																																																												
	SECURITY WIRELESS ACCESS POINT	EXISTING WIRING AT THIS DEVICE TO BE MAINTAINED	--																																																																												
A.F.F.	-	ABOVE FINISHED FLOOR	U.O.N.	-	UNLESS OTHERWISE NOTED																																																																										
T.B.D.	-	TO BE DETERMINED	F.O.V.	-	FIELD OF VIEW																																																																										
N/A	-	NOT APPLICABLE	A.C.P.	-	ACCESS CONTROL PANEL																																																																										
SH	-	SHIELDED	I.A.P.	-	INTRUSION ALARM PANEL																																																																										
TW	-	TWISTED	V.I.F.	-	VERIFY IN FIELD																																																																										
WP	-	WEATHER PROOF	E	-	EXISTING																																																																										
S.O.C.	-	SECURITY OPERATIONS CENTER	N	-	NEW																																																																										
RECP	-	RECEPTION																																																																													
<div>SECURITY CONTRACTOR</div> <div><div>1. SECURITY CONTRACTOR SHALL PROVIDE, INSTALL AND PROGRAM A COMPLETELY FUNCTIONAL AND OPERATIONAL SYSTEM AS SHOWN ON DRAWINGS AND SPECIFICATIONS.</div><div>2. THE SECURITY CONTRACTOR SHALL PROVIDE A PHASED INSTALLATION OF THE ELECTRONIC SECURITY BASED ON THE GOVERNMENT AND GENERAL CONTRACTOR'S SCHEDULE.</div><div>3. SECURITY CONTRACTOR SHALL PROVIDE AND INSTALL ALL CONDUIT, WIRING, DEVICES, CONNECTIONS, PROGRAMMING, AND COORDINATION REQUIRED FOR A COMPLETELY FUNCTIONAL AND OPERATIONAL SYSTEM. SECURITY CONTRACTOR SHALL PROVIDE ANY CUSTOM BACKBOXES REQUIRED.</div><div>4. INCLUDE FINAL CONNECTION, PROGRAMMING, TRAINING, AND TESTING OF THE WORK TO THE HEAD-END EQUIPMENT.</div><div>5. ATTENDANCE AT CONSTRUCTION COORDINATION MEETINGS.</div><div>6. COORDINATION OF WORK WITH OTHER DESIGN AND INSTALLATION TRADES.</div></div>				<div>ELECTRICAL CONTRACTOR</div> <div><div>1. PROVIDE AND INSTALL ALL CONDUIT, BACK BOXES, PULL BOXES AS SHOWN ON DRAWINGS.</div><div>2. PROVIDE AND INSTALL FIRE ALARM SYSTEM INTERFACES WHERE REQUIRED.</div><div>3. DOTTED LINES AND BACK BOXES ON T4-01 ARE TO BE PROVIDED AND INSTALLED BY THE ELECTRICAL CONTRACTOR.</div><div>4. INSTALL J-BOXES FOR CARD READER ON SECURE SIDE OF DOOR.</div></div>																																																																											
<div>DETAIL BUBBLE REFERENCE</div> <div><div>X</div><div>TYXX</div><div>DETAIL LETTER</div><div>DETAIL SHEET</div></div>				<div>BID SUBMISSION NOVEMBER 04, 2013</div> <div>Office of Construction and Facilities Management</div> <div>Department of Veterans Affairs</div>																																																																											

CONSULTANTS:		ARCHITECT		Drawing Title		Project Title		Project Number	
<div><div>GUIDEPOST SOLUTIONS TECHNOLOGY DESIGN CONSULTING</div></div> <div>550 South Hope, Suite 850 Los Angeles, CA 90071 Office: (213) 624-9000 Website: www.guidepostsolutions.com</div>		<div><div>POLYTECH ASSOCIATES INC.</div></div> <div>235 Pine Street, 17th Floor San Francisco, CA 94104 TEL (415) 397-3117 FAX (415) 397-1517</div>		SECURITY LEGEND AND NOTES		MPD - EXPAND HOMELESS DOMICILIARY OUTPATIENT AND THERAPY PROGRAMS		640-382	
Revisions:				Approved: Project Director		Location: 795 WILLOW ROAD, MENLO PARK, CA		Building Number 349	
Date						Date NOVEMBER 04, 2013		Drawing Number TY001	
						Checked ES		Drawn SO	
								Dwg. of	

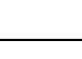VA FORM 28-6231

SHEET NOTES

- ① EXISTING WIRELESS ALARM POINT TO BE MAINTAINED DURING CONSTRUCTION. WHERE DEVICES NEED TO BE REMOVED RETURN THEM TO THE GOVERNMENT UNTIL THE CONSTRUCTION IN THAT AREA IS COMPLETED AND THE DEVICES CAN BE REINSTALLED. WHERE DEMO REMOVES A DEVICE ENSURE IT IS FITTED IN THE NEW DOOR OR FRAME WHEN INSTALLED.
- ② EXISTING WIRELESS ACCESS POINT FOR WIRELESS DOOR CONTACTS. DISCONNECT THE EQUIPMENT AFTER POWERING DOWN THE DEVICE AND RETURN IT TO THE GOVERNMENT UNTIL THE DEMO AND CONSTRUCTION IS COMPLETE IN THAT AREA. ENSURE NO DAMAGE IS DONE TO THE CABLE. REINSTALL THE DEVICE IN THE SAME LOCATION AFTER THE CEILING WORK IS COMPLETE. ENSURE THE DEVICE RECEIVES SIGNALS FROM ALL OF THE FIELD DEVICE TO WHICH IS WAS CONNECTED TO AT THE ONSET OF THE DEMO WORK.

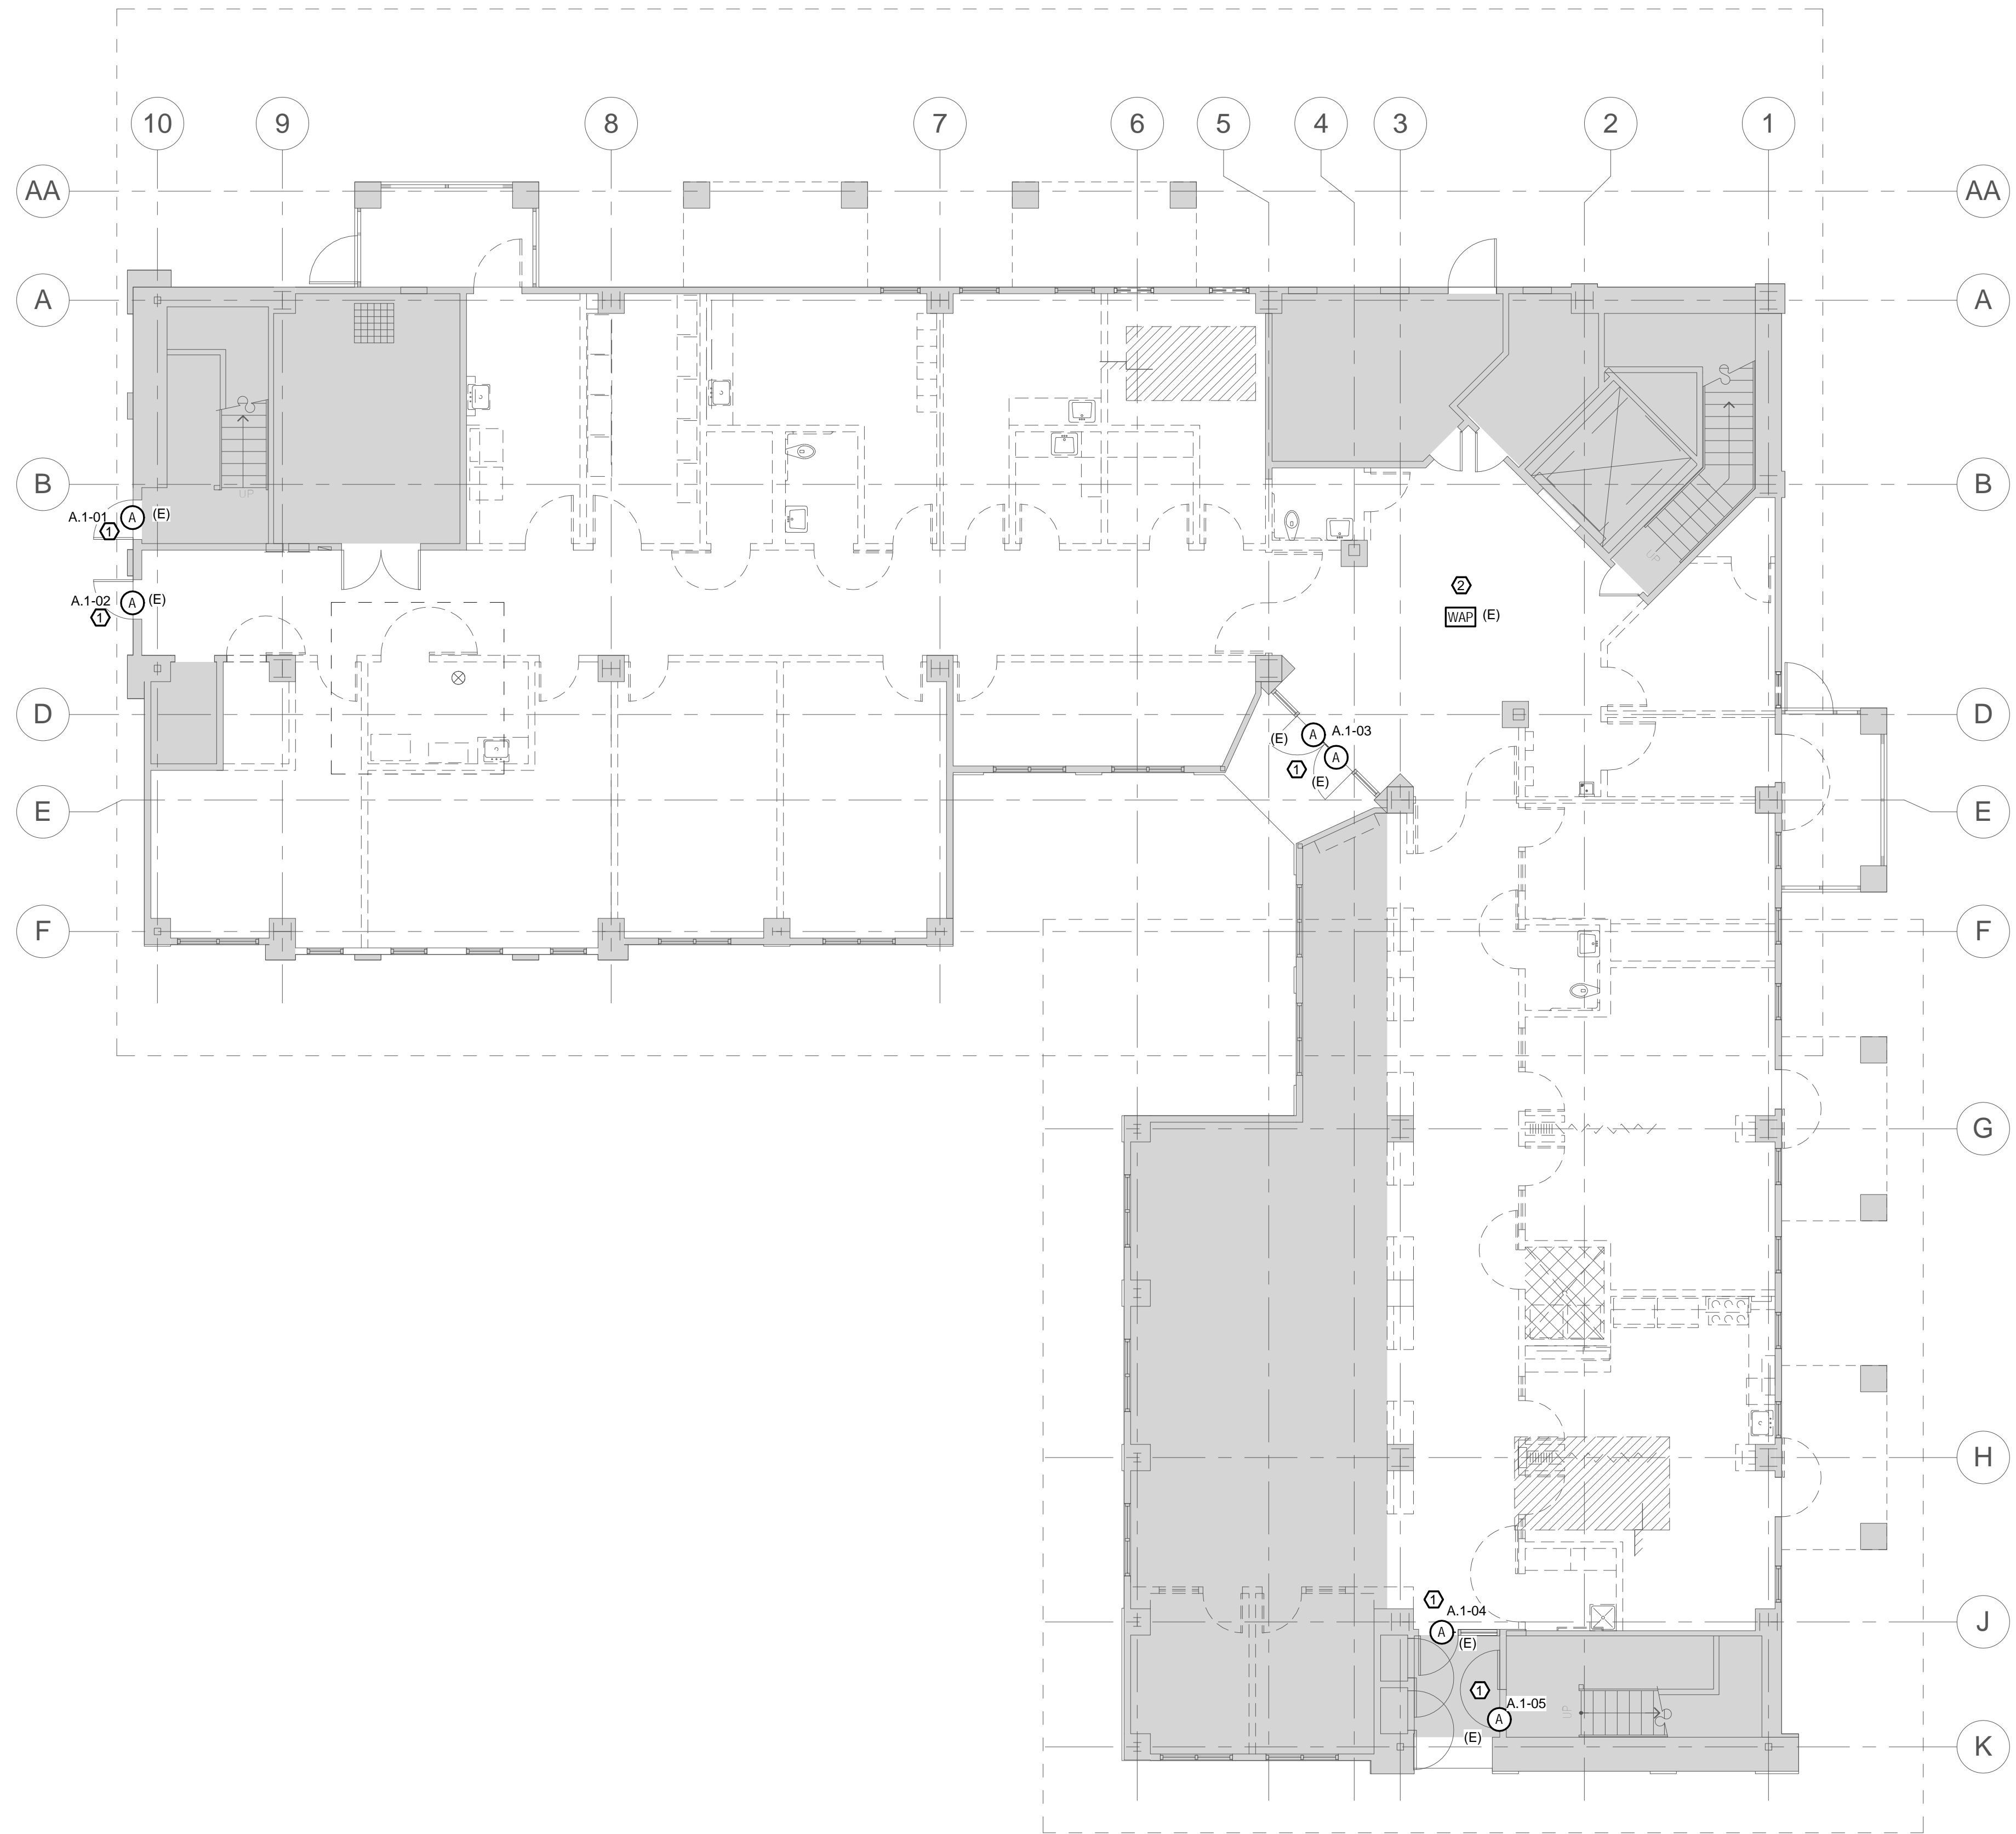

SECURITY GROUND FLOOR DEMOLITION PLAN

1/8" = 1'-0"

CONSULTANTS:



550 South Hope, Suite 850  
Los Angeles, CA 90071  
Office: (213) 624-9000  
Website: [www.guidepostsolutions.com](http://www.guidepostsolutions.com)

ARCHITECT



POLYTECH ASSOCIATES INC.  
235 Pine Street, 17th Floor  
San Francisco, CA 94104  
TEL (415) 397-3117  
FAX (415) 397-1517

Drawing Title  
SECURITY GROUND FLOOR DEMOLITION PLAN

Approved: Project Director

Project Title  
MPD - EXPAND HOMELESS DOMICILIARY  
OUTPATIENT AND THERAPY PROGRAMS

Location  
795 WILLOW ROAD, MENLO PARK, CA

Date  
NOVEMBER 04, 2013

Checked  
ES

Drawn  
SO

Project Number  
640-382

Building Number  
349

Drawing Number

TY201D

Dwg. of

BID SUBMISSION  
NOVEMBER 04, 2013

Office of  
Construction  
and Facilities  
Management





BID SUBMISSION  
NOVEMBER 04, 2013

VA FORM 08-6231


$$1/8'' = 1'-0''$$


Revisions:

Date \_\_\_\_\_

550 South Hope, Suite 850  
Los Angeles, CA 90071  
Office: (213) 624-9000  
Website: [www.guidepostsolutions.com](http://www.guidepostsolutions.com)



**POLYTECH**  
ASSOCIATES  
INC.



Department of  
Veterans Affairs




$$1/8^{\circ} = 1'-0"$$
[illegible]

GUIDEPOST SOLUTIONS  
TECHNOLOGY DESIGN CONSULTING

550 South Hope, Suite 850  
Los Angeles, CA 90071  
Office: (213) 624-9000  
Website: [www.guidepostsolutions.com](http://www.guidepostsolutions.com)



**POLYTECH  
ASSOCIATES  
INC.**

POLYTECH ASSOCIATES INC.  
235 Pine Street, 17th Floor  
San Francisco, CA 94104  
TEL (415) 397-3117  
FAX (415) 397-1517

Drawing Title	SECURITY SECOND FLOOR PLAN
---------------	----------------------------

Approved: Project Director

Project Title	MPD - EXPAND HOMELESS DOMICILIARY OUTPATIENT AND THERAPY PROGRAMS
---------------	--

Location	795 WILLOW ROAD, MENLO PARK, CA
----------	---------------------------------

Checked ES	Draw SO
---------------	------------

Project Number  
640-382Building Number  
349


Drawing Number  
**TV2**

Dwg.	c
------	---

BID SUBMISSION  
NOVEMBER 04, 2013

Office of  
Construction  
and Facilities  
Management



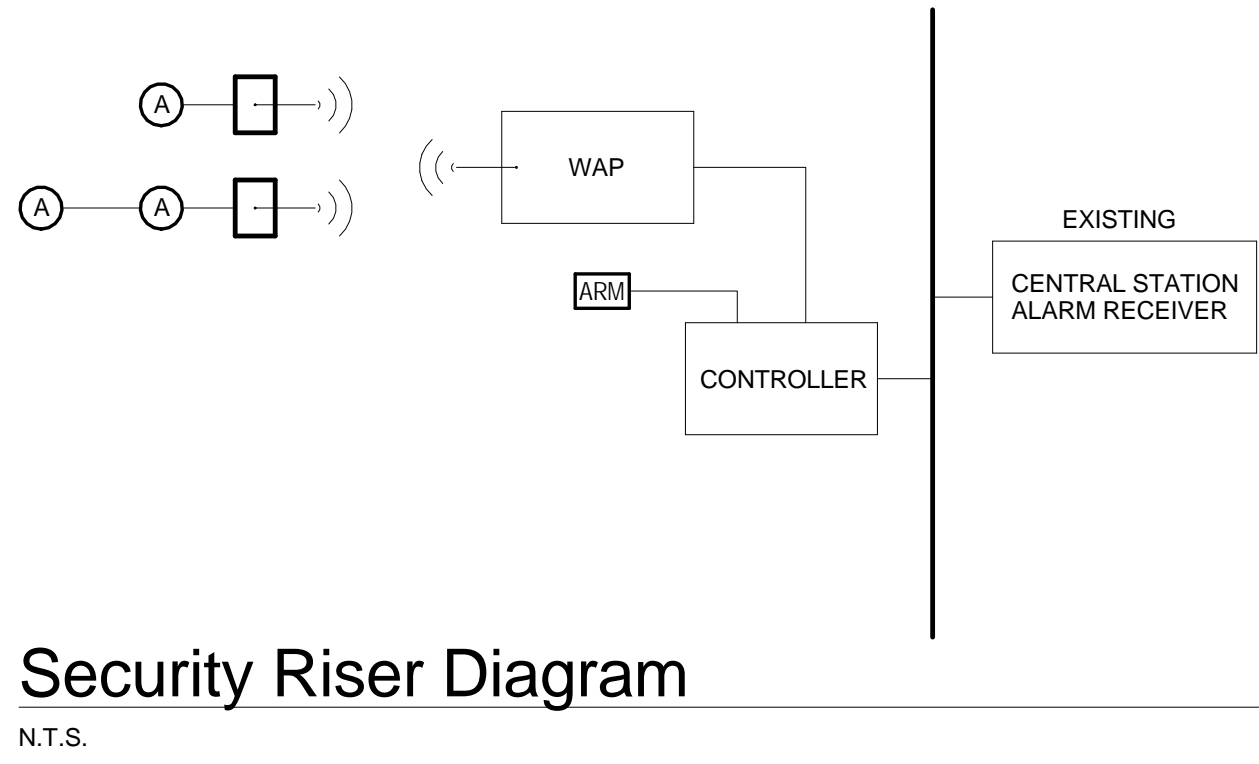

<div>Revisions:</div> <table><tr><td> </td><td> </td></tr><tr><td> </td><td> </td></tr><tr><td> </td><td> </td></tr><tr><td> </td><td> </td></tr></table>									<div>CONSULTANTS:</div> <div> <b>GUIDEPOST SOLUTIONS</b> TECHNOLOGY DESIGN CONSULTING</div> <div>550 South Hope, Suite 850 Los Angeles, CA 90071 Office: (213) 624-9000 Website: <a href="http://www.guidepostsolutions.com">www.guidepostsolutions.com</a></div>	<div></div>	<div>ARCHITECT</div> <div> <b>POLYTECH ASSOCIATES INC.</b></div> <div>235 Pine Street, 17th Floor San Francisco, CA 94104 TEL (415) 397-3117 FAX (415) 397-1517</div>	<div>Drawing Title</div> <div>SECURITY RISER DIAGRAM</div> <div>Approved: Project Director</div>	<div>Project Title</div> <div>MPD - EXPAND HOMELESS DOMICILIARY OUTPATIENT AND THERAPY PROGRAMS</div> <div>Location</div> <div>795 WILLOW ROAD, MENLO PARK, CA</div> <div>Date</div> <div>NOVEMBER 04, 2013</div> <div>Checked</div> <div>ES</div> <div>Drawn</div> <div>SO</div>	<div>Project Number</div> <div>640-382</div> <div>Building Number</div> <div>349</div> <div>Drawing Number</div> <div>TY301</div> <div>Dwg. of</div>	<div>BID SUBMISSION NOVEMBER 04, 2013</div> <div> <b>Office of Construction and Facilities Management</b></div> <div> <b>Department of Veterans Affairs</b></div>



BID SUBMISSION  
NOVEMBER 04, 2013

Office of  
Construction  
and Facilities  
Management



Department of  
Veterans Affairs

Project Number  
640,382Building Number  
349

Drawing Number

1 Y 40

Dwa. c

Project Title	MPD - EXPAND HOMELESS DOMICILIARY OUTPATIENT AND THERAPY PROGRAMS
---------------	--

Location
795 WILLOW ROAD, MENLO PARK, CA

Date  
NOVEMBER 01 2004

Checked  
50

Draw

Drawing Title  
SECURITY DETAILS

Approved: Project Director

ARCHITECT

POLYTECH ASSOCIATES INC.

235 Pine Street, 17th Floor  
San Francisco, CA 94104  
TEL (415) 397-3117  
FAX (415) 397-1517



CONSULTANTS:



GUIDEPOST SOLUTIONS  
TECHNOLOGY DESIGN CONSULTING

550 South Hope, Suite 850  
Los Angeles, CA 90071  
Office: (213) 624-9000  
Website: [www.guidepostsolutions.com](http://www.guidepostsolutions.com)