


# Renovate Research Building 19

## Project # 603-12-601 - T661

8/17/2012

ROBLEY REX VA MEDICAL CENTER,  
LOUISVILLE, KENTUCKY 40206

Revision 1 - October 31, 2014

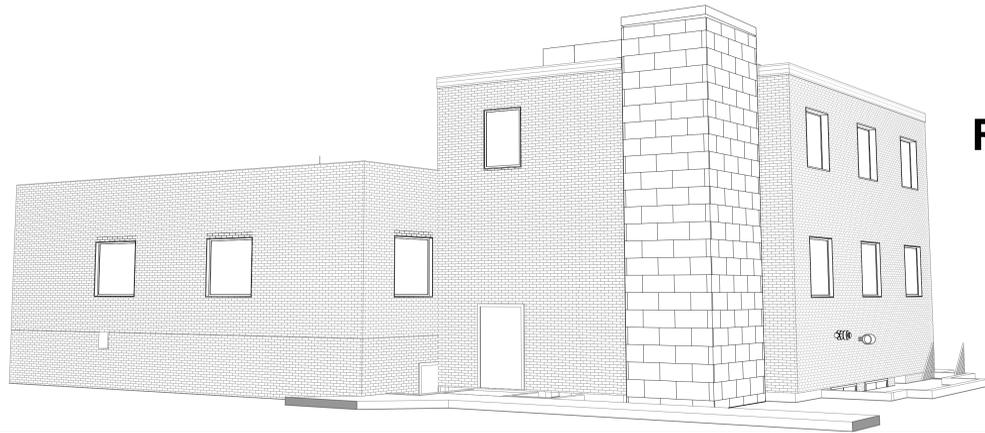

### PROJECT CONTACTS

**ARCHITECT/ENGINEER**  
Guidon Design Inc.  
2543 N. Delaware St.  
Indianapolis, IN. 46205  
317.800.6388

Stewart Whitcomb LEED AP  
swhitcomb@guidondesign.com


**MEP ENGINEER**  
Biagi, Chance, Cummins, London, Titzer, Inc.  
Consulting Engineers  
9100 Marksfield Rd. Suite 200  
Louisville, KY. 40222  
502.708.1860

James B. Brooks  
Brooks@bcclt.com

**RESIDENT ENGINEER**  
Robley Rex VA Medical Center  
800 Zorn Ave.  
Louisville KY 40206  
502-287-4222


Anthony C. Costanzo  
anthony.costanzo@va.gov

### LOCATION MAP

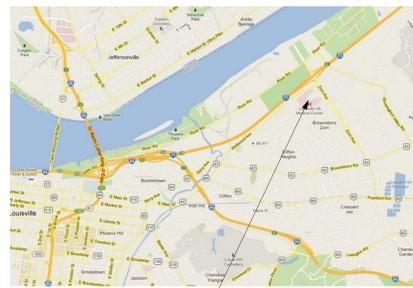


Robley Rex Campus

### ORIENTATION MAP

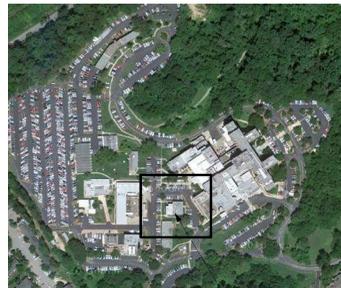

Building 19

### KEY MAP

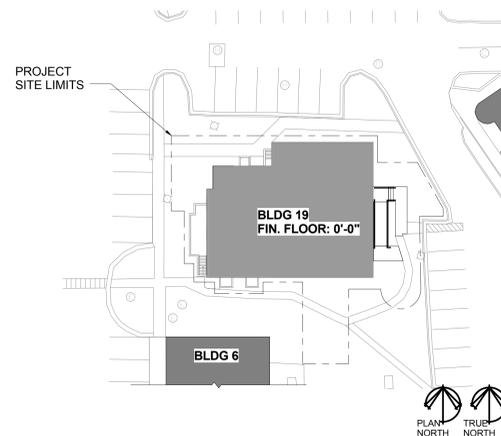

### DRAWING INDEX

Sheet Number	Sheet Name
GI001	TITLE SHEET
GI100	GENERAL INFORMATION
CS101	SITE PLAN
HA100	ABATEMENT PLANS
AD010	DEMOLITION PLANS
AS100	LIFE SAFETY PLANS
AS101	FLOOR PLANS
AS200	REFLECTED CEILING PLANS
AS300	ROOF PLAN
AS400	EXTERIOR ELEVATIONS
AS501	BUILDING SECTION AND DETAILS
AS502	WALL SECTIONS AND DETAILS
AS800	DOOR AND WINDOW DETAILS
AS900	FINISH PLANS
AS901	CASEWORK ELEVATIONS
MD101	HVAC DEMOLITION PLANS
MH001	HVAC LEGENDS, ABBREVIATIONS, AND NOTES
MH200	BASEMENT HVAC DUCTWORK PLANS
MH201	1ST FLOOR HVAC DUCTWORK PLAN
MH202	2ND FLOOR HVAC DUCTWORK PLAN
MH203	ROOF HVAC DUCTWORK PLAN
MH204	HVAC PIPING PLANS
MH205	HVAC SECTIONS
MH301	HVAC DETAILS
MH302	HVAC DETAILS
MH303	HVAC DETAILS
MH401	HVAC SCHEDULES
MH501	HVAC FLOW DIAGRAMS
MH601	HVAC TEMPERATURE CONTROLS
ED101	ELECTRICAL - DEMOLITION LIGHTING PLANS
ED102	ELECTRICAL - DEMOLITION POWER PLANS
ED103	ELECTRICAL - DEMOLITION SYSTEMS PLANS
ED104	EXISTING ONE-LINE DIAGRAM
EL201	BASEMENT LIGHTING PLAN AND SCHEDULE
EL202	1ST AND 2ND FLOOR LIGHTING PLANS
EP203	BASEMENT AND ROOF POWER PLANS
EP204	1ST AND 2ND FLOOR POWER PLANS
ES206	LIGHTNING PROTECTION PLAN
ES207	ELECTRICAL DETAILS
ET205	BASEMENT, 1ST AND 2ND FLOOR SYSTEMS PLANS
PL001	PLUMBING LEGEND AND SCHEDULES
PL101	PLUMBING REMOVAL PLAN
PL201	PLUMBING PLANS
PL300	PLUMBING WASTE AND VENT DIAGRAM
PL400	PLUMBING DETAILS
FD101	EXISTING FIRE PROTECTION DEMO PLANS
FA201	FIRE DETECTION AND ALARM PLANS
FX202	FIRE SUPPRESSION PLANS

FULLY SPRINKLERED

### FOR BID

Drawing Title <b>TITLE SHEET</b>	Project Title <b>RENOVATE RESEARCH BUILDING 19 - T661</b>	Project Number 12.1004	OFFICE OF FACILITIES MANAGEMENT
Approved: Project Director <b>Anthony C. Costanzo</b> anthony.costanzo@va.gov 502-287-4222	Location <b>ROBLEY REX VAMC</b>	Building Number <b>Bldg-19</b>	VA Project Number <b>603-12-601 - T661</b>
Date 8/17/2012	Checked By: LJL	Drawn By: STW	<b>GI001</b>

**ROBLEY REX VAMC System**  
800 Zorn Ave.  
Louisville, KY 40206



MEP / HVAC DESIGN  
**BCCLT, Inc.**  
www.BCCLT.com

Site Civil, MEP Engineers  
9100 Marksfield Road  
Suite 200  
Louisville, KY 40222  
T: 502-708-1860



INTERIOR DESIGN ARCHITECT  
**JRA Architects**  
www.jraarchitects.com

Louisville Office:  
3225 Summit Square Place,  
Suite 200  
Louisville, KY 40206  
T: 502-583-4697



PROJECT LEADER/ARCHITECT:






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317.800.6388 WWW.GUIDONDESIGN.COM  
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Revisions: \_\_\_\_\_ Date \_\_\_\_\_



SITE PLAN NOTES	
S.1	GRADE SITE TO 2% MIN. AND 5% MAX POSITIVE SLOPE DRAINAGE AWAY FROM NEW CONSTRUCTION
S.2	CONCRETE RAMP WITH STEEL TUBE HANDRAILS AND GUARD RAILS TO MEET ADA REQUIREMENTS.
S.3	NEW TO EXISTING
S.4	INSTALL FOUNDATION DRAIN AT FOOTER. TIE INTO EXISTING DRAIN AND MAINTAIN SLOPE AND POSITIVE DRAINAGE.

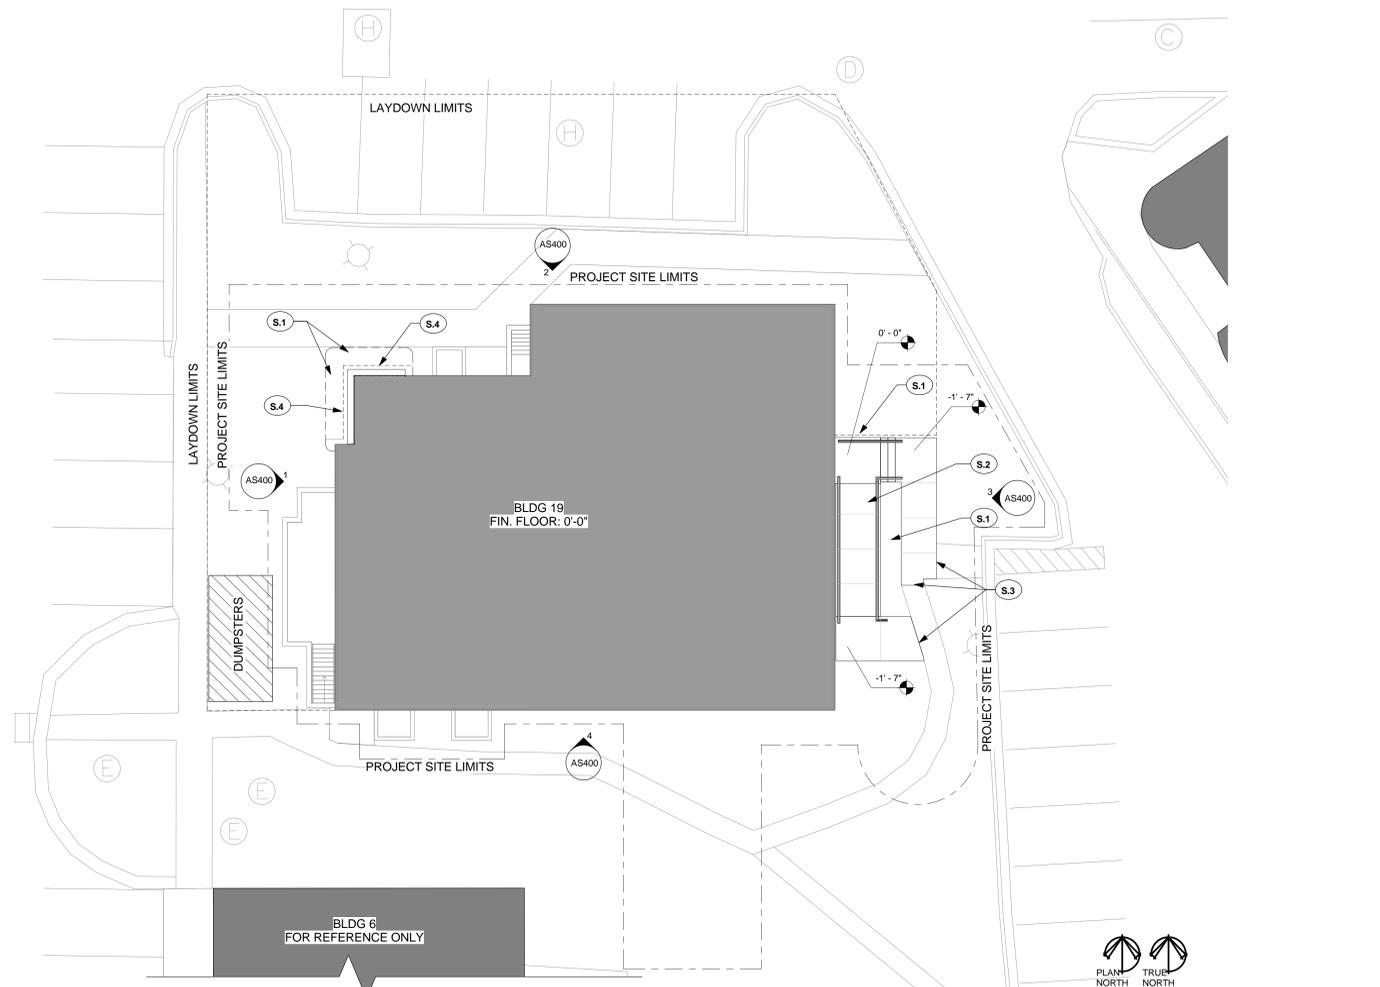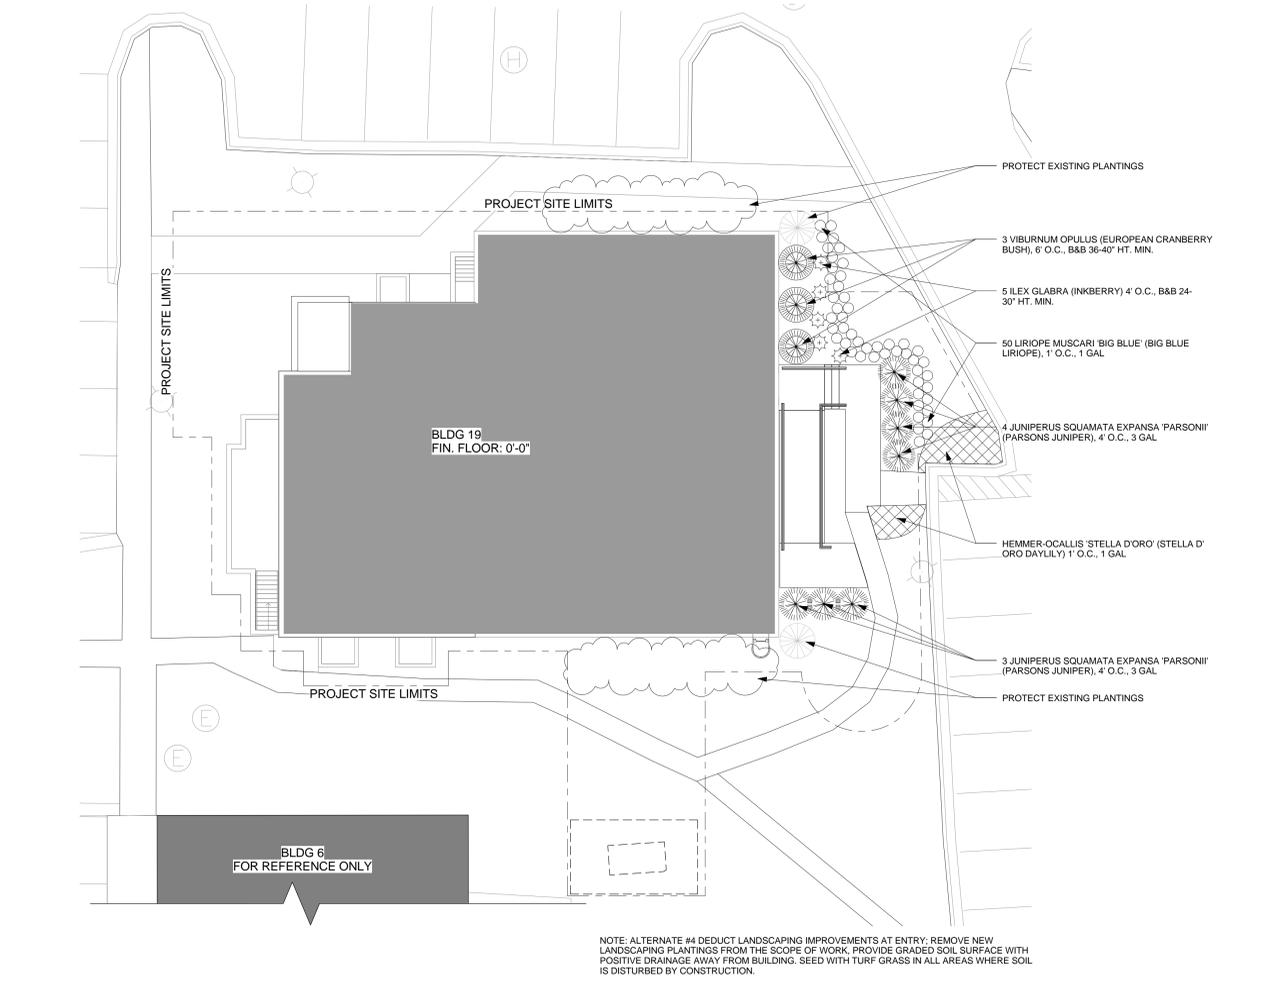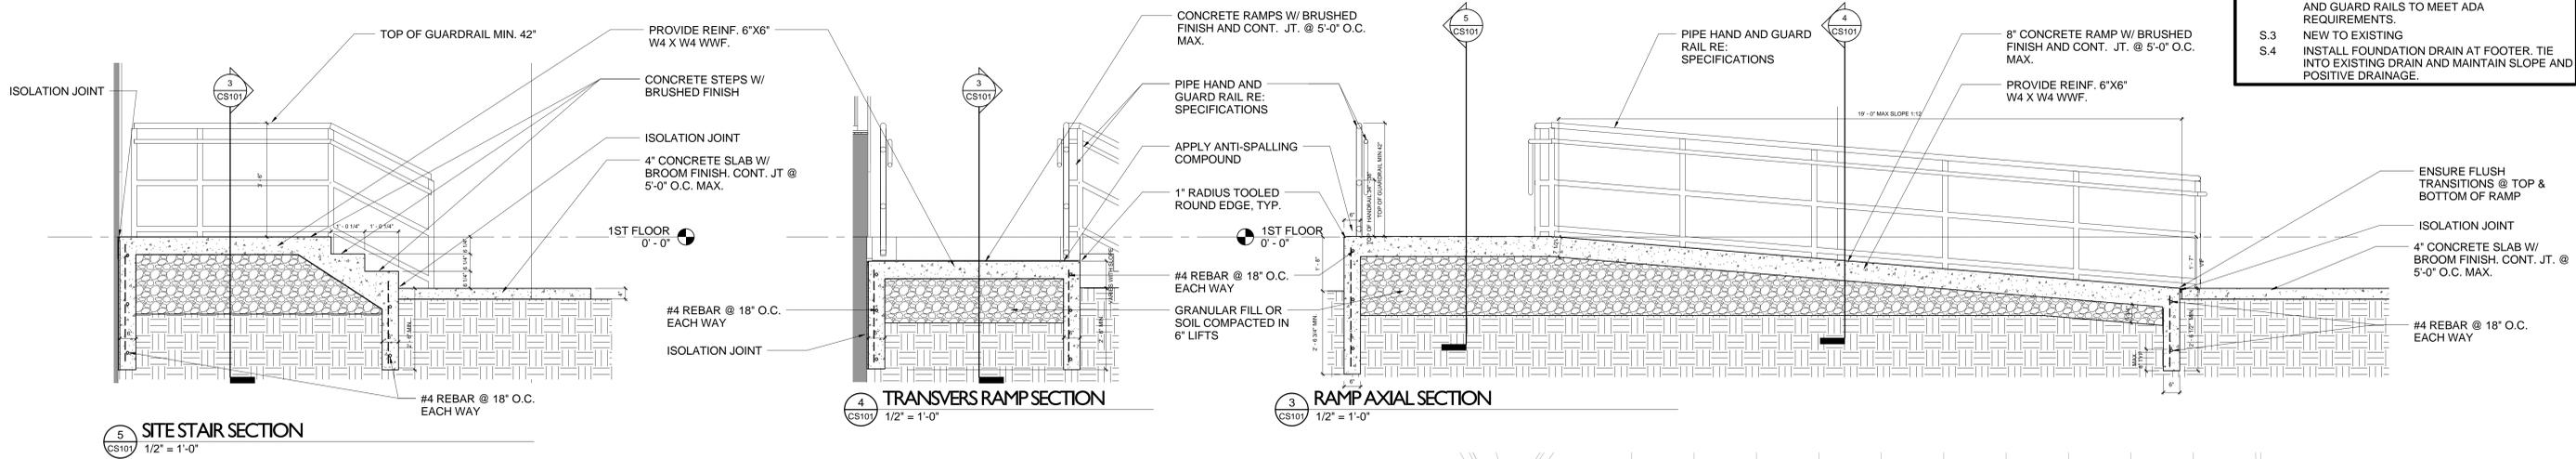

5 SITE STAIR SECTION  
1/2" = 1'-0"

4 TRANSVERSERS RAMP SECTION  
1/2" = 1'-0"

3 RAMP AXIAL SECTION  
1/2" = 1'-0"

2 LANDSCAPE PLAN  
1" = 10'-0"


1 SITE PLAN  
1" = 10'-0"

one eighth inch = one foot  
 one quarter inch = one foot  
 three eighths inch = one foot  
 one half inch = one foot  
 three quarters inch = one foot  
 one inch = one foot  
 one and one half inches = one foot  
 three inches = one foot


<b>ROBLEY REX VAMC System</b> 800 Zorn Ave. Louisville, KY 40206				<b>MEP/HVAC DESIGN</b> <b>BCCLT, Inc.</b> www.bcclt.com Site Civil, MEP Engineers 9100 Markfield Road Suite 200 Louisville, KY 40222 T: 502-708-1860		<b>PROJECT LEADER/ARCHITECT:</b> <b>GUIDON DESIGN</b> 2453 N. DELAWARE ST. INDIANAPOLIS, IN. 46205 317.800.6388 WWW.GUIDONDESIGN.COM SUSTAINABLE ARCHITECTURE + ENGINEERING		<b>FOR BID</b> Drawing Title: <b>SITE PLAN</b> Project Title: <b>RENOVATE RESEARCH BUILDING 19 - T661</b> Approved: Project Director <b>Anthony C. Costanzo</b> anthony.costanzo@va.gov 502-287-4222		Project Number: <b>12.1004</b> Building Number: <b>Bldg-19</b> Drawing Number: <b>CS101</b> Date: <b>8/17/2012</b> Checked By: <b>LJL</b> Drawn By: <b>STW</b>		<b>OFFICE OF FACILITIES MANAGEMENT</b> VA Project Number: <b>603-12-601 - T661</b> 	
1 Revision 1 Revisions:		Date 1 Date		<b>JRA Architects</b> Louisville Office: 3225 Summit Square Place, Suite 200 Louisville, KY 40206 T: 502-583-4697 www.jraarchitects.com		<b>BCCLT</b> Biagi, Chance, Cummins, London, Titzer CONSULTING ENGINEERS		<b>ANTHONY C. COSTANZO</b> ARCHITECT		<b>VA</b> Department of Veterans Affairs			

HAZMAT REMOVAL NOTES	
SCOPE OF ASBESTOS & HAZMAT REMOVAL:	
NOTE	
H.1	PIPE FITTING INSULATION
H.2	ACM FLOOR TILE AND RELATED MASTIC
H.3	BLACK MASTIC ASSOCIATED WITH FLOOR TILE
H.4	TRANSITE FUME HOODS AND COUNTERTOPS
H.5	ACM SINK MASTIC
H.6	ACM FLUE PIPE
H.7	FLUORESCENT LIGHT TUBES
H.8	LIGHT FIXTURE BALLASTS
H.9	CHEMICALS AND CLEANING PRODUCTS
H.10	NOT USED
H.11	MOLD IMPACTED PIPE INSULATION


NOTE: HAZMAT REMOVAL NOTES APPLY TO ENTIRE ROOMS. CONTRACTOR SHALL IDENTIFY ALL MATERIALS DESCRIBED BY NOTE IN EACH ROOM AND REMOVE ACCORDING TO SAFETY STANDARDS.

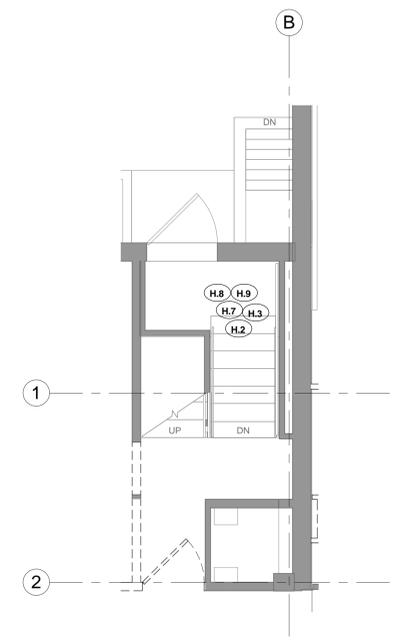


4 EGRESS LEVEL HAZMAT ABATEMENT PLAN  
1/4" = 1'-0"

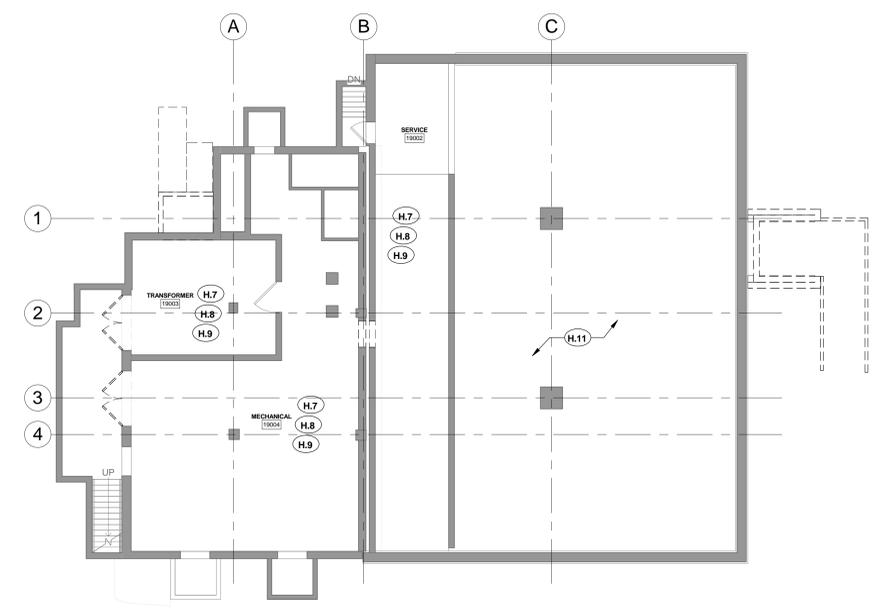

3 LOWER LEVEL HAZMAT ABATEMENT PLAN  
1/8" = 1'-0"

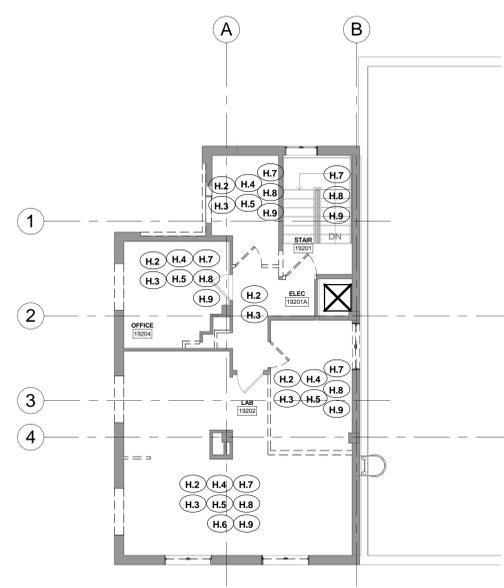

2 SECOND LEVEL HAZMAT ABATEMENT PLAN  
1/8" = 1'-0"

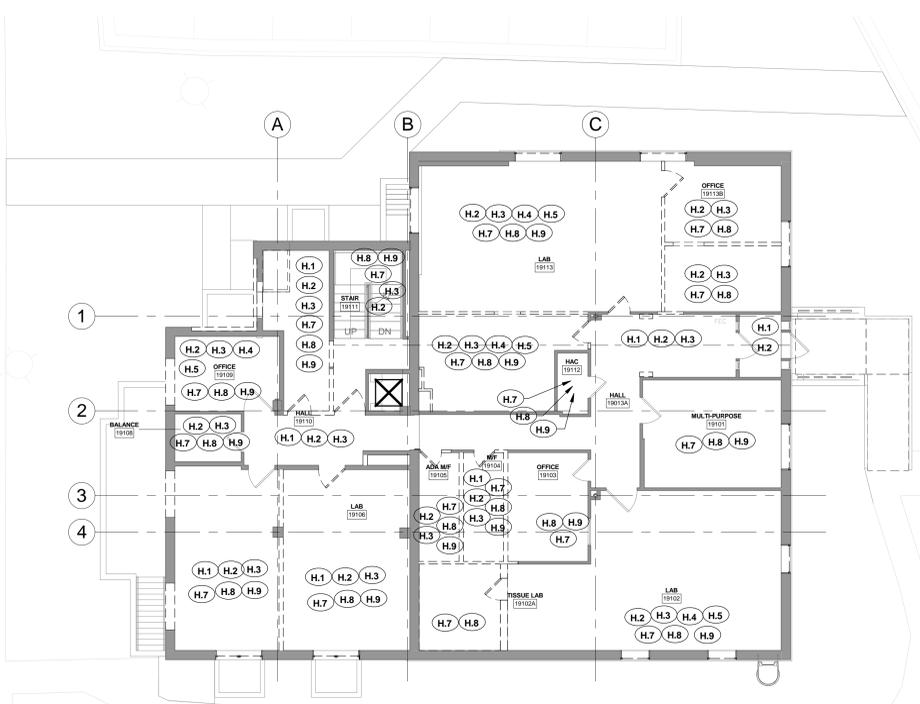

1 FIRST LEVEL HAZMAT ABATEMENT PLAN  
1/8" = 1'-0"

Scale bar on the left side of the drawing with increments from 0 to 10 feet. Text labels: three inches = one foot, one and one half inches = one foot, one inch = one foot, three quarters inch = one foot, one half inch = one foot, three eighths inch = one foot, one quarter inch = one foot, one eighth inch = one foot.

**USFin**  
BRETT L. BRUMBAUGH  
KENTUCKY ASBESTOS PROJECT DESIGNER  
LICENSE D12-06-1371  
USFIN DEVELOPMENT, LLC  
7920 N. WOODBRIDGE RD.  
MONCLOVA, OH 43542  
419-382-9574

MEP / HVAC DESIGN  
**BCCLT, Inc.**  
www.bcclt.com  
Site Civil, MEP Engineers  
9100 Markfield Road  
Suite 200  
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**JRA Architects**  
www.jraarchitects.com  
Louisville Office:  
3225 Summit Square Place,  
Suite 200  
Louisville, KY 40206  
T: 502-583-4697

**BCCLT**  
Blugi, Chance, Cummins, London, Tipton  
CREATING PROGRESS

**JRA**  
architects

PROJECT LEADER/ARCHITECT:  
**GUIDON DESIGN**  
2453 N. DELAWARE ST. INDIANAPOLIS, IN. 46205  
317.800.6388 WWW.GUIDONDESIGN.COM  
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Drawing Title		Project Title		Project Number		Office of Facilities Management	
ABATEMENT PLANS		RENOVATE RESEARCH BUILDING 19 - T661		12.1004		OFFICE OF FACILITIES MANAGEMENT	
Approved: Project Director		Location		Drawing Number		VA Project Number	
Anthony C. Costanzo anthony.costanzo@va.gov 502-287-4222		ROBLEY REX VAMC		HA100		603-12-601 - T661	
Date		Checked By:		Drawn By:		Department of Veterans Affairs	
8/17/2012		BLB		STW		Department of Veterans Affairs	

**ROBLEY REX VAMC System**  
800 Zorn Ave.  
Louisville, KY 40206


Revisions:	Date

**DEMOLITION GENERAL NOTES**


- A DO NOT SCALE FROM DRAWINGS. REFER ANY DISCREPANCIES TO THE ARCHITECT FOR FINAL DECISIONS.
- B VISIT THE SITE TO BECOME FAMILIAR WITH EXISTING CONDITIONS. DEMOLITION DRAWINGS ARE FOR REFERENCE TO AID CONTRACTOR IN EVALUATION OF THE EXTENT OF THE DEMOLITION, BUT SHALL NOT BE CONSIDERED ALL-INCLUSIVE.
- C CONTRACTOR TO FIELD VERIFY ALL EXISTING CONDITIONS, DIMENSIONS, ETC.
- D THE CONTRACTOR IS RESPONSIBLE FOR THE PROTECTION OF ALL EXISTING SURFACES, MATERIALS, COMPONENTS, ETC. TO REMAIN OR BE RELOCATED. ANY DAMAGE TO THESE RESULTING FROM PERFORMANCE OF WORK SHALL BE REPAIRED BY THE CONTRACTOR TO THE SATISFACTION OF THE OWNER AND ARCHITECT AT NO ADDITIONAL EXPENSE TO THE OWNER. CONTRACTOR TO MAINTAIN REQUIRED FLOOR RATING IN ALL HORIZONTAL AND VERTICAL SURFACES DAMAGED DURING OR AS A RESULT OF DEMOLITION.
- E ALL EXISTING SURFACES LOCATED ADJACENT TO, OR EXPOSED BY DEMOLITION WORK AND SCHEDULED TO RECEIVE NEW CONSTRUCTION SHALL BE PATCHED AND REPAIRED AS REQUIRED.
- F OWNER WILL BE RESPONSIBLE FOR REMOVAL/REARRANGEMENT OF ALL EXISTING LOOSE FURNISHINGS AND EQUIPMENT DURING CONSTRUCTION UNLESS NOTED OTHERWISE.
- G EACH TRADE CONTRACTOR IS RESPONSIBLE FOR ALL DEMOLITION WORK REQUIRED OR NOTED FOR THE INSTALLATION OF NEW WORK. DEMOLITION MAY INCLUDE ASSOCIATED DISTRIBUTION SYSTEMS, APPURTENANCES, AND EQUIPMENT SUPPORTING CONTROLS, AND MISCELLANEOUS SUPPORTS UNLESS NOTED OTHERWISE.
- H CONTRACTOR SHALL COORDINATE CONSTRUCTION SEQUENCING WITH OWNER AT ALL TIMES.
- I HAZARDOUS MATERIALS SURVEY HAS BEEN PROVIDED FOR DEMOLITION AND CONSTRUCTION. ALL HAZARDOUS MATERIALS WILL BE REMOVED IN COMPLIANCE WITH APPLICABLE CODES AND LAWS. RE: SHEET HA 100
- J REMOVE AND/OR DEMOLISH ITEMS INDICATED. DEMOLISHED MATERIALS SHALL BE REMOVED FROM SITE IMMEDIATELY BY CONTRACTOR UNLESS NOTED OTHERWISE.
- K REMOVE DUST AND DEBRIS FROM NEW EXPOSED SURFACES.
- L WHEN CEILING SYSTEMS ARE REMOVED, M.E.P. TRADES SHALL COORDINATE REMOVAL OF ENGINEERING SYSTEMS WITH INSTALLATION OF NEW.
- M COMPLY WITH ALL APPLICABLE LOCAL, STATE AND FEDERAL CODES AND REGULATIONS. ALWAYS ABIDE BY THE MOST RESTRICTIVE CODE.
- N SOLID LINE INDICATES STRUCTURE AND/OR EQUIPMENT TO REMAIN. DASHED LINES INDICATE STRUCTURE AND/OR EQUIPMENT TO BE REMOVED.
- O DO NOT INTERRUPT SERVICE WITHOUT PRIOR OWNER APPROVAL AND COORDINATION.
- P COORDINATE CONSTRUCTION COMMUNICATION AND POWER REQUIREMENTS WITH OWNER PRIOR TO CONSTRUCTION.
- Q COORDINATE DEMOLITION AND/OR RELOCATION OF FIRE PROTECTION AND LIFE SAFETY DEVICES WITH OWNER AND M.E.P. ENGINEERS.
- R COORDINATE PATH OF DEBRIS REMOVAL WITH OWNER.
- S REMOVE ALL ITEMS ASSOCIATED WITH DEMOLISHED WALL IF NOT NOTED OR SHOWN OTHERWISE.



SITE OF NEW ELEVATOR REF.: DEMOLITION NOTES D.11 THROUGH D.14 AND 1/D010, 2/D010, AND 3/D010

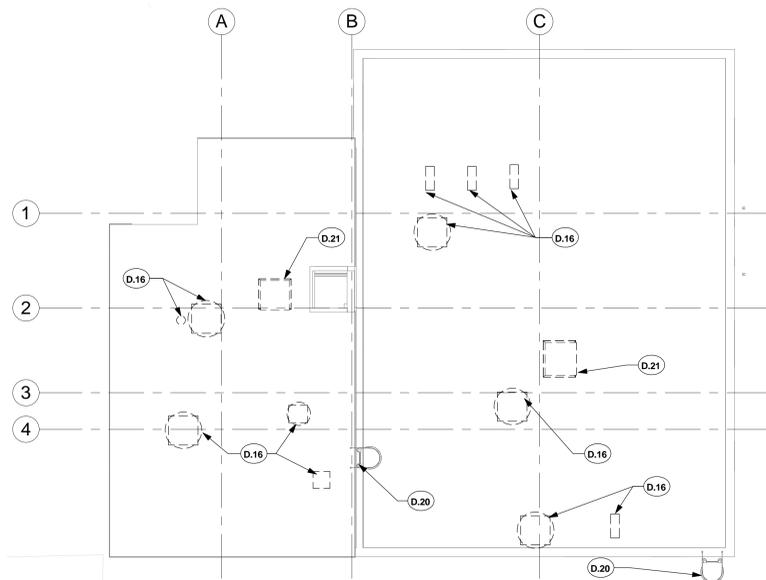


4 DEMOLITION ROOF PLAN  
1/8" = 1'-0"

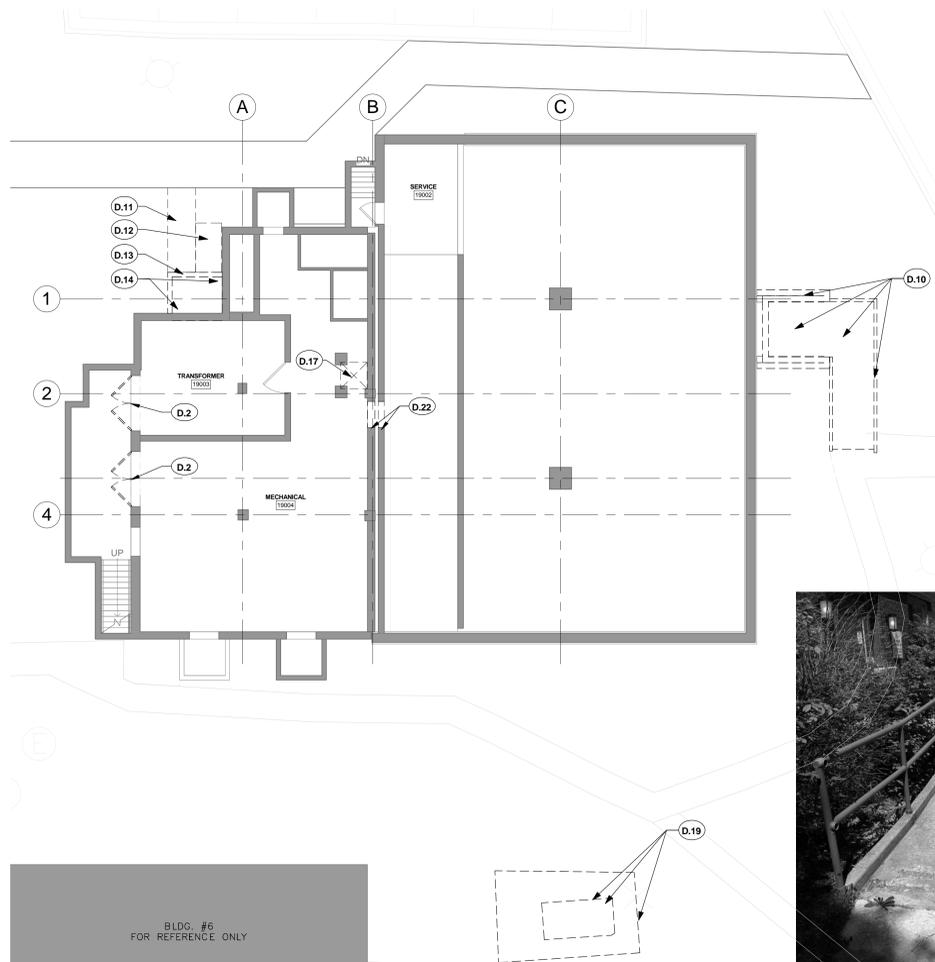


1 SITE AND LOWER FLOOR DEMO. PLAN  
1/8" = 1'-0"




CONCRETE RAMP TO BE REMOVED. REF.: DEMOLITION NOTE D.10 AND 1/D010

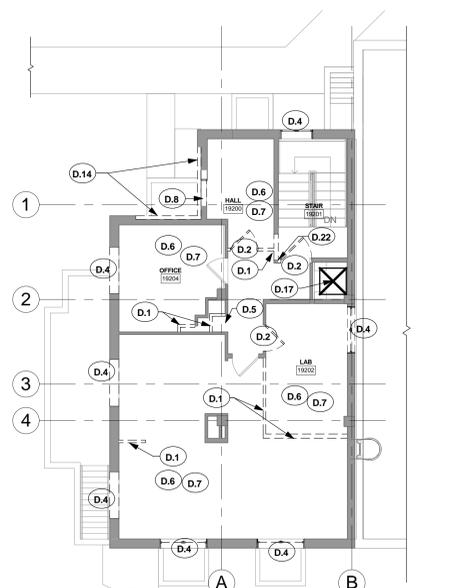

3 SECOND FLOOR DEMOLITION PLAN  
1/8" = 1'-0"

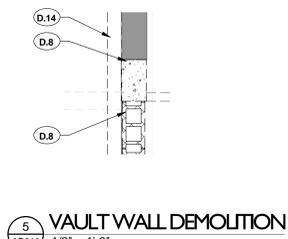

5 VAULT WALL DEMOLITION  
1/2" = 1'-0"

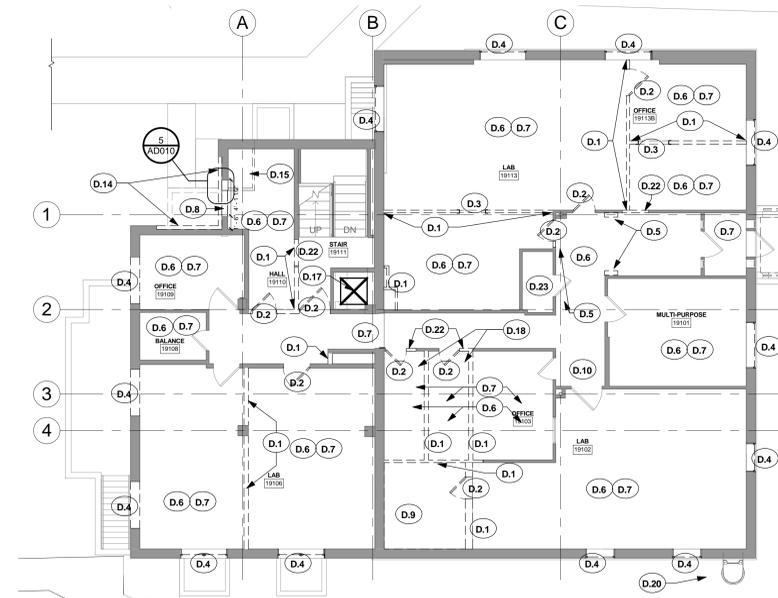

2 FIRST FLOOR DEMOLITION PLAN  
1/8" = 1'-0"

**DEMOLITION PLAN NOTES**

- D.1 REMOVE WALL FROM FLOOR TO DECK
- D.2 REMOVE DOOR AND FRAME
- D.3 REMOVE CASSED OPENING OR FRAME
- D.4 REMOVE ALUMINUM WINDOWS & FRAME. DEDUCT ALTERNATE #3 ALUMINUM WINDOWS & FRAME TO REMAIN. RE: SPECIFICATIONS
- D.5 REMOVE BULKHEAD ABOVE
- D.6 REMOVE CEILING OR CEILING FINISH
- D.7 REMOVE FLOOR FINISH AND RUBBER BASE, PREPARE SUBFLOOR TO RECEIVE NEW FINISHES
- D.8 SAW CUT AND REMOVE EXTERIOR WALL AS REQUIRED FOR ELEVATOR ACCESS. REF.: ARCHITECTURAL DWGS
- D.9 REMOVE FLOOR FINISH, CEILING, WALLS, INSULATION, AND SUBFLOOR, AT FORMER COLD STORAGE ROOM. BRING DOWN TO LEVEL W/ EXISTING FLOORS
- D.10 REMOVE CONCRETE RAMPS, HANDRAILS, WALLS AND LANDING. REMOVE SIDEWALK AS REQ. FOR CLEAN TRANSITION
- D.11 REMOVE SIDEWALK AND LANDSCAPING SHRUBS.
- D.12 REMOVE CHAINLINK FENCE, CONCRETE PAD AND METAL CANOPY
- D.13 REMOVE POURED IN PLACE CONCRETE WELL, LOUVER AND FRAME
- D.14 SAW CUT AND REMOVE BRICK VENEER TO ALIGN TO NEW CMU ELEVATOR SHAFT WALL.
- D.15 REMOVE CONCRETE WELL WITH LEAD LINING
- D.16 REFERENCE MECHANICAL SHEETS FOR EQUIPMENT REMOVAL. REMOVE ALL UNUSED CURBS AND RESTORE ROOF
- D.17 REMOVE DUMBWAITER EQUIPMENT.
- D.18 REMOVE AND SALVAGE LOCKERS FOR REINSTALLATION
- D.19 REMOVE COOLING UNIT, FENCE AND PAD. RE: MECHANICAL PLANS
- D.20 PROTECT ROOF ACCESS LADDER, REPAIR ANY DAMAGE
- D.21 REMOVE ROOF HATCH AND COLLAR AND RESTORE ROOF
- D.22 REMOVE WALL AS NEEDED FOR NEW DOOR.
- D.23 EXISTING EQUIPMENT AND FIXTURES TO BE REMOVED BY OWNER AND REINSTALLED AFTER COMPLETION OF NEW FINISHES


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**FOR BID**

Drawing Title <b>DEMOLITION PLANS</b>	Project Title <b>RENOVATE RESEARCH BUILDING 19 - T661</b>	Project Number <b>12.1004</b>	OFFICE OF FACILITIES MANAGEMENT
Approved: Project Director <b>Anthony C. Costanzo</b> anthony.costanzo@va.gov 502-287-4222	Location <b>ROBLEY REX VAMC</b>	Building Number <b>Bldg-19</b>	
Date <b>8/17/2012</b>	Checked By: <b>LJL</b>	Drawing Number <b>AD010</b>	VA Project Number <b>603-12-601 - T661</b>
		Drawn By: <b>STW</b>	Department of Veterans Affairs

Revisions:	Date

**ROBLEY REX VAMC System**  
800 Zorn Ave.  
Louisville, KY 40206

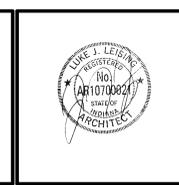

MEP/HVAC DESIGN  
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Site Civil, MEP Engineers  
9100 Markfield Road  
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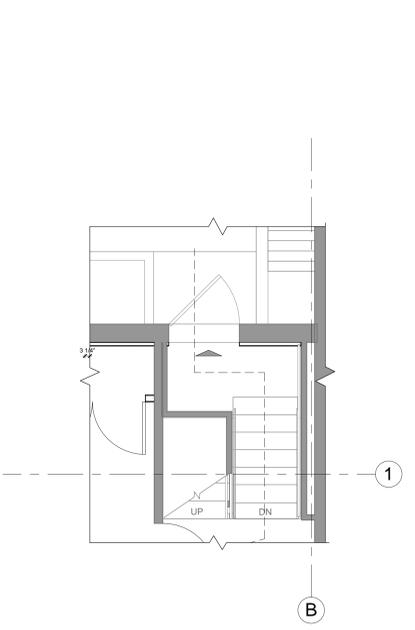
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2453 N. DELAWARE ST. INDIANAPOLIS, IN. 46205  
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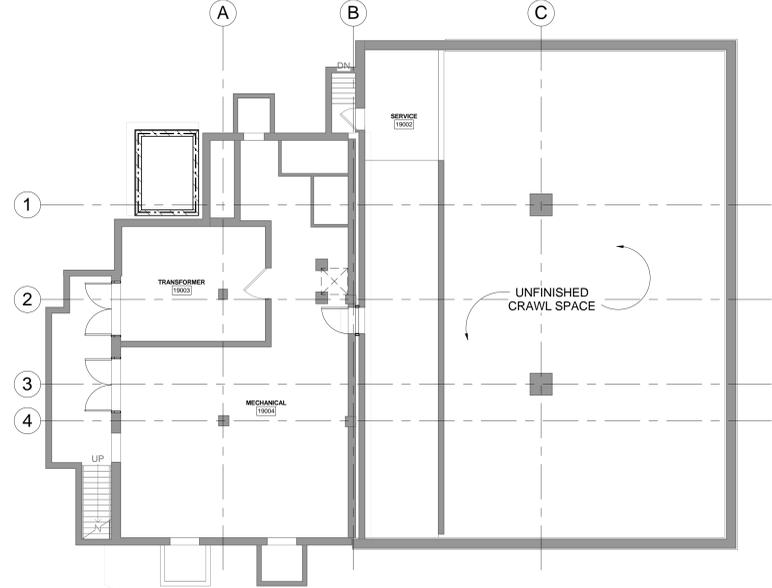
LIFE SAFETY LEGEND	
---	MAX TRAVEL DISTANCE
---	EXISTING SEPARATION
---	1 HR RATED WALL
☒	FIRE EXTINGUISHER CABINET
⬆	EXIT DOOR
▲	RECESSED FIRE EXTINGUISHER
▲	NEW EGRESS HARDWARE
▲	EXISTING EGRESS HARDWARE

**CODE REVIEW**


- The 2009 edition of the Life Safety Code, NFPA 101 and the Fifth Edition of the Department of Veterans Affairs Fire Protection Design Manual have been used to review the above referenced project for compliance with the fire and life safety requirements. For features not addressed by NFPA 101 and the referenced National Fire Codes, the 2009 edition of the International Building Code has been used.
- The existing building is undergoing a remodel and we used as a medical laboratory building. The occupancy is a Group B, Business Occupancy.
- The construction type is determined based upon the allowable area and height requirements of chapter 5 of the 2009 IBC. Type II-0000 is permitted for this building. Construction type and materials shall be per Chapter 6 of the IBC for type II-B construction as follows:  
 Fire Resistive Ratings - II-B Construction:  
 Exterior Walls Bearing: Noncombustible, 0 hour fire resistive  
 Exterior Walls, Non-Bearing: Noncombustible, 0 hour fire-resistive  
 Interior Walls, Bearing: Noncombustible, 0-hour fire resistive  
 Structural Frame: Noncombustible, 0-hour fire resistive  
 Floor-Ceiling: Noncombustible, 0-hour fire resistive  
 Roof-Ceiling: Noncombustible, 0-hour fire resistive  
 Interior Walls, Nonbearing, (Permanent Partitions): Noncombustible.  
 Structural design shall comply with Chapter 16 of the IBC.
- Allowable Area: Based upon non combustible, unprotected construction.  
 Basic Allowable Area: 23,000 SF (IBC, Table 503 S-1)  
 Open Perimeter (20 Feet): 17,250  
 Automatic Sprinklers (200%): 46,000 SF (IBC 506.3)  
 Total: 86,250 SF  
 Actual Area is 4,545 S.F.
- Allowable Height: 4 stories permitted (IBC table 503)  
 75 feet (IBC Table 503 plus sprinkler increase of section 504.2)  
 Actual building is two story.  
 Actual Height is 34 feet.
- Separation of Buildings: 10 feet minimum (IBC table 602)
- Occupancy Separation: Occupancy separation is not required.
- Hazardous Room Separation: None required
- Smoke partitions are required in the training center to separate the following:  
 - Storage rooms over 100 sf (NFPA 101)  
 - Mechanical rooms with equipment with an aggregate input rating exceeding 200,000 Btu (NFPA 101)
- One hour partitions are required to separate the following:  
 - Elevator hoistway
- Means of egress requirements shall comply with NFPA 101.  
 Maximum Travel Distance: 300 Feet  
 Common Path of travel: Training Center Assembly: 75 feet is permitted except that for assembly rooms areas with an occupant load exceeding 50, a 20 foot common path of travel is permitted.  
 Dead ends: 50 feet  
 Number of exits: NFPA 101 38.2.4.6. A single exit is permitted from a single tenant building 2 or fewer stories in height protected by automatic sprinklers where the total travel distance to the exterior does not exceed 100 feet.  
 No fire separation is required for exit stair.  
 Clear Width of exits: Doors - 34 inches clear Min.  
 Clear Width of corridors: 36 inches clear Min. (occupant load less than 50)  
 Exit signs: Exit marking is provided as follows: Exit signs are provided in accessible to the public in accordance with NFPA 101, and shall be of the LED type. Incandescent signs are not permitted.
- Interior Finish:  
 Walls and Ceilings: Interior finish flame spread shall be limited per Chapter 8 of the NFPA 101 to Class A, B and C materials. Interior wall and ceiling finish shall be Class A or Class B in exits, corridors and lobbies; and Class A, Class B, or Class C in all other areas.  
 Class A: Flame Spread 0-25; Smoke Developed 0-450  
 Class B: Flame Spread 26-75; Smoke Developed 0-450  
 Class C: Flame Spread 76-200; Smoke Developed 0-450  
 Floors: Interior floor finish shall be Class I or Class II in corridors and exits.  
 Fabric Draperies, curtains (excluding shower curtains, but including cubicle curtains), and other loosely hanging fabrics and films serving as furnishings or decorations in health care occupancies must meet the flame resistance requirements of NFPA 701, Standard Methods of Fire Tests for Flame-Resistant Textiles and Films.
- Fabric Draperies, curtains (excluding shower curtains, but including cubicle curtains), and other loosely hanging fabrics and films serving as furnishings or decorations in health care occupancies must meet specified requirements, based on NFPA 260, NFPA 261, NFPA 266, 16 CFR 1632, ASTM E1537, and ASTM E1590
- Fire Suppression:  
 Sprinkler system: Laboratory building is required to be sprinkled throughout in accordance with NFPA 13.  
 The sprinkler system is hydraulically designed in accordance with 2010 edition of NFPA 13 and the Fifth Edition of the Department of Veterans Affairs Fire Protection Design Manual and NFPA 45 shall regulate design area and density.  
 Minimum Design Requirements: Laboratory is classified as a class C lab and shall be protected as Ordinary Hazard Occupancy, Group 1; 0.15 gpm/ft<sup>2</sup> over 1,500 ft<sup>2</sup>.  
 Hose stream allowance: 250 GPM  
 Portable Fire extinguishers: Fire Extinguishers are required in accordance with NFPA 101 and NFPA 10.  
 Standpipe systems: Standpipe systems are not required.
- Fire alarm system: A combined manual and automatic Fire Alarm system shall be required.




5 EGRESS LEVEL LIFE SAFETY PLAN  
1/4" = 1'-0"



3 LOWER LEVEL LIFE SAFETY PLAN  
1/8" = 1'-0"

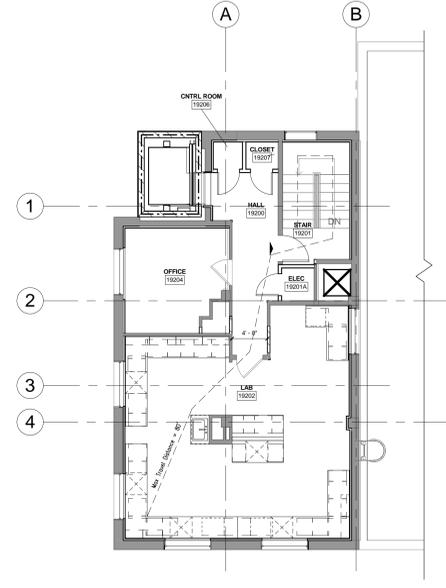

4 SECOND LEVEL LIFE SAFETY PLAN  
1/8" = 1'-0"

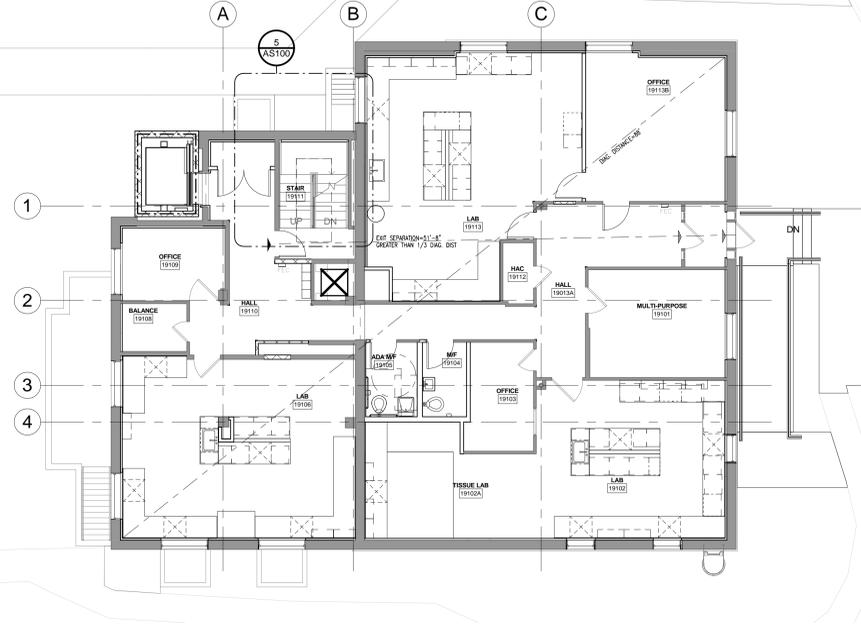


1 FIRST LEVEL LIFE SAFETY PLAN  
1/8" = 1'-0"

FULLY SPRINKLERED			
FOR BID			
Drawing Title	Project Title	Project Number	OFFICE OF FACILITIES MANAGEMENT
LIFE SAFETY PLANS	RENOVATE RESEARCH BUILDING 19 - T661	12.1004	
Approved: Project Director	Location	Building Number	VA Project Number
Anthony C. Costanzo anthony.costanzo@va.gov 502-287-4222	ROBLEY REX VAMC	Bldg-19	
Date	Checked By:	Drawn By:	AS100
8/17/2012	LJL	STW	
Department of Veterans Affairs			

Revisions:	Date

**ROBLEY REX VAMC System**  
800 Zorn Ave.  
Louisville, KY 40206

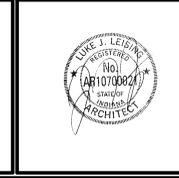

MEP/HVAC DESIGN  
**BCCLT, Inc.**  
www.bcclt.com

Site Civil, MEP Engineers  
9100 Markfield Road  
Suite 200  
Louisville, KY 40222  
T: 502-708-1860

INTERIOR DESIGN ARCHITECT  
**JRA Architects**  
www.jraarchitects.com

Louisville Office:  
3225 Summit Square Place,  
Suite 200  
Louisville, KY 40206  
T: 502-583-4697

**BCCLT**  
Blugi, Chance, Cummins, London, Tizer

**JRA**  
architects

PROJECT LEADER/ARCHITECT:  
**GUIDON DESIGN**

2453 N. DELAWARE ST. INDIANAPOLIS, IN. 46205  
317.800.6388 WWW.GUIDONDESIGN.COM  
SUSTAINABLE ARCHITECTURE + ENGINEERING

Approved: Project Director  
**Anthony C. Costanzo**  
anthony.costanzo@va.gov  
502-287-4222

Date: 8/17/2012  
Checked By: LJL  
Drawn By: STW

Project Number: 12.1004  
Building Number: Bldg-19  
Drawing Number: AS100  
VA Project Number: 603-12-601 - T661

Department of Veterans Affairs



**REFLECTED CEILING NOTES**


- A. ALL ACOUSTICAL CEILING TILE CEILINGS TO BE 8'-2" A.F.F. UNLESS NOTED OTHERWISE
- B. REFER TO REFLECTED CEILING PLAN FOR ADDITIONAL NOTES AND CEILING INFORMATION.
- C. PROVIDE CONTROL JOINTS IN PLASTER & GYPSUM BOARD CEILINGS AND BULKHEADS WHERE RECOMMENDED/REQUIRED BY MANUFACTURERS OR INDUSTRY STANDARDS, OR WHERE INDICATED. COORDINATE LOCATION WITH ARCHITECT.
- D. ALL CEILING HEIGHTS ARE FROM FINISHED FLOOR.
- E. INSTALL SUSPENDED CEILING GRID WITH EQUAL SIZE PANELS AT EACH SIDE OR END OF THE INDIVIDUAL SPACES UNLESS OTHERWISE INDICATED. NO PANEL SHALL BE LESS THAN 4" WIDE.
- F. THE ARCHITECTURAL REFLECTED CEILING PLAN SHALL GOVERN THE LAYOUT OF ALL CEILING ELEMENTS AND/OR PENETRATIONS. COORDINATE ANY FIELD VERIFIED OR AS-BUILT CONDITIONS THAT DIFFER FROM WHAT IS SHOWN ON THESE PLANS WITH THE ARCHITECT.
- G. SIZES AND SHAPES OF LIGHTING FIXTURES AND OTHER MISCELLANEOUS ELECTRICAL EQUIPMENT (IF SHOWN) ARE FOR REFERENCE ONLY. COORDINATE ACTUAL SIZES AND TYPES WITH THE ELECTRICAL DRAWINGS/ENGINEER.
- H. COORDINATE CLEARANCES WITH M.E.P. DRAWINGS. NOTIFY ARCHITECT OF CONFLICTS PRIOR TO CONSTRUCTION.
- J. SIZES OF MECHANICAL EQUIPMENT (IF SHOWN) ARE FOR REFERENCE ONLY. COORDINATE ACTUAL SIZES AND TYPES WITH MECHANICAL DRAWINGS/ENGINEER.
- K. ALL CEILING MOUNTED ITEMS (SPRINKLER HEADS, MOUNTING MECHANISMS, ETC.) SHALL BE CENTERED IN THE CEILING PANELS UNLESS OTHERWISE NOTED/INDICATED.

**REFLECTED CEILING PLAN KEY NOTES**


- C.1 NOT USED
- C.2 PAINT ALL GYP BOARD CEILINGS P-6. PAINT VERTICAL BULKHEADS P-1. SEE FINISH LEGEND.
- C.3 PAINT ALL EXPOSED FIREPROTECTION AND PLUMBING PIPES, HANGER AND SUPPORTS P-3. SEE FINISH LEGEND.
- C.4 EXTEND WALL TO DECK
- C.5 PAINT ALL EXPOSED ALL DUCTS, MECHANICAL UNITS, DAMPERS ETC. P-4. SEE FINISH LEGEND.
- C.6 PAINT ALL EXPOSED STRUCTUR, CONDUIT AND OTHER EQUIPMENT P-5. SEE FINISH LEGEND.

**REFLECTED CEILING PLAN LEGEND**


A		GYPSUM BOARD, PAINTED
B		2x4 SUSPENDED ACOUSTICAL CEILING TILE AND GRID SYSTEM
C		2x2 SUSPENDED ACOUSTICAL CEILING TILE AND GRID SYSTEM
D		EXPOSED STRUCTURAL DECK ABOVE
		LIGHT FIXTURES AND DIFFUSERS
<p>CEILING TYPE</p> <p>CEILING TAG</p> <p>CEILING HEIGHT ABOVE FIN.FLR. AT LOWER LEVEL</p>		

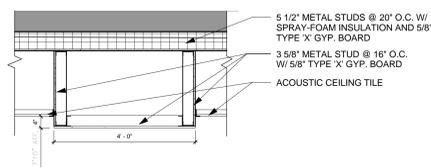

**6 DROPPED BULKHEAD**  
1/2" = 1'-0"

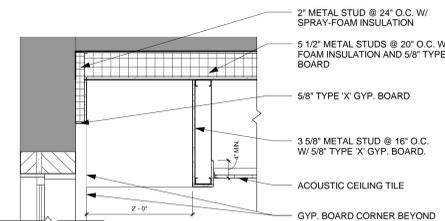


**5 LIGHTWELL SECTION, TYP**  
3/4" = 1'-0"

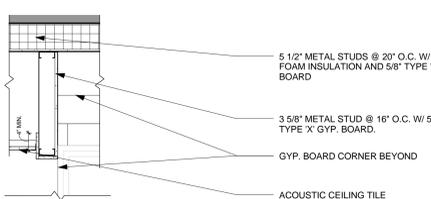


**8 HALLWAY BULKHEAD**  
1/2" = 1'-0"

**4 LIGHTWELL SIDE SECTION, TYP**  
3/4" = 1'-0"

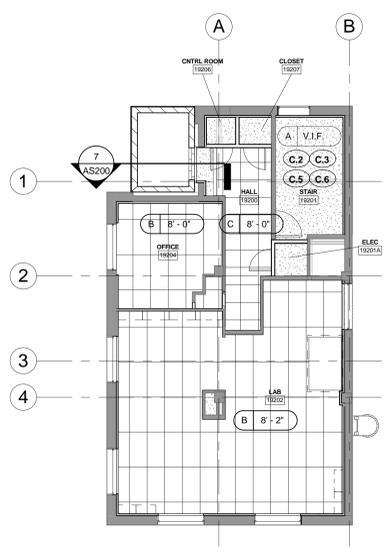


**2 2ND FLOOR REFLECTED CEILING PLAN**  
1/8" = 1'-0"

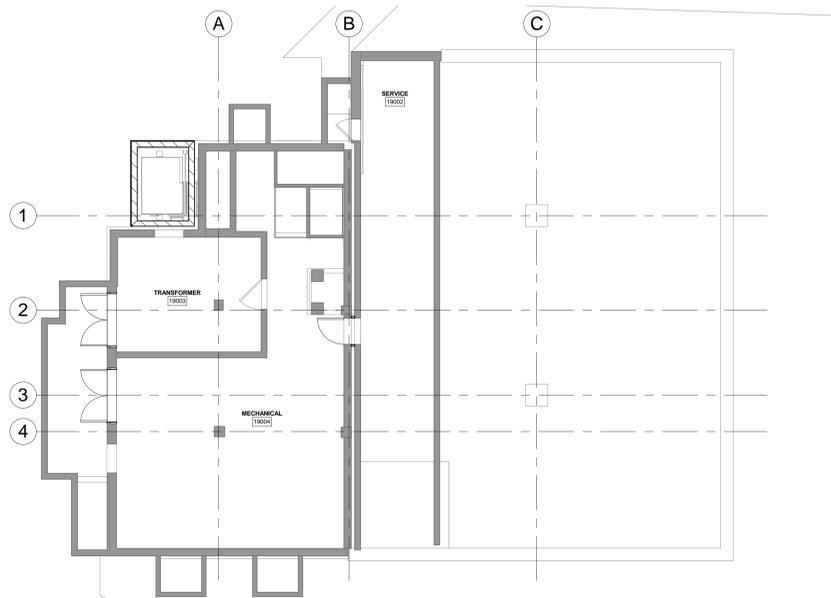


NOTE: ALL CEILINGS THIS FLOOR TO BE EXPOSED

**3 BASEMENT REFLECTED CEILING PLAN**  
1/8" = 1'-0"

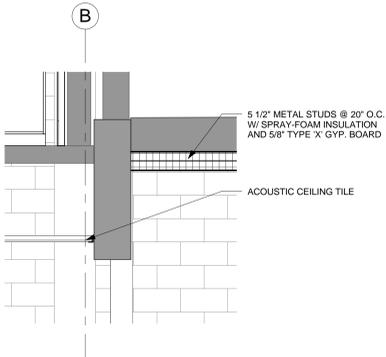

**7 ELEVATOR BULKHEAD**  
1/2" = 1'-0"

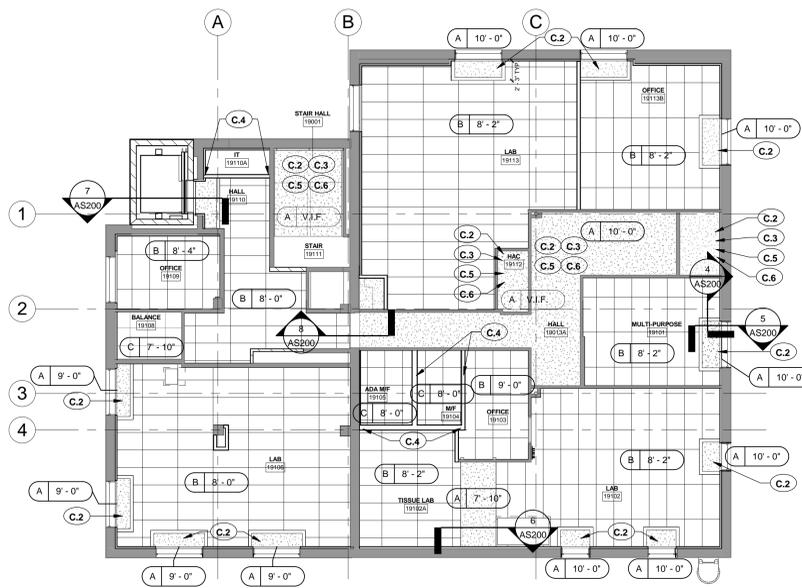

**1 1ST FLOOR REFLECTED CEILING PLAN**  
1/8" = 1'-0"


FULLY SPRINKLERED

FOR BID


<p>Revisions:</p> <table border="1"> <tr> <th>No.</th> <th>Description</th> <th>Date</th> </tr> <tr> <td> </td> <td> </td> <td> </td> </tr> </table>	No.	Description	Date				<p><b>ROBLEY REX VAMC System</b> 800 Zorn Ave. Louisville, KY 40206</p>	<p><b>JRA ARCHITECTS</b> Louisville Office: 3225 Summit Square Place, Suite 200 Louisville, KY 40226 T: 502-583-4697</p>	<p>MEP/HVAC DESIGN</p> <p><b>BCCLT, Inc.</b> www.bcclt.com</p> <p>Site Civil, MEP Engineers 9100 Markfield Road Suite 200 Louisville, KY 40222 T: 502-708-1860</p> <p><b>BCCLT</b> Bugs, Chance, Cummins, London, Titzer</p>	<p>PROJECT LEADER/ARCHITECT:</p> <p><b>GUIDON DESIGN</b></p> <p>2453 N. DELAWARE ST. INDIANAPOLIS, IN. 46205 317.800.6388 WWW.GUIDONDESIGN.COM SUSTAINABLE ARCHITECTURE + ENGINEERING</p>	<p>Drawing Title</p> <p><b>REFLECTED CEILING PLANS</b></p>	<p>Project Title</p> <p><b>RENOVATE RESEARCH BUILDING 19 - T661</b></p>	<p>Project Number</p> <p>12.1004</p>	<p>Office of Facilities Management</p>
	No.	Description	Date											
<p>Approved: Project Director</p> <p><b>Anthony C. Costanzo</b> anthony.costanzo@va.gov 502-287-4222</p>	<p>Location</p> <p><b>ROBLEY REX VAMC</b></p>	<p>Building Number</p> <p><b>Bldg-19</b></p>	<p>VA Project Number</p> <p>603-12-601 - T661</p>											
<p>Date</p> <p>8/17/2012</p>	<p>Checked By:</p> <p>LJL</p>	<p>Drawn By:</p> <p>STW</p>	<p>Drawing Number</p> <p><b>AS200</b></p>	<p>Department of Veterans Affairs</p>										

- ROOF PLAN GENERAL NOTES**
- A. PROVIDE MANUFACTURER'S STANDARD DETAILS WHERE MECHANICAL EQUIPMENT OCCURS, COORDINATE W/ ARCHITECTURAL AND MEP.
  - B. SEE MECHANICAL, ELECTRICAL, AND PLUMBING DRAWINGS FOR ADDITIONAL ROOF PENETRATION REQUIREMENTS.
  - C. REPAIR/REPLACE ROOFING MEMBRANE WHERE NEEDED, REFERENCE MECHANICAL PLANS TO IDENTIFY ABANDONED EQUIPMENT PLATFORMS
  - D. REMOVE ALL UNUSED EXISTING ROOF CURBS AND RESTORE ROOF. INCLUDES BUT NOT LIMITED TO AREAS NOTED R.1


- ROOF PLAN KEY NOTES**
- R.1 PATCH BUILT-UP ROOF, AS INDICATED AND ANY ADDITIONAL LOCATIONS AS REQUIRED BY NEW WORK.

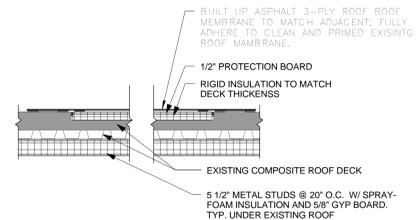


**4 TYP. ROOF CURB PATCH**  
AS300 1/2" = 1'-0"

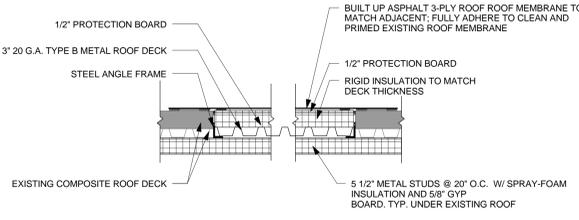

**3 TYP. ROOF PENETRATION PATCH**  
AS300 1/2" = 1'-0"

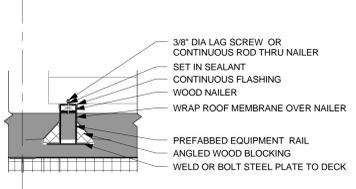

**2 MECHANICAL ROOF CURB DETAIL**  
AS300 3/4" = 1'-0"

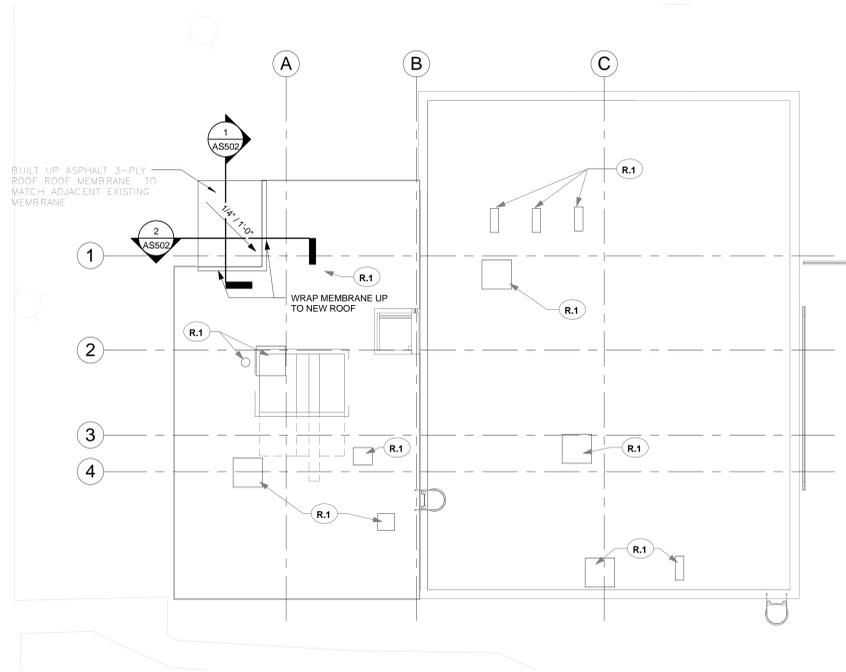


**1 ROOF PLAN**  
AS300 1/8" = 1'-0"

one eighth inch = one foot  
 one quarter inch = one foot  
 three eighths inch = one foot  
 one half inch = one foot  
 three quarters inch = one foot  
 one inch = one foot  
 one and one half inches = one foot  
 three inches = one foot

Revisions:	Date

**ROBLEY REX VAMC System**  
800 Zorn Ave.  
Louisville, KY 40206

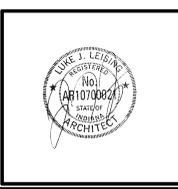

MEP / HVAC DESIGN  
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www.bcclt.com

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Louisville, KY 40222  
T: 502-708-1860

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www.jraarchitects.com

Louisville Office:  
3225 Summit Square Place,  
Suite 200  
Louisville, KY 40206  
T: 502-583-4697

**JRA architects**

PROJECT LEADER/ARCHITECT:  
**GUIDON DESIGN**


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Drawing Title <b>ROOF PLAN</b>		Project Title <b>RENOVATE RESEARCH BUILDING 19 - T661</b>		Project Number <b>12.1004</b>		OFFICE OF FACILITIES MANAGEMENT	
Approved: Project Director <b>Anthony C. Costanzo</b> anthony.costanzo@va.gov 502-287-4222		Location <b>ROBLEY REX VAMC</b>		Building Number <b>Bldg-19</b>		VA Project Number <b>603-12-601 - T661</b>	
Date <b>8/17/2012</b>		Checked By: <b>LJL</b>		Drawing Number <b>AS300</b>		Department of Veterans Affairs	
		Drawn By: <b>STW</b>					


FULLY SPRINKLERED

ELEVATION KEY NOTES


- E.1 ZINC RAIN SCREEN SYSTEM OVER SHEET APPLIED MOISTURE BARRIER
- E.2 WRAP MEMBRANE ROOF DOWN WALL TO EXISTING ROOF
- E.3 EXPANSION JOINT
- E.4 DOOR PAINT COLOR TO BE SELECTED BY ARCHITECT

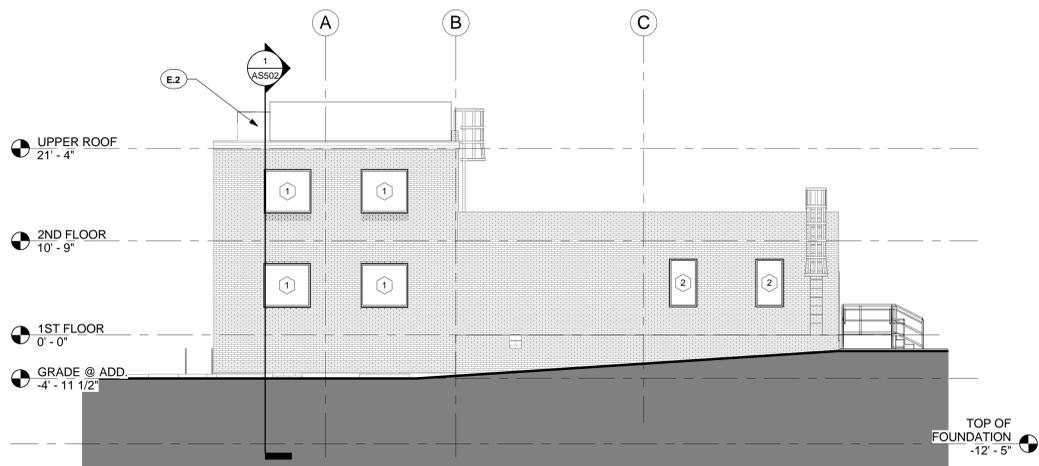


4 SOUTH ELEVATION  
AS400 1/8" = 1'-0"

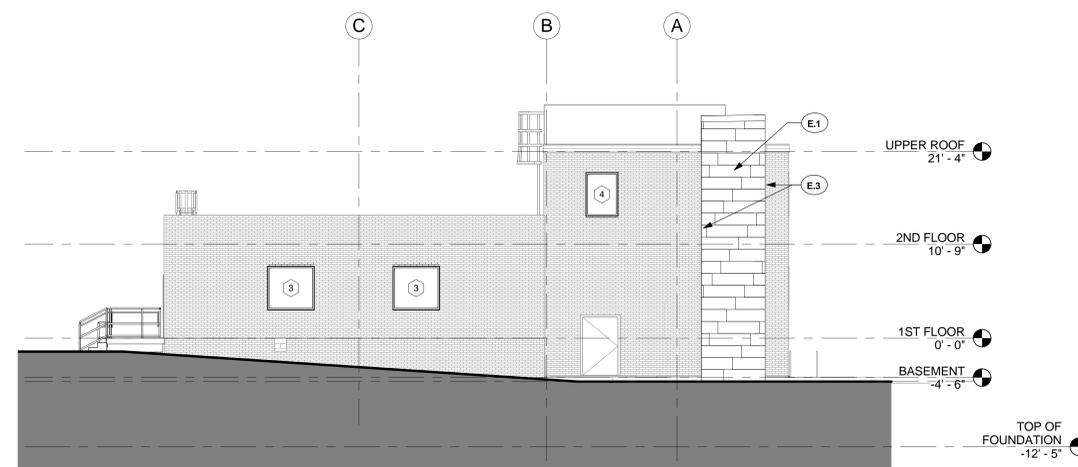

2 NORTH ELEVATION  
AS400 1/8" = 1'-0"

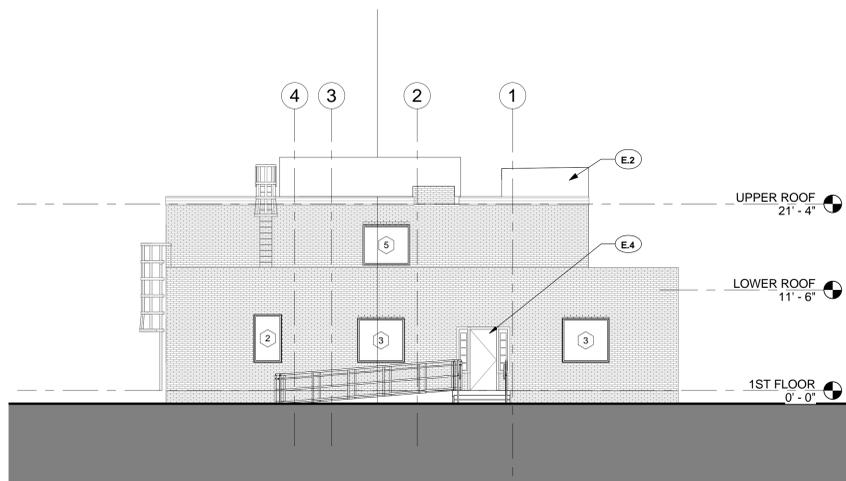

3 EAST ELEVATION  
AS400 1/8" = 1'-0"

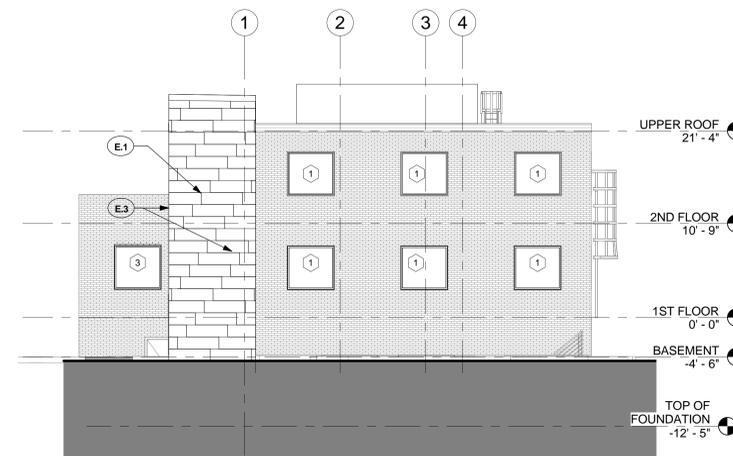

1 WEST ELEVATION  
AS400 1/8" = 1'-0"

NOTE: WINDOW REPLACEMENT ARE PART OF ALTERNATE #3

FULLY SPRINKLERED

Revisions:	Date

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**GUIDON DESIGN**  
2453 N. DELAWARE ST. INDIANAPOLIS, IN. 46205  
317.800.6388 WWW.GUIDONDESIGN.COM  
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Drawing Title <b>EXTERIOR ELEVATIONS</b>		Project Title <b>RENOVATE RESEARCH BUILDING 19 - T661</b>		Project Number <b>12.1004</b>		OFFICE OF FACILITIES MANAGEMENT	
Approved: Project Director <b>Anthony C. Costanzo</b> anthony.costanzo@va.gov 502-287-4222		Location <b>ROBLEY REX VAMC</b>		Building Number <b>Bldg-19</b>		VA Project Number <b>603-12-601 - T661</b>	
Date <b>8/17/2012</b>		Checked By: <b>LJL</b>		Drawn By: <b>STW</b>		<b>AS400</b>	
						Department of Veterans Affairs	







EXISTING WINDOW CONDITION: WINDOW AND FRAME TO BE REPLACED

**6 SILL CONDITION 2**

1/4" = 1'-0"

NOT TO SCALE




EXISTING WINDOW CONDITION: WINDOW AND FRAME TO BE REPLACED

**5 SILL CONDITION 1**

1/4" = 1'-0"


NOT TO SCALE

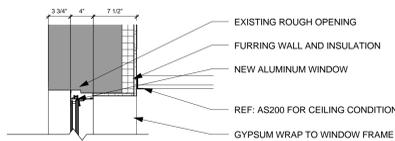

**3 WINDOW HEADER, TYP**

1" = 1'-0"


PART OF ALTERNATE #3

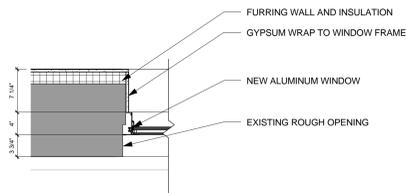

**2 WINDOW JAMB, TYP**

1" = 1'-0"

PART OF ALTERNATE #3

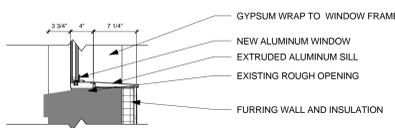

**1 WINDOW SILL, TYP**

1" = 1'-0"

PART OF ALTERNATE #3


#	R.O.		Type	Material	Finish	Head	Jamb	Sill	Glazing		Comments	U-Value	T-Vis	SHGC
	Width	Height							Thickness	Type				
1	5'-4"	5'-0 1/2"	FIXED SINGLE	AL	ANNO. AL	3/A800	2/A800	1/A800	1 1/4" IGU		1, 2, 3	0.3	.56	.45
2	3'-2"	5'-6"	FIXED SINGLE	AL	ANNO. AL	3/A800	2/A800	1/A800	1 1/4" IGU		1, 4	0.3	.56	.45
3	5'-4"	5'-0 1/2"	FIXED SINGLE	AL	ANNO. AL	3/A800	2/A800	1/A800	1 1/4" IGU		1, 4	0.3	.56	.45
4	3'-8"	5'-0 1/2"	FIXED SINGLE	AL	ANNO. AL	3/A800	2/A800	1/A800	1 1/4" IGU		1, 4	0.3	.56	.45
5	5'-4"	4'-7"	FIXED SINGLE	AL	ANNO. AL	3/A800	2/A800	1/A800	1 1/4" IGU		1, 2, 3	0.3	.56	.45

- ALTERNATE #3: DEDUCT WINDOWS FROM SCOPE OF WORK. EXISTING WINDOWS TO REMAIN IN PLACE. CAULK AND SEAL EXISTING WINDOWS AND PROVIDE INTERIOR SURFACE (SURFACE #4) INFRA-RED AND UV REFLECTIVE LOW-E WINDOW FILM.
- PROVIDE LIGHT PROOF SHADES FOR ROOM 19202
- SILL CONDITION 1
- SILL CONDITION 2

NOTE: CONTRACTOR TO SPECIFICALLY FIELD MEASURE EACH WINDOW OPENING IN ORDER TO VERIFY EXISTING CONDITIONS. PAY CLOSE ATTENTION TO SILL DETAIL/SIZES AS THEY CHANGE.

Door Number	Type	Door						Frame				Comments		
		Width	Height	Thickness	Material	Finish	Hardware	Type	Material	Finish	Jamb			
002.1	ETR	2'-6"	7'-0"	0'-2"	ETR	EX. PAINT	ETR	ETR	EX. PAINT					
003.1	D	6'-0"	7'-0"	0'-2"	HM	PAINT	HW-E6	2	HM	PAINT				PART OF ALT #3
004.1	D	6'-0"	7'-0"	0'-2"	HM	PAINT	HW-E6	2	HM	PAINT				PART OF ALT #3
004.2	B	3'-0"	7'-0"	0'-2"	HM	PAINT	HW-E6	1	HM	PAINT				
005.1	ETR	3'-6"	7'-0"	0'-2"	ETR	EX. PAINT	ETR	ETR	EX. PAINT					
013.1	ETR	3'-0"	7'-0"	0'-2"	ETR	EX. PAINT	ETR	ETR	EX. PAINT	N/A				EXISTING DOOR TO REMAIN CLEAN & PAINT
013.2	ETR	3'-0"	7'-0"	0'-2"	ETR	EX. PAINT	ETR	ETR	EX. PAINT	N/A				EXISTING DOOR TO REMAIN CLEAN & PAINT
013.3	B	3'-0"	7'-0"	0'-2"	WD, BIRCH	CLEAR	HW-1F	1	HM	PAINT				
013.4	B	3'-0"	7'-0"	0'-2"	WD, BIRCH	CLEAR	HW-1F	1	HM	PAINT				
110.1	A	3'-0"	7'-0"	0'-2"	WD, BIRCH	CLEAR	HW-6	1	HM	PAINT				
110.2	C	6'-0"	7'-0"	0'-2"	WD, BIRCH	CLEAR	HW-10G	2	HM	PAINT				1,2
113.1	A	3'-0"	7'-0"	0'-2"	WD, BIRCH	CLEAR	HW-3B	1	HM	PAINT				
113.2	A	3'-0"	7'-0"	0'-2"	WD, BIRCH	CLEAR	HW-3	1	HM	PAINT				
113.3	A	3'-0"	7'-0"	0'-2"	WD, BIRCH	CLEAR	HW-3B	1	HM	PAINT				
200.1	A	3'-0"	7'-0"	0'-2"	WD, BIRCH	CLEAR	HW-6	1	HM	PAINT				
200.2	B	2'-6"	7'-0"	0'-2"	WD, BIRCH	CLEAR	HW-5D	1	HM	PAINT				
200.3	B	2'-6"	7'-0"	0'-2"	WD, BIRCH	CLEAR	HW-5D	1	HM	PAINT				
200.4	B	2'-6"	7'-0"	0'-2"	WD, BIRCH	CLEAR	HW-5D	1	HM	PAINT				

- SOLID WOOD DOOR.
- DOORS TO HAVE 3/4" MIN. UNDERCUT.

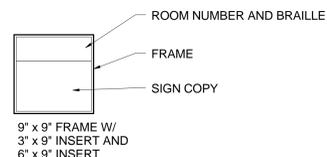


9" x 9" FRAME W/  
3" x 9" INSERT AND  
6" x 9" INSERT

**SIGNAGE NOTES:**

- PROVIDE ROOM SIGN FOR EACH SPACE INDICATED ON ROOM FINISH SCHEDULE.
- LOCATE SIGNS PER DIRECTION OF ARCHITECT.
- SIGNAGE CONSTRUCTION TO MATCH EXISTING SIGNAGE ON CAMPUS. COORDINATE WITH OWNER.


**10 SIGN DETAIL**

1 1/2" = 1'-0"

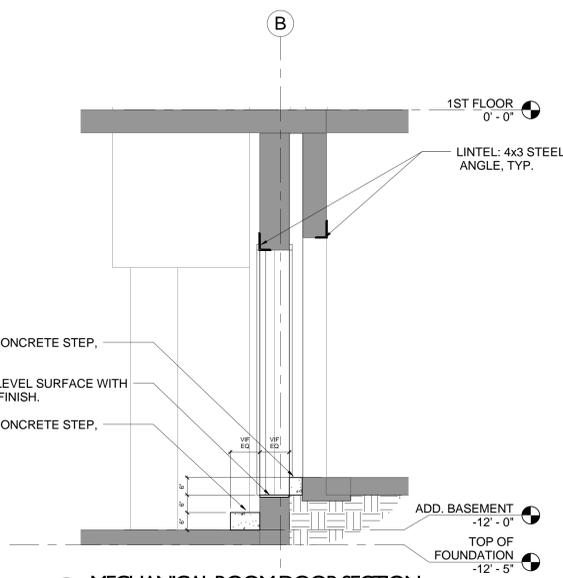

**4 MECHANICAL ROOM DOOR SECTION**

1/2" = 1'-0"

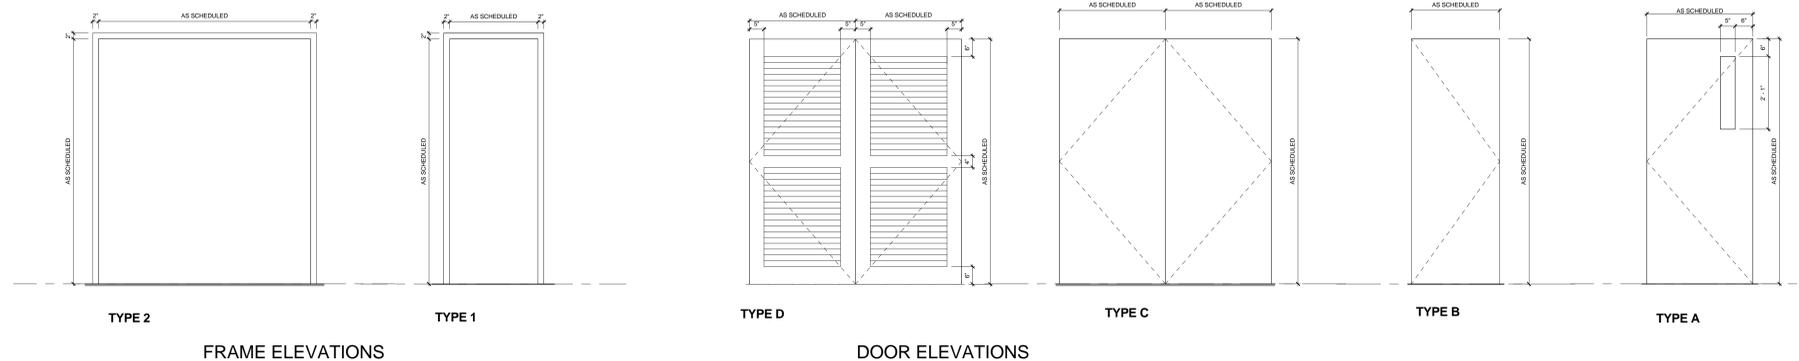

TYPE 2  
FRAME ELEVATIONS

TYPE 1

TYPE D

TYPE C  
DOOR ELEVATIONS

TYPE B

TYPE A

FULLY SPRINKLERED

Revisions:	Date

**ROBLEY REX VAMC System**  
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Louisville, KY 40206

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FOR BID			
Drawing Title <b>DOOR AND WINDOW DETAILS</b>	Project Title <b>RENOVATE RESEARCH BUILDING 19 - T661</b>	Project Number 12.1004	OFFICE OF FACILITIES MANAGEMENT
Approved: Project Director <b>Anthony C. Costanzo</b> anthony.costanzo@va.gov 502-287-4222	Location <b>ROBLEY REX VAMC</b>	Building Number Bldg-19	VA Project Number 603-12-601 - T661
Date 8/17/2012	Checked By: LJL	Drawn By: STW	<b>AS800</b> Department of Veterans Affairs

Room Number	Room Name	Floor Finish	Base Finish	Wall Finish	Ceiling Finish	Ceiling Height	REMARKS
19001	STAIR HALL	CPT-W	EXISTING	PAINT	PAINT		1,2,6.
19002	SERVICE	EXIST	EXISTING	EXIST	EXPOSED DECKING		
19003	TRANSFORMER	EXIST	EXISTING	EXIST	EXPOSED DECKING		
19004	MECHANICAL	EXIST	EXISTING	EXIST	EXPOSED DECKING		
19013	VESTIBULE	CPT-W	EXISTING	PAINT	PAINT		2.
19013A	HALL	SVT-1	RESILIENT/EXISTING	PAINT	PAINT		2.
19101	MULTI-PURPOSE	SVT-1	EXISTING	PAINT	APC-1	8' - 2"	1.
19102	LAB	SVT-1	RESILIENT BASE	PAINT	APC-1	8' - 2"	1,2., 3.
19102A	TISSUE LAB	SVT-2	RESILIENT BASE	PAINT	APC-1	8' - 2"	1,2.,
19103	OFFICE	SVT-1	RESILIENT BASE	PAINT	APC-1	9' - 0"	1,4.,
19104	M/F	SVT-1	RESILIENT BASE	PAINT AND TILE	APC-1	8' - 0"	3,5
19105	ADA M/F	SVT-1	RESILIENT BASE	PAINT AND TILE	APC-1	8' - 0"	3,5
19106	LAB	SVT-1	RESILIENT BASE	PAINT	APC-1	8' - 0"	1,2.,
19108	BALANCE	SVT-2	RESILIENT / EXISTING	PAINT	APC-1	7' - 10"	1.,
19109	OFFICE	SVT-1	RESILIENT BASE	PAINT	APC-1	8' - 4"	1,4.,
19110	HALL	SVT-1	RESILIENT BASE	PAINT	APC-1	8' - 0"	
19110A	IT	SVT-1	RESILIENT BASE	PAINT	EXPOSED DECKING		
19111	STAIR	PT-6	RESILIENT / EXISTING	PAINT	EXPOSED DECKING		1,2,6.
19112	HAC	SVT-1	RESILIENT / EXISTING	PAINT	PAINT		
19113	LAB	SVT-1	RESILIENT BASE	PAINT	APC-1	8' - 2"	1,2., 3.,
19113B	OFFICE	SVT-1	RESILIENT BASE	PAINT	APC-1	8' - 2"	1.,
19200	HALL	SVT-1	RESILIENT BASE	PAINT	APC-1	8' - 0"	
19201	STAIR	PT-6	RESILIENT / EXISTING	PAINT	PAINT		2,6.
19201A	ELEC	SVT-2	RESILIENT BASE	PAINT	PAINT		
19202	LAB	SVT-1	RESILIENT BASE	PAINT	APC-1	8' - 0"	1,2., 3.,
19204	OFFICE	SVT-1	RESILIENT BASE	PAINT	APC-1	8' - 2"	1,4.,
19206	CNTRL ROOM	SVT-2	RESILIENT BASE	PAINT	PAINT		
19207	CLOSET	SVT-2	RESILIENT BASE	PAINT	PAINT		


- ### INTERIOR GENERAL NOTES
- CONTRACTOR SHALL FIELD VERIFY ALL DIMENSIONS, LOCATIONS, AND MATERIAL QUANTITIES PRIOR TO STARTING WORK AND PURCHASING MATERIALS. REPORT ANY DISCREPANCIES TO DESIGNER / ARCHITECT.
  - CONTRACTOR SHALL COMPLY WITH ALL MANUFACTURER'S INSTALLATION METHODS AND SHALL NOT EXECUTE WORK WITHOUT VERIFICATION OF FIELD CONDITIONS.
  - REFERENCE ROOM FINISH SPECIFICATIONS FOR MATERIAL TYPE AND ADDITIONAL INFORMATION.
  - CONTRACTOR IS RESPONSIBLE TO PROVIDE AND FOR PLACEMENT OF ALL FLOOR FINISH TRANSITIONS BETWEEN MATERIALS.
  - REFERENCE FLOOR FINISH PLAN FOR DIMENSIONS, DIRECTION OF INSTALLATION AND/OR GRAIN PATTERN.
  - REFERENCE ARCHITECTURAL FLOOR PLANS FOR LOCATION OF FULL HEIGHT SURFACE MOUNTED CORNER GUARDS.
  - PAINT ALL HOLLOW METAL DOOR FRAMES PT-2, UNLESS NOTED OTHERWISE. FINISH: SEMI-GLOSS
  - LOOSE FURNITURE AND OTHER LOOSE EQUIPMENT ITEMS INDICATED ON THIS DRAWING ARE OWNER PROVIDED, NOT IN CONTRACT (N.I.C.) UNLESS NOTED OTHERWISE.
  - CASEWORK/MILLWORK INSTALLER IS RESPONSIBLE TO COORDINATE INSTALLATION IN FIELD OF MEP DIVISION 23 / 26 ITEMS INCLUDING CUT-OUTS IN CASEWORK OR COUNTERTOPS.
  - MOUNT TOP OF WALL CABINETS @ 7'-0" A.F.F., UNLESS NOTED OTHERWISE.
  - PROVIDE RESILIENT COVE BASE AT FIXED CASEWORK AND SUPPORTS UNLESS NOTED OTHERWISE.
  - PAINT BULKHEADS AS NOTED ON ROOM FINISH SCHEDULE.
  - PAINT GRILLES, LOUVERS, AND LIKE PRODUCT TO MATCH ADJACENT WALL COLOR UNLESS NOTED OTHERWISE.
  - REFERENCE REFLECTED CEILING PLAN FOR CEILING HEIGHTS, EXTENT OF BULKHEADS, AND ANY SPECIAL PAINT COLOR DESIGNATIONS.
  - PROVIDE FLAT FINISH PAINT FOR CEILING. SATIN / EGG SHELL FINISH PAINT AT WALLS UNLESS NOTED OTHERWISE.

- ### INTERIOR FINISH REMARKS
- PROVIDE HOLD DOWN CLIPS FOR CEILING GRID, REFERENCE SHEET AS201 FOR GRID LOCATIONS.
  - REFERENCE REFLECTED CEILING PLAN FOR BULKHEAD AND CEILING FINISHES ON SHEET AS201.
  - PROVIDE SVT-1,2 IN 2'-0" X 2'-0" CHECKERBOARD PATTERN.
  - PROVIDE SVT-2 IN 2'-0" WIDE BOARDER, INSET ONE TILE FROM WALLS.
  - REFERENCE ELEVATIONS FOR TILE LAYOUT PATTERN
  - PREPARE AND PAINT STAIR HANDRAILS, TREADS, RISERS, STRINGERS, KNEWLS AND GUARDS. AS RECOMMENDED BY PAINT MANUFACTURER FOR EXISTING MATERIAL.


### FINISH LEGEND

MARK	FINISH/MATERIAL
-S-	REF: 10/AS800 FOR SIGNAGE REQUIREMENTS
APC-1	ACOUSTICAL PANEL CEILING AND TRIM AS PER SPECIFICATION; SIMILAR TO: ARMSTRONG OPTIMA OPEN PLAN 3152 (24 X 24)
CG-1	VINYL CORNER GUARDS AS PER SPECIFICATION; SIMILAR TO: CS ACROVYN CAPPUCCINO 479
CPT-W	WALKOFF CARPET TILE AS PER SPECIFICATION; SIMILAR TO: INTERFACE FLOR ENTRY LEVEL 1290102500 BLACK 7187 (20 X 20)
CT-1	CERAMIC TILE AS PER SPECIFICATION; SIMILAR TO: CROSSVILLE BUENOS AIRES MOOD PAMPA VS152 (POLISHED 12 X 24)
PLAM-1	PLASTIC LAMINATE AS PER SPECIFICATION
PT-1	FIELD PAINT AS PER SPECIFICATION; SIMILAR TO: ICI PAINTS MANUSCRIPT A1844
PT-2	TRIM PAINT AS PER SPECIFICATION; SIMILAR TO: ICI PAINTS CAMEL TAN A1824
PT-3	ACCENT PAINT AS PER SPECIFICATION
PT-4	ACCENT PAINT AS PER SPECIFICATION; SIMILAR TO: ICI PAINTS THYME A0949
PT-5	ACCENT PAINT AS PER SPECIFICATION
PT-6	WHITE PAINT AS PER SPECIFICATION
RCB-1	RESILIENT 6" COVE BASE AS PER SPECIFICATION; SIMILAR TO: FLEXCO BLACK DAHLIA 01
SS	PHOENOLIC COUNTER TOPS AS PER SPECIFICATION; SIMILAR TO: CORIAN DELTA SAND
SVT-1	SOLID VINYL TILE AS PER SPECIFICATION; SIMILAR TO: AZROCK CORTINA, SPONGE BEIGE CG506 (16 X 16)


NOTE: ALL CASEWORK TO BE PART OF ALTERNATE #2

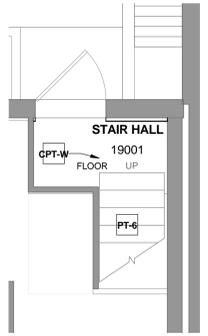

3 EXIT STAIR FINISH PLAN  
1/4" = 1'-0"

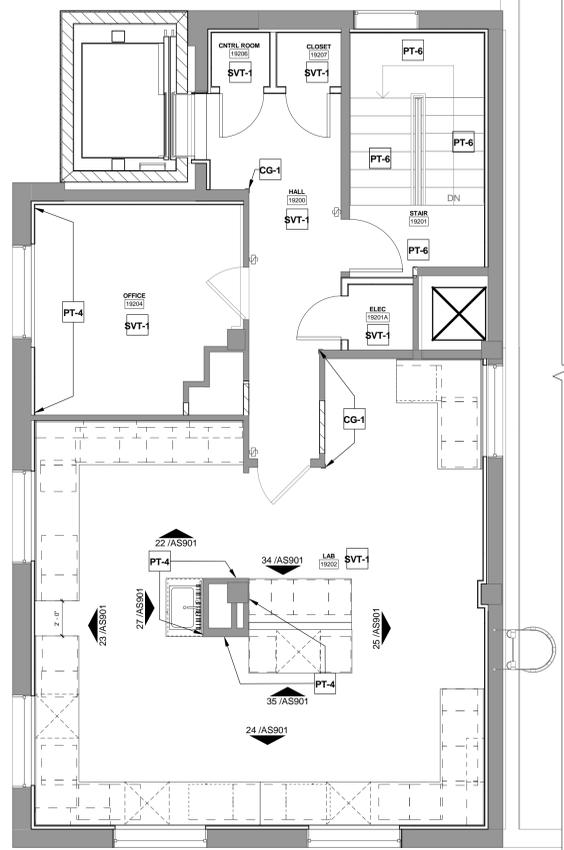

2 2ND FLOOR FINISH PLAN  
1/4" = 1'-0"

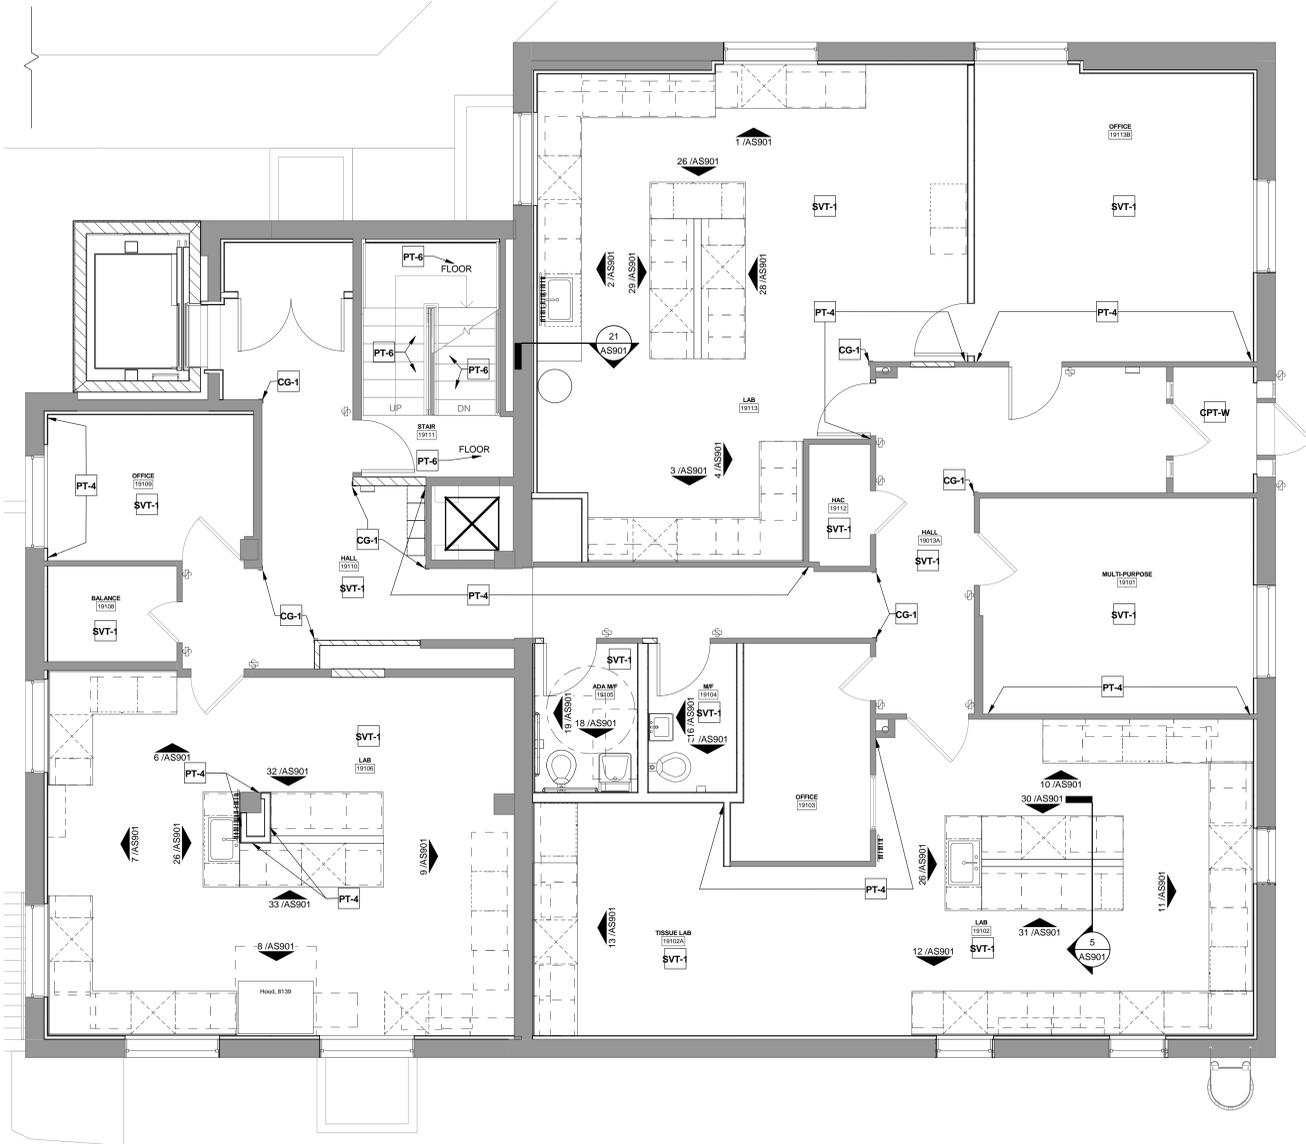

1 1ST FLOOR FINISH PLAN  
1/4" = 1'-0"

one and one half inch = one foot  
 one inch = one foot  
 three quarters inch = one foot  
 one half inch = one foot  
 three eighths inch = one foot  
 one quarter inch = one foot  
 one eighth inch = one foot

Revisions:	Date:

**ROBLEY REX VAMC System**  
800 Zorn Ave.  
Louisville, KY 40206



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Site Civil, MEP Engineers  
9100 Markfield Road  
Suite 200  
Louisville, KY 40222  
T: 502-708-1860

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Louisville Office:  
3225 Summit Square Place,  
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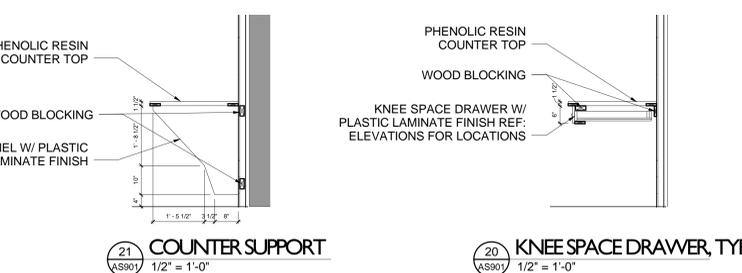
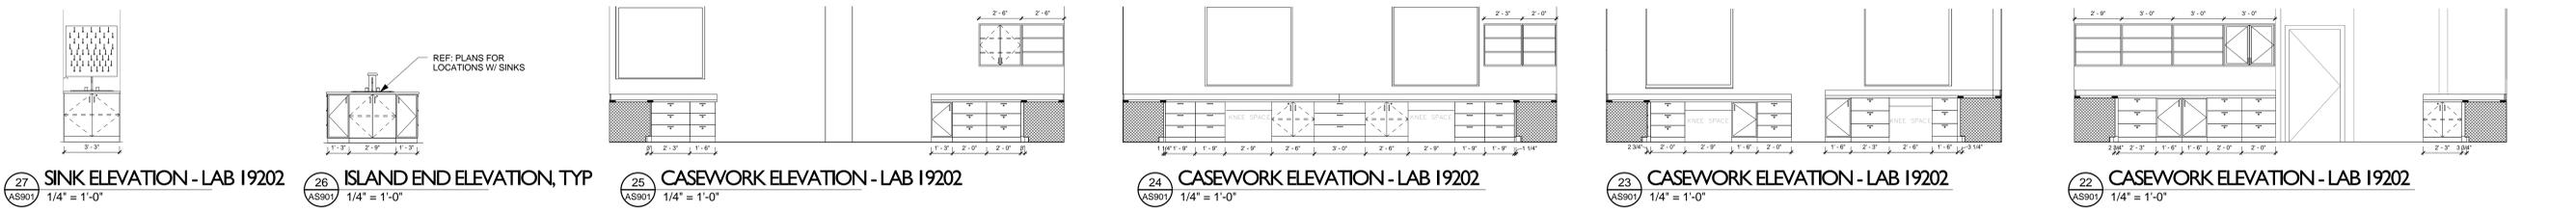
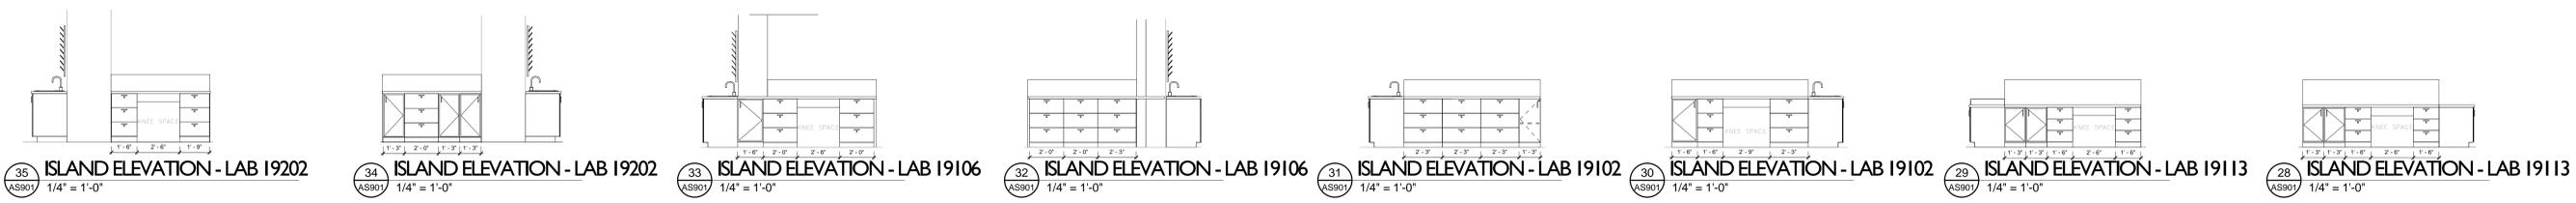
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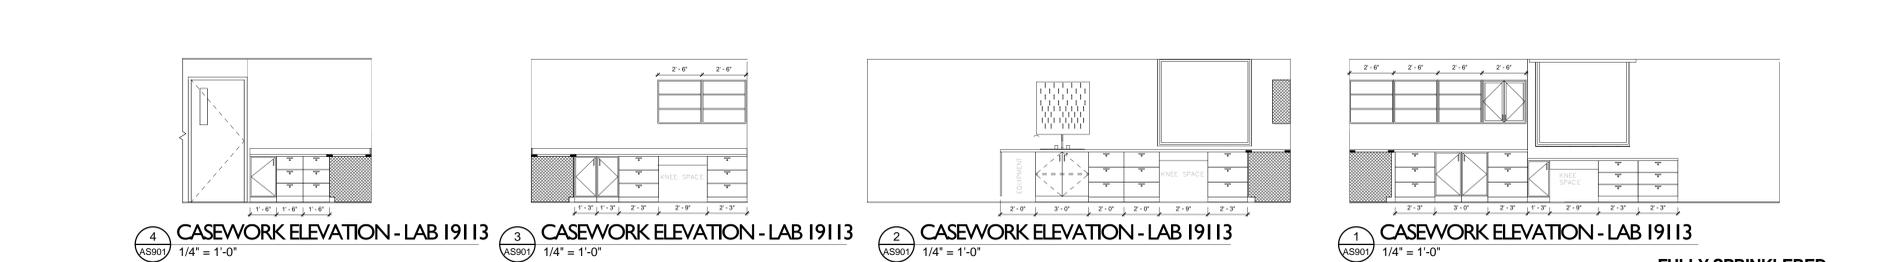
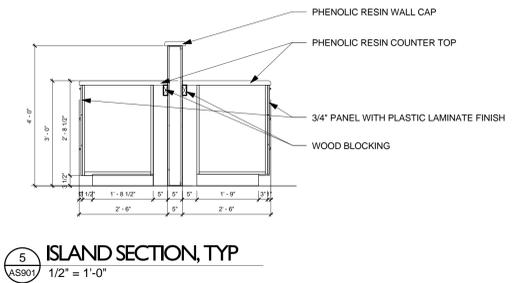
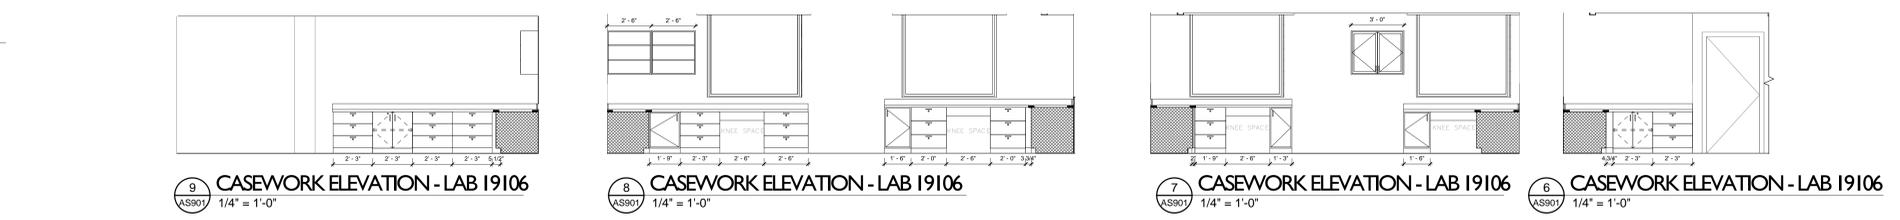
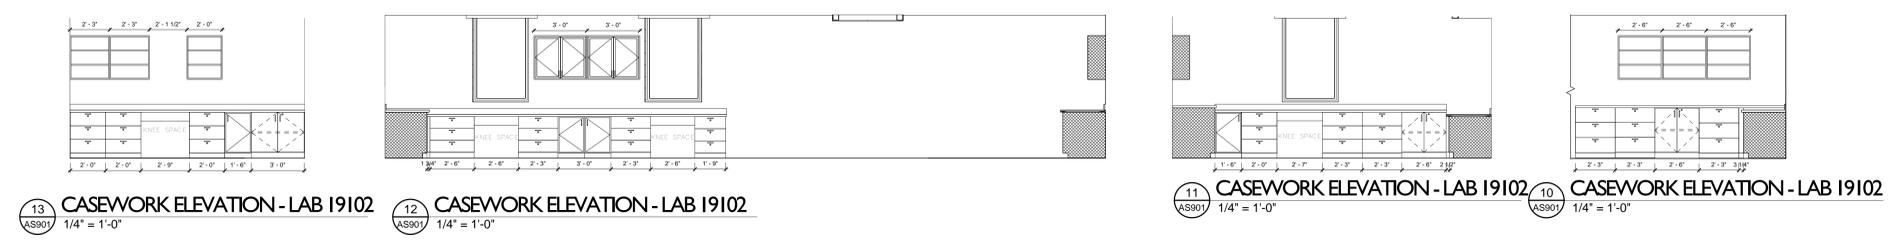
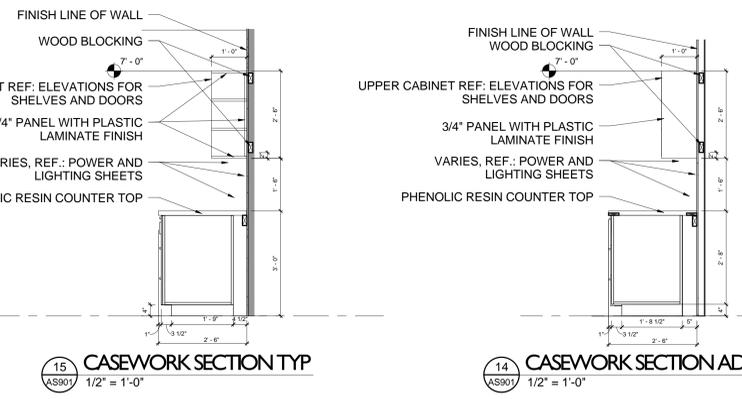
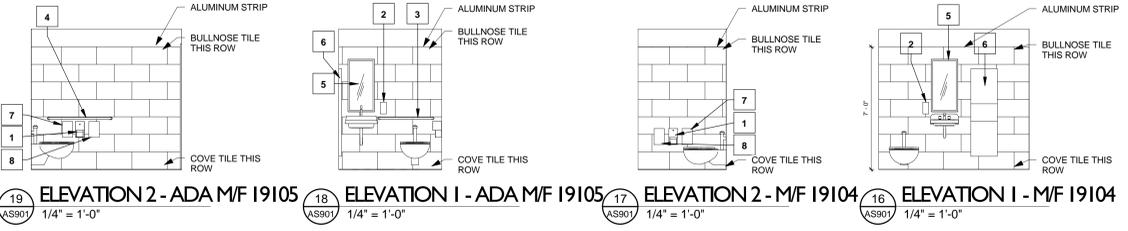
**FULLY SPRINKLERED**

Drawing Title <b>FINISH PLANS</b>		Project Title <b>RENOVATE RESEARCH BUILDING 19 - T661</b>		Project Number <b>12.1004</b>		OFFICE OF FACILITIES MANAGEMENT	
Approved: Project Director <b>Anthony C. Costanzo</b> anthony.costanzo@va.gov 502-287-4222		Location <b>ROBLEY REX VAMC</b>		Building Number <b>Bldg-19</b>		VA Project Number <b>603-12-601 - T661</b>	
Date <b>8/17/2012</b>		Checked By: <b>LJL</b>		Drawing Number <b>AS900</b>		Department of Veterans Affairs	
		Drawn By: <b>STW</b>					

**CASEWORK NOTES:**  
 ALL COUNTERS TO BE PHENOLIC RESIN (SS)  
 ALL CABINETS TO BE PLASTIC LAMINATE (PL-1)  
 NOTE: ALL CASEWORK TO BE PART OF ALTERNATE #2



NO.	ITEM	MANUFACTURER	COMMENTS
1	TOILET TISSUE DISPENSER	REFERENCE SPECIFICATIONS	O.F.C.I
2	SOAP DISPENSER	REFERENCE SPECIFICATIONS	O.F.C.I
3	GRAB BAR 36"	REFERENCE SPECIFICATIONS	C.F.C.I. SEE SPECS FOR MOUNTING HEIGHT
4	GRAB BAR 42"	REFERENCE SPECIFICATIONS	C.F.C.I. SEE SPECS FOR MOUNTING HEIGHT
5	18" X 36" MIRROR	REFERENCE SPECIFICATIONS	C.F.C.I. SEE SPECS FOR MOUNTING HEIGHT
6	COMBINATION PAPER TOWEL DISPENSER AND DISPOSAL UNIT	REFERENCE SPECIFICATIONS	O.F.C.I
7	SANITARY NAPKIN DISPOSAL	REFERENCE SPECIFICATIONS	O.F.C.I
8	SANITARY NAPKIN DISPENSER	REFERENCE SPECIFICATIONS	O.F.C.I
9	CLOTHES HOOKS, ROBE OR COAT	REFERENCE DOOR SCHEDULE	C.F.C.I. SEE SPECS FOR MOUNTING HEIGHT



**FULLY SPRINKLERED**

**FOR BID**

Drawing Title <b>CASEWORK ELEVATIONS</b>	Project Title <b>RENOVATE RESEARCH BUILDING 19 - T661</b>	Project Number <b>12.1004</b>	<b>OFFICE OF FACILITIES MANAGEMENT</b>
Approved: Project Director <b>Anthony C. Costanzo</b> anthony.costanzo@va.gov 502-287-4222	Location <b>ROBLEY REX VAMC</b>	Building Number <b>Bldg-19</b>	
Date <b>8/17/2012</b>	Checked By: <b>LJL</b>	Drawing Number <b>AS901</b>	VA Project Number <b>603-12-601 - T661</b>
			Department of Veterans Affairs

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**JRA**  
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 three quarters inch = one foot  
 one inch = one foot  
 one and one half inches = one foot  
 three inches = one foot  
 three quarters inch = one foot  
 one half inch = one foot  
 one quarter inch = one foot  
 one eighth inch = one foot

A  
 B  
 C  
 D  
 E  
 F