


## PLUMBING LEGEND

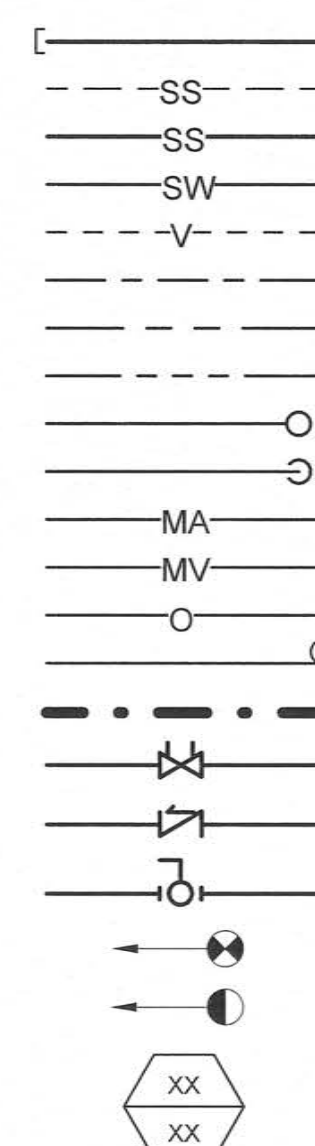


## ABBREVIATIONS


AD	AREA DRAIN
AD	AMERICANS WITH DISABILITIES ACT
AFF	ABOVE FINISHED FLOOR
AP	ACCESS PANEL
BFP	BACKFLOW PREVENTER
CV	COMMON VENT
CW	COLD WATER
FCO	FLOOR CLEANOUT (FLOOR OR SLAB)
FD	FLOOR DRAIN
GCO	GROUND CLEANOUT
GW	GREASE WATER
HB	HOSE BIB
HD	HUB DRAIN
HW	HOT WATER
HW	HOT WATER CIRCULATION
IND	INDIRECT DRAIN
I#	PLUMBING FIXTURE - NUMBER
P.C.	PLUMBING CONTRACTOR
RD	ROOF DRAIN
SW	SEWER
V	VENT
V.T.R.	VENT THROUGH ROOF
W	WASTE
WCO	WALL CLEANOUT

## GENERAL NOTES AND SPECIFICATIONS

1. THE ENTIRE PLUMBING SYSTEM SHALL BE IN ACCORDANCE WITH ALL PROJECT SPECIFICATIONS, NATIONAL CODES, AND ALL VA STANDARDS. EQUIPMENT SHALL BE INSTALLED IN ACCORDANCE TO MANUFACTURER'S WRITTEN RECOMMENDATIONS.
2. ALL WORK SHALL BE COORDINATED WITH ALL OTHER TRADES PRIOR TO INSTALLATION. CONTRACTOR SHALL COORDINATE ROUTING OF ALL PIPING WITH EXISTING CONDITIONS AND SHALL PROVIDE ANY NECESSARY OFFSETS, REROUTING, ETC. REQUIRED FOR A COMPLETE AND COORDINATED INSTALLATION.
3. THESE PLANS ARE DIAGRAMMATIC. CONTRACTOR SHALL PROVIDE ALL NECESSARY OFFSETS, TEES, ELBOWS, ETC FOR A COMPLETE WORKING PLUMBING SYSTEM.
4. THE PLUMBING CONTRACTOR SHALL COMPLY WITH ALL VA PERMIT AND INSPECTION REQUIREMENTS REQUIRED FOR THIS WORK.
5. CONTRACTOR SHALL COORDINATE ANY PLUMBING SYSTEM REQUIRING SHUTDOWN WITH THE COR 2 WEEKS IN ADVANCE.
6. ALL DOMESTIC PIPING SHOWN IS LOCATED ABOVE THE CEILING OR WITHIN WALLS UNLESS NOTED OTHERWISE.
7. ALL SANITARY SEWER PIPING SHOWN IS LOCATED BELOW GRADE OR WITHIN WALLS UNLESS NOTED OTHERWISE. ALL SANITARY VENT PIPING SHOWN IS ABOVE CEILING OR WITHIN WALLS UNLESS NOTED OTHERWISE.
8. ALL PIPING SYSTEMS SHALL BE SUPPORTED AS REQUIRED BY ALL NATIONAL CODES ALONG WITH ALL VA STANDARDS AND MANUFACTURER'S RECOMMENDATIONS.
9. ALL PIPING PENETRATIONS THRU NEW OR EXISTING WALLS OR FLOORS SHALL BE SEALED TO EQUAL THE RATING OF THE NEW OR EXISTING WALL OR FLOOR.
10. ALL PLUMBING SYSTEMS SHALL BE TESTED AS REQUIRED PER ALL NATIONAL CODES ALONG WITH ALL VA STANDARDS.
11. THE PLUMBING CONTRACTOR SHALL COORDINATE ALL PLUMBING PIPING WITH ALL STRUCTURAL COMPONENTS.
12. THE ENTIRE DOMESTIC WATER SYSTEM SHALL BE DISINFECTED IN ACCORDANCE WITH ALL NATIONAL CODES ALONG WITH ALL VA STANDARDS.

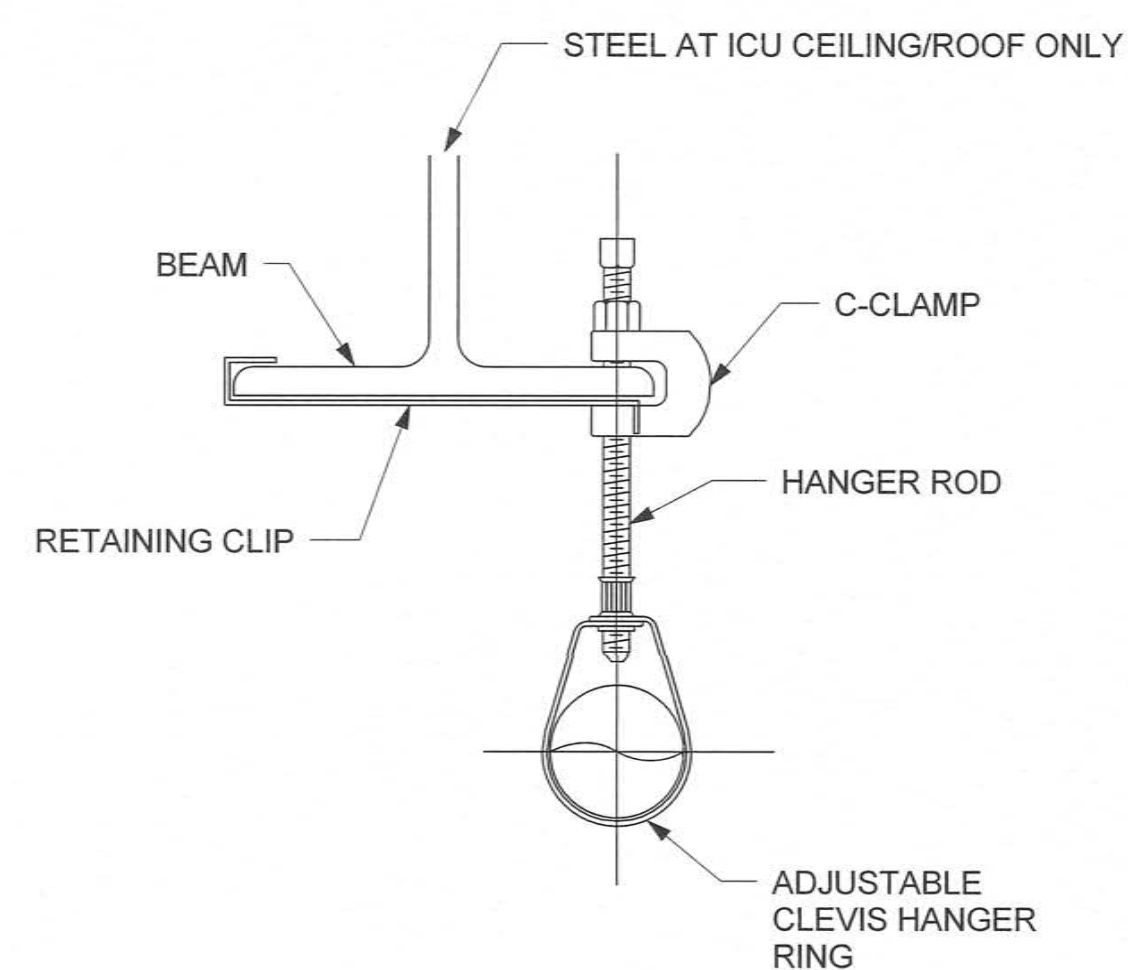

1 C-CLAMP PIPE HANGER DETAIL  
P-001 N.T.S.

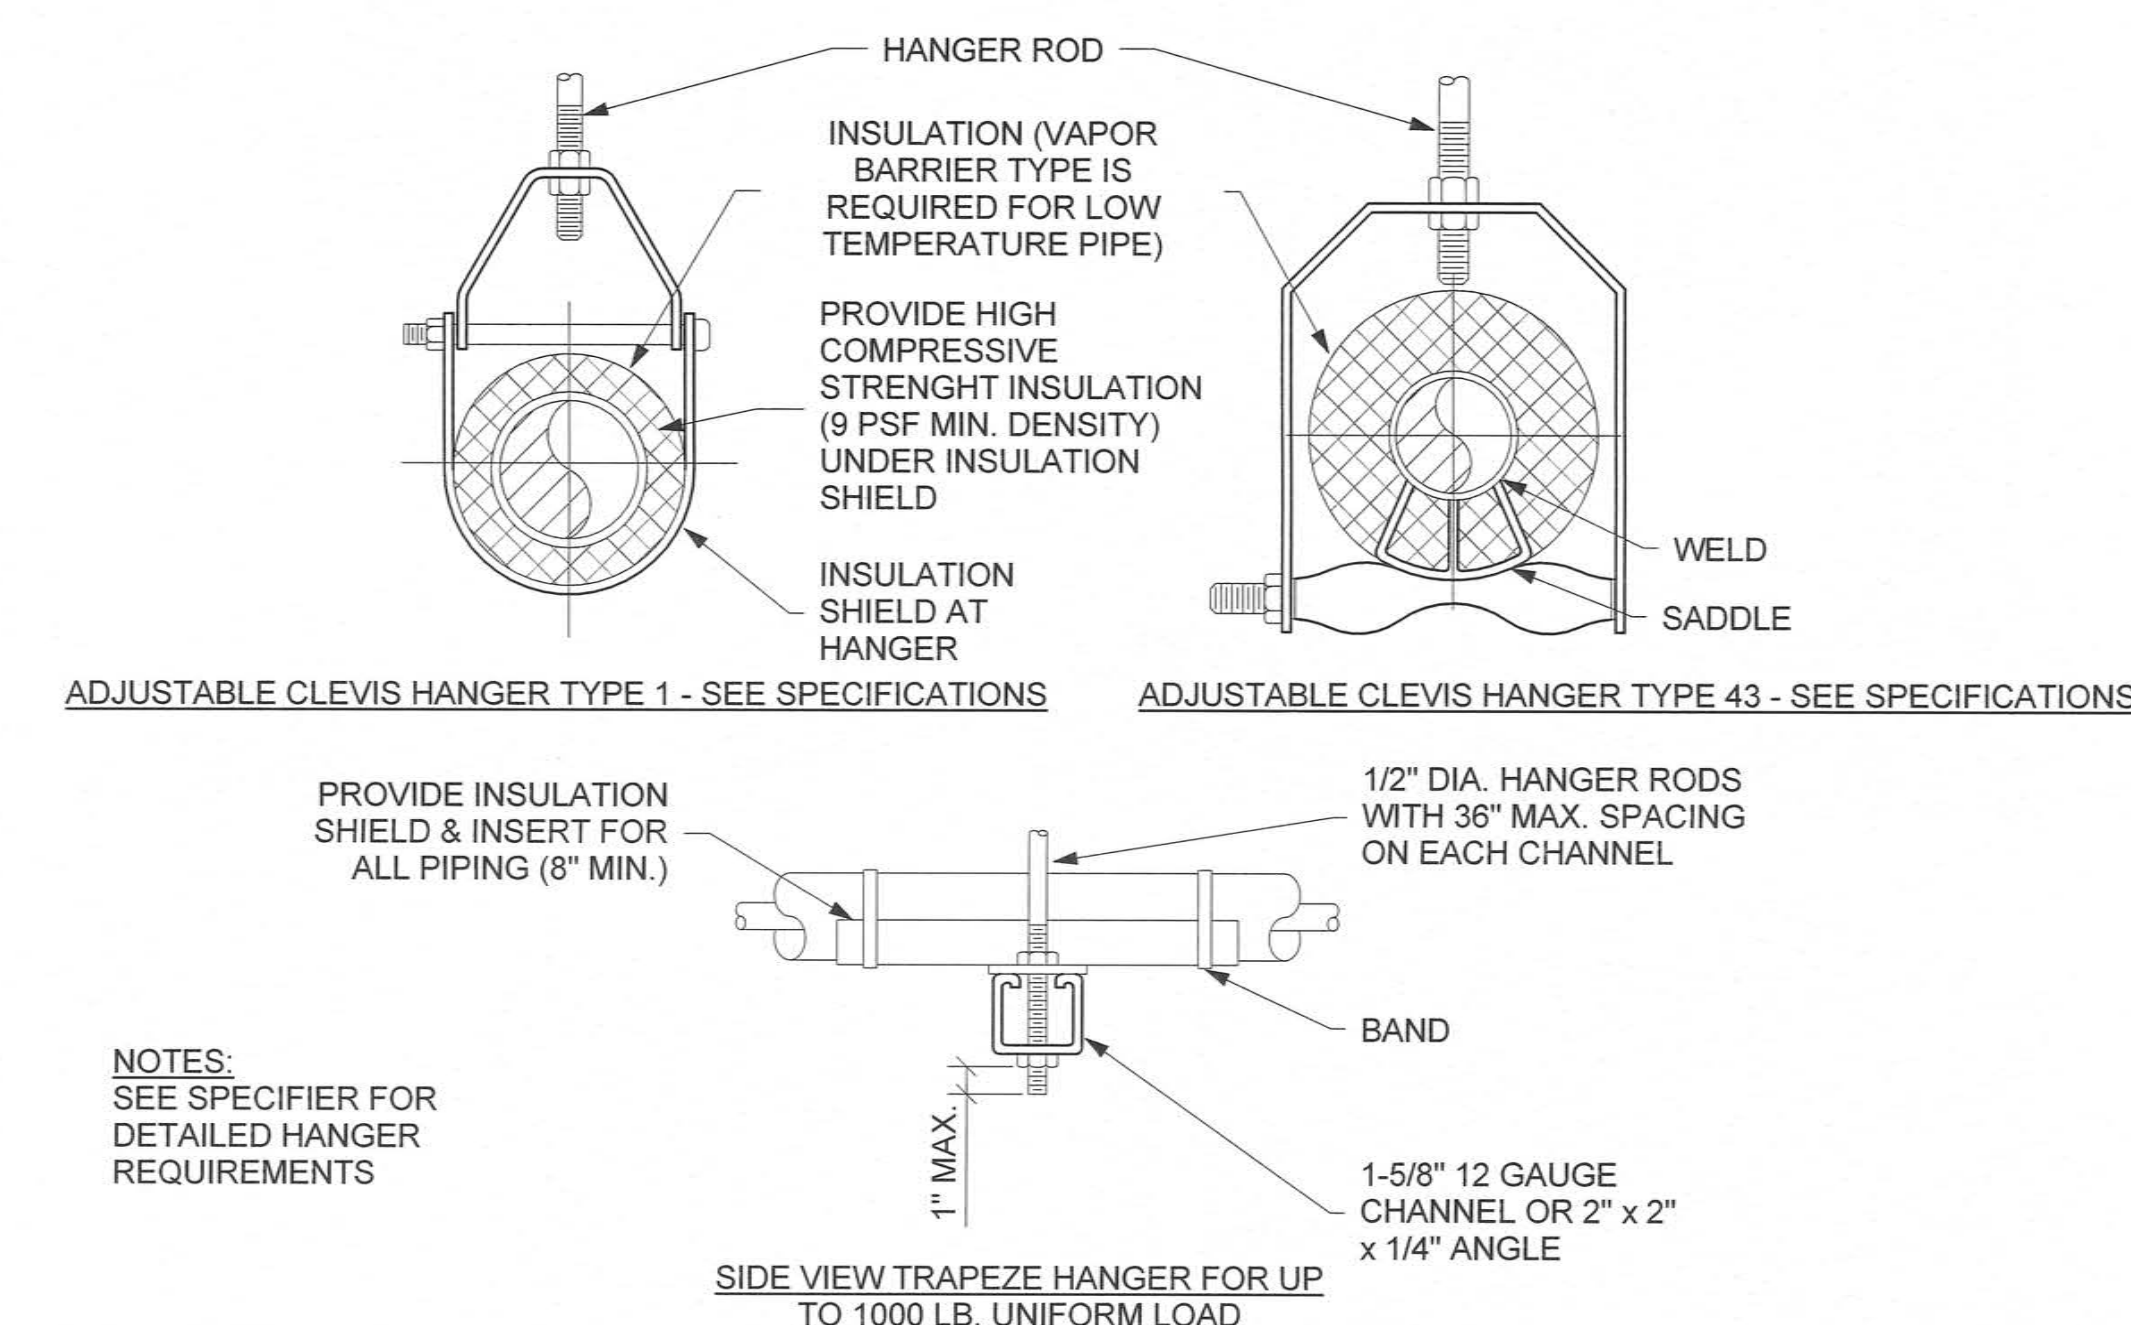

TO 1000 LB. UNIFORM LOAD																			
MAXIMUM PIPE/TUBING SUPPORT SPACING																			
NOM. SIZE (IN.)	THRU 3/4	1	1 1/4	1 1/2	2	2 1/2	3	4	5	6	8	10	12	14	16	18	20	24	
PIPE (FT.)	7	7	7	9	10	11	12	14	16	17	19	22	23	25	27	28	30	36	
TUBING (FT.)	5 FT	6	7	8	8	9	10	12	13	14	16	-	-	-	-	-	-	-	
NOTE: FOR TRAPEZE HANGER TAKE SPACING OF SMALLEST SIZE ON TRAPEZE																			

2 PLUMBING PIPE HANGER  
P-001 N.T.S.

		<b>CONSULTANTS:</b>				<b>PROJECT MANAGER:</b>		Project Number 2013121		Scale As indicated		Drawing Title <b>PLUMBING NOTES, ABBREVIATIONS, AND LEGEND</b>		Project Title <b>REPLACE AIR HANDLING UNITS 3, 14, &amp; 34</b>		VA Project Number <b>246-13-C-0106</b>		Office of Facilities Management			
						 <b>APOGEE</b> Consulting Group, PA www.acg-pa.com NC License # C-1848				Approved: Project Director		Location 2300 RAMSEY STREET, FAYETTEVILLE, NC 28301		Building Number <b>1 AND 3</b>		Drawing Number <b>P-001</b>					
Amended Per Owner's Comments No Rev Clouds		10/17/2014														Date 08/28/2014				Checked DJR	
Revisions		Date																Dwg. 2 of 18		 Department of Veterans Affairs	