



three inches = one foot
one and one-half inch = one foot
one inch = one foot
three-quarters inch = one foot
one-half inch = one foot
three-eighths inch = one foot
one-quarter inch = one foot
one-eighth inch = one foot

A
B
C
D
E
F

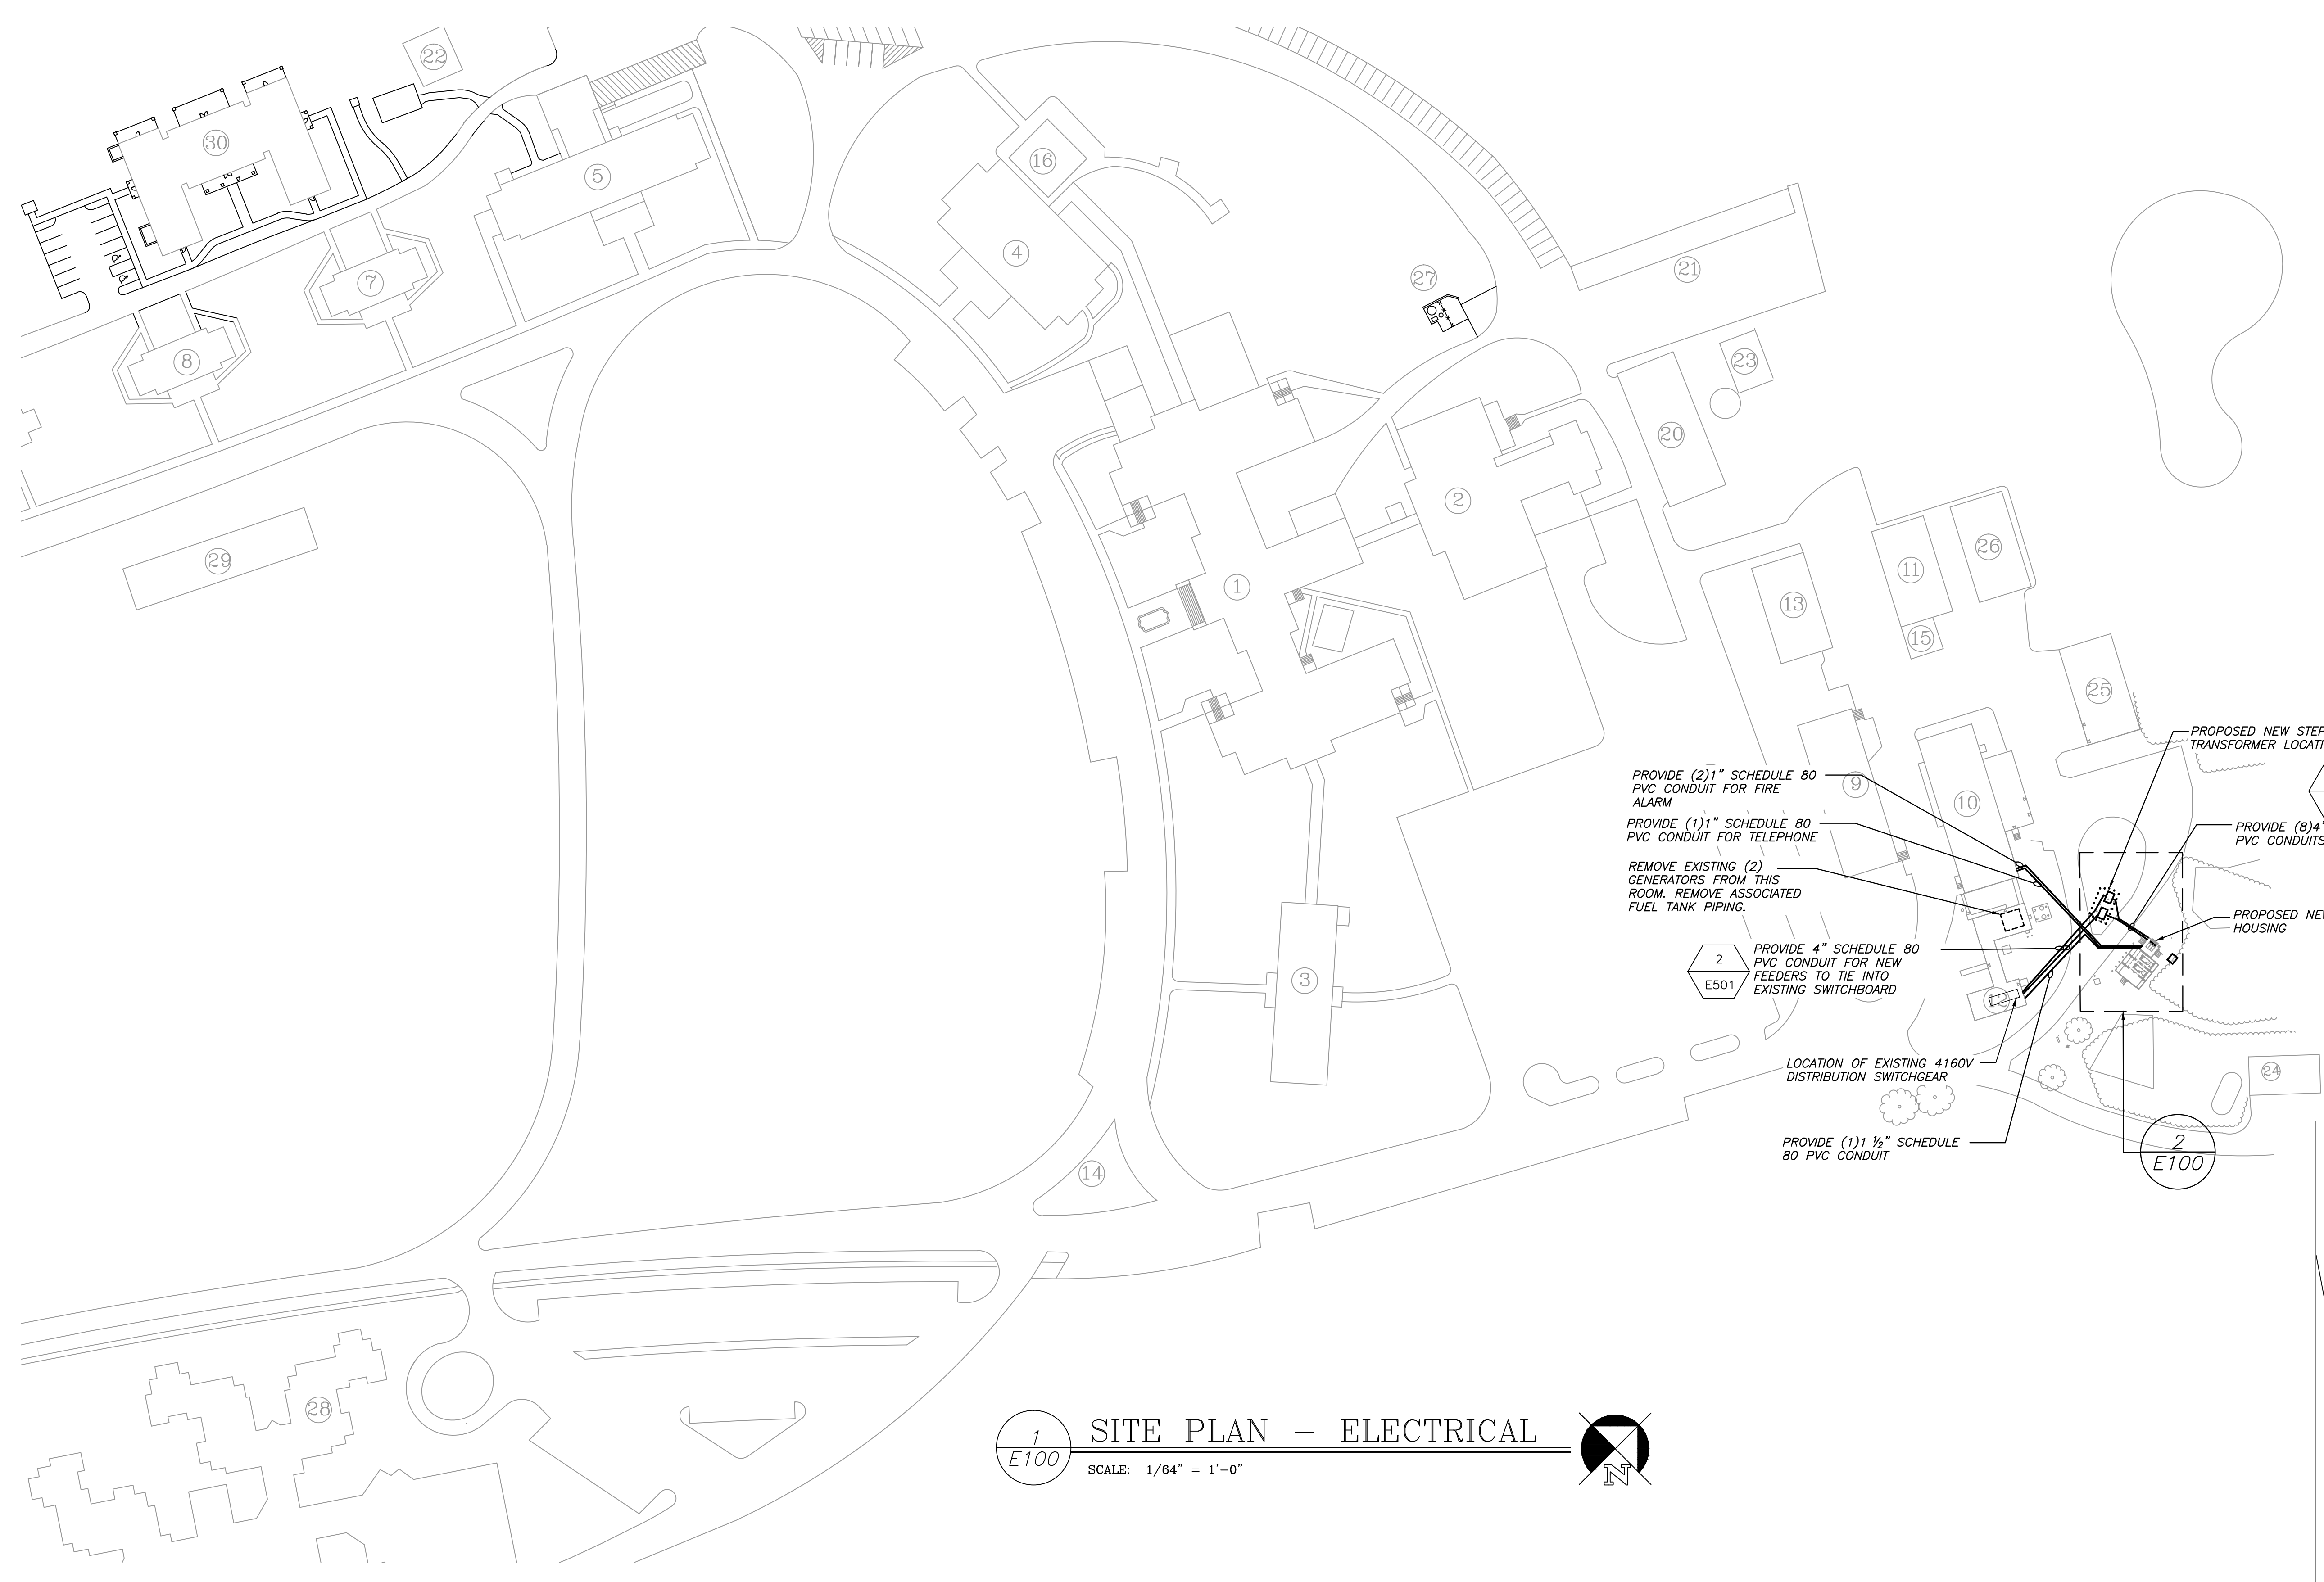

1
E100
SITE PLAN - ELECTRICAL
SCALE: 1/64" = 1'-0"

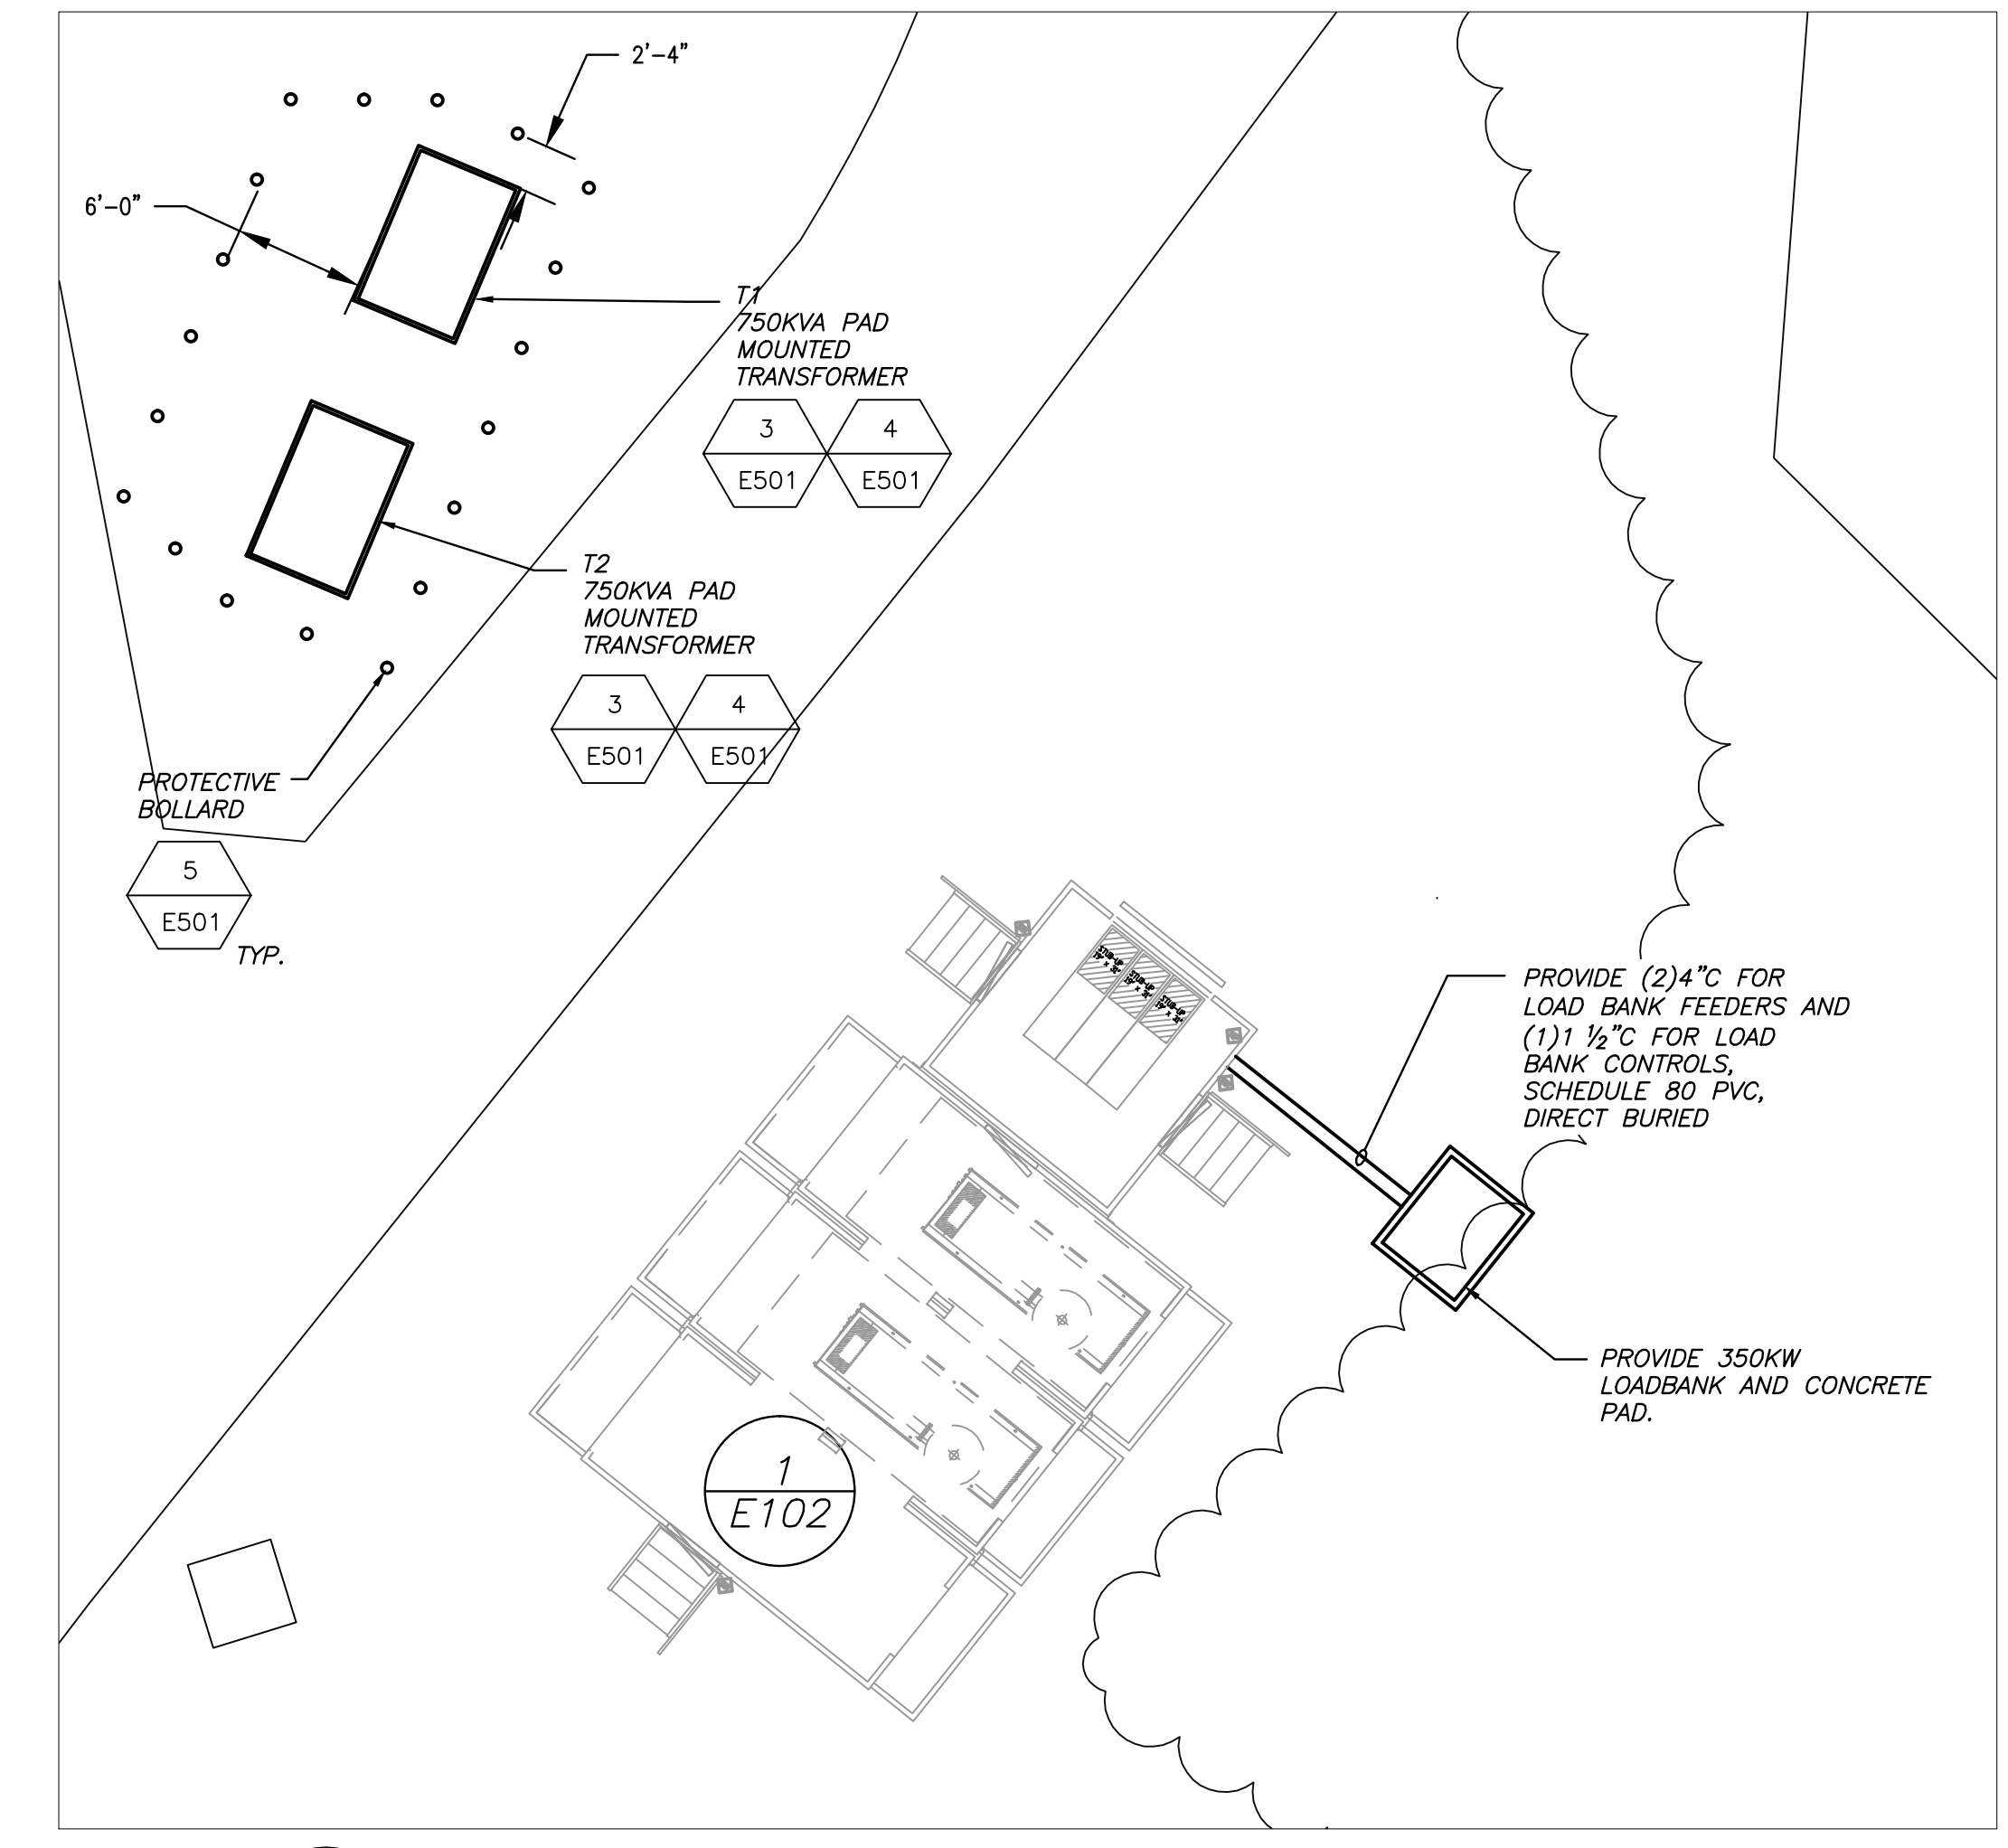

2
E100
PARTIAL SITE PLAN - ELECTRICAL
SCALE: 1/8" = 1'-0"

- GENERAL NOTES:**
- A. THE ELECTRICAL CONTRACTOR SHALL PROVIDE ALL ELECTRICAL CONDUIT, MANHOLES, CABLE, AND TERMINATIONS.
 - B. THE CONTRACTOR IS RESPONSIBLE FOR CONTACTING THE PROPER UTILITIES INCLUDING ALL UTILITIES PRIVATELY OWNED AND STAKING OUT ALL UTILITIES PRIOR TO BEGINNING ANY WORK. VERIFY ALL UTILITY LOCATIONS PRIOR TO TRENCHING TO AVOID DAMAGE TO EXISTING UTILITIES. SPRAY PAINT LOCATION OF UTILITIES ON ASPHALT AND CONCRETE AND PROVIDE STAKES ON GRASS OR DIRT SURFACES. REMOVE SPRAY PAINT FROM ASPHALT AND CONCRETE ONCE PROJECT IS COMPLETE.
 - C. HAND EXCAVATE WHERE NECESSARY TO AVOID CAUSING DAMAGE TO EXISTING UTILITIES AND SERVICES.
 - D. COORDINATE ALL CUTTING AND PATCHING OF SIDEWALKS AND DRIVEWAYS WITH GENERAL CONTRACTOR PRIOR TO BEGINNING CONSTRUCTION. E.G. IS TO REPAIR ALL EXISTING ASPHALT AND CONCRETE AS REQUIRED FOR INSTALLATION OF CONDUITS.
 - E. ALL EXCAVATION AND BACKFILL FOR THE ELECTRICAL SITE WORK IS BY THE ELECTRICAL CONTRACTOR. COORDINATE ALL WORK WITH THE SITE CONTRACTOR.
 - F. THE ELECTRICAL CONTRACTOR SHALL BE RESPONSIBLE FOR ALL TRAFFIC MAINTENANCE AND SAFETY. ASPHALT CUTTING, EXCAVATION, BACKFILL, AND CONCRETE WORK REQUIRED FOR THE INSTALLATION OF ELECTRICAL WORK. ALL REPAIR SHALL BE BY THE ELECTRICAL CONTRACTOR AFTER ALL ELECTRICAL WORK IS COMPLETE.
 - G. ROUTE ALL CONDUIT PENETRATIONS SHOWN UNDER BUILDING FOUNDATIONS TO EACH BUILDING'S MECHANICAL SPACE.
 - H. ALL WIRING SHALL CONFORM TO THE NATIONAL ELECTRIC CODE.
 - I. COORDINATE LOCATION OF NEW SITE LUMINAIRES WITH SITE/CIVIL DRAWINGS PRIOR TO ROUGH-IN.

<div>100% SUBMISSION</div> <div>Revisions</div>		<div>VA WESTERN NEW YORK HEALTHCARE SYSTEM 222 RICHMOND AVENUE BATAVIA, NEW YORK 14020</div>	<div>EC4B Engineering, P.C. 15 Schoen Place Suite 300 Batavia, NY 14034 Phone: (585) 641-7121 Fax: (585) 362-4175 www.ec4b.com</div>	<div>Consultant</div>	<div>stamp</div>	<div>Architect / Engineer</div>	<table><tr><td>CARDIOLOGY MANAGER</td><td>DATE</td><td>ENGINEERING MANAGER</td><td>DATE</td></tr><tr><td>INFECTION CONTROL</td><td>DATE</td><td>CARELINE MANAGER</td><td>DATE</td></tr><tr><td>SAFETY OFFICER</td><td>DATE</td><td>CHIEF OF STAFF</td><td>DATE</td></tr></table>	CARDIOLOGY MANAGER	DATE	ENGINEERING MANAGER	DATE	INFECTION CONTROL	DATE	CARELINE MANAGER	DATE	SAFETY OFFICER	DATE	CHIEF OF STAFF	DATE	<table><tr><td colspan="2">Drawing Title</td></tr><tr><td colspan="2">SITE PLAN ELECTRICAL</td></tr><tr><td colspan="2">MEDICAL CENTER DIRECTOR</td></tr><tr><td colspan="2">ASSOCIATE MEDICAL CENTER DIRECTOR</td></tr></table>	Drawing Title		SITE PLAN ELECTRICAL		MEDICAL CENTER DIRECTOR		ASSOCIATE MEDICAL CENTER DIRECTOR		<table><tr><td colspan="2">Project Title</td></tr><tr><td colspan="2">VA BATAVIA EMERGENCY POWER UPGRADES</td></tr><tr><td>Building Number 1</td><td>Checked EJS</td></tr><tr><td colspan="2">Location V.A.M.C. BATAVIA, NEW YORK</td></tr></table>	Project Title		VA BATAVIA EMERGENCY POWER UPGRADES		Building Number 1	Checked EJS	Location V.A.M.C. BATAVIA, NEW YORK		<table><tr><td>Date June 6, 2014</td></tr><tr><td>Station No. 528-13-201</td></tr><tr><td>13-201-E100</td></tr></table>	Date June 6, 2014	Station No. 528-13-201	13-201-E100	<div>Office of Facilities</div> <div>Department of Veterans Affairs</div>
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