


1. ANCHOR PIPES TO STRUCTURE. SEE DETAIL.
2. PIPE EXPANSION LOOPS. SEE DETAIL.
3. TEMPORARY HOT DUCT REHEAT COIL.
4. BALL VALVE (FULL SIZE) AND CAP, FOR PHASE 4 EXTENSION. TYPICAL.
5. FULL SIZE BALL VALVES
6. CONTROL VALVE SHALL BE 3-WAY MODULATING TYPE.
7. REFRIGERANT PIPING, SIZE AND INSTALL PER MANUFACTURER'S RECOMMENDATIONS.
8. 1 1/2" GH AND 1 1/2" GHR.
9. EXISTING 2" CH(OR) & 2" CHR(OR). LOCATION INDICATED IS APPROXIMATE, BECAUSE THESE WERE NOT YET INSTALLED WHEN THESE DOCUMENTS WERE COMPLETED. VERIFY ACTUAL LOCATION. RELOCATE AS REQUIRED TO COORDINATE WITH NEW WORK.
10. VALVE AND CAP FOR FUTURE EXTENSION. TYPICAL.
11. DRIP LEG AND TRAP ASSEMBLY. SEE DETAIL.
12. DO NOT INSTALL ANYTHING NEW (DUCTS, FITTINGS, TERMINAL UNITS ETC.) IN THE INDICATED SHADED ZONE (3' WIDE X 6' HIGH). THIS ZONE MUST STAY CLEAR FOR PERSONNEL ACCESS AND EXITING. ALL NEW ITEMS THAT MUST CROSS THIS ZONE ARE TO BE COMESET UP AND OVER THIS ZONE. EXISTING ITEMS (DUCTS, TERMINAL UNITS, ETC.) CAN STAY WITHIN THE AREA. IT IS NOT PART OF THE SCOPE OF WORK IN THIS CONTRACT TO RELOCATE THOSE EXISTING ITEMS OUT OF THIS ZONE UNLESS NOTED OTHERWISE.


COMPLETION ITEM NO. _____
FULLY SPRINKLERED

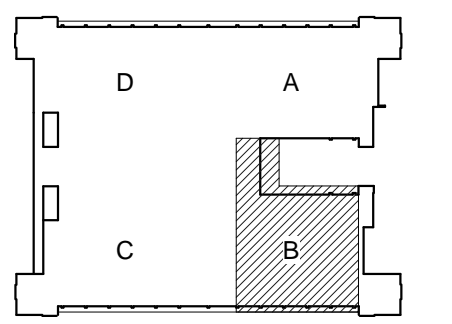

**Office of
Construction
and Facilities
Management**




Department of
Veterans Affairs

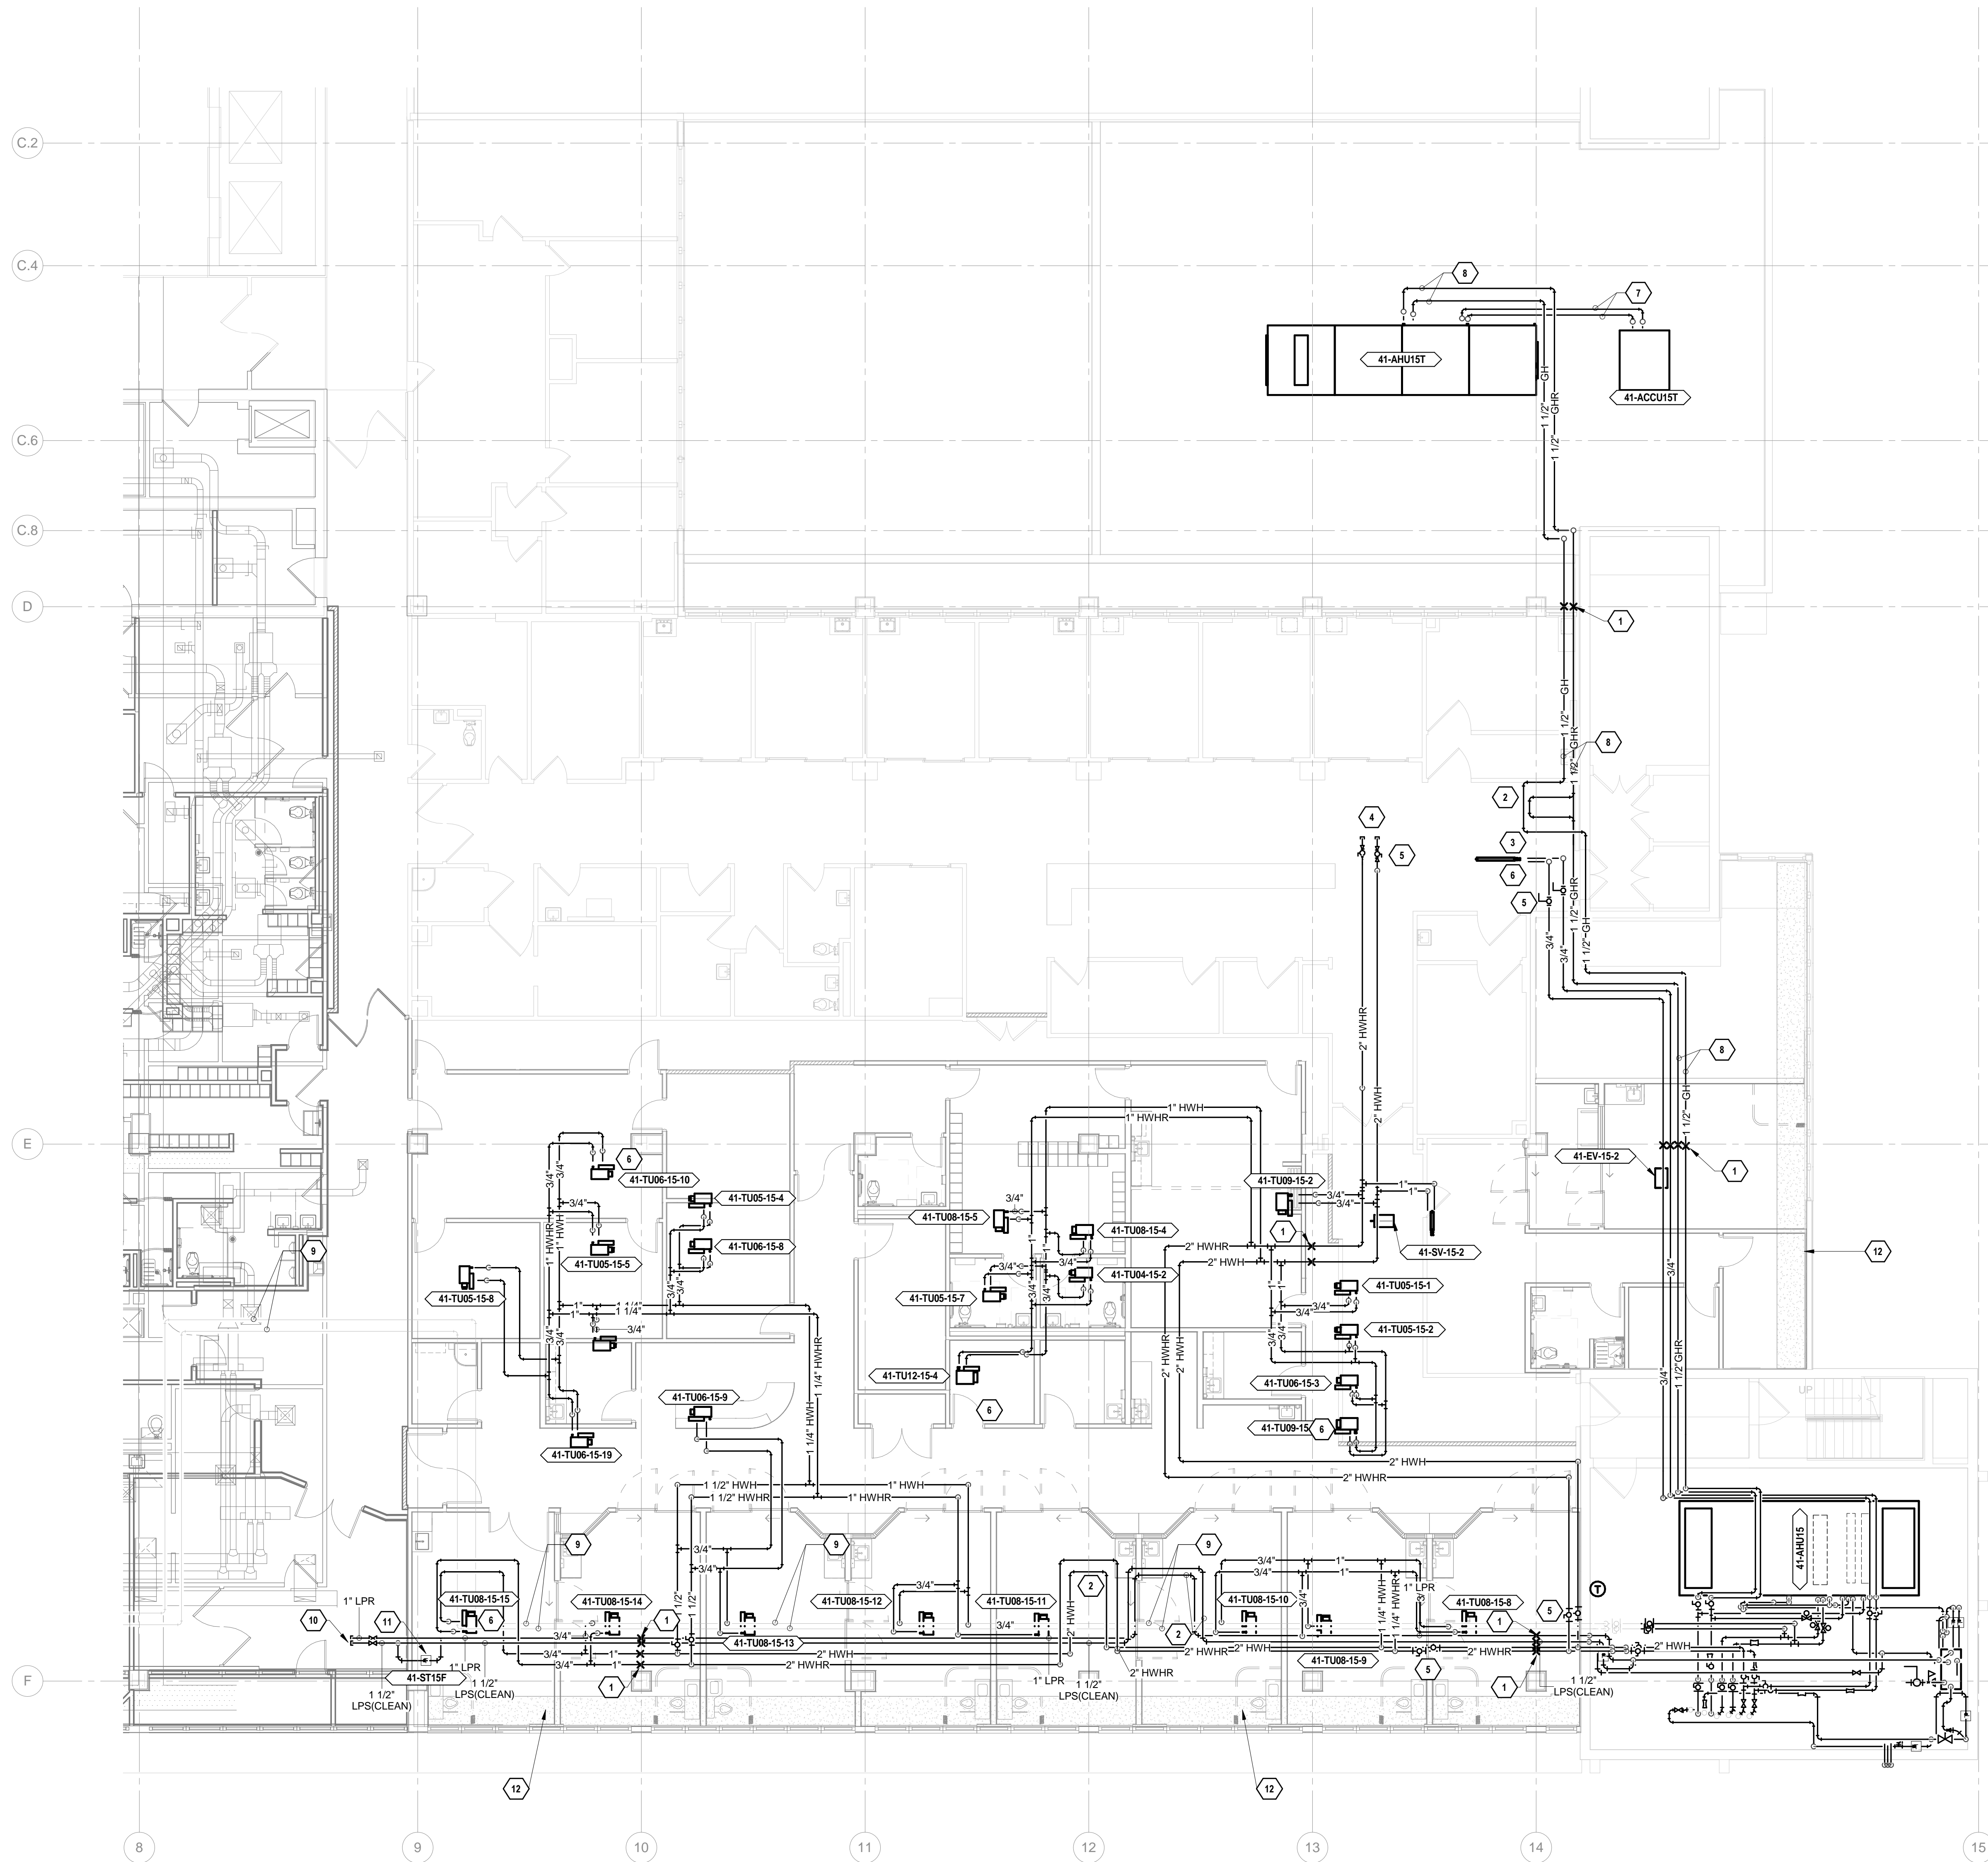

A1 MECHANICAL PIPING PLAN - 3RD FLOOR - QUAD B - ICU - PHASE 3
1/8" = 1'-0"

1	ADDENDUM #001	07-15-2014
#	Revisions	Date

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	Drawing Title
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MECHANICAL PIPING - QUAD B - ICU PHASE 3 FLOOR PLAN

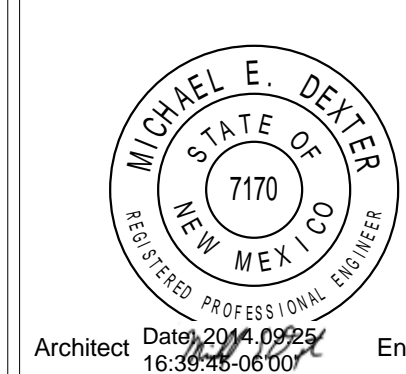Approved: Project Director

Project Title

MICU-SICU CONSOLIDATION & PACU
BUILDING 41

Location

NMVAHCS RAYMOND G

Date
SEPTEMBER 26, 2014

Checked
ROS

Drawn
ACB

Project Number
501-324

Building Number
BUILDING 41

Drawing Number

MP103

Dwg. Of

Dwg. Of