


three inches = one foot  
 one and one half inches = one foot  
 one inch = one foot  
 one quarter inch = one foot  
 three quarters inch = one foot  
 one half inch = one foot  
 three eighths inch = one foot  
 one eighth inch = one foot  
 one quarter inch = one foot  
 one eighth inch = one foot  
 one eighth inch = one foot

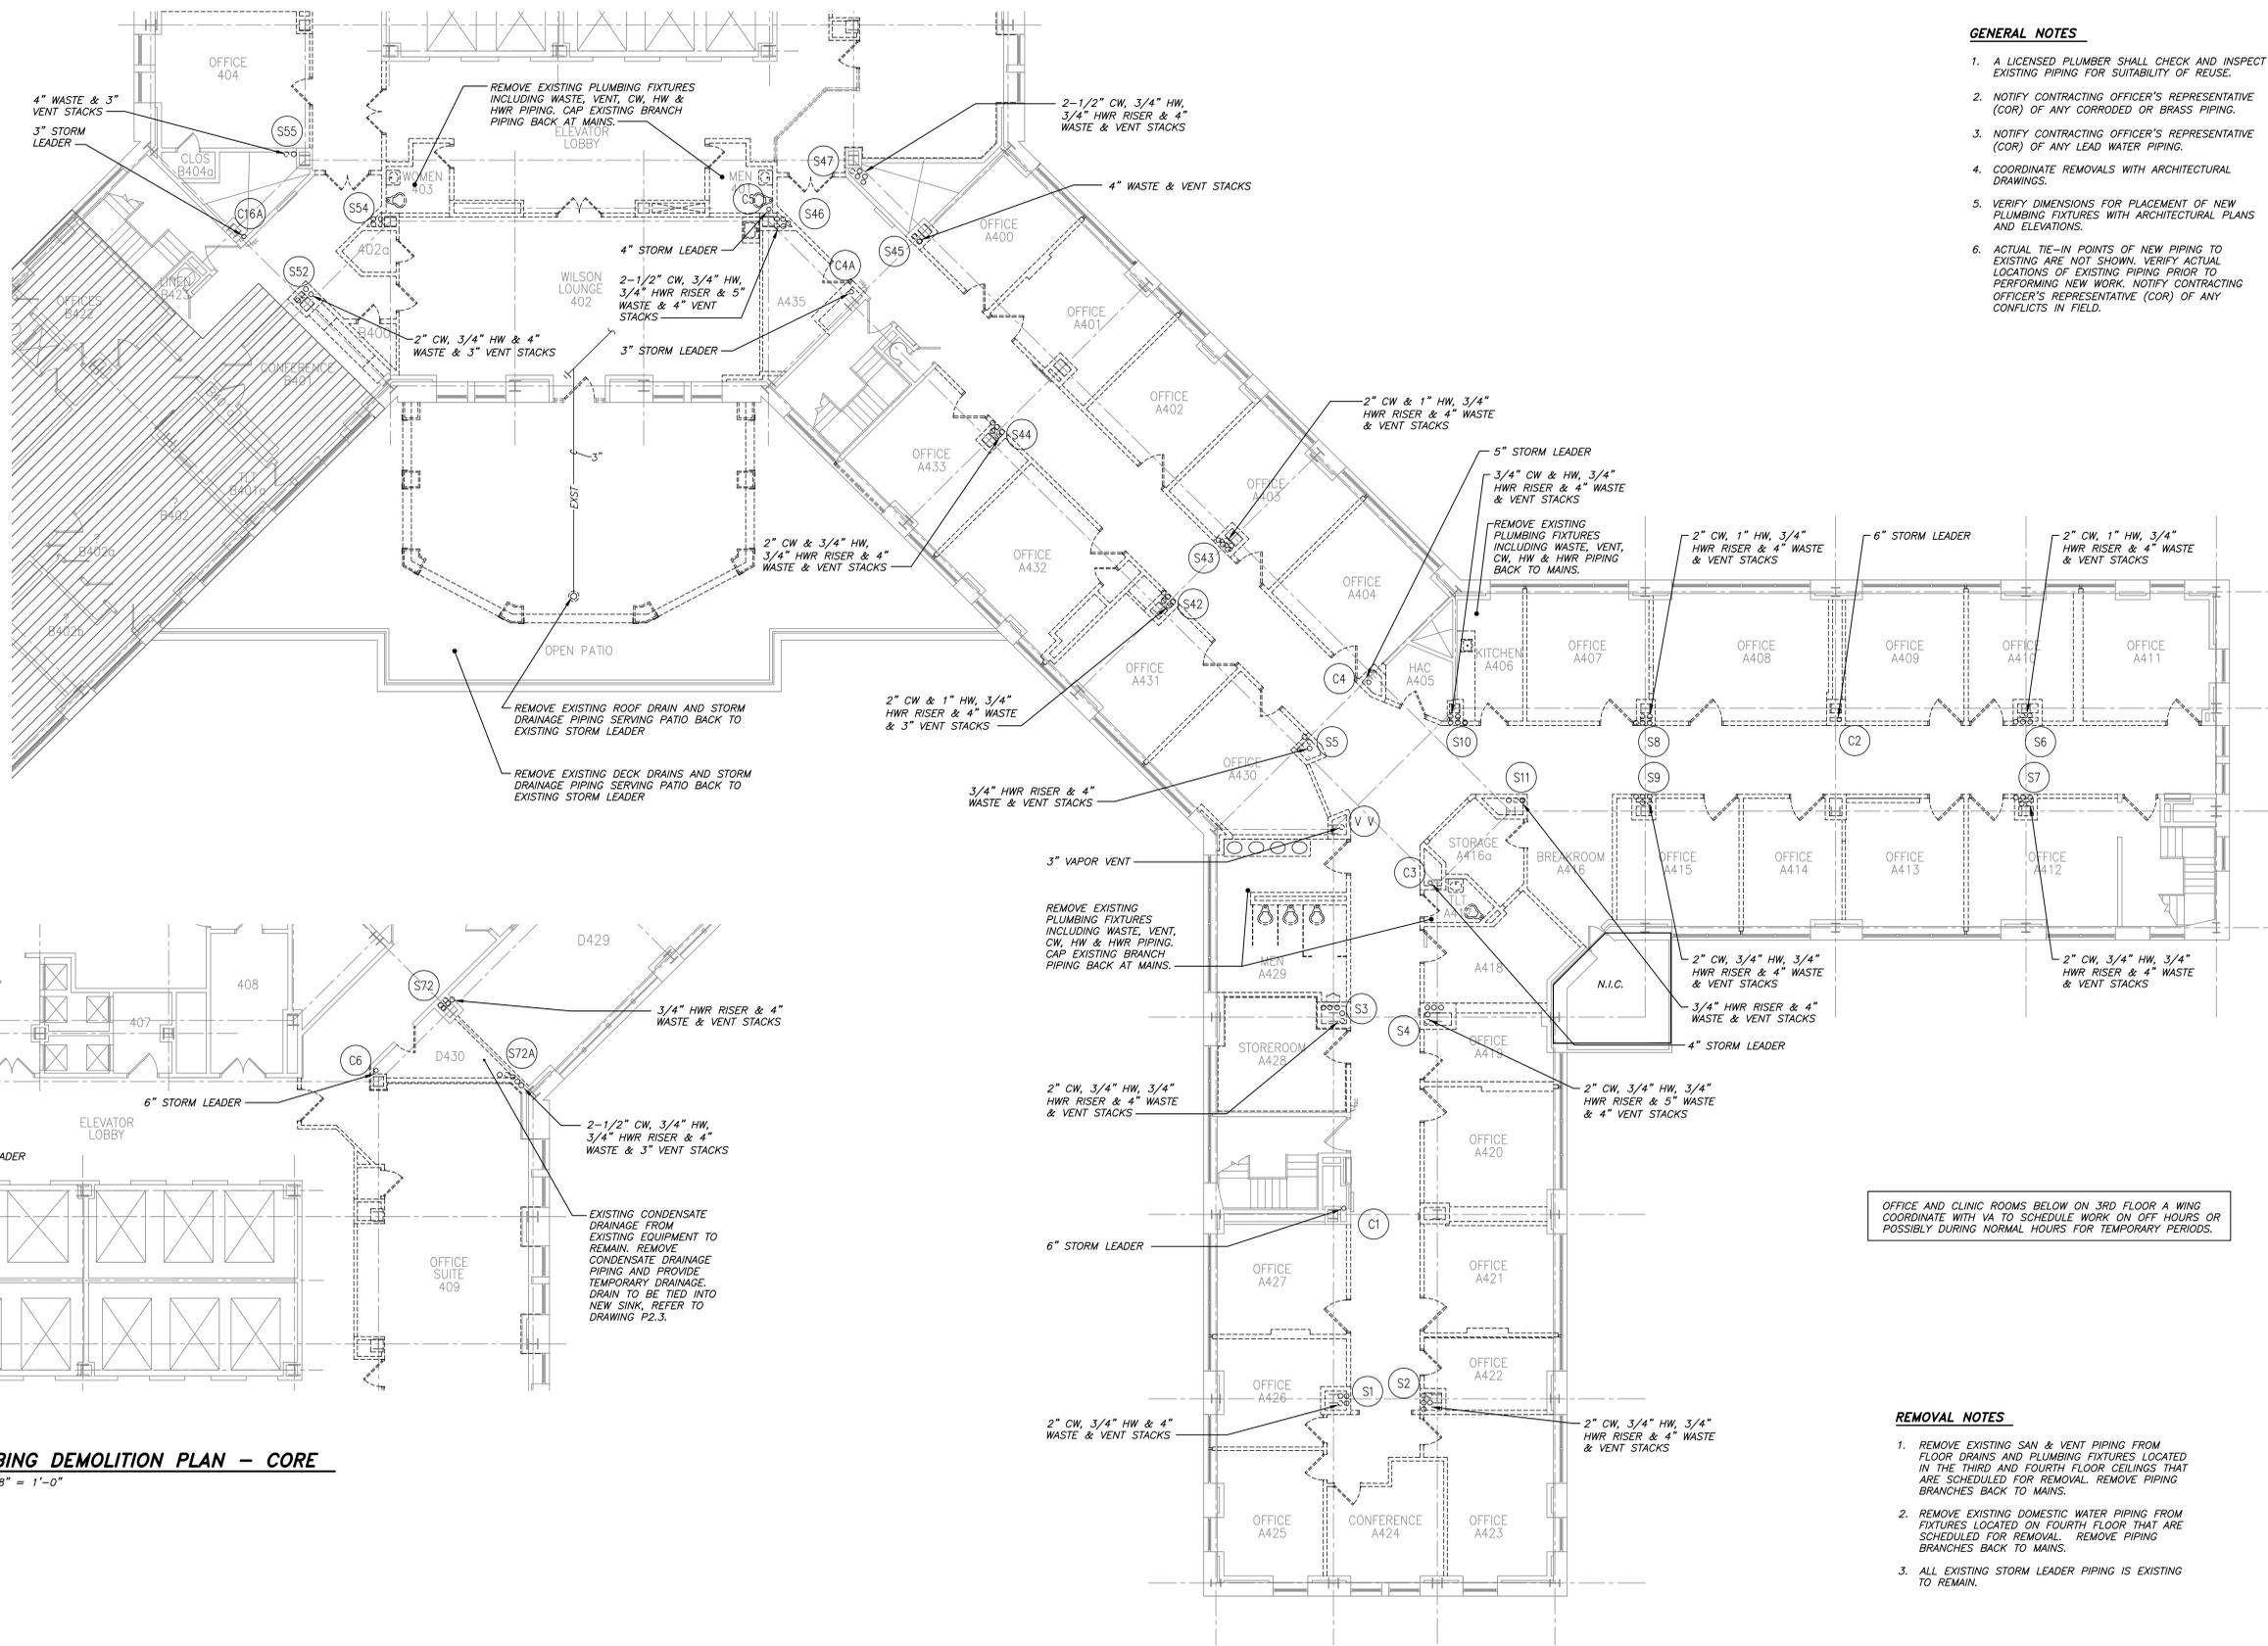

- GENERAL NOTES**
1. A LICENSED PLUMBER SHALL CHECK AND INSPECT EXISTING PIPING FOR SUITABILITY OF REUSE.
  2. NOTIFY CONTRACTING OFFICER'S REPRESENTATIVE (COR) OF ANY CORRODED OR BRASS PIPING.
  3. NOTIFY CONTRACTING OFFICER'S REPRESENTATIVE (COR) OF ANY LEAD WATER PIPING.
  4. COORDINATE REMOVALS WITH ARCHITECTURAL DRAWINGS.
  5. VERIFY DIMENSIONS FOR PLACEMENT OF NEW PLUMBING FIXTURES WITH ARCHITECTURAL PLANS AND ELEVATIONS.
  6. ACTUAL TIE-IN POINTS OF NEW PIPING TO EXISTING ARE NOT SHOWN. VERIFY ACTUAL LOCATIONS OF EXISTING PIPING PRIOR TO PERFORMING NEW WORK. NOTIFY CONTRACTING OFFICER'S REPRESENTATIVE (COR) OF ANY CONFLICTS IN FIELD.

**2 PLUMBING DEMOLITION PLAN - CORE**  
 P1.1 SCALE: 1/8" = 1'-0"

**1 PLUMBING DEMOLITION PLAN - WING 4A & CORE**  
 P1.1 SCALE: 1/8" = 1'-0"

OFFICE AND CLINIC ROOMS BELOW ON 3RD FLOOR A WING COORDINATE WITH VA TO SCHEDULE WORK ON OFF HOURS OR POSSIBLY DURING NORMAL HOURS FOR TEMPORARY PERIODS.

- REMOVAL NOTES**
1. REMOVE EXISTING SAN & VENT PIPING FROM FLOOR DRAINS AND PLUMBING FIXTURES LOCATED IN THE THIRD AND FOURTH FLOOR CEILINGS THAT ARE SCHEDULED FOR REMOVAL. REMOVE PIPING BRANCHES BACK TO MAINS.
  2. REMOVE EXISTING DOMESTIC WATER PIPING FROM FIXTURES LOCATED ON FOURTH FLOOR THAT ARE SCHEDULED FOR REMOVAL. REMOVE PIPING BRANCHES BACK TO MAINS.
  3. ALL EXISTING STORM LEADER PIPING IS EXISTING TO REMAIN.

FINAL DESIGN (100%)

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<p><b>Adelaide</b>                  Environmental Health Associates, Inc.</p>		<p><b>Professional Engineer Seal</b></p>		<p>Approved Project Director  <i>[Signature]</i></p>		<p>Location  <b>Albany, New York</b></p>		<p>Drawing Number  <b>P1.1</b></p>		<p>Date  <b>10-22-2014</b></p>		<p>Checked                  Drawn</p>	
<p>Revisions</p>		<p>1511 Route 22 - Suite C-24                  Brewster, New York 10509                  p: 845.278.7710 f: 845.278.7750                  adelaidelc.com</p>		<p>Professional Engineer Seal</p>		<p>Project Number  <b>VA 528A8-12-801</b></p>		<p>Building Number  <b>1</b></p>		<p>Drawing Number  <b>P1.1</b></p>		<p>Dwg 71 of 117</p>	