
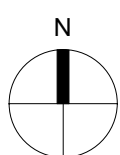


GENERAL NOTES:

1. REFER TO SHEET M-000 FOR GENERAL NOTES.

KEYED NOTES: #

- 1 REMOVE EXISTING HOT WATER RADIATORS AND ALL ASSOCIATED HANGERS, SUPPORTS, AND RELOCATE AS SHOWN ON MP-101. EXTEND EXISTING BRANCH PIPING TO NEW LOCATION. EXISTING PIPING ACCESSORIES AND CONTROL VALVE TO REMAIN.
- 2 REMOVE EXISTING INTAKE LOUVER IN EXISTING EXTERIOR WALL BELOW WINDOWS. REFER TO ARCHITECTURAL DRAWINGS FOR WALL PATCHING DETAILS.
- 3 REMOVE EXISTING HOT WATER RADIATOR AND ALL ASSOCIATED CONTROLS, HANGERS, SUPPORTS, AND CAP PIPING AT MAINS. TURN UNIT OVER TO OWNER.
- 4 REMOVE EXISTING DUCTWORK TO POINT SHOWN INCLUDING ALL HANGERS AND SUPPORTS.
- 5 CAP EXISTING DUCTWORK AIRTIGHT WITH SHEETMETAL.
- 6 REMOVE EXISTING GRILLE AND RELOCATE TO AREA SHOWN ON SHEET MH-101.

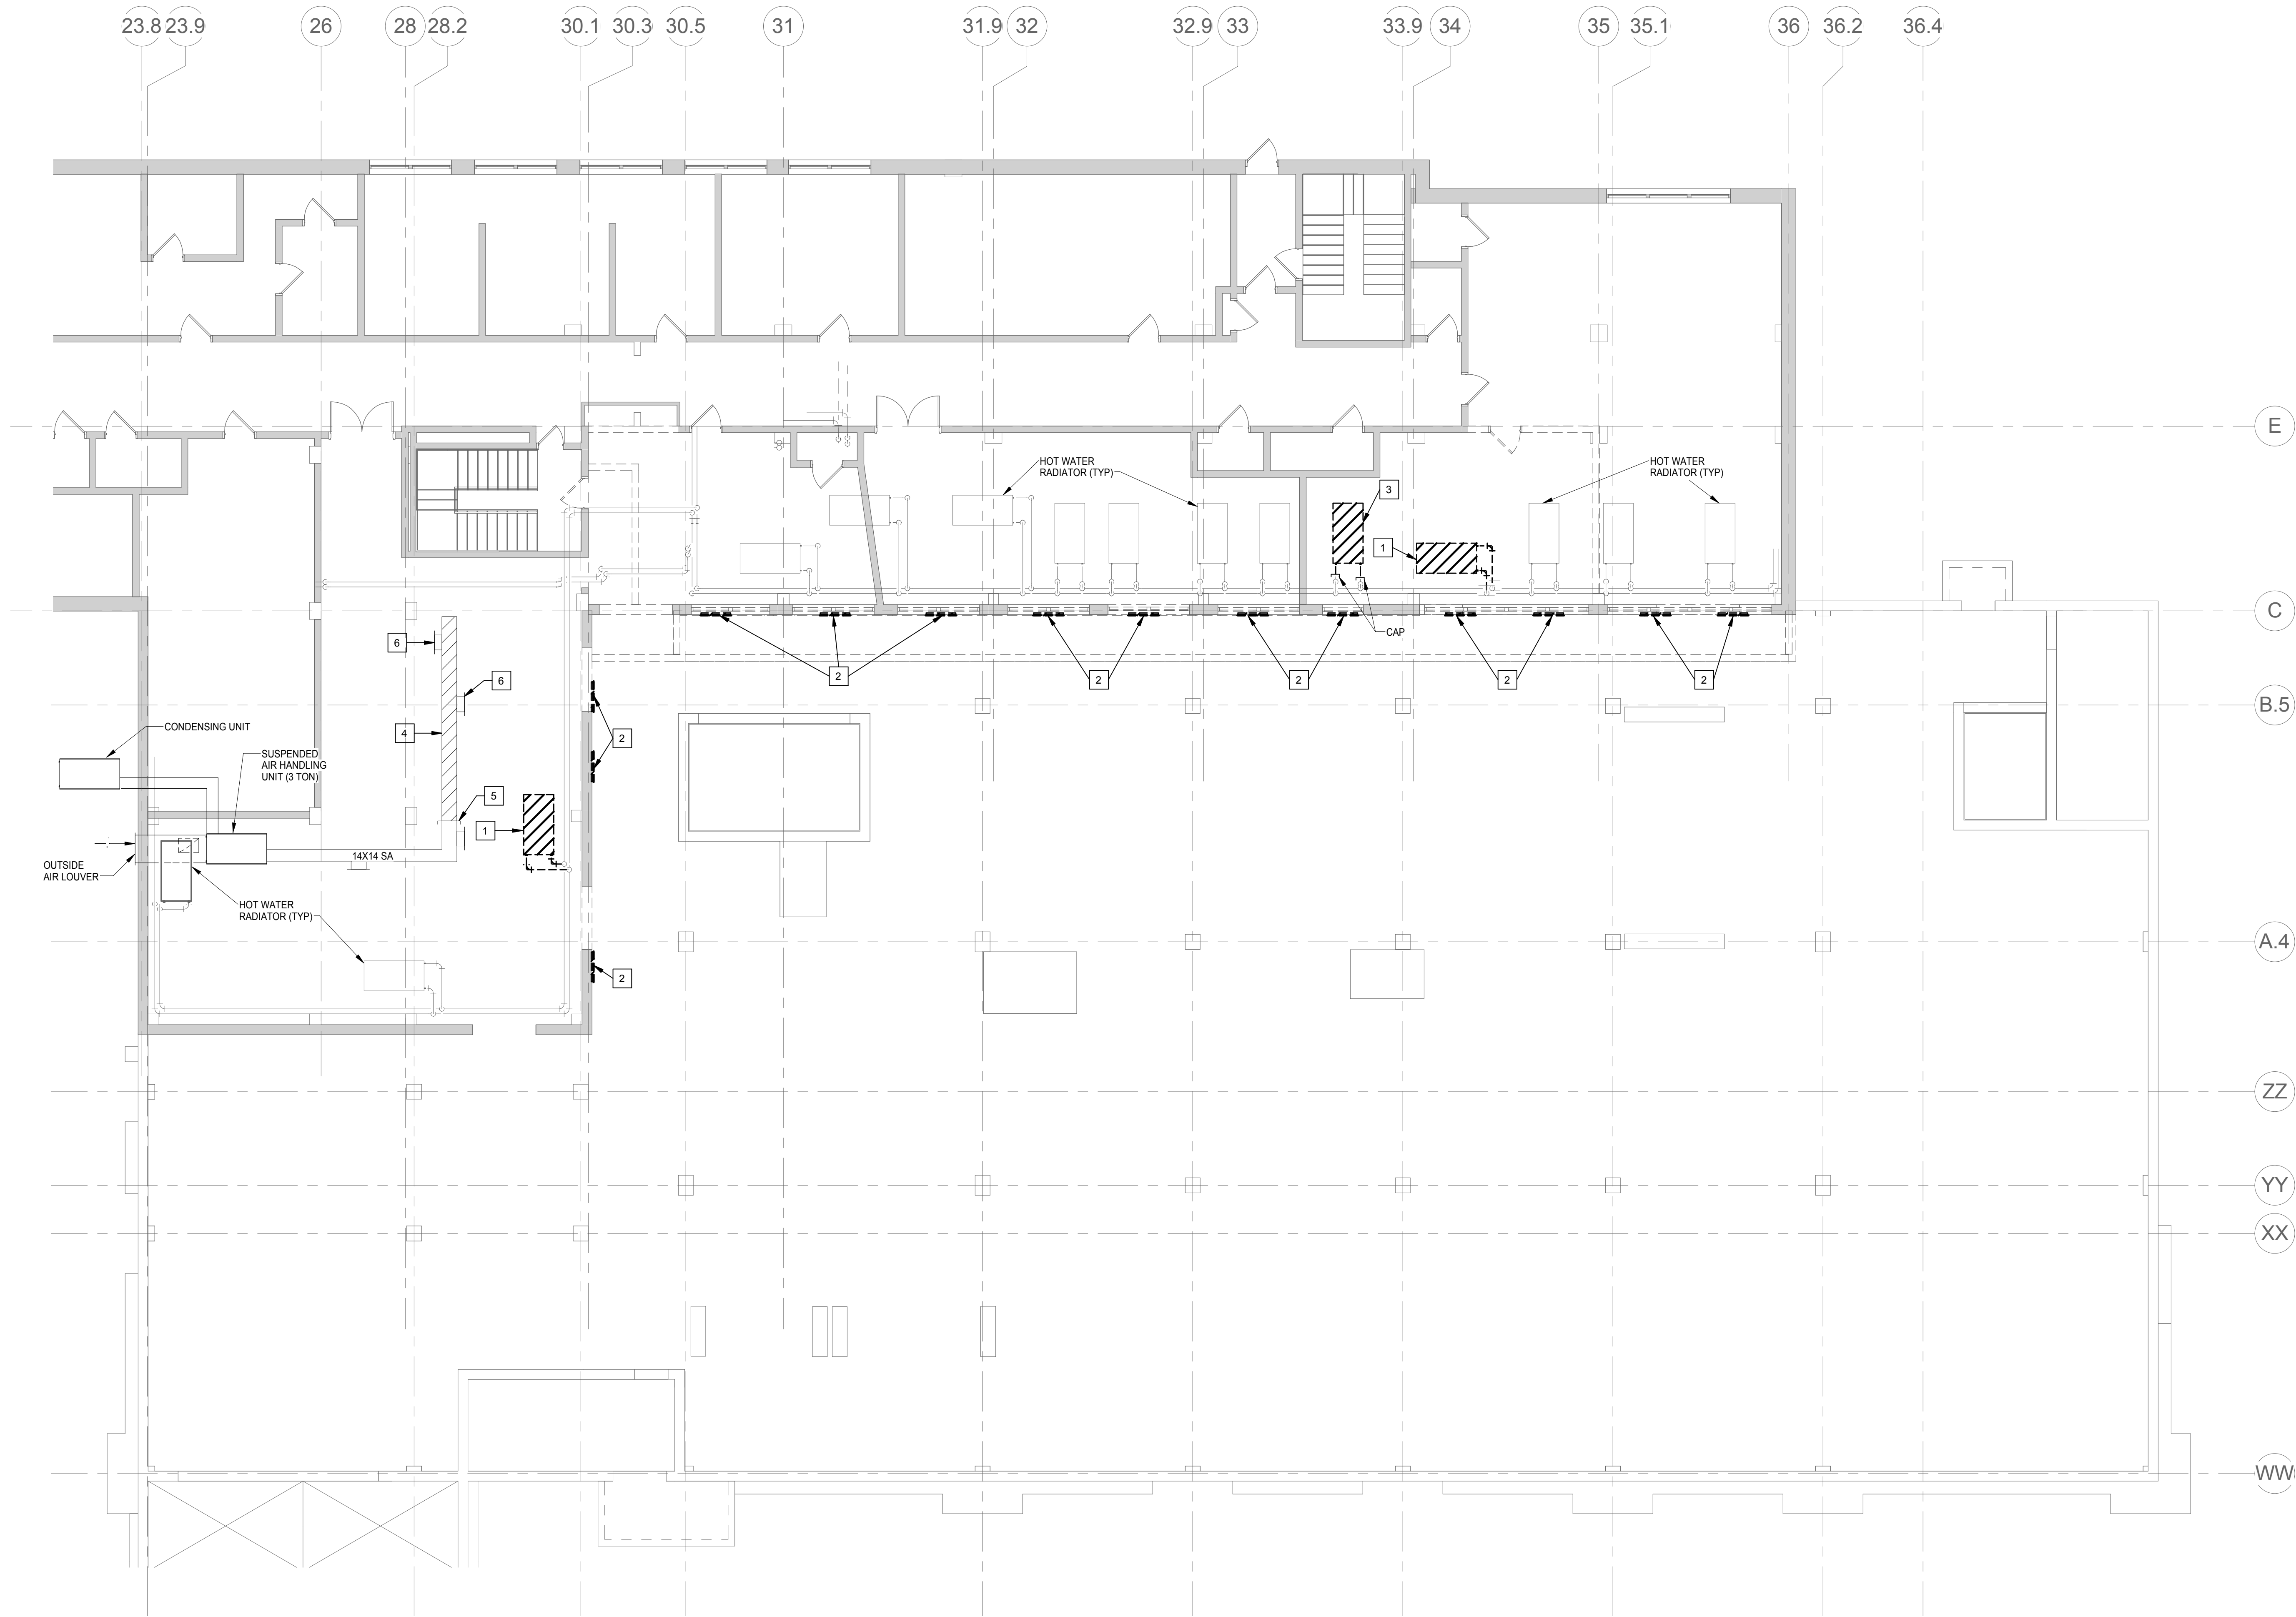

BASEMENT LEVEL DEMOLITION PLAN


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Revisions:	
Amendment 04	06-10-2015
Date	



SPS BASEMENT  
ADDITION

2121 LAKE AVE., FORT  
WAYNE, IN 46805

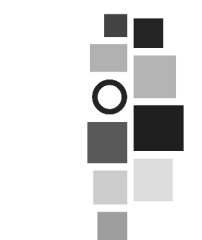

7260 SHADELAND STATION  
INDIANAPOLIS, IN 46256-3957  
TEL 317.547.5500 FAX 317.543.0270  
www.structurepoint.com

Ross & Baruzzini

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Suite 285  
Indianapolis, IN 46240  
317.638.8383

CONSULTANTS:

Drawing Title  
BASEMENT LEVEL DEMOLITION  
PLAN

Approved: Project Director

Project Title  
SPS BASEMENT ADDITION

Location  
2121 LAKE AVE., FORT WAYNE, IN 46805

Date  
08/15/2014

Checked  
SWD

Drawn  
RAC

Project Number  
2010.00629

Building Number  
01

Drawing Number  
MD-101

Office of  
Construction  
and Facilities  
Management


VA Department of  
Veterans Affairs

GENERAL NOTES:

1. REFER TO SHEET M000 FOR GENERAL NOTES.
2. REFER TO PIPING PLAN FOR LOCATION OF TEMPERATURE SENSORS AND OTHER ROOM SENSORS.
3. REFER TO AIR TERMINAL UNIT SCHEDULE ON SHEET MH-611 FOR AIR INLET SIZE TO AIR TERMINAL UNITS.

KEYED NOTES: #

1. ALL CART WASH EXHAUST DUCTWORK SHALL BE CONSTRUCTED OF WELDED STAINLESS STEEL.
2. CONNECT 12" Ø EXHAUST DUCT TO CART WASH. TRANSITION TO OUTLET SIZE OF CART WASH. BALANCE FOR 500 CFM.
3. INSTALL TRANSFER GRILLES ON EACH SIDE OF WALL ABOVE STERILIZERS. BOTTOM OF GRILLE 8'-0" AFF. VERIFY LOCATION WITH STERILIZER WALL OPENING.
4. PROVIDE CONCEALED REGULATOR FOR MANUAL VOLUME DAMPERS LOCATED ABOVE GYPSUM BOARD CEILING.
5. ROUTE BRANCH DUCTWORK INTO ROOM ABOVE DOOR. NOT THRU MASONRY/CONCRETE WALL. SLOPE DOWN IN SOFFIT TO ENTER ROOM.
6. CAP DUCTWORK WHERE SHOWN IF ALTERNATE DUCT #01 IS ACCEPTED.
7. 36" X 24" EXHAUST DUCT UP THRU ROOF TO EXHAUST FAN EF-1. REFER TO SHEET MH-102 FOR CONTINUATION.
8. 12" Ø EXHAUST DUCT UP THRU ROOF. REFER TO SHEET MH-102 FOR CONTINUATION.
9. 20" X 20" INTAKE DUCT UP THRU ROOF TO GRAVITY INTAKE HOOD GH-1. TERMINATE 12" BELOW STRUCTURE IN CHILLER ROOM WITH MOTORIZED DAMPER. REFER TO SHEET MH-102 FOR CONTINUATION.
10. 16" X 16" EXHAUST DUCT UP THRU ROOF TO EXHAUST FAN EF-2. TERMINATE 12" BELOW STRUCTURE IN CHILLER ROOM WITH MOTORIZED DAMPER. REFER TO SHEET MH-102 FOR CONTINUATION.
11. 40" X 24" SUPPLY DUCT UP THRU ROOF TO AHU-1. REFER TO SHEET MH-102 FOR CONTINUATION.
12. DELETE AIR TERMINAL UNIT, DUCTWORK, AND AIR DEVICES IF ALTERNATE DUCT #01 IS ACCEPTED.
13. DELETE DUCTWORK IF ALTERNATE DUCT #03 IS ACCEPTED.
14. RELOCATED EXISTING SUPPLY GRILLE. CONNECT TO EXISTING SUPPLY MAIN.
15. OPEN END SUPPLY DUCT IF ALTERNATE DUCT #01 IS ACCEPTED. BALANCE FOR CFM NOTED ON PLAN.
16. OPEN END RETURN DUCT IF ALTERNATE DUCT #01 IS ACCEPTED. BALANCE FOR CFM NOTED ON PLAN.
17. OPEN END EXHAUST DUCT IF ALTERNATE DUCT #01 IS ACCEPTED. BALANCE FOR CFM NOTED ON PLAN.
18. OFFSET BRANCH DUCTWORK OVER TOP OF STORM PIPING. SEE PLUMBING DRAWINGS.

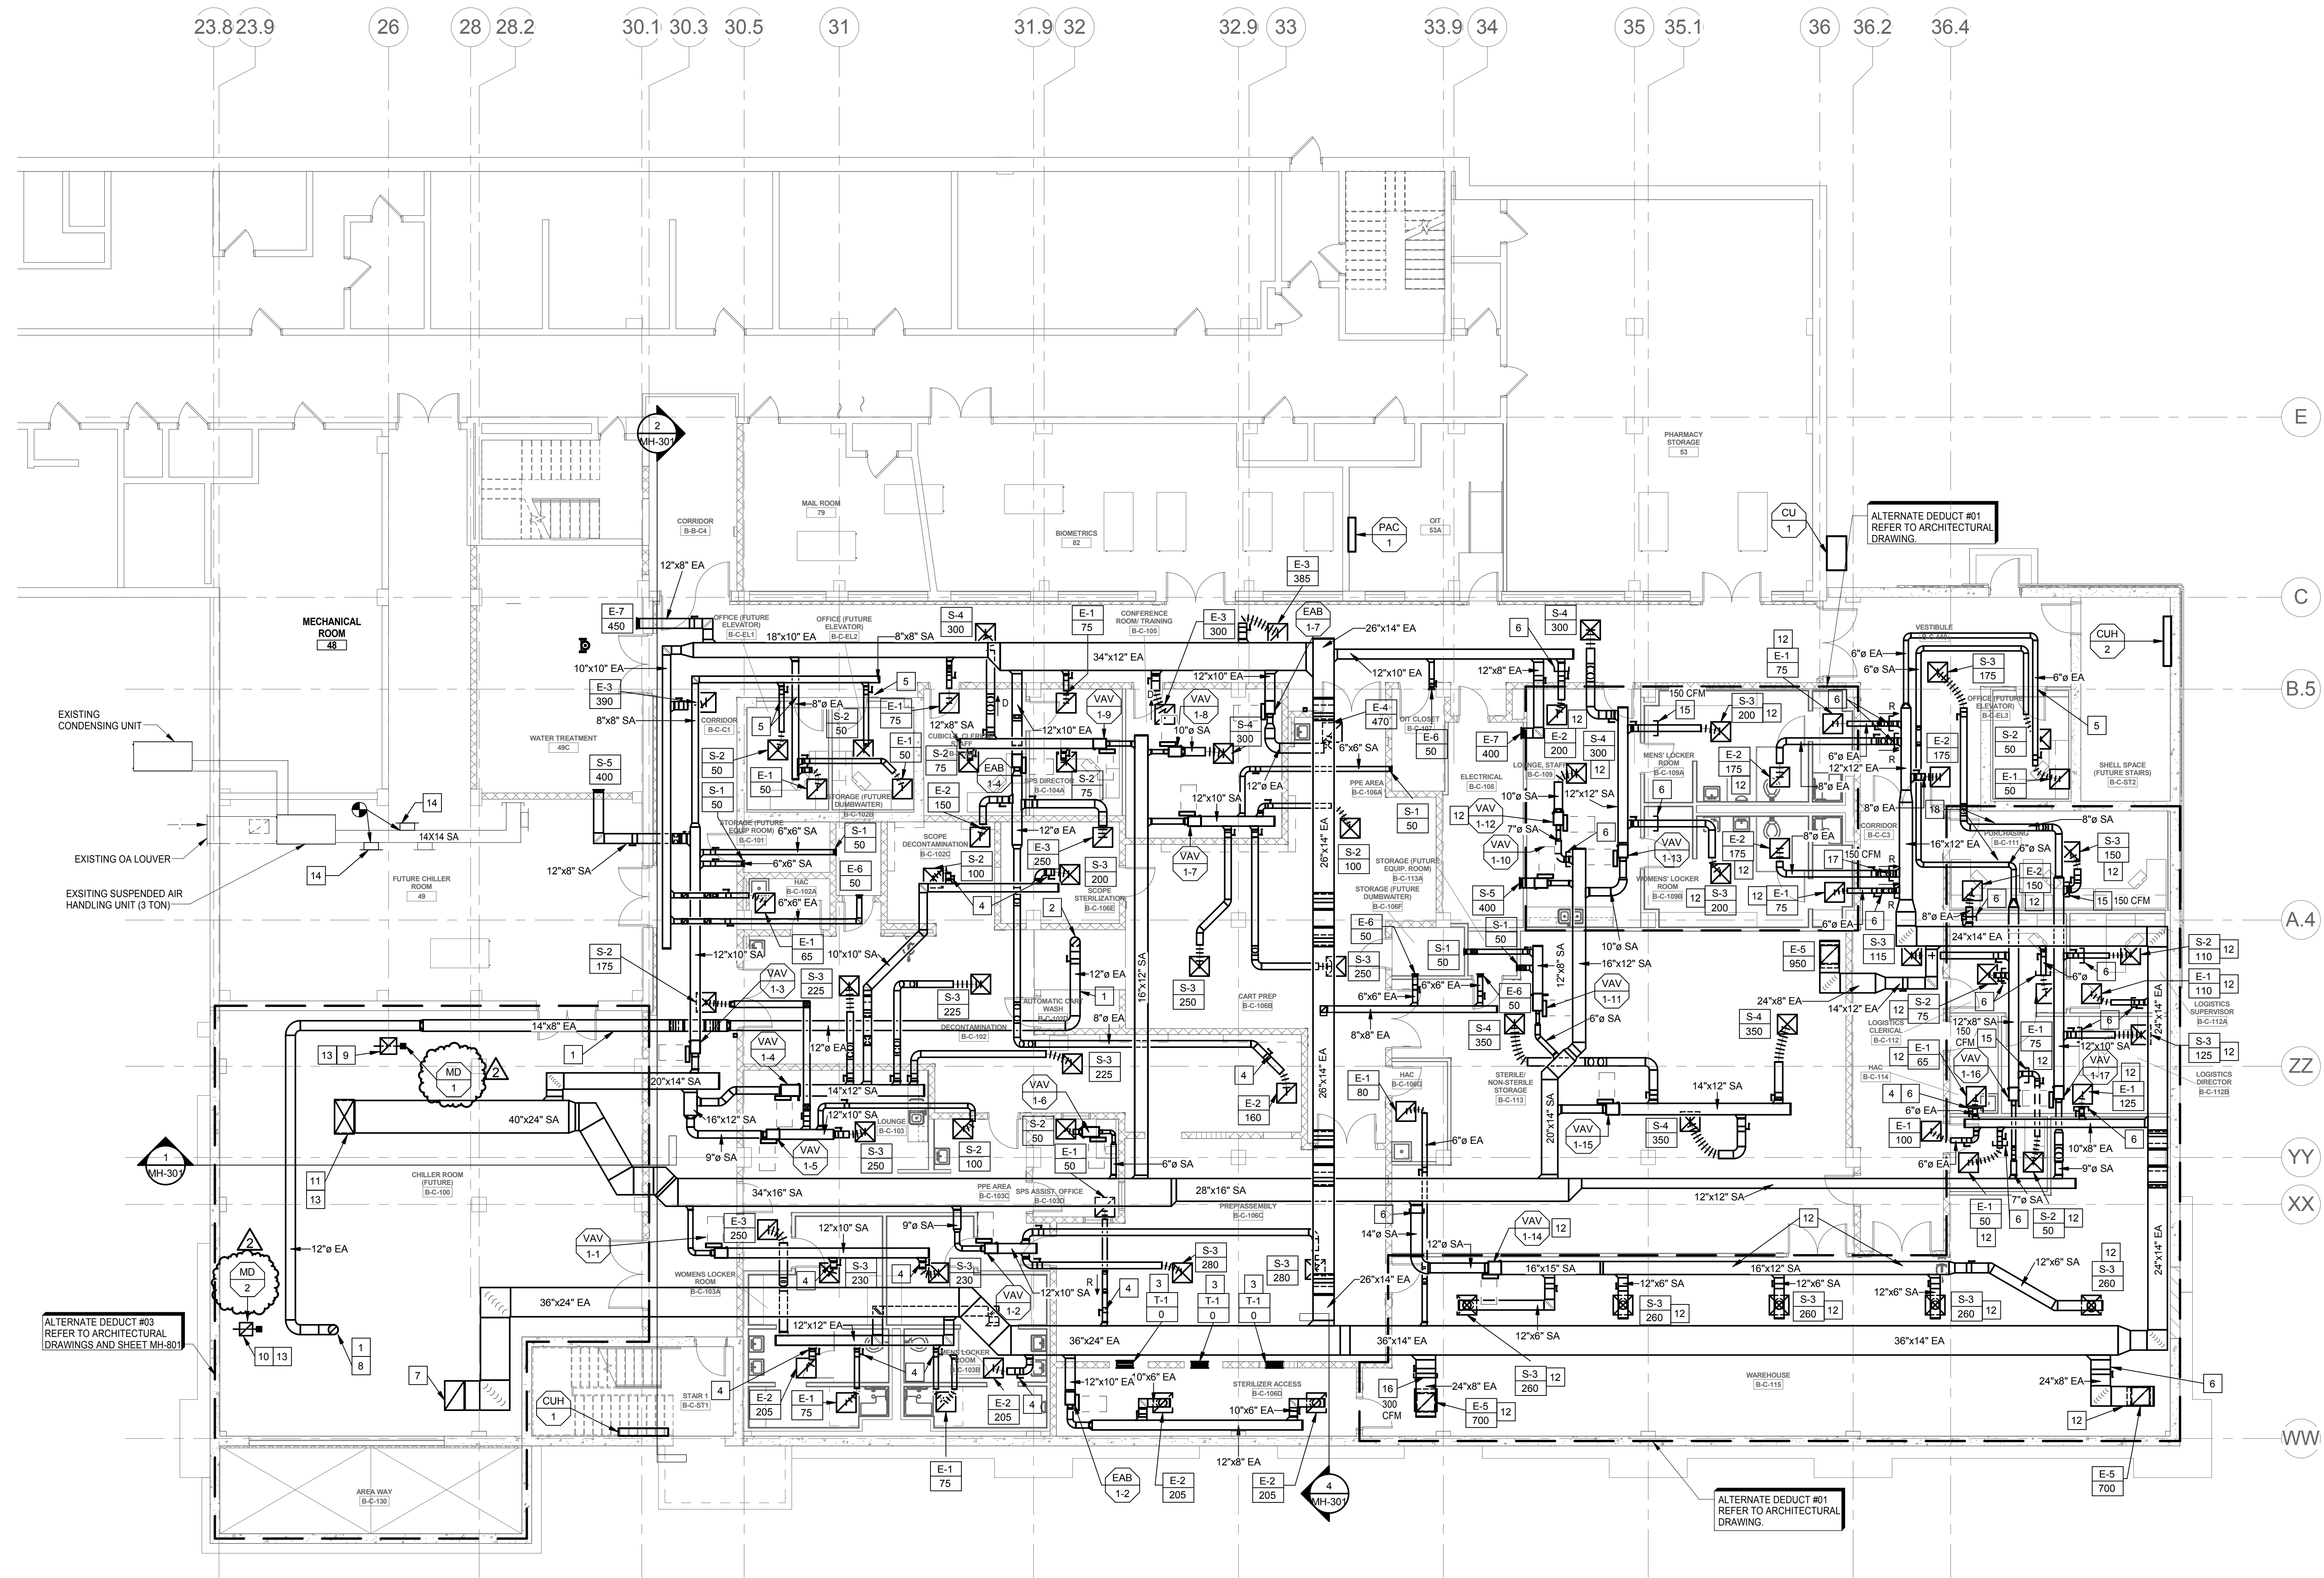

BASEMENT LEVEL DUCTWORK PLAN - NEW WORK

1  
MH-101  
1/8" = 1'-0"

ARCHITECT/ENGINEERS:

**AMERICAN STRUCTUREPOINT INC.**  
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317.638.8383

CONSULTANTS:

Drawing Title  
**BASEMENT LEVEL DUCTWORK PLAN - NEW WORK**

Approved: Project Director

Project Title  
**SPS BASEMENT ADDITION**

Location  
**2121 LAKE AVE., FORT WAYNE, IN 46805**

Date  
08/15/2014

Checked  
SWD

Drawn  
RAC

Project Number  
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Building Number  
01

Drawing Number  
**MH-101**

Office of  
Construction  
and Facilities  
Management

**VA** Department of  
Veterans Affairs

**VA**

SPS BASEMENT  
ADDITION

2121 LAKE AVE., FORT  
WAYNE, IN 46805

Amendment 04

06-10-2015


Revisions:

Date


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three inches = one foot  
one and one half inches = one foot  
one inch = one foot  
three quarters inch = one foot  
one half inch = one foot  
three eighths inch = one foot  
one quarter inch = one foot  
one eighth inch = one foot

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**PARTIAL ROOF / FIRST LEVEL - NEW WORK**  
1  
MH-102  
1/8" = 1'-0"

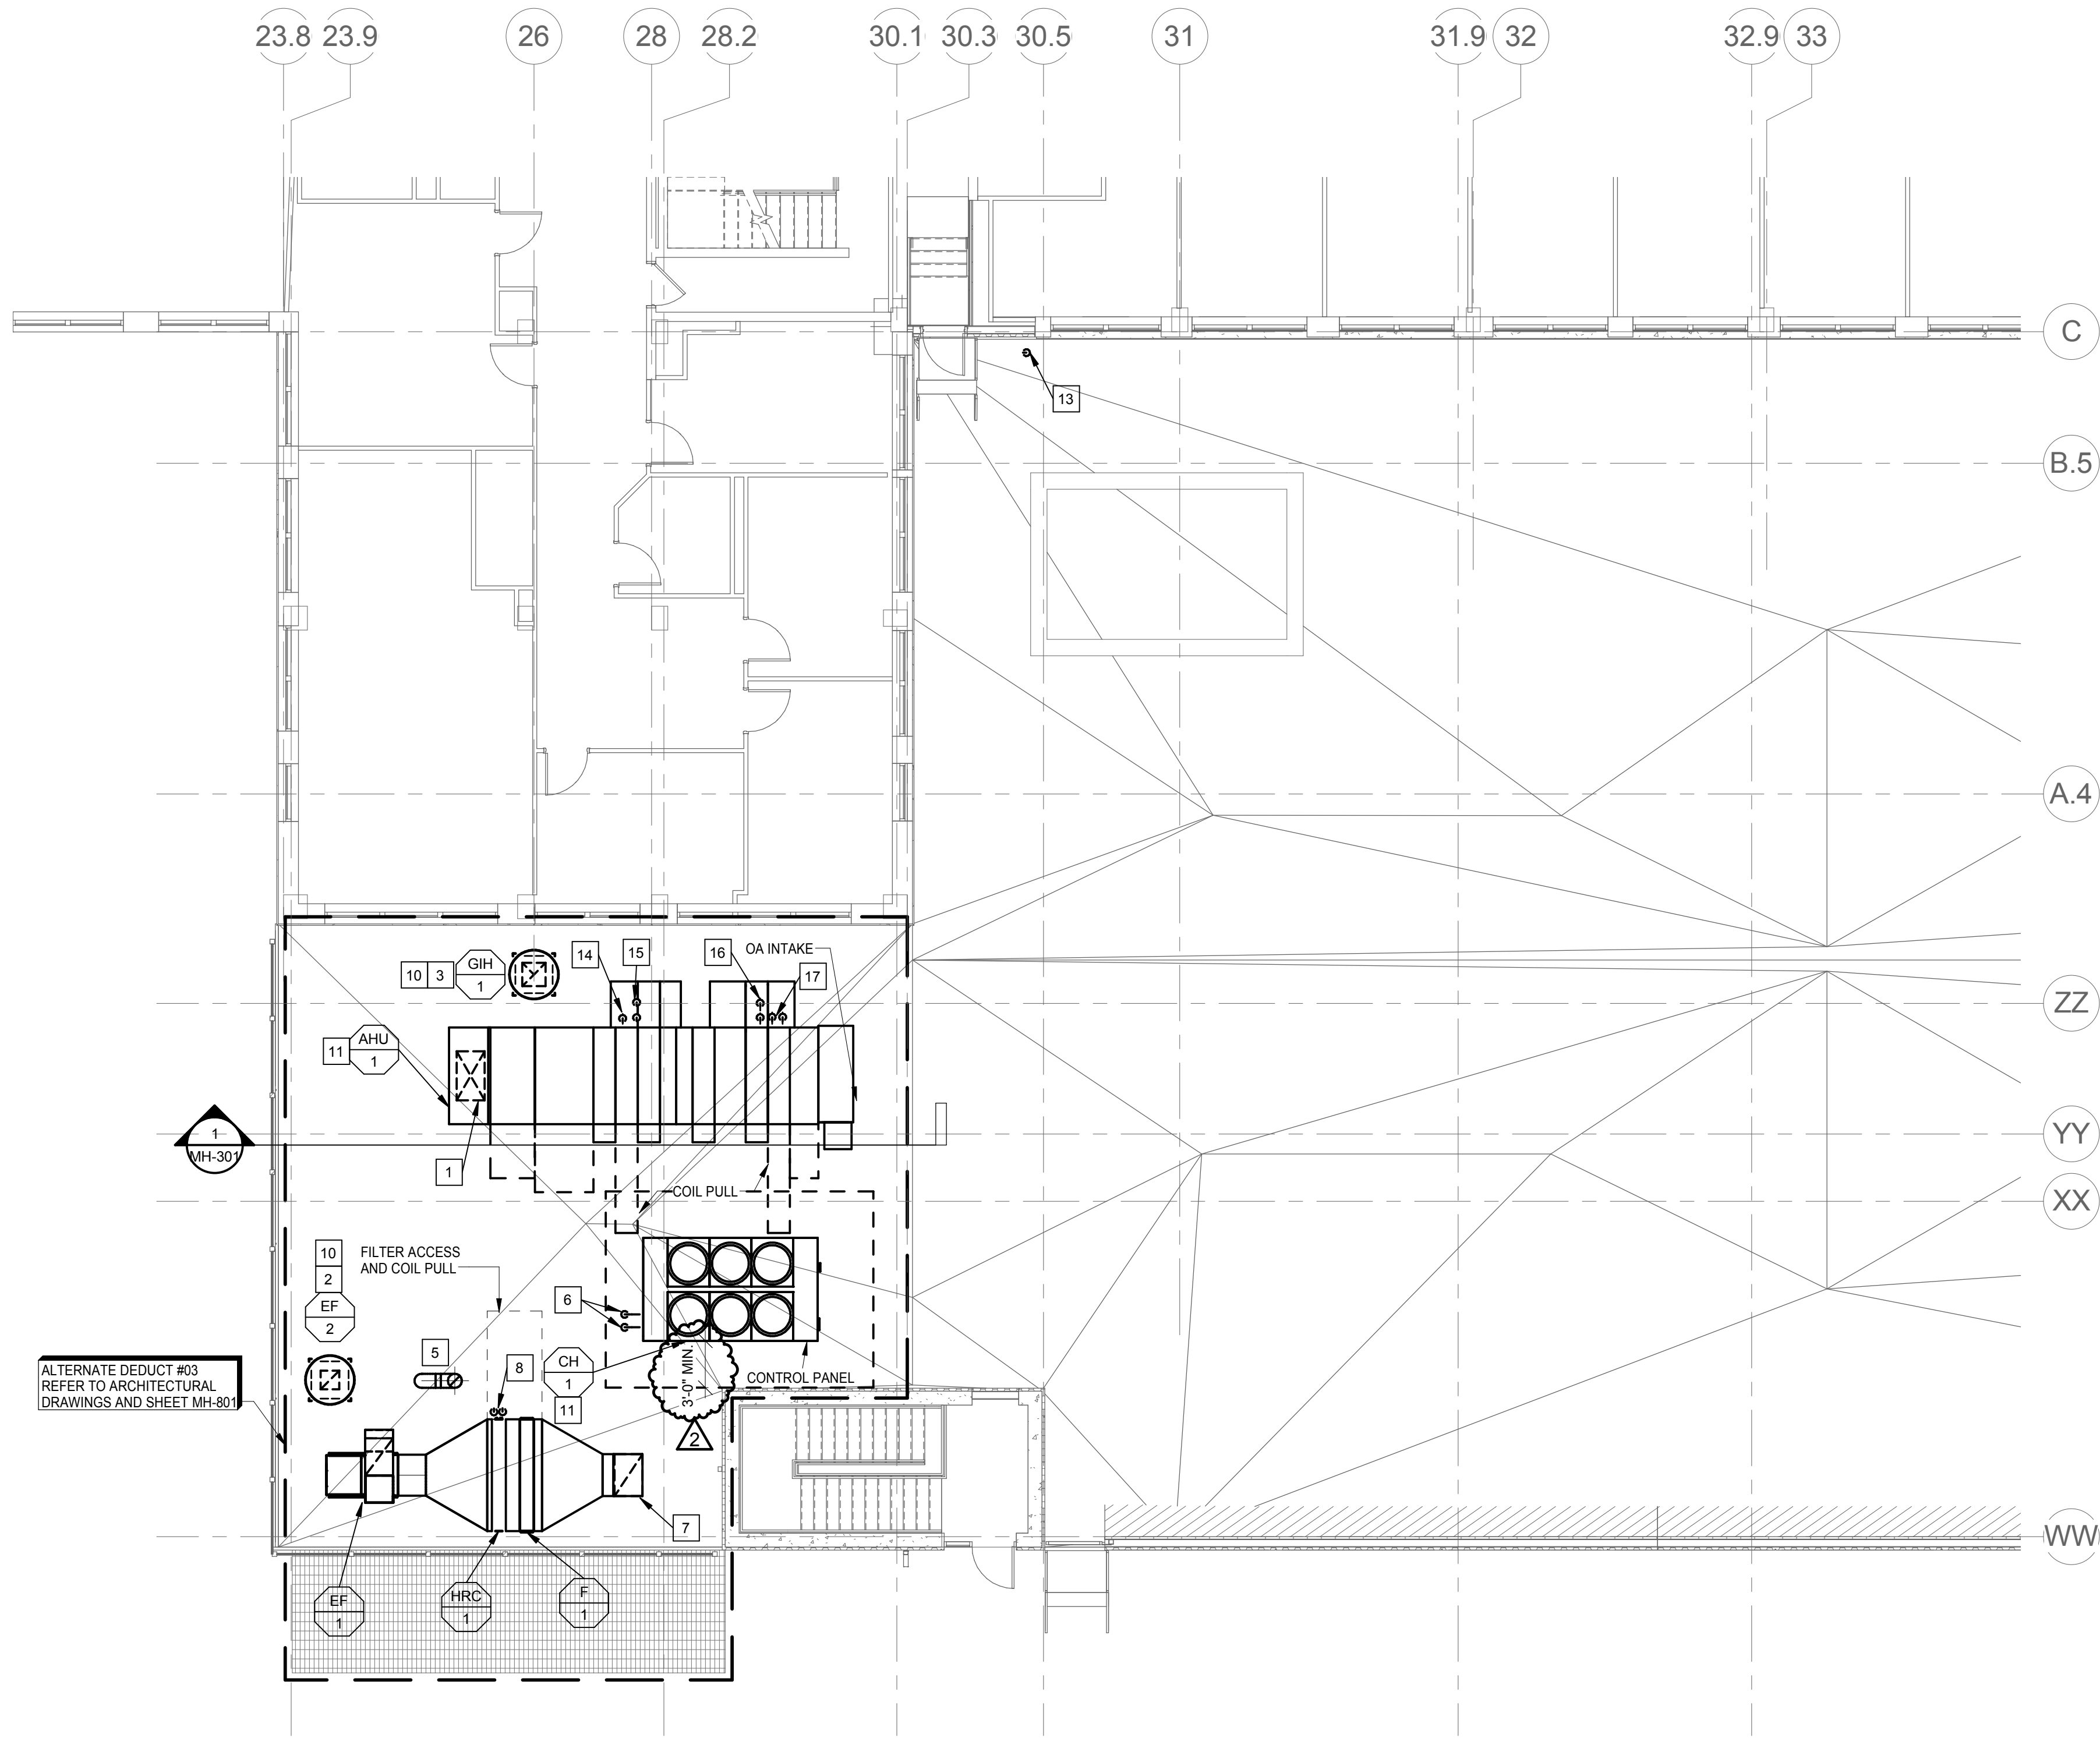

**ENLARGED WATER TREATMENT ROOM 49C**  
2  
MH-102  
1/4" = 1'-0"

**GENERAL NOTES:**

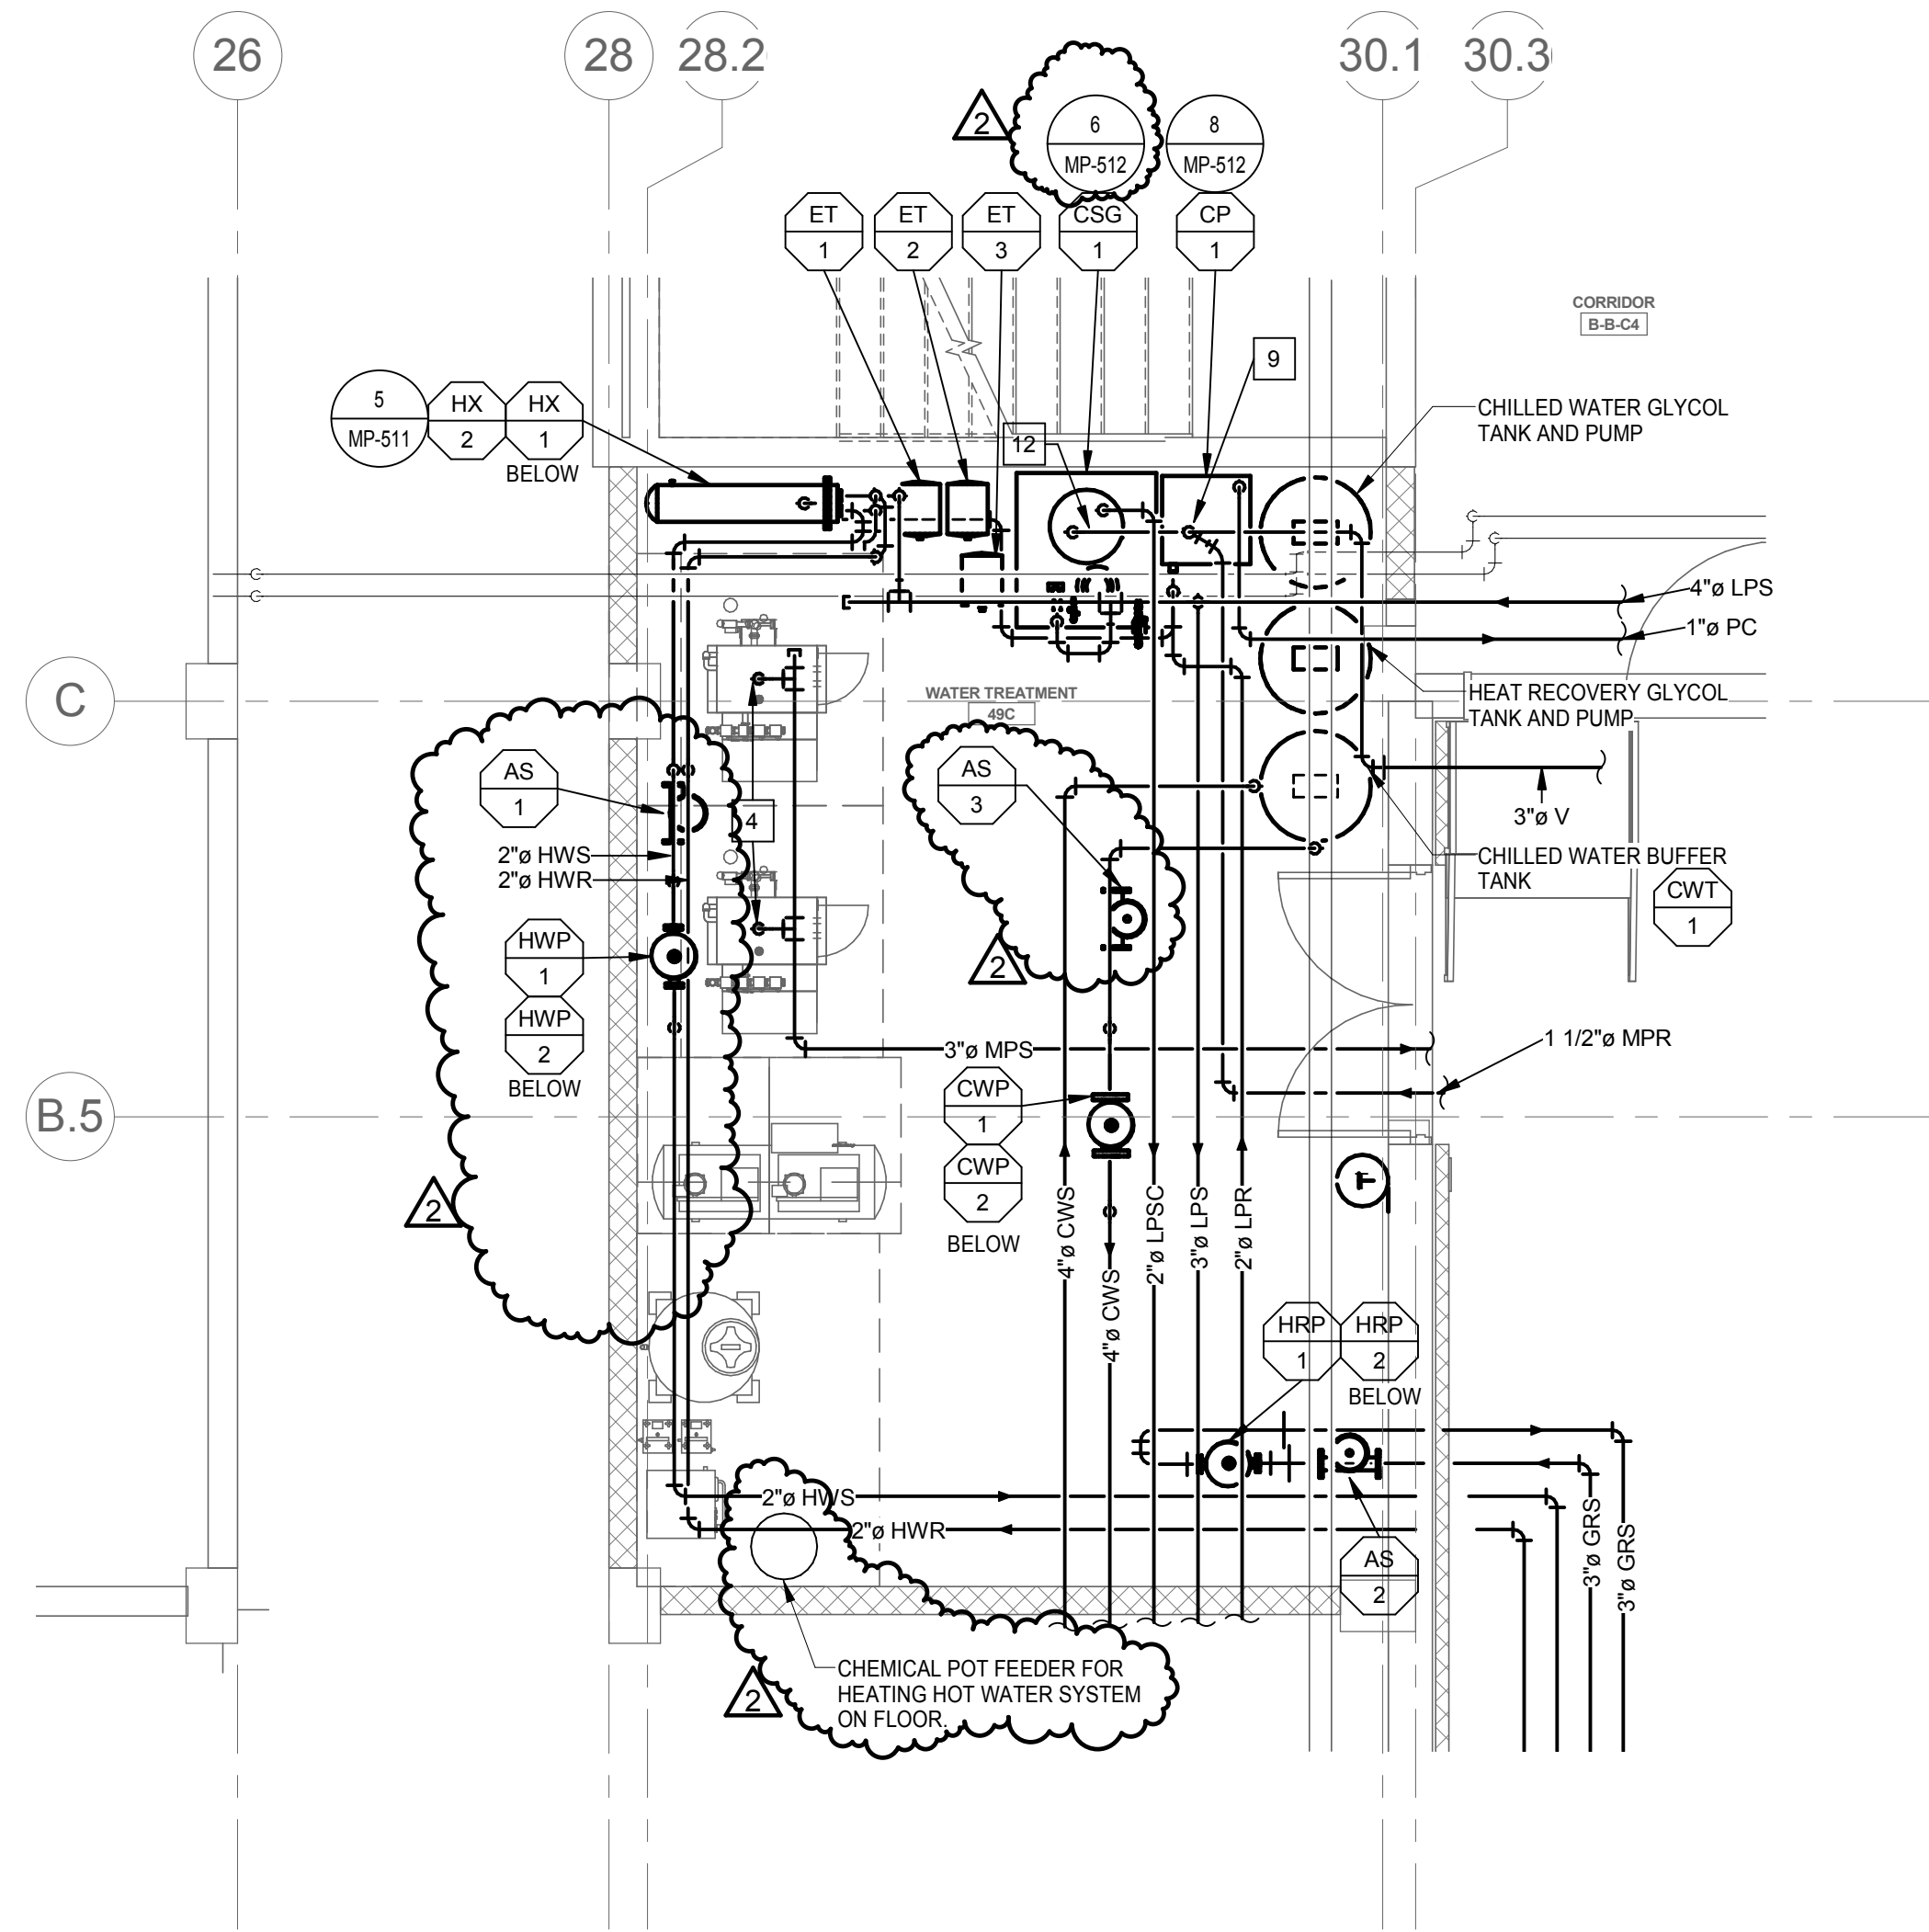1. REFER TO SHEET M00 FOR GENERAL NOTES.

**KEYED NOTES:** #

- 1 40"x24" SUPPLY DUCT DOWN THRU ROOF. REFER TO SHEET MH-101 FOR CONTINUATION.
- 2 16"x16" EXHAUST DUCT DOWN THRU ROOF. REFER TO SHEET MH-101 FOR CONTINUATION.
- 3 GRAVITY INTAKE HOOD GREENNECK MODEL FGI 2000 CFM, 20"x20" NECK, 0.15" MAX PD, WITH 12" HIGH ROOF CURB. EXTEND 20"x20" DUCT DOWN THRU ROOF. REFER TO SHEET MH-101 FOR CONTINUATION.
- 4 CONNECT 2" MPS TO ELECTRIC STEAM GENERATOR PROVIDED AND INSTALLED BY STERIS. PROVIDE SHUT-OFF VALVE AT CONNECTION TO UNIT.
- 5 12"Ø EXHAUST DUCT DOWN THRU ROOF. REFER TO SHEET MH-101 FOR CONTINUATION. TERMINATE WITH GOOSENECK A MINIMUM OF 18" ABOVE ROOF. ALL CART WASH EXHAUST DUCTWORK SHALL BE CONSTRUCTED OF WELDED STAINLESS STEEL.
- 6 4" CWS AND CWR PIPING DOWN THRU ROOF. REFER TO SHEET MP-101 FOR CONTINUATION. PROVIDE PIPE CURB ASSEMBLY FOR PIPE PENETRATIONS AT ROOF. REFER TO DETAIL 5 ON SHEET MP-512.
- 7 36"x24" EXHAUST DUCT DOWN THRU ROOF. REFER TO SHEET MH-101 CONTINUATION.
- 8 3" GRS AND GRR DOWN THRU ROOF. REFER TO SHEET MP-101 FOR CONTINUATION. PROVIDE PIPE CURB ASSEMBLY FOR PIPE PENETRATIONS AT ROOF. REFER TO DETAIL 5 ON SHEET MP-512.
- 9 CONNECT STEAM VENT TO CONDENSATE PUMP AND INCREASE TO 3" IN VERTICAL RISER. CONNECT 1 1/2" MPR TO 3" STEAM VENT PIPING VERTICAL RISER AND EXTEND AS SHOWN.
- 10 DELETE EQUIPMENT IF ALTERNATE DEDUCT #03 IS ACCEPTED.
- 11 RELOCATE EQUIPMENT AS SHOWN ON SHEET MH-B01 IF ALTERNATE DEDUCT #03 IS ACCEPTED.
- 12 CONNECT TO 2" CLEAN STEAM GENERATOR RELIEF VALVE AND PROVIDE DRAIN PAN ELBOW. EXTEND 3" RELIEF VENT TO 3" STEAM VENT VERTICAL RISER AS SHOWN. REFER TO DETAIL 11 ON SHEET MP-511.
- 13 3" STEAM VENT DOWN THRU ROOF. REFER TO SHEET MP-101 FOR CONTINUATION. TERMINATE 6'-0" ABOVE ROOF. PROVIDE STAINLESS STEEL INSECT SCREEN ON END OF PIPING.
- 14 2" LPS DOWN THRU ROOF INSIDE AHU PIPE VESTIBULE. REFER TO SHEET MP-101 FOR CONTINUATION.
- 15 4" CWS AND CWR DOWN THRU ROOF INSIDE AHU PIPE VESTIBULE. REFER TO MP-101 FOR CONTINUATION. CHILLED WATER PIPING INSIDE PIPE VESTIBULE SHALL BE HEAT TRACED. REFER TO ELECTRICAL DRAWINGS.
- 16 3" LPS AND 2" LPR DOWN THRU ROOF INSIDE PRE-HEAT COIL PIPE VESTIBULE. REFER TO MP-101 FOR CONTINUATION.
- 17 3" GRS AND GRR DOWN THRU ROOF INSIDE OUTDOOR AIR RECOVERY COIL PIPE VESTIBULE. REFER TO MP-101 FOR CONTINUATION.

100% CONSTRUCTION DOCUMENTS  
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<div>Amendment 0406-10-2015</div> <div>Revisions:Date</div>		<div>ARCHITECT/ENGINEERS:</div> <div><div>VA</div><div>SPS BASEMENT ADDITION</div><div>2121 LAKE AVE., FORT WAYNE, IN 46805</div></div>		<div>CONSULTANTS:</div> <div><div>AMERICAN STRUCTUREPOINT INC.</div><div>7260 SHADELAND STATION INDIANAPOLIS, IN 46256-3957 TEL 317.547.5580 FAX 317.543.0270 www.structurepoint.com</div><div>Ross &amp; Baruzzini</div><div>8250 Haverstick Road Suite 285 Indianapolis, IN 46240 317.638.8383</div></div>		<div>Drawing Title</div> <div>ROOF PLAN &amp; ENLARGED MECH. ROOM- NEW WORK</div> <div>Approved: Project Director</div>	<div>Project Title</div> <div>SPS BASEMENT ADDITION</div> <div>Location</div> <div>2121 LAKE AVE., FORT WAYNE, IN 46805</div> <div>Date</div> <div>08/15/2014</div> <div>Checked</div> <div>SWD</div> <div>Drawn</div> <div>RAC</div>	<div>Project Number</div> <div>2010.00629</div> <div>Building Number</div> <div>01</div> <div>Drawing Number</div> <div>MH-102</div>	<div>Office of Construction and Facilities Management</div> <div>VA Department of Veterans Affairs</div>	
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AIR SEPARATOR SCHEDULE								
PLAN	MARK	TYPE	LOCATION		SERVICE	FLOW (GPM)	MAX WATER PD (FT)	NOTES
			ROOM NAME	ROOM NUMBER				
AS	1	NOTE 1	WATER TREATMENT	49C	HEATING HOT WATER	25	2.0	
AS	2	NOTE 2	WATER TREATMENT	49C	HEAT RECOVERY	100	2.0	
AS	3	NOTE 3	WATER TREATMENT	49C	CHILLED WATER	124	2.0	

NOTES:  
(1) ONE HEAT EXCHANGER IS BACK-UP.

NOTES:  
(1) PRIMARY HUMIDIFIER DISPERSION GRID SHALL BE INSTALLED IN AIR HANDLING UNIT CASING. VERIFY SIZE OF MANIFOLD AND QUANTITY OF DISPERSION TUBES WITH APPROVED AHU MANUFACTURERS SHOP DRAWING

NOTES:  
(1) STAINLESS STEEL CONSTRUCTION.  
(2) UNIT SHALL HAVE FACTORY SKID WITH BLOWDOWN AFTER COOLER AND REALTED CONTROLS.  
(3) PROVIDE WITH 120V TO 24V TRANSFORMER AND UNIT MOUNTED DISCONNECT SWITCH.

NOTES:  
(1) SEE EQUIPMENT DATA SCHEDULE ON SHEET E-600 FOR ELECTRICAL INFORMATION.  
(2) WATER  
(3) 40% PROPYLENE GLYCOL SOLUTION.  
(4) PROVIDE WITH INVERTER - READY OR INVERTER DUTY MOTOR FOR VARIABLE SPEED OPERATION. PROVIDE SHAFT GROUNDING RING.  
(5) PUMPS ARE DUTY/STANDBY.

NOTES:  
(1) SEE EQUIPMENT DATA SCHEDULE ON SHEET E-600 FOR ELECTRICAL INFORMATION.  
(2) PROVIDE WITH FACTORY MOUNTED CONTROL PANEL AND SINGLE POINT POWER CONNECTION. CONTROLS SHALL INCLUDE STARTER, DISCONNECT, WATER LEVEL CONTROL, AND THERMAL PROTECTION.

NOTES:  
(1) SUMMER CONDITIONS  
(2) WINTER CONDITIONS  
(3) CAPACITY BASED ON 40% PROPYLENE GLYCOL


NOTES:

- (1) PROVIDE WITH MANUFACTURER'S PRE-CHARGED LINE SETS, CONNECTION CABLES, AND ALL RECOMMENDED ACCESSORIES FOR MOUNTING LOCATIONS. FINAL SIZING OF REFRIGERANT PIPING IS RESPONSIBILITY OF MANUFACTURER BASED ON INSTALLATION REARRANGEMENTS.
- (2) PROVIDE WITH FACTORY INSTALLED CONTROLS, AND THERMOSTAT. NO CONTROL INTERFACE WITH BUILDING EMCS.
- (3) PROVIDE LOW AMBIENT KIT FOR OPERATION DOWN TO 0 DEGREES F.
- (4) PROVIDE CONDENSATE PUMP

NOTES:  
(1) REFER TO SPEC SECTION 23 05 41 FOR ISOLATER TYPE DESCRIPTION.  
(2) EQUIPMENT SUSPENDED FROM STRUCTURE.  
(3) INTERNAL ISOLATORS PROVIDED BY AHU MANUFACTURER.  
(4) LOCATE ISOLATORS UNDER UNIT EQUIPMENT BASE.





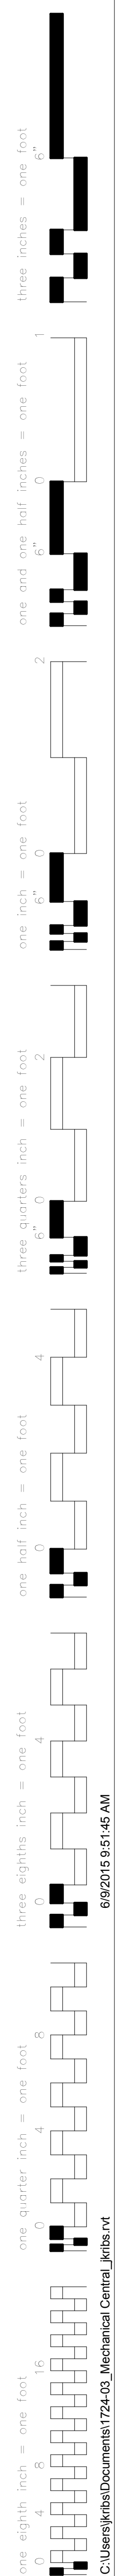







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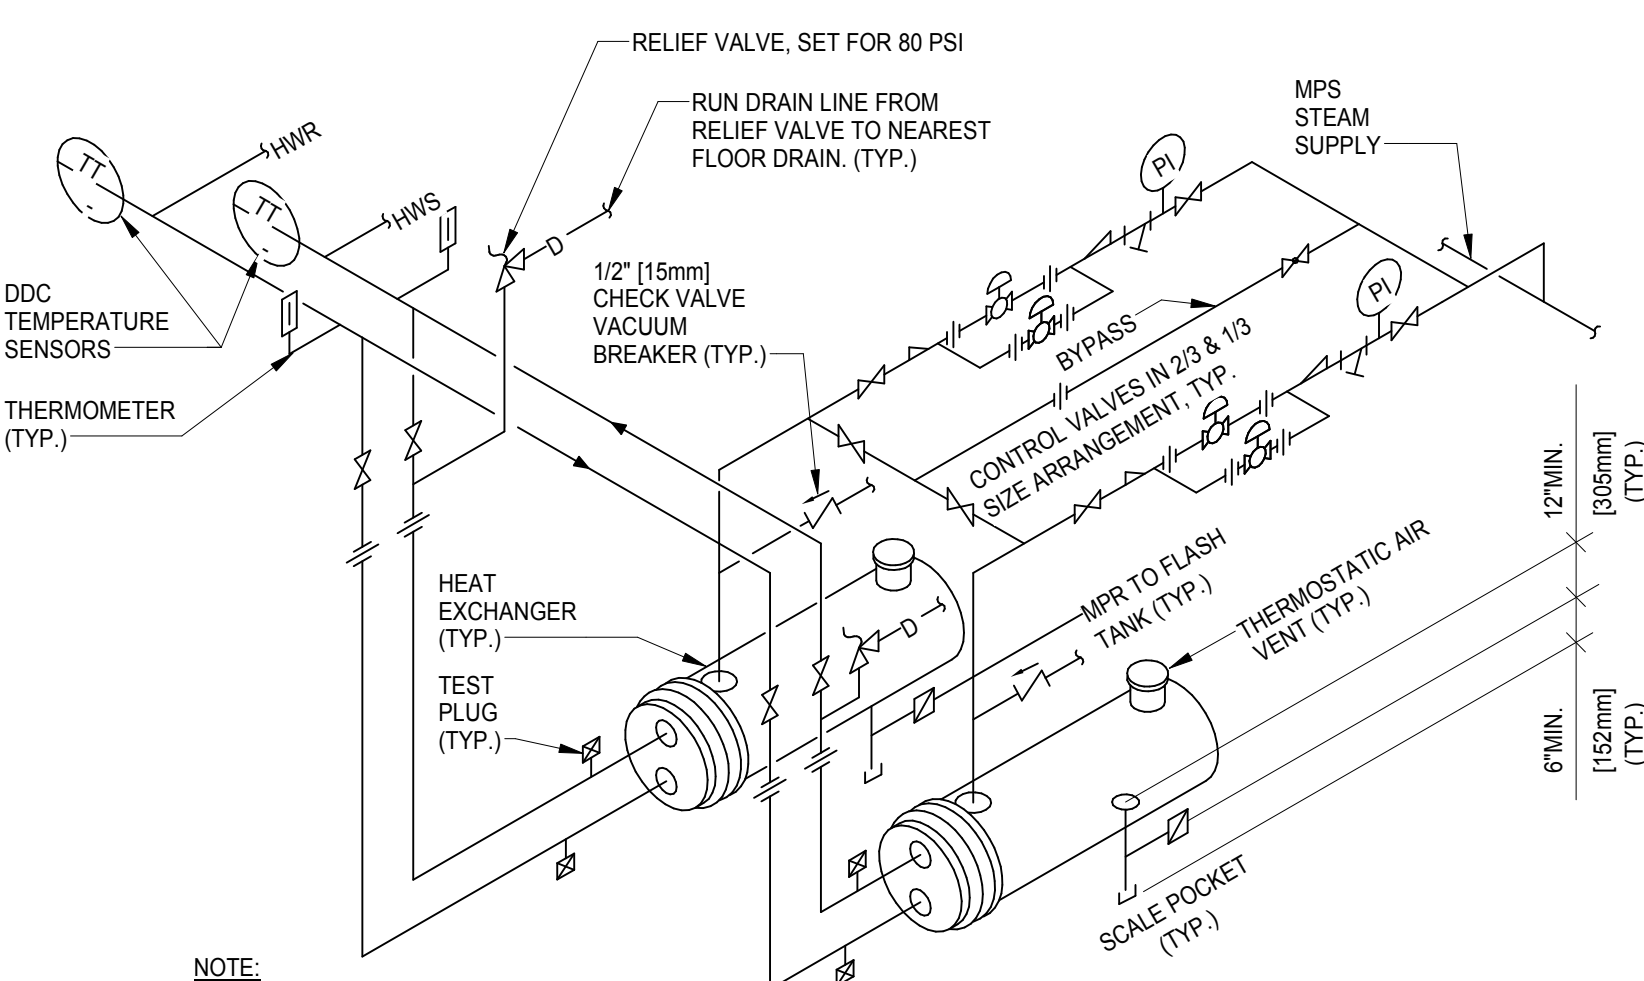
- NOTE:
1. CPVC PIPE MAY BE USED ONLY IF APPROVED BY LOCAL BA AND IS INDOORS AND DOES NOT PASS THROUGH RATED BARRIERS.
  2. DIELECTRIC FITTING TO BE USED WHEN TWO DISSIMILAR METALS ARE TO BE CONNECTED.

UNIT TYPE	A	B
DRAW THRU	2" [50mm] PLUS X	X
BLOW THRU	1" [25mm] MINIMUM	2X

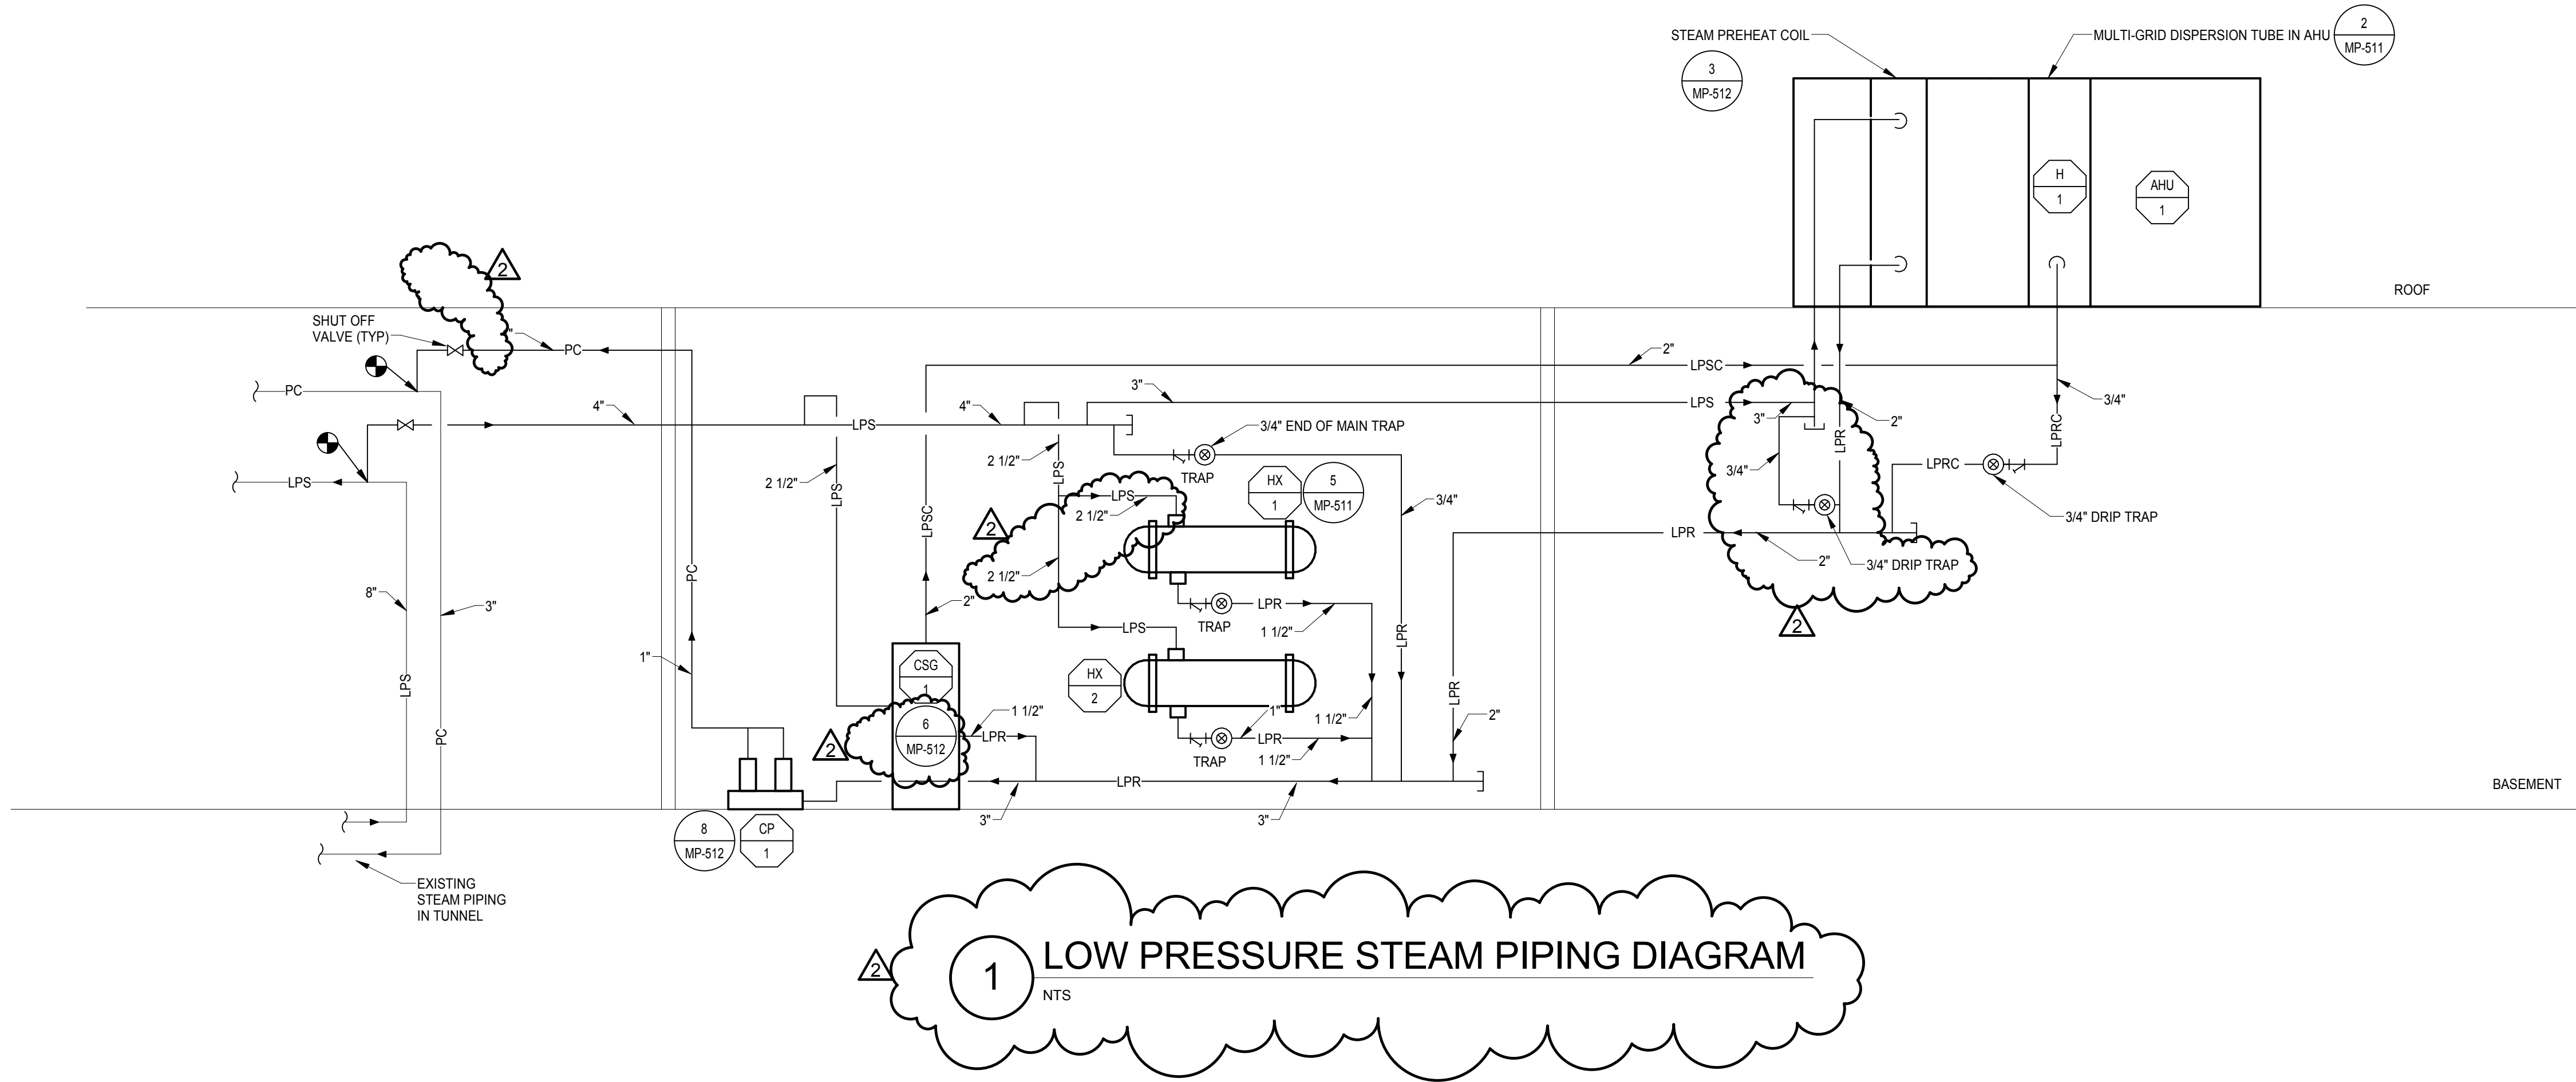WHERE X = STATIC PRESSURE IN PAN

## 1 AIR HANDLING UNIT DRAIN TRAP DETAIL

NTS

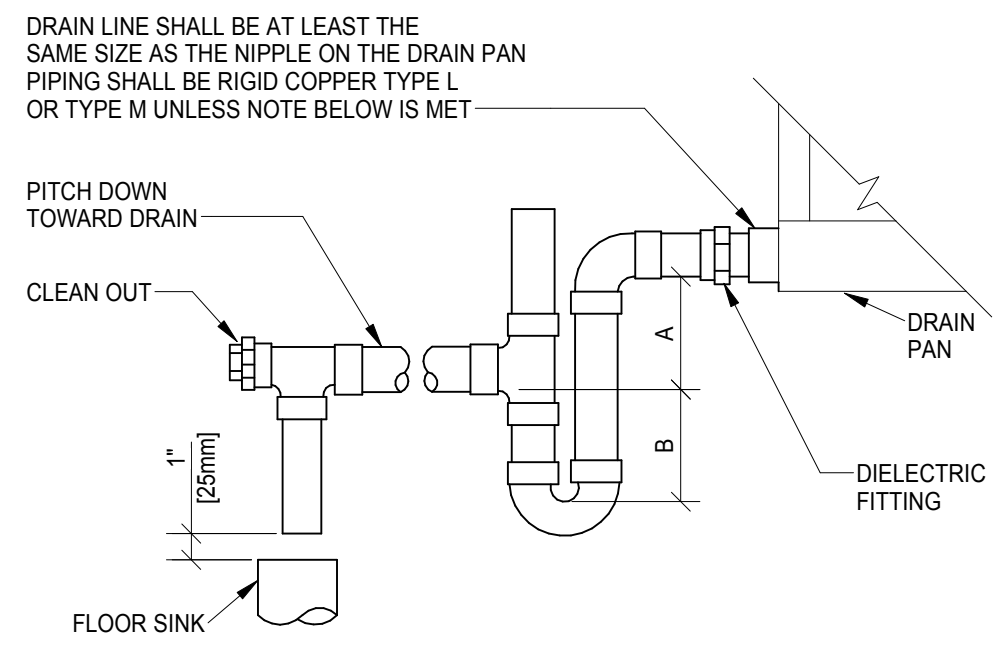


NOTE:

1. THE ABOVE DETAIL SHOWS REQUIRED PIPING FOR TWO HEAT EXCHANGERS IN PARALLEL.
2. PROVIDE SADDLE SUPPORTS AND LEGS OR HANGERS FOR HEAT EXCHANGER. MOUNTING HEIGHT SHALL BE ADJUSTED TO FACILITATE GRAVITY RETURN OF STEAM CONDENSATE.
3. MAKE THE BYPASS THE SAME SIZE AS THE CONNECTIONS TO THE CONTROL VALVES.
4. CONTROL VALVES SHALL BE IN A 1/3 AND 2/3 SIZE ARRANGEMENT.


## 5 HEAT EXCHANGER - STEAM TO HOT WATER

NTS

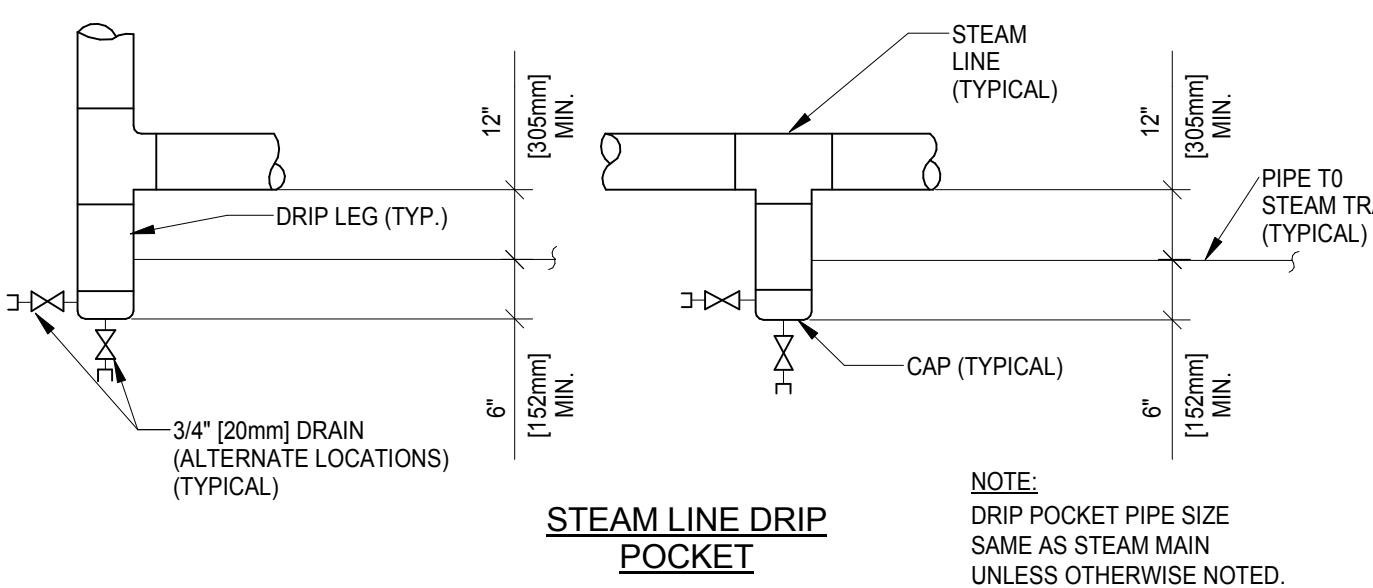

STEAM LINE DRIP POCKET


NOTE: DRIP POCKET PIPE SIZE SAME AS STEAM MAIN UNLESS OTHERWISE NOTED.

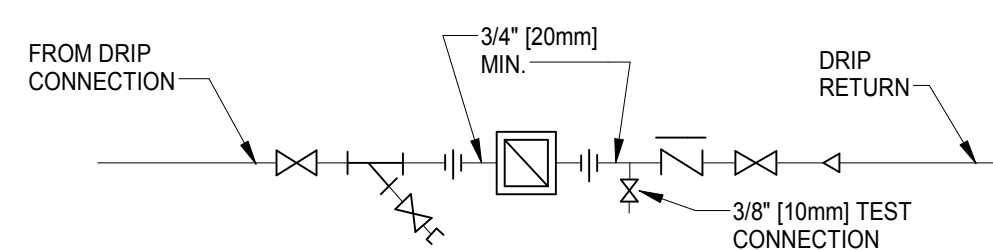

STEAM TRAP ASSEMBLY


## 9 STEAM LINE DRIP POCKET STEAM TRAP ASSEMBLY

NTS

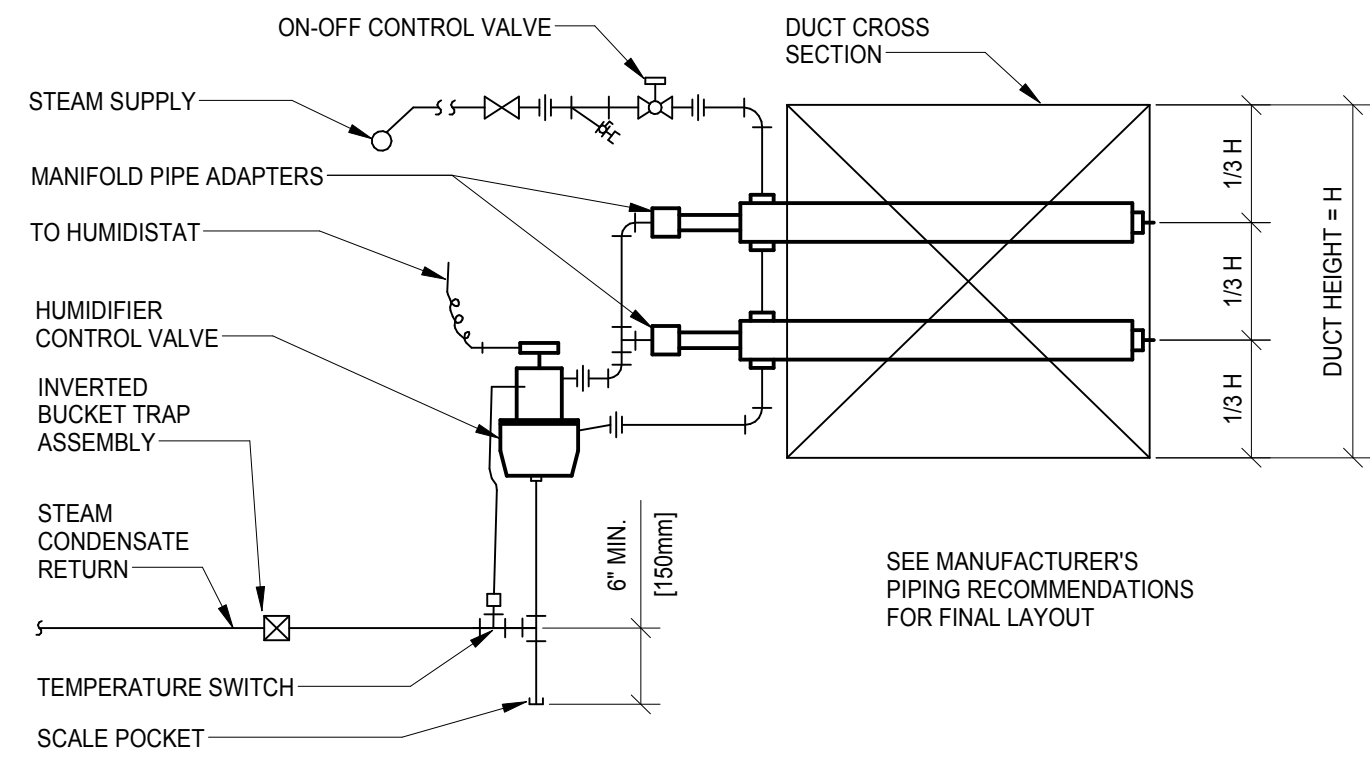

## 2 STEAM HUMIDIFIER - PIPING CONNECTION (MULTIPLE DISPERSION TUBES)

NTS

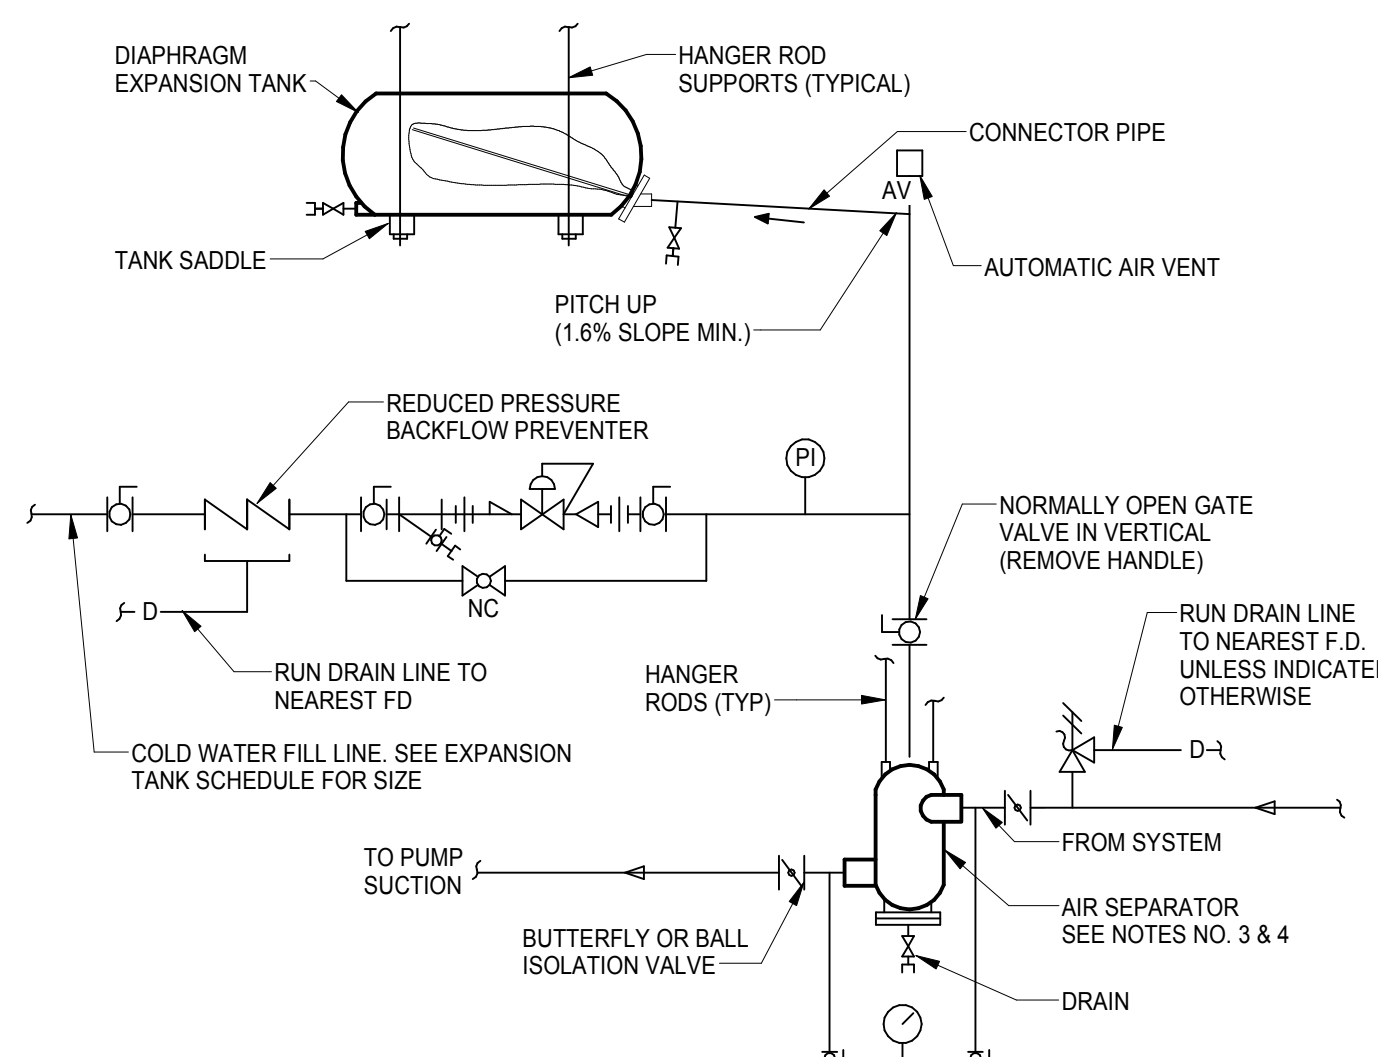


NOTES:

1. SEE EXPANSION TANK SYSTEM SCHEDULE FOR COMPONENT SIZES.
2. RELIEF VALVE FOR CHILLED WATER SYSTEM IS SHOWN. OMIT WHEN RELIEF VALVE IS SHOWN ON HEAT EXCHANGER DETAIL & SYSTEM IS USED ONLY FOR HOT WATER HEATING.
3. PROVIDE STRAINER IN AIR SEPARATOR WHEN INDICATED IN EXPANSION TANK SCHEDULE.
4. FOR HOT WATER SYSTEMS 2" [50mm] AND SMALLER AND CHILLED WATER SYSTEMS USE IN-LINE AIR PURGER IN LIEU OF AIR SEPARATOR.
5. SET PRESSURE REDUCING VALVE SO PRESSURE AT HIGHEST POINT IN SYSTEM HAS A MINIMUM OF 4 PSIG. [28kPa]


## 6 HORIZONTAL EXPANSION TANK-PIPING CONNECTIONS

NTS

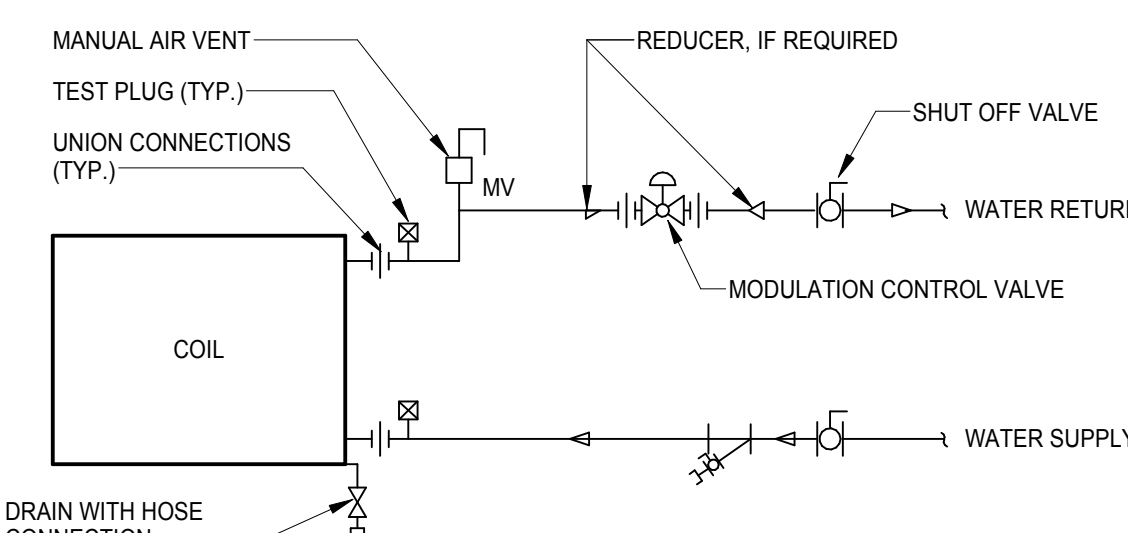


## 10 TERMINAL UNIT WATER COILS-PIPING CONNECTION

NTS

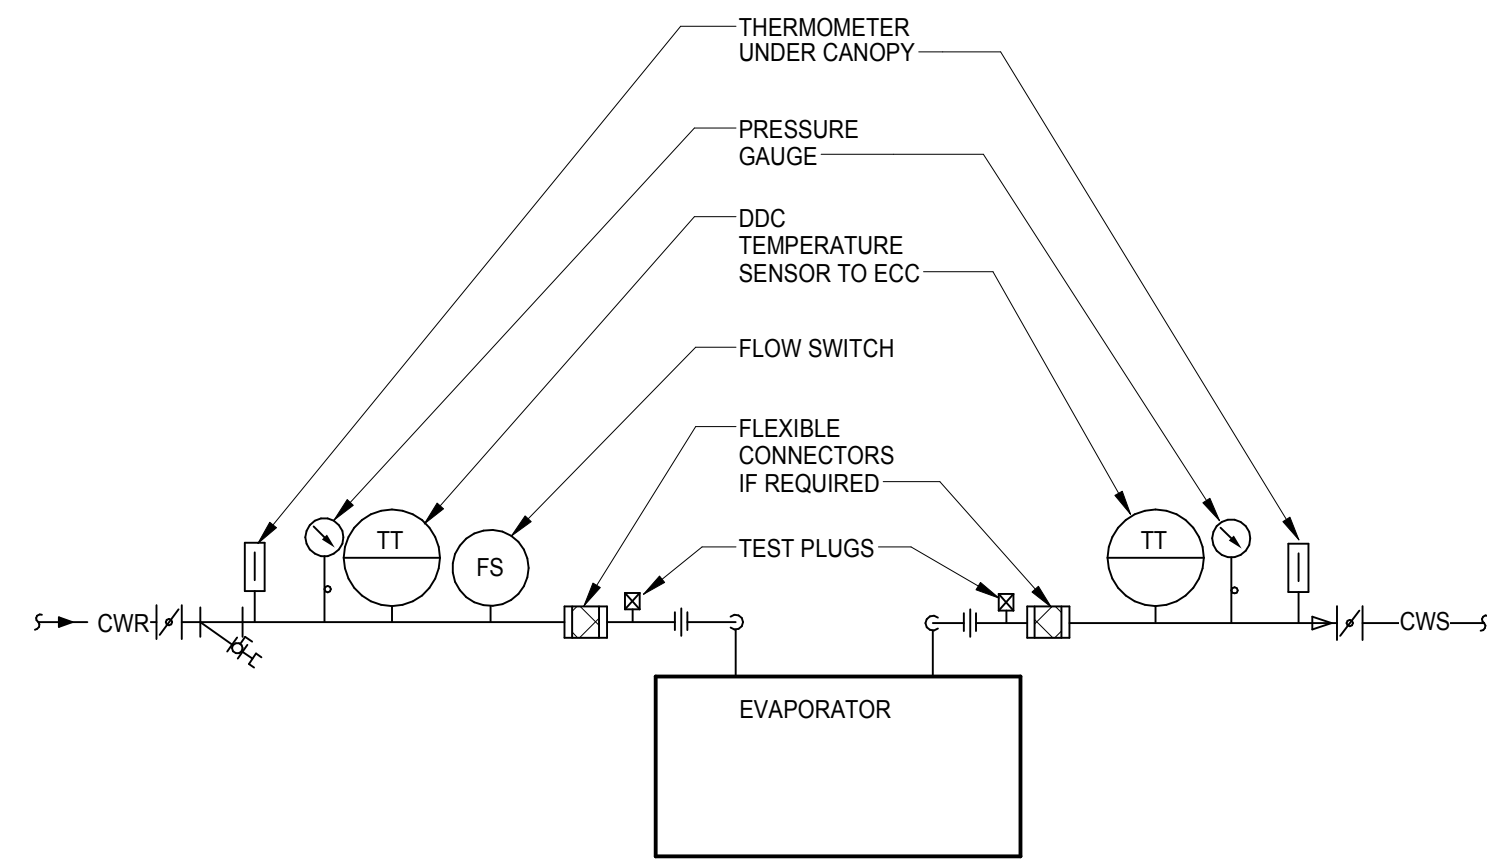

## 4 AIR COOLED CHILLER - PIPING CONNECTIONS

NTS

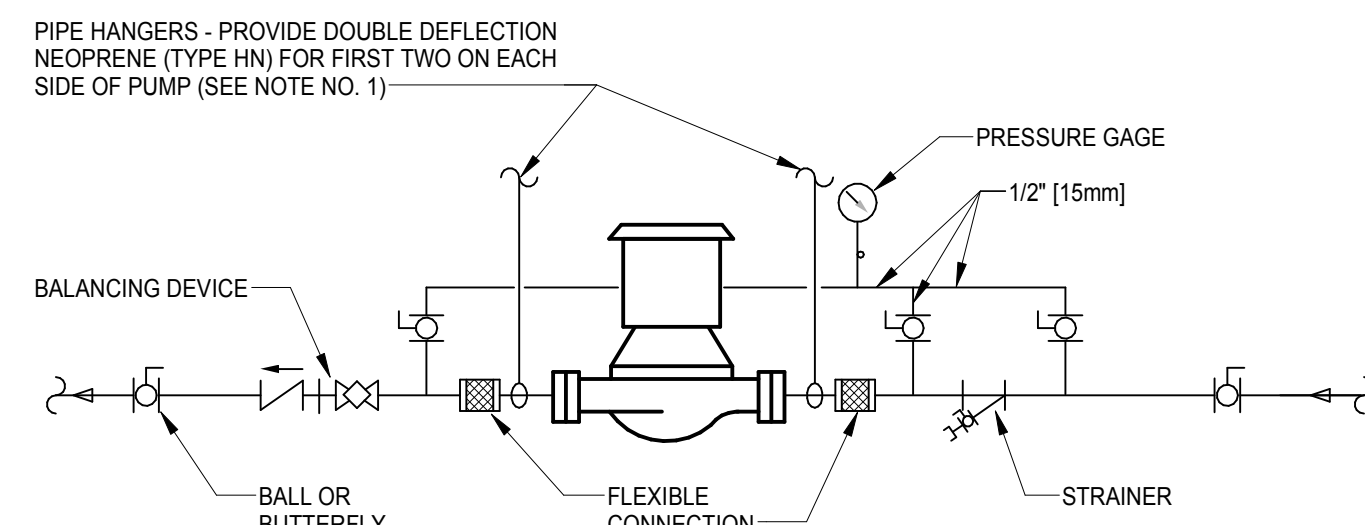


NOTES:

1. SUPPORT PUMP FROM PIPING ONLY. DO NOT SUPPORT PUMP FROM MOTOR.

## 7 IN-LINE PUMPS - CONNECTIONS

NTS

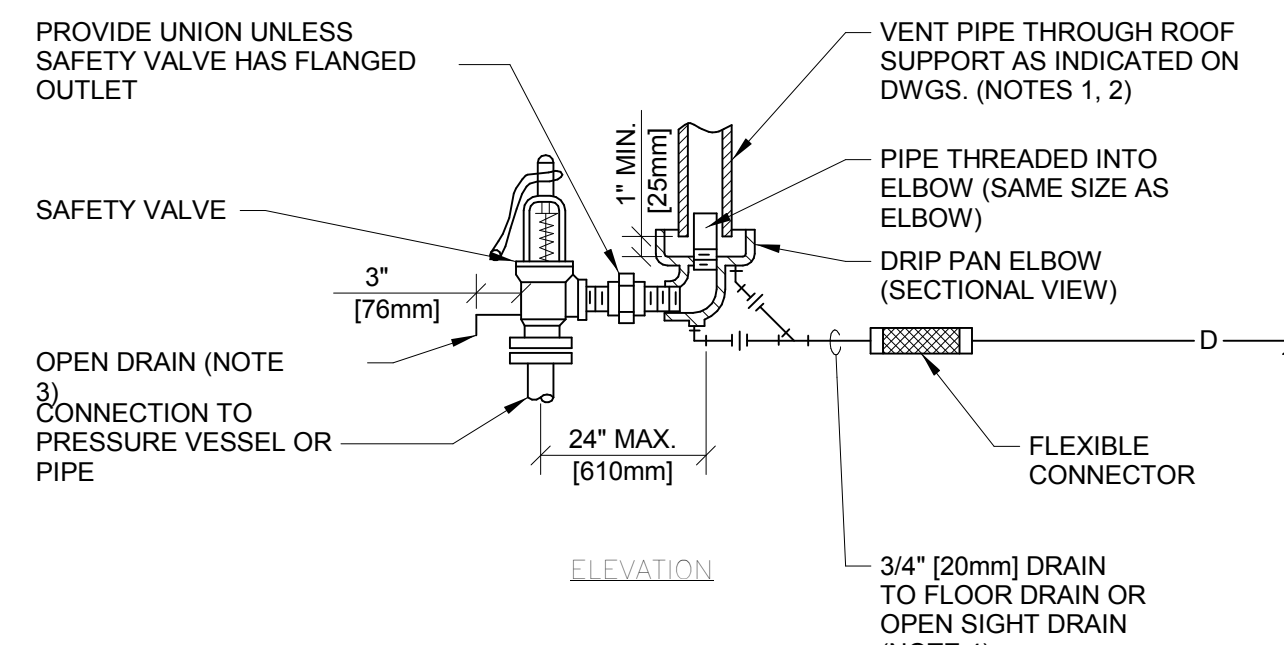


NOTES:

1. UNLESS OTHERWISE SHOWN ON THE DRAWINGS, SIZE THE VENT PIPE SO THAT STEAM IS NOT BLOWN OUT AT THE VENT PIPE ENTRANCE. UTILIZE THE CALCULATION METHOD CONTAINED IN ANSI B31.1, POWER PIPING CODE, APPENDIX II.
2. VENT PIPE SHALL TERMINATE 6' [1829mm] MIN. ABOVE FINISHED ROOF.
3. DISCHARGE OF DRAIN MUST BE DIRECTED AWAY FROM PLATFORMS OR OTHER AREAS WHICH PERSONNEL MAY OCCUPY.
4. DO NOT CONNECT ANY OTHER DRAIN TO THE DRIP PAN ELBOW DRAIN PIPE.


## 11 STEAM SAFETY VALVE

NTS

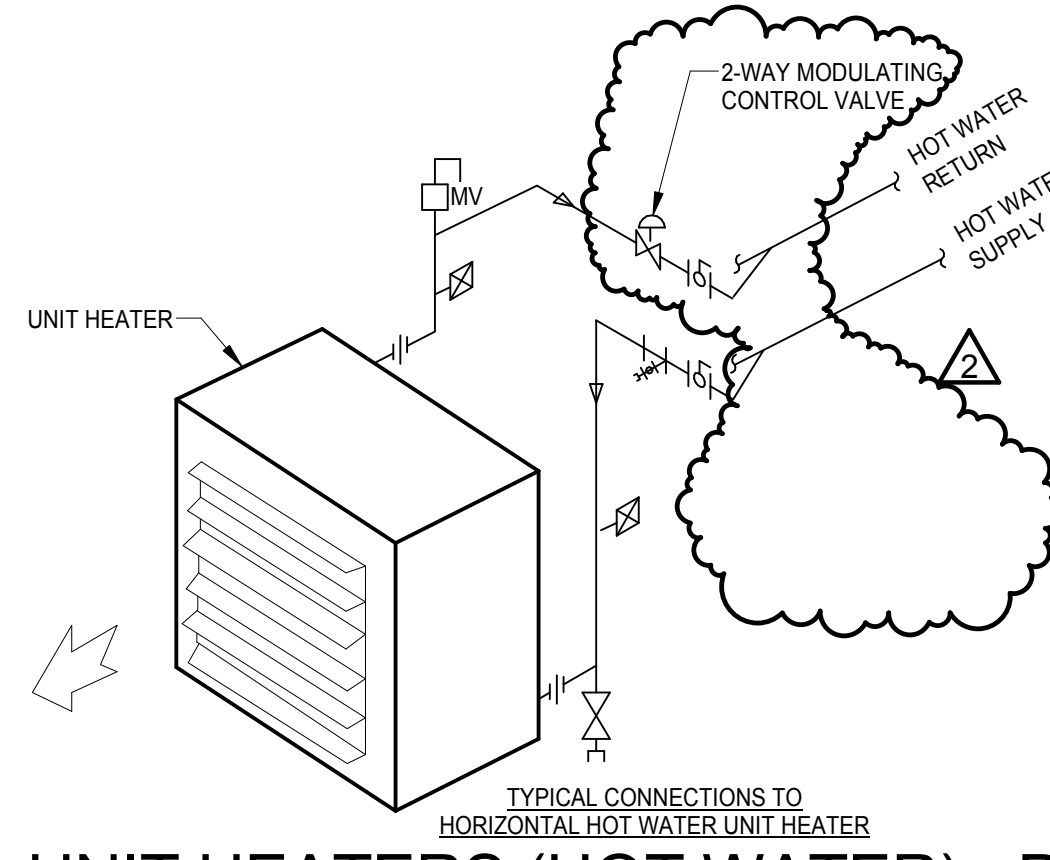

## 4 UNIT HEATERS (HOT WATER) - PIPING CONNECTIONS

NTS

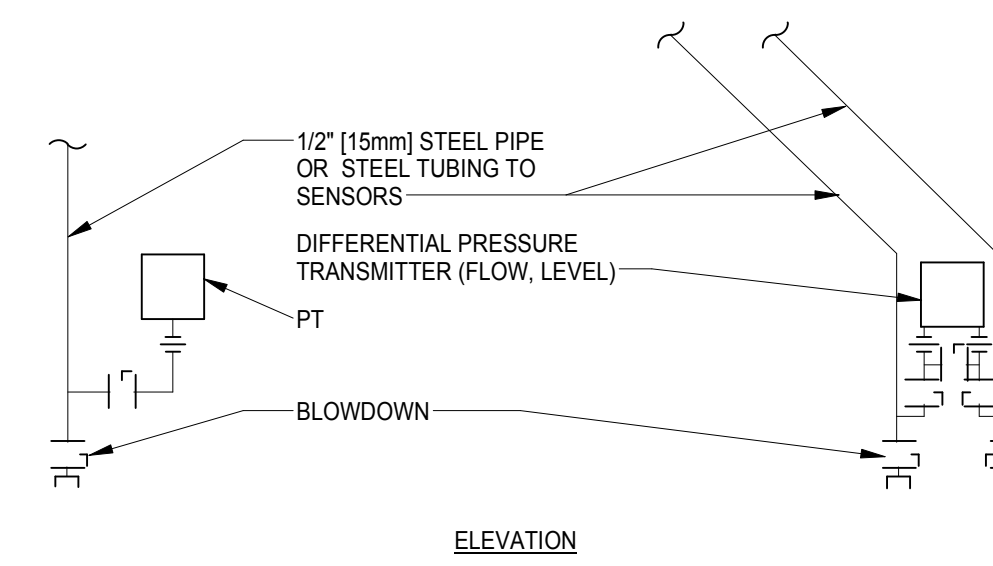

NOTES:

1. INSTALLATION OF SENSORS AND TRANSMITTERS SHALL CONFORM TO RECOMMENDATIONS OF MANUFACTURERS OF TRANSMITTERS.

## 8 PRESSURE TRANSMITTER INSTALLATION

NTS


Amendment 04	06-10-2015
Revisions:	Date



SPS BASEMENT ADDITION

2121 LAKE AVE., FORT WAYNE, IN 46805

ARCHITECT/ENGINEERS:

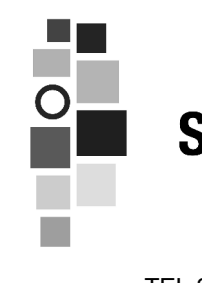

7260 SHADELAND STATION  
INDIANAPOLIS, IN 46256-3957  
TEL 317.547.5580 FAX 317.543.0270  
www.structurepoint.com

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8250 Haverstick Road  
Suite 285  
Indianapolis, IN 46240  
317.638.8383

CONSULTANTS:

Drawing Title  
MECHANICAL PIPING DETAILS

Approved: Project Director

Project Title  
SPS BASEMENT ADDITION

Location  
2121 LAKE AVE., FORT WAYNE, IN 46805

Date  
08/15/2014

Checked  
SWD

Drawn  
RAC

Project Number  
2010.00629


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Drawing Number  
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Office of  
Construction  
and Facilities  
Management


VA Department of  
Veterans Affairs

three inches = one foot  
one and one half inches = one foot  
one inch = one foot  
three quarters inch = one foot  
three eighths inch = one foot  
one quarter inch = one foot  
one eighth inch = one foot  
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6/9/2015 9:51:48 AM  
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## INDIRECT GLYCOL MAKE-UP SYSTEM (PIPING & CONTROLS)

1  
NTS

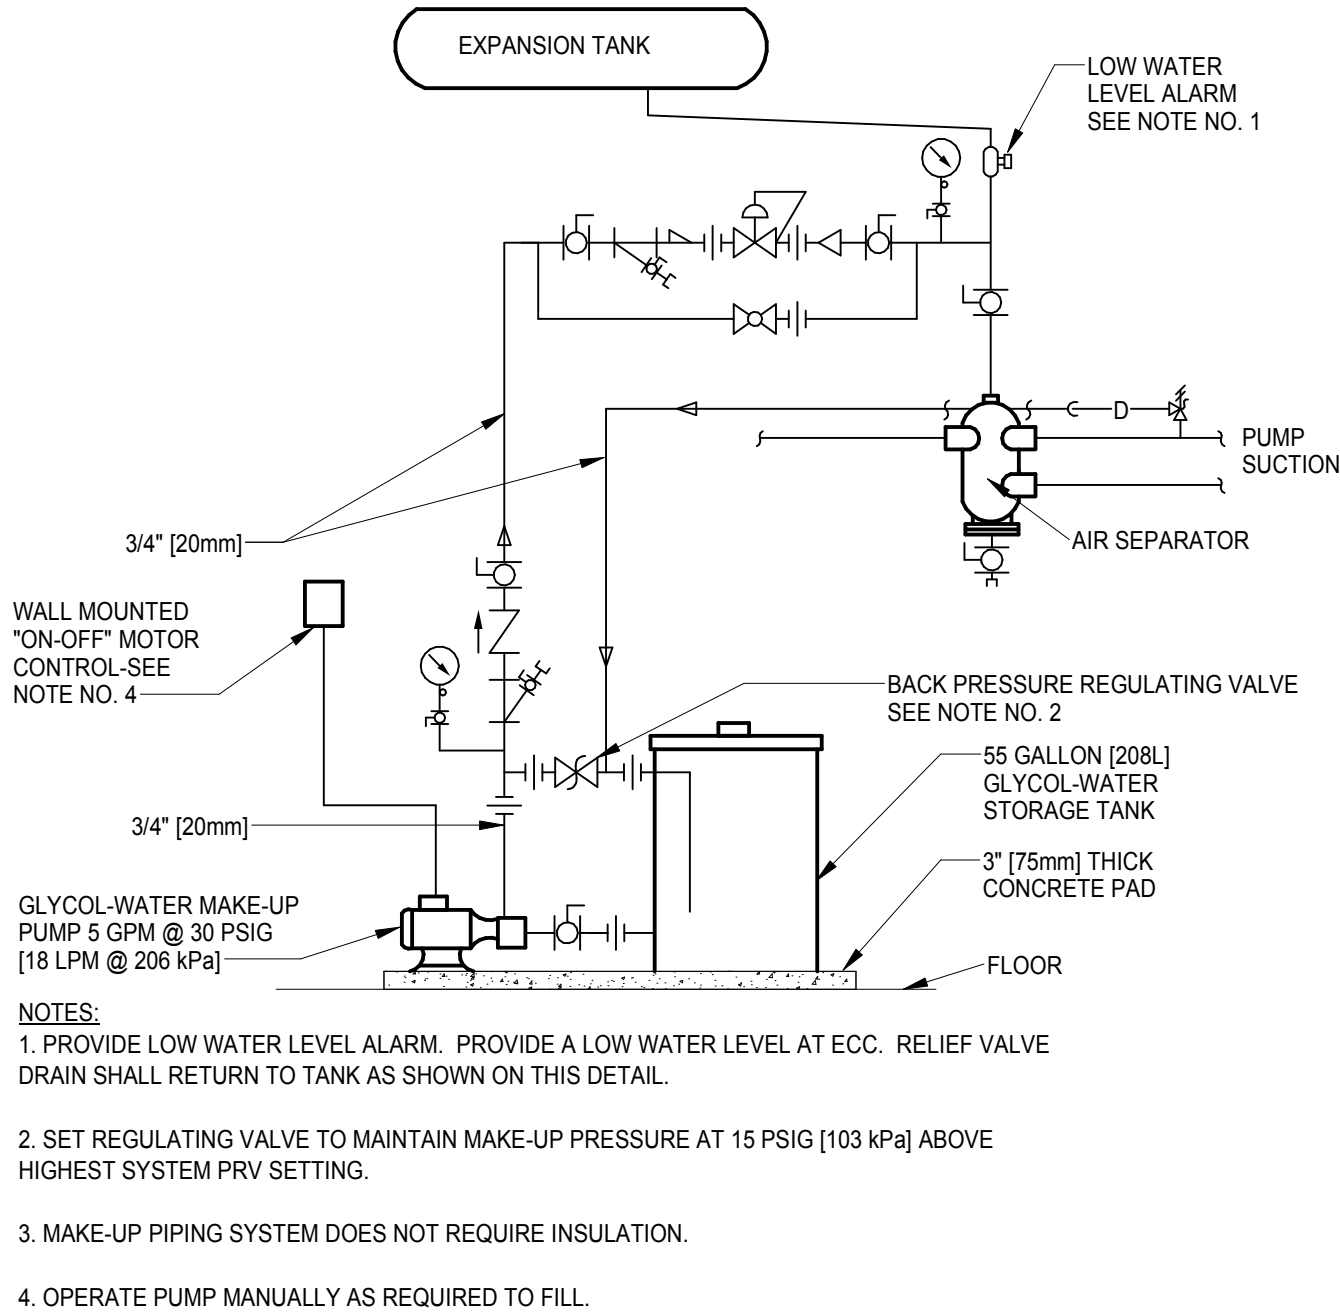


MAXIMUM PIPE/TUBING SUPPORT SPACING																							
NOM. SIZE	IN.	THRU 3/4	1	1 1/4	2	2 1/2	3	4	5	6	8	10	12	14	16	18	20	24					
PIPE	FT.	[2100]	[2100]	[2100]	[2700]	[3000]	[3400]	[3700]	[4100]	[4600]	[5200]	[5800]	[6700]	[7600]	[8200]	[8500]	[9100]	[9600]					
TUBING	FT.	[1500]	[1800]	[2100]	[2400]	[2700]	[3000]	[3700]	[4000]	[4100]	[4900]	-	-	-	-	-	-	-					

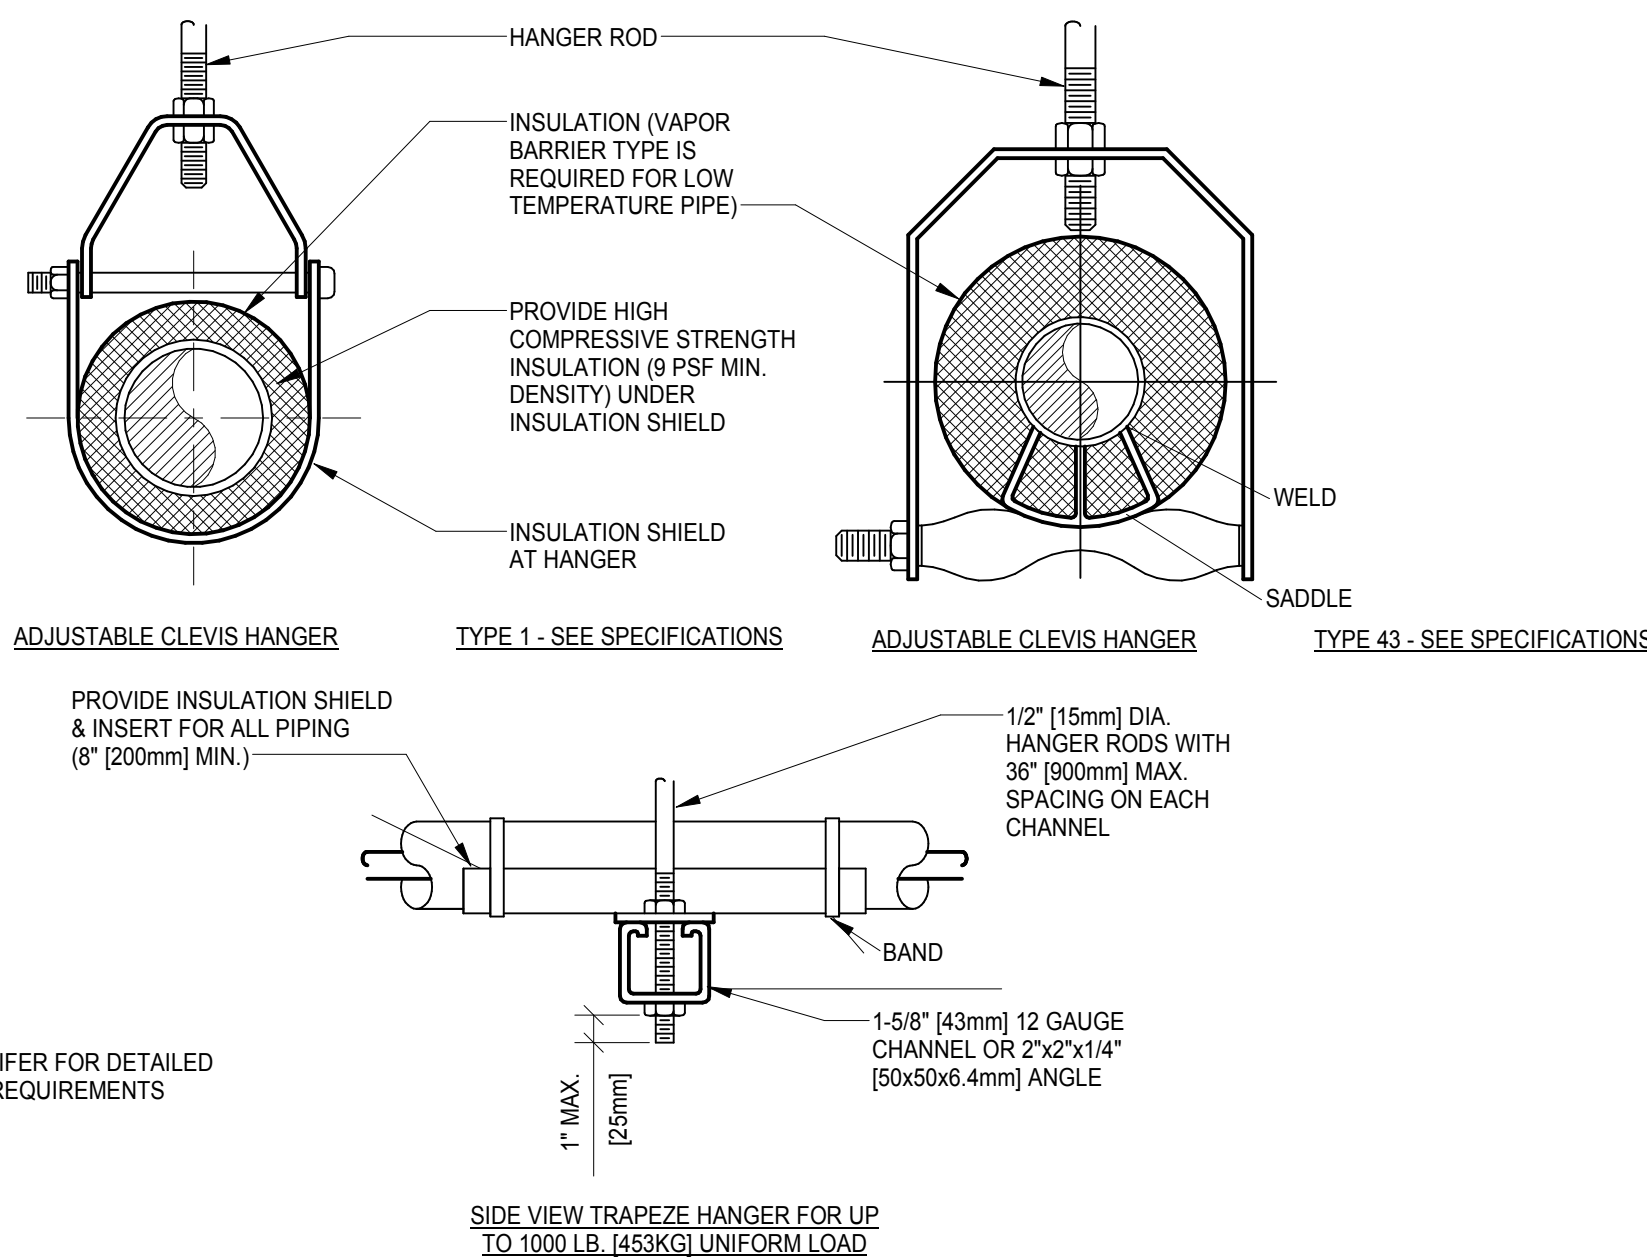NOTE: FOR TRAPEZE HANGER TAKE SPACING OF SMALLEST SIZE ON TRAPEZE.


## PIPE HANGERS

NTS

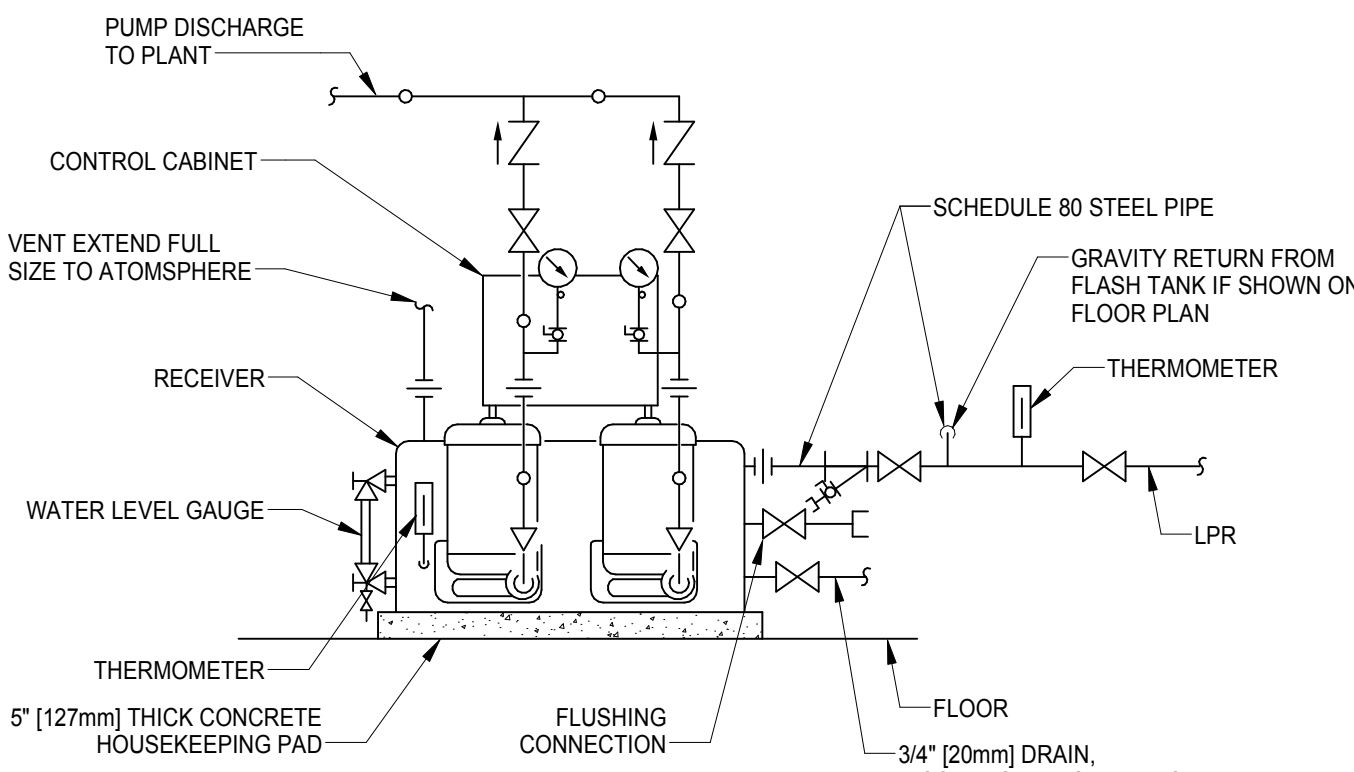


## CONDENSATE PUMPS - PIPING CONNECTION

8  
NTS

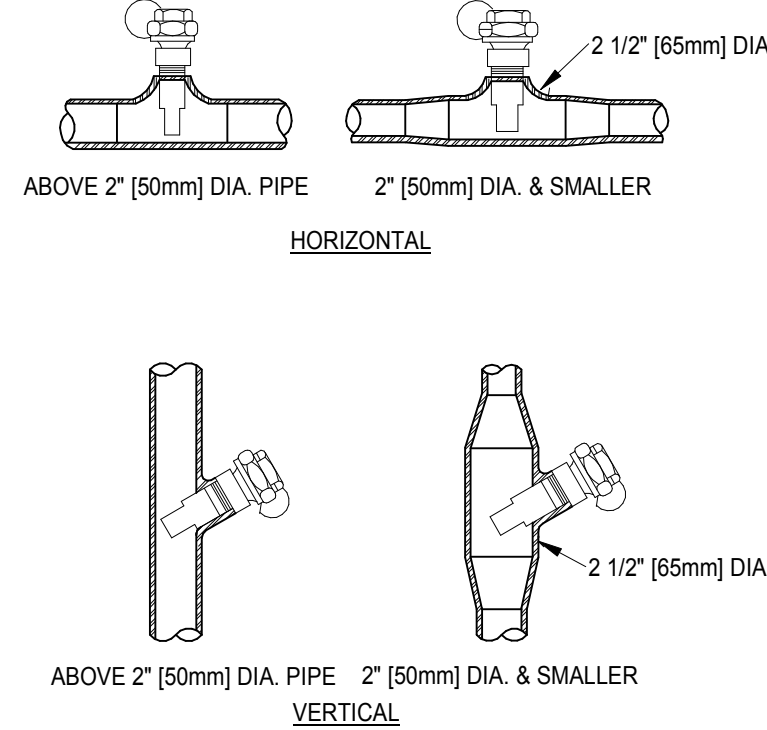


## INSTALLATION OF THERMOMETER WALLS

NTS

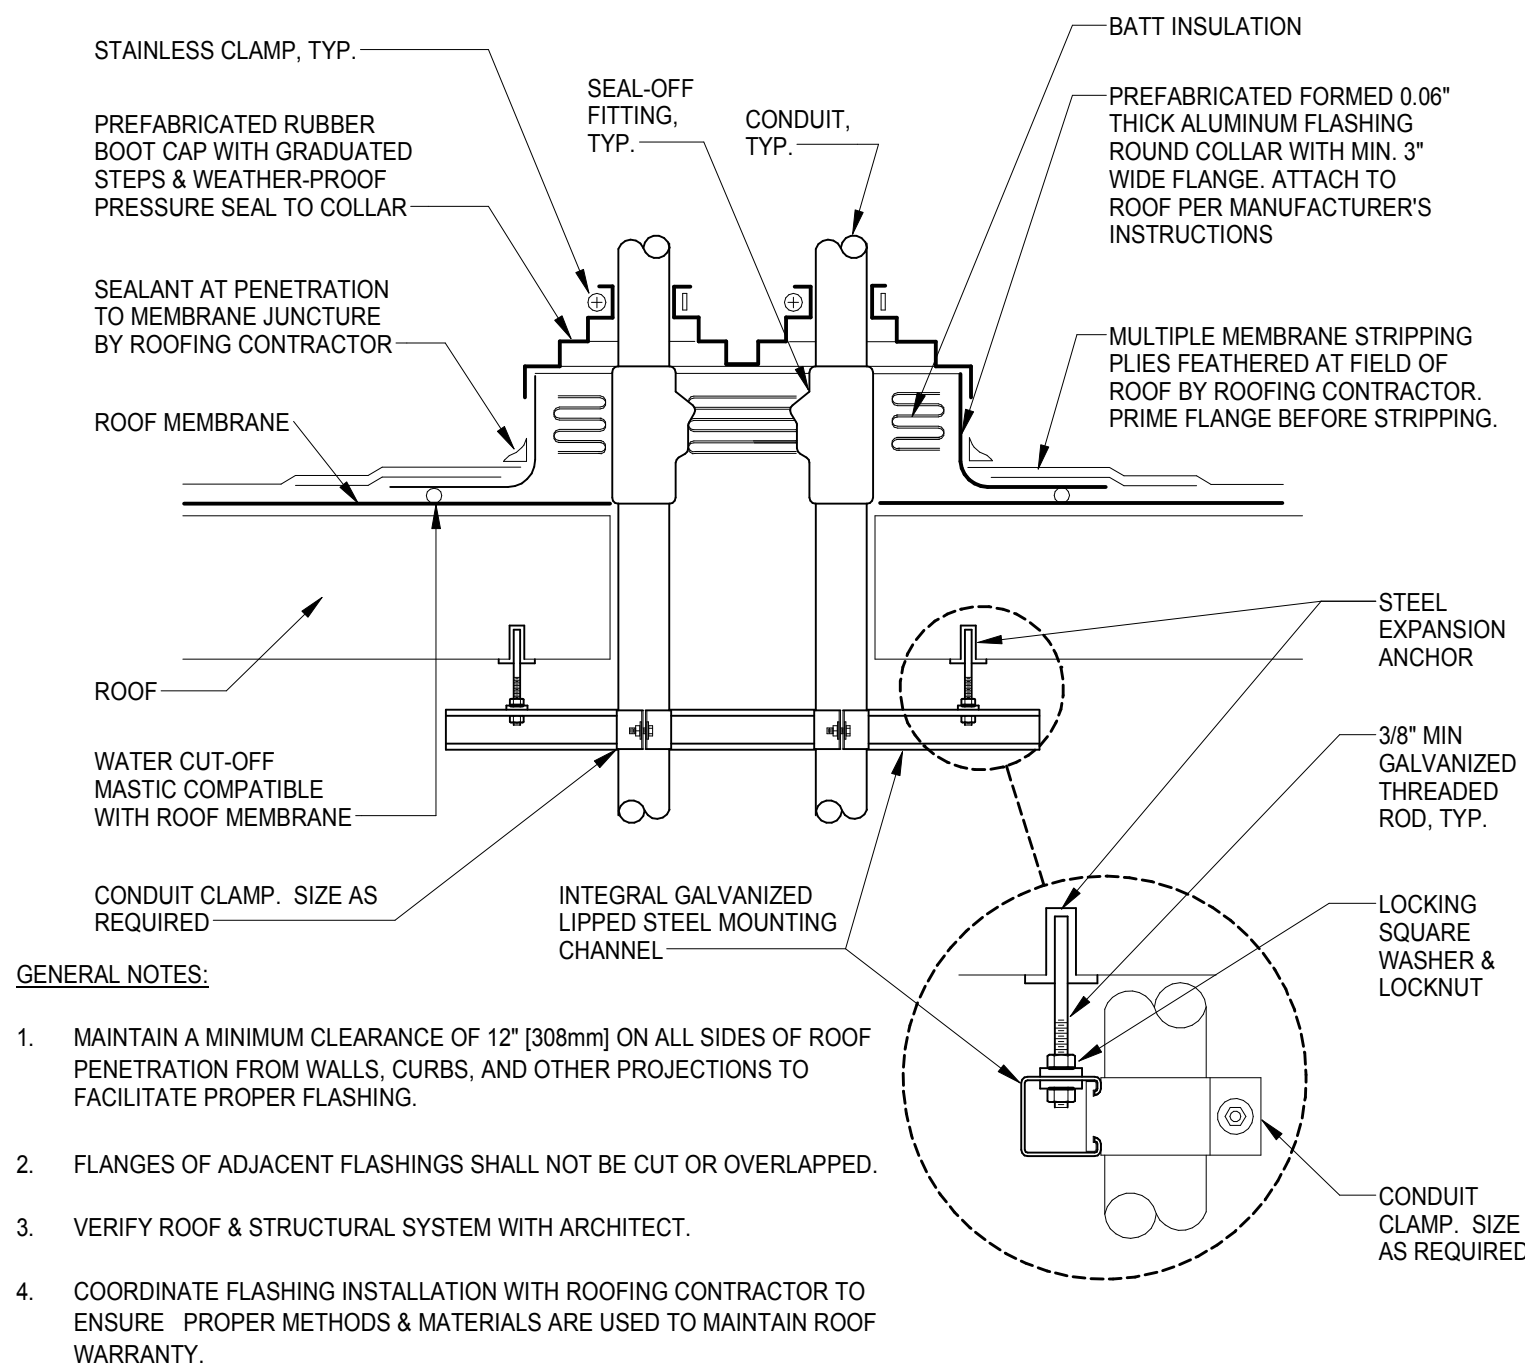


## ROOF PENETRATION DETAIL

NTS

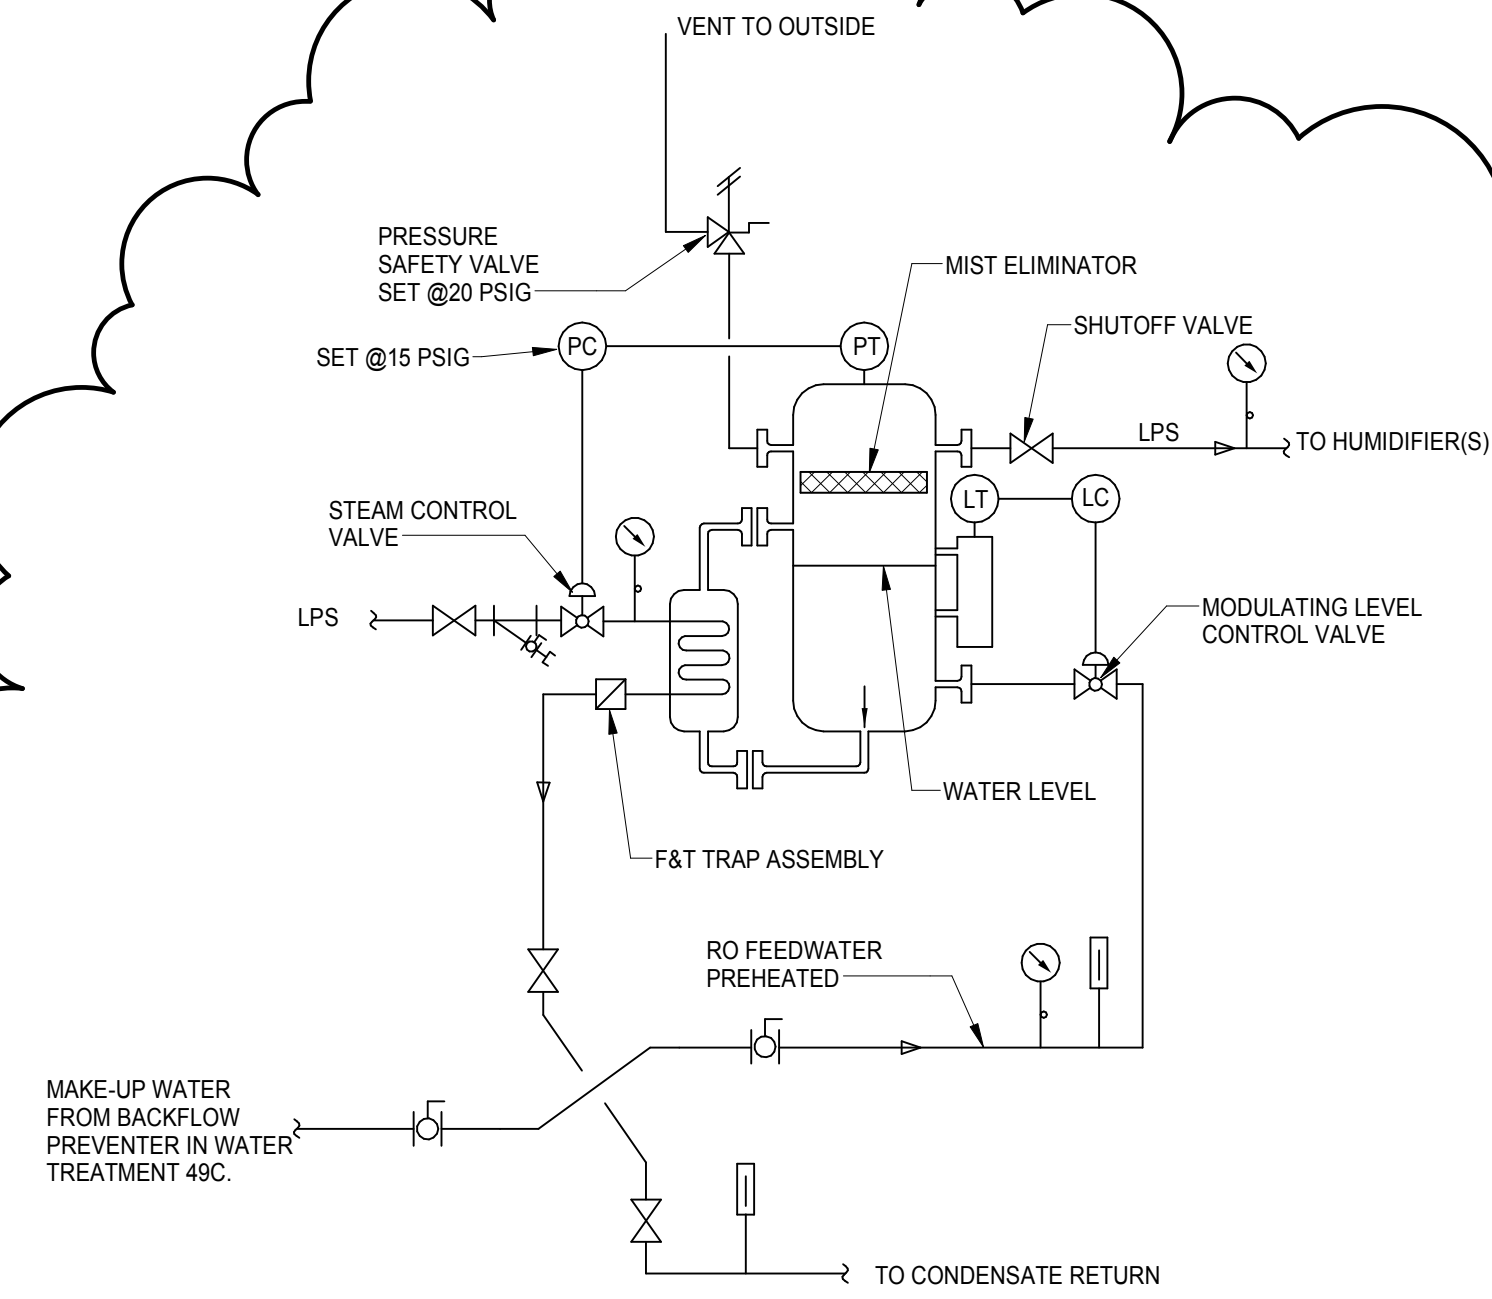


## CLEAN STEAM GENERATOR

NTS

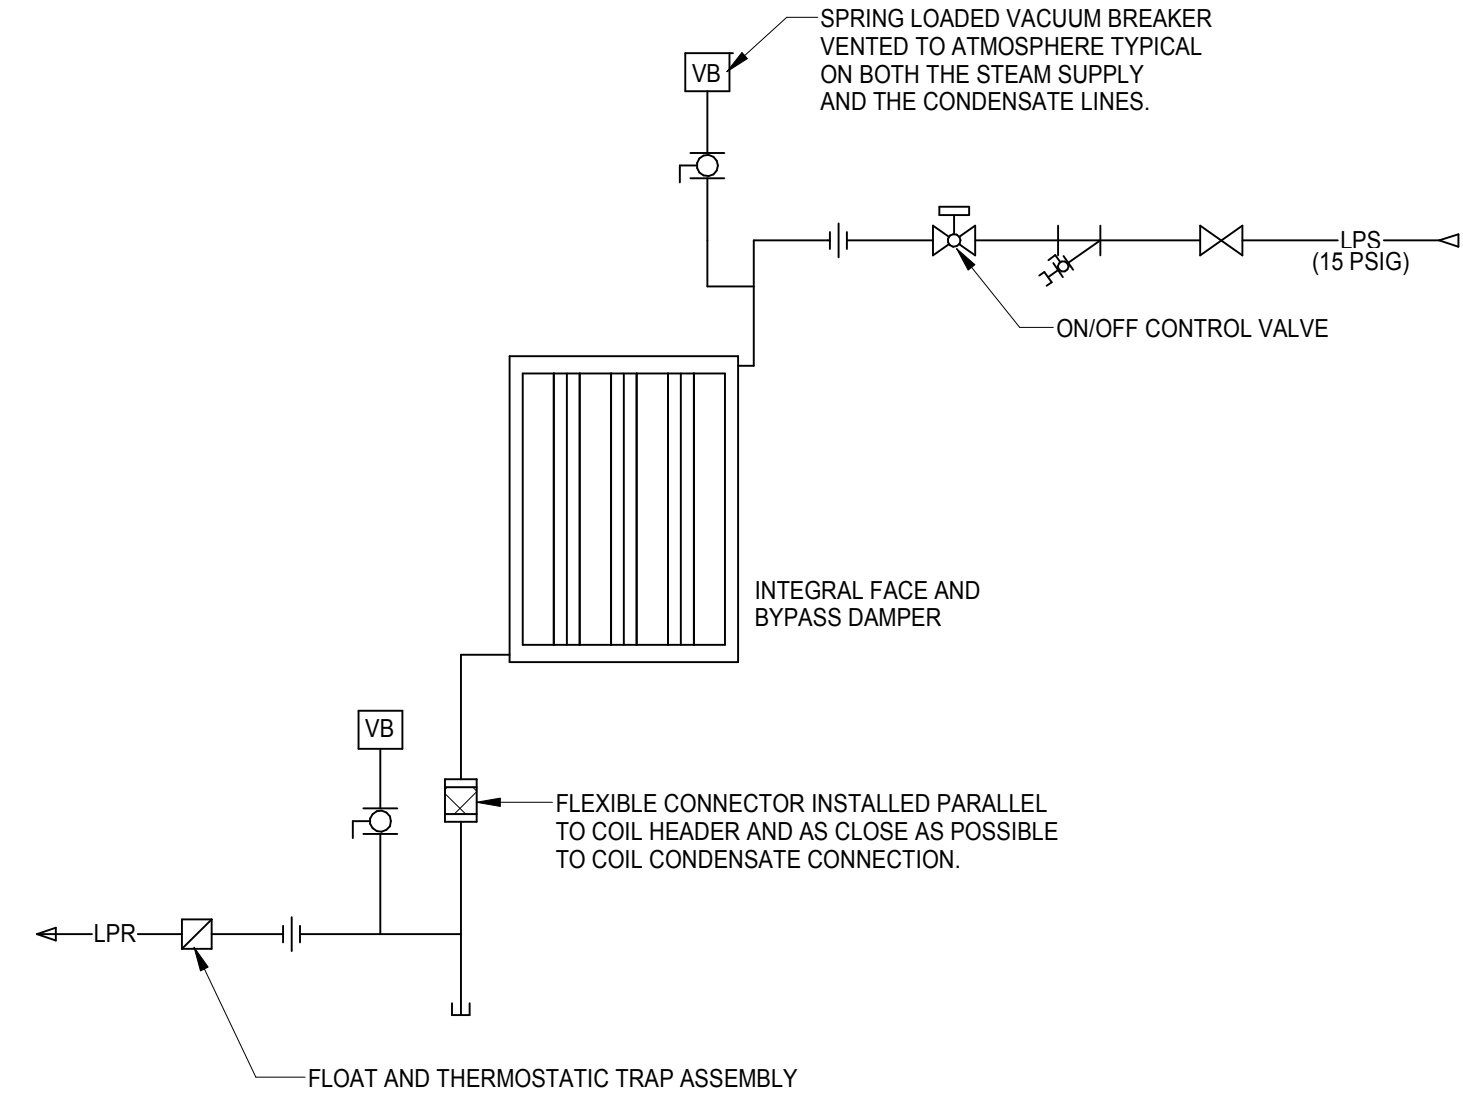

## INTEGRAL FACE AND BYPASS STEAM COIL DETAIL

NTS

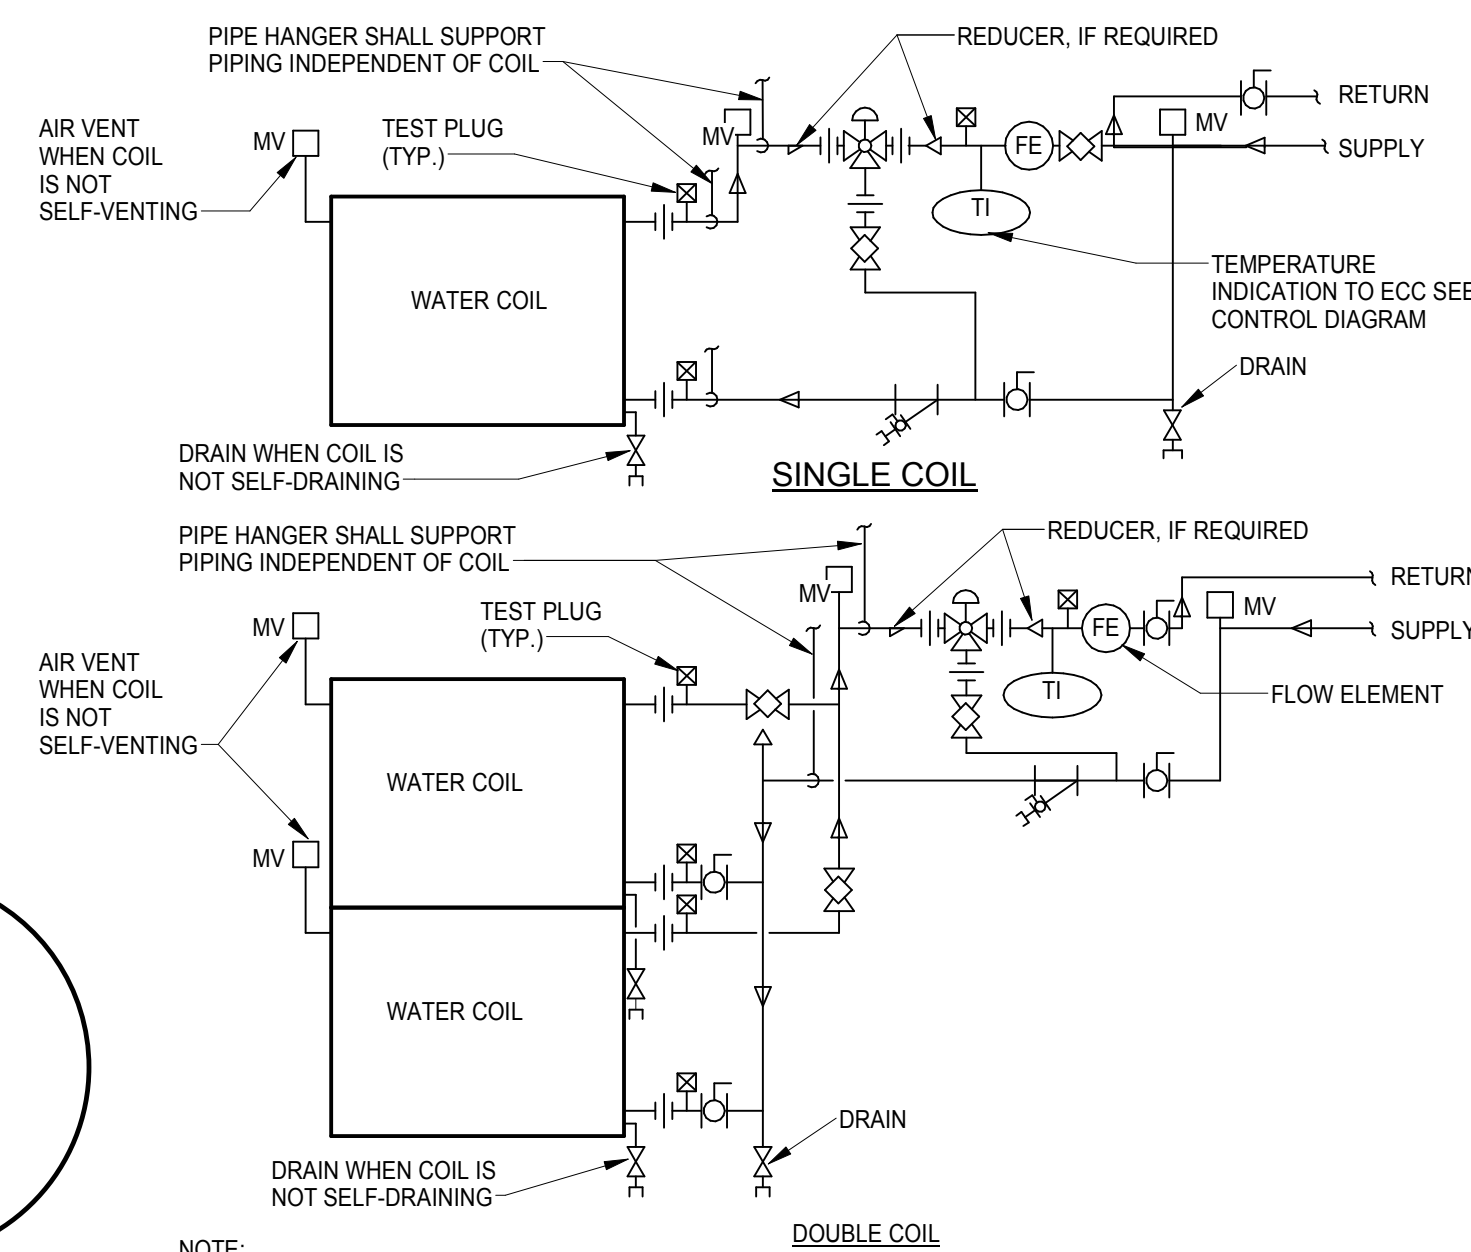

NOTE:


- WHEN COIL IS INCLUDED IN CASING MOUNTED ON VIBRATION ISOLATORS THE FIRST 2 HANGERS FOR EACH PIPE SHALL BE SPRING & NEOPRENE TYPE. TYPE "H" FOR 4" (100mm); PIPE & SMALLER. TYPE "H-P" FOR 5" (125mm); PIPE & LARGER.
- PIPING SHALL BE INSTALLED IN SUCH MANNER THAT IT WILL NOT BLOCK THE SWING OR USE OF ACCESS DOORS OR PANELS; NEITHER SHALL IT BLOCK THE SERVICING OF FILTERS, VALES, OR EQUIPMENT.
- THE FLOW ELEMENT MAY BE INSTALLED IN THE SUPPLY PIPING IF THE REQUIRED MINIMUM UPSTREAM AND DOWNSTREAM DIMENSIONS CANNOT BE OBTAINED IN THE RETURN PIPING.

## WATER COILS - PIPING CONNECTIONS

NTS

100% CONSTRUCTION DOCUMENTS  
FULLY SPRINKLERED

### ARCHITECT/ENGINEERS:

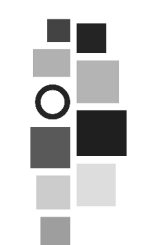

AMERICAN  
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INC.  
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