

|                             |         |
|-----------------------------|---------|
| RECORD DRAWINGS             | 6/16/95 |
| INFORMATION BULLETIN NO.108 | Date    |

These records drawings have been prepared based on information furnished by others. The architect/engineer has not verified the accuracy of this information and shall not be responsible for any errors or omissions which may be incorporated herein as a result.

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Breaking the  
DOMESTIC SITE PLAN  
LUMINARY AND SIGNAL

Project No. ED-PACIFIC NO. J  
ED-PACIFIC NO. K  
ED-PACIFIC NO. L  
ED-PACIFIC NO. M  
ED-PACIFIC NO. N  
ED-PACIFIC NO. O  
ED-PACIFIC NO. P  
ED-PACIFIC NO. Q  
ED-PACIFIC NO. R  
ED-PACIFIC NO. S  
ED-PACIFIC NO. T  
ED-PACIFIC NO. U  
ED-PACIFIC NO. V  
ED-PACIFIC NO. W  
ED-PACIFIC NO. X  
ED-PACIFIC NO. Y  
ED-PACIFIC NO. Z  
Approved: Area Project Manager  
Building Number 847 Checked 1P WD  
Location VANC Park Area, CA  
Comments

Date 24 JULY 1995  
Project No. 640-EDC  
Page No. 347-ELIO  
Sheet No. 141 of 172



#### NOTES:

- ① USE THIN CONDUCTORS AND #10 GROUND FOR ALL SITE LIGHTING CIRCUITS.
- ② USE 1" CONDUIT FOR ALL SITE LIGHTING CONDUCTORS.
- ③ PROVIDE PHOTOCELL FIXTURE TO TURN ON/OFF THE CIRCUIT.
- ④ LUMINAIRE HAS BEEN REMOVED.
- ⑤ CIRCUIT NOT CONTROLLED BY PHOTOCELL.

#### SUPPLEMENTARY LEGEND


- NEW LUMINAIRE
- LUMINAIRE PREVIOUSLY REMOVED AND NOT TO BE RESTORED
- LC EXISTING CONDUIT AND CONDUCTORS
- MC EXISTING UNDERGROUND CONDUIT, REMOVE CONDUCTORS & ABANDON CONDUIT
- HJ NEW CONDUIT AND CONDUCTORS
- EXISTING LUMINAIRE
- POWER PULLBOX, 12" w x 27" L
- LIGHTING PULLBOX, 12" w x 22" L




SCALE 1"=50'


0 30' 60' 120'



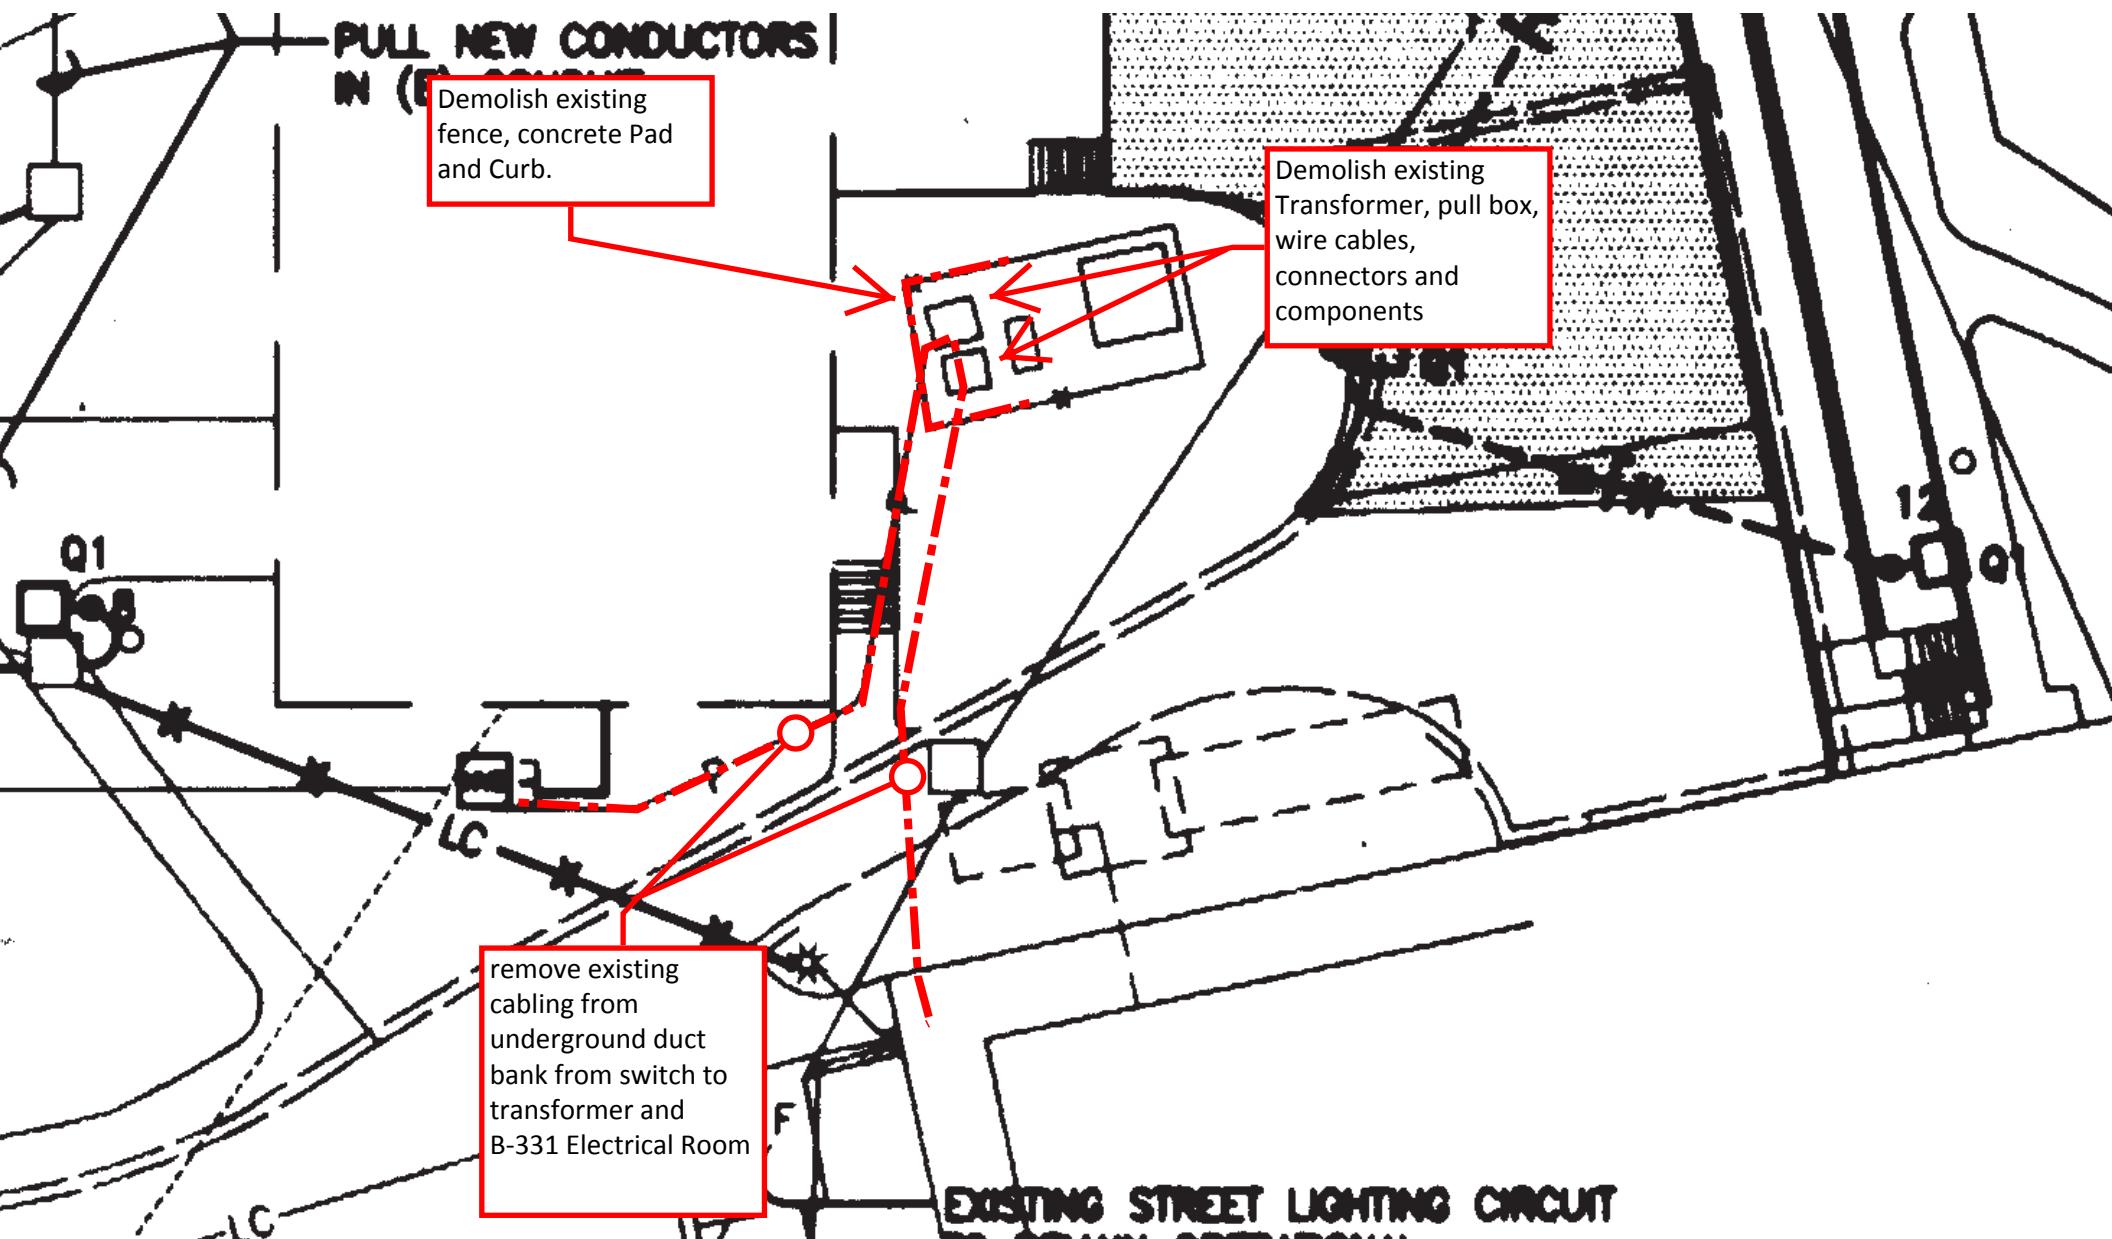



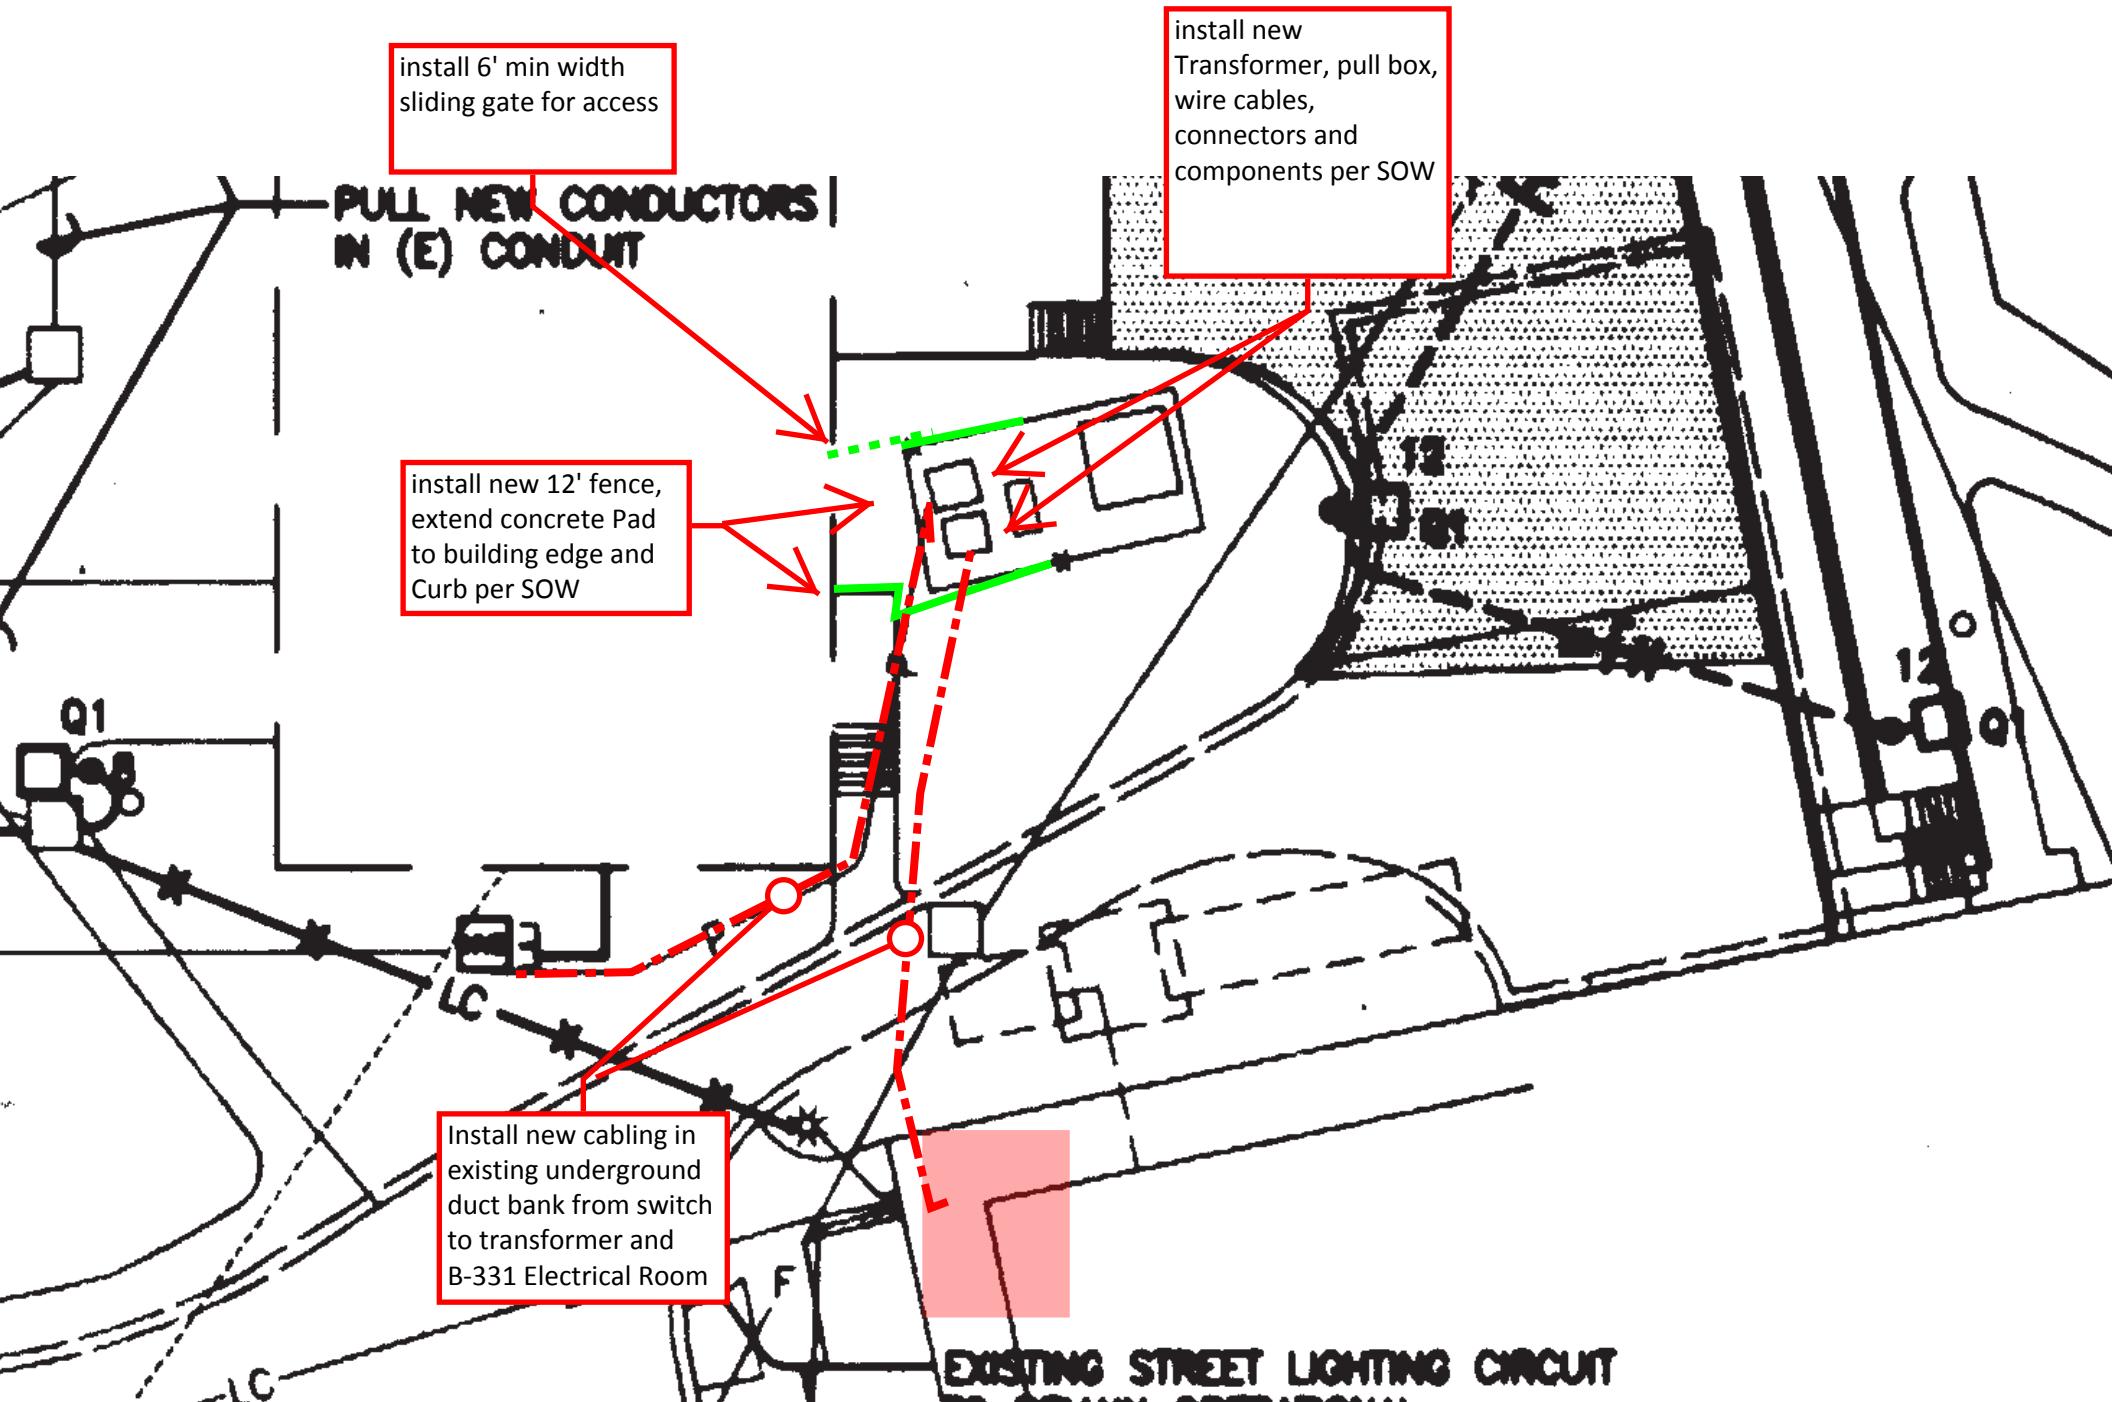


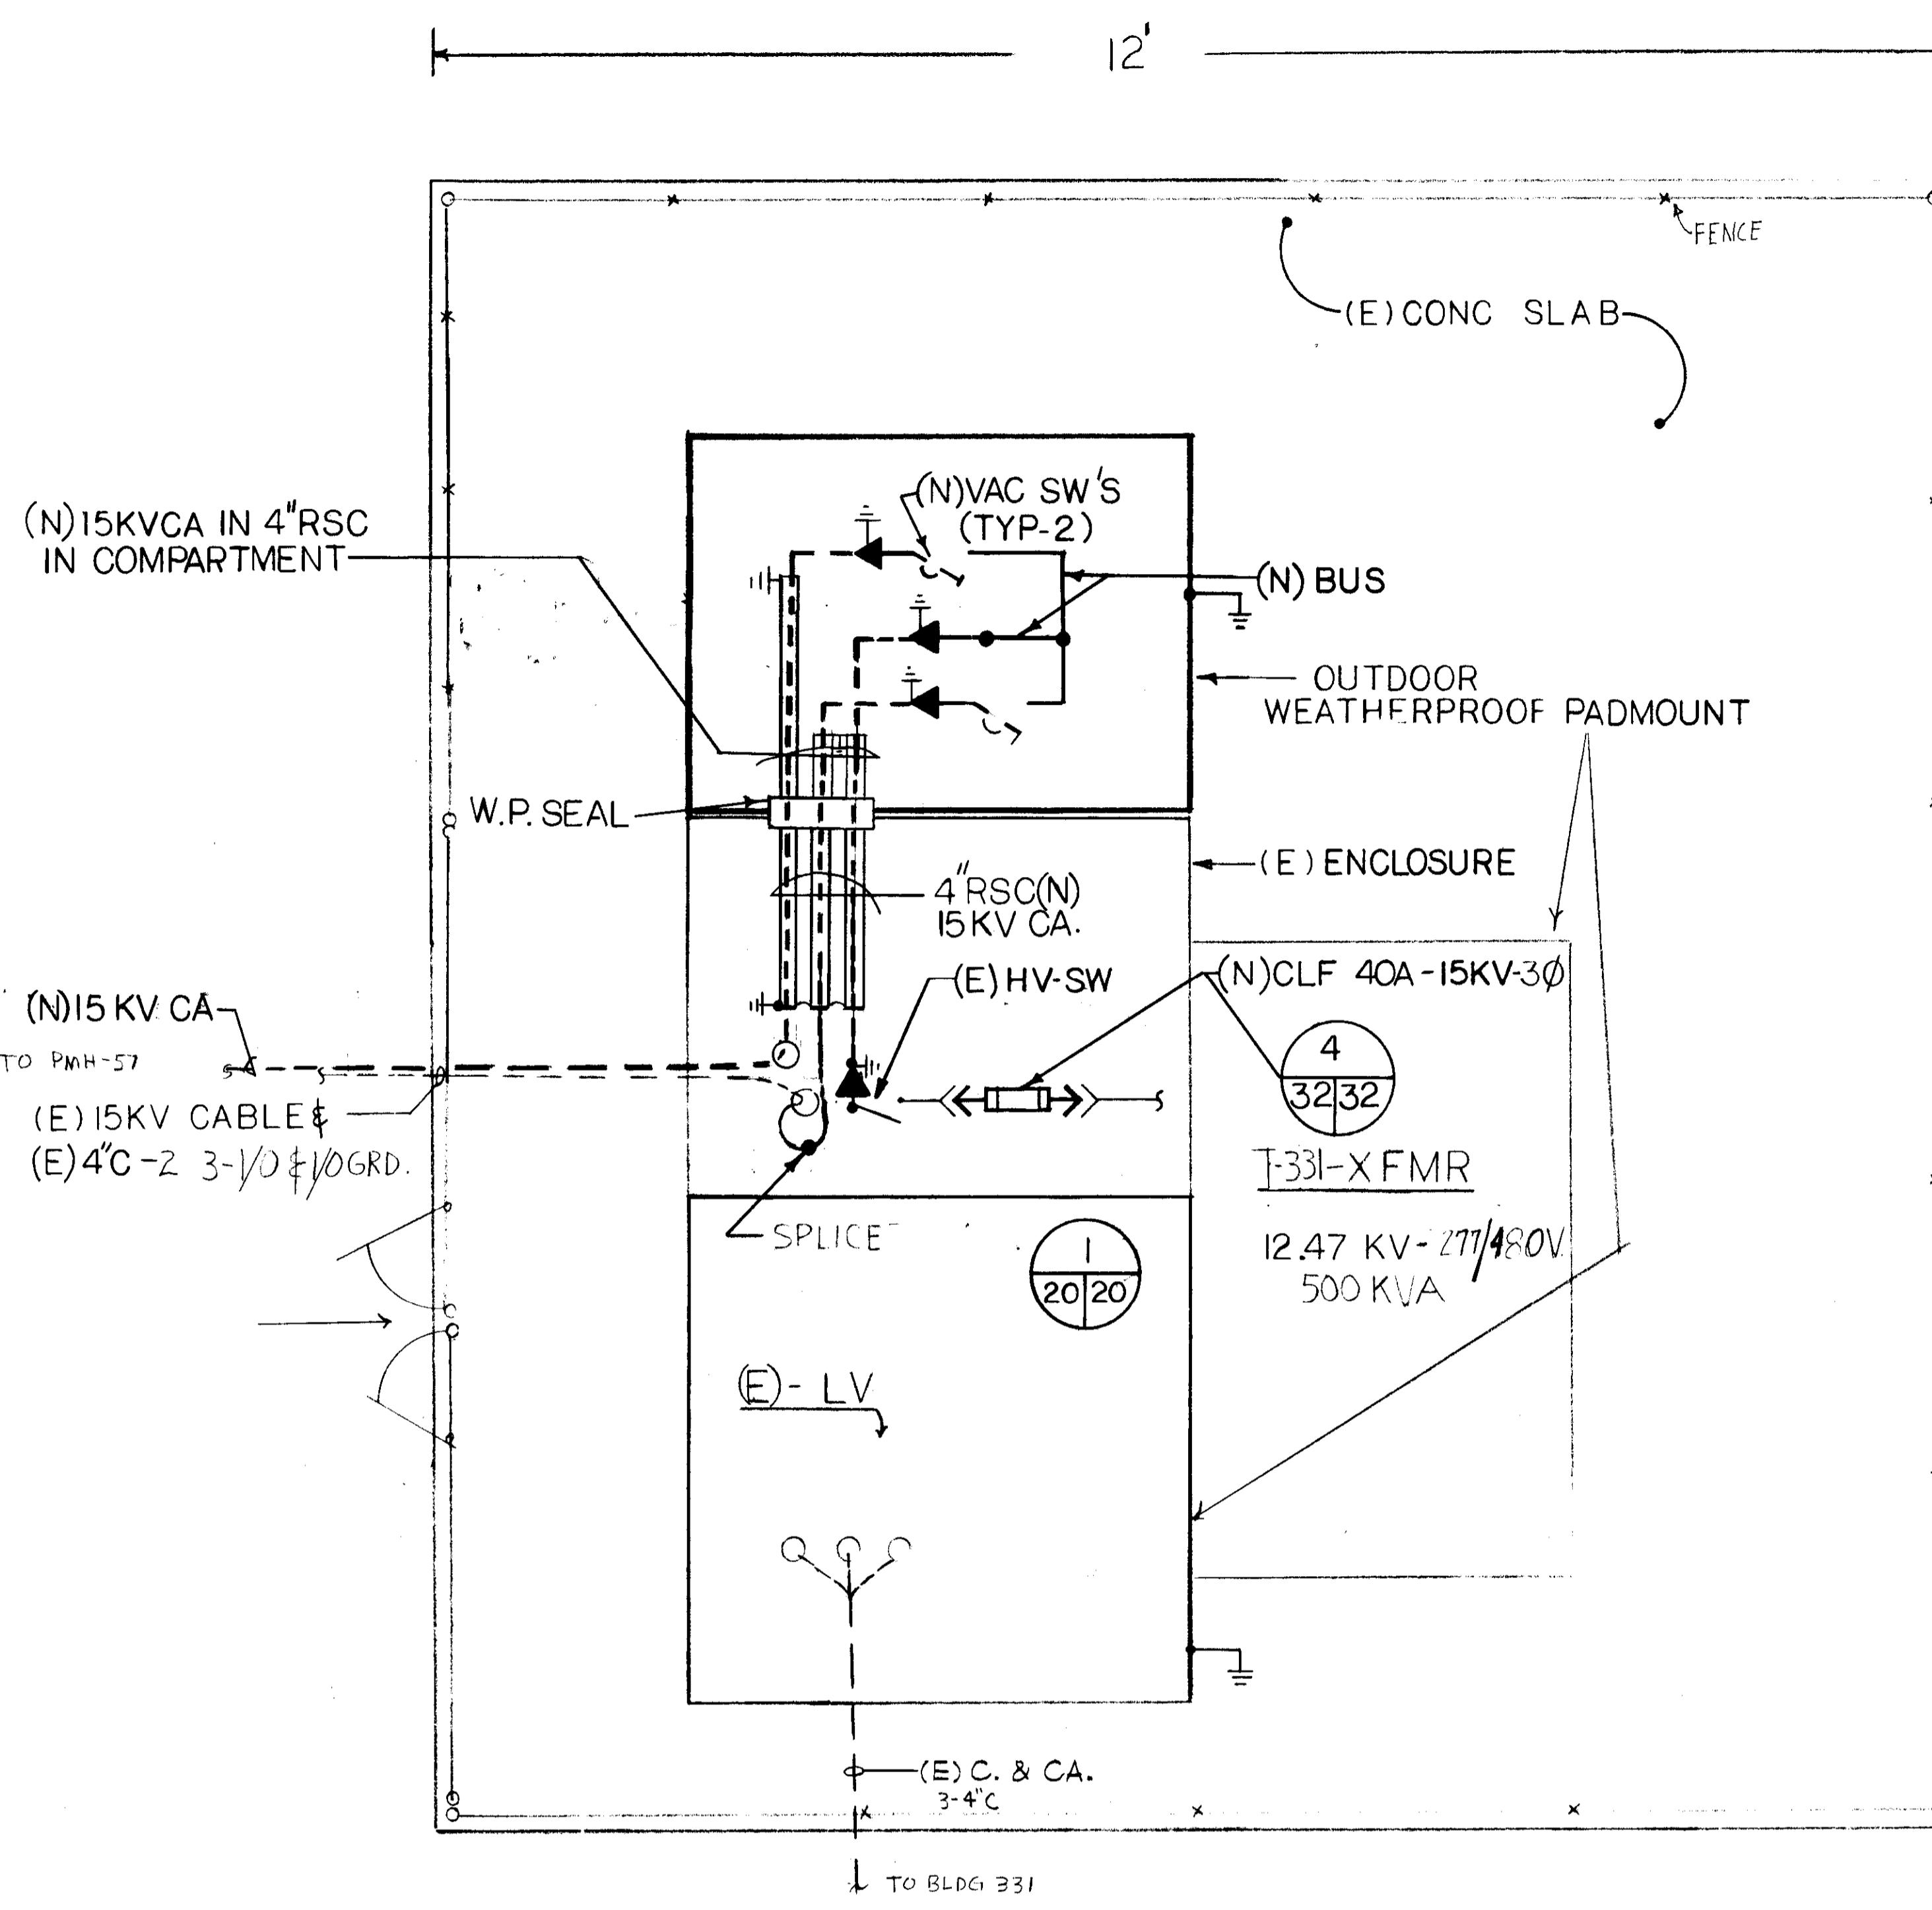


### HIGH RESISTANCE GROUNDING NETWORK

WIRE # TERM #  
 17 1 1\* 22 TO ANNUNCIATOR VIA CONTROL CABLE SEE DIAGRAM  
 18 2 1\* 14 TO GEN. CONTROL PANEL (TBI-26) AT RIGHT  
 13 3 } 2# 12'S TO 110 V PANEL CKT. IO  
 14 4 }  
 12 5 }  
 10 6 }  
 4 7 \* 10 TO UFER GROUND  
 5 8 \* 10 TO (GEN. NEUTRAL)  
 9 9



### GENERATOR CONTROL PANEL TB-2

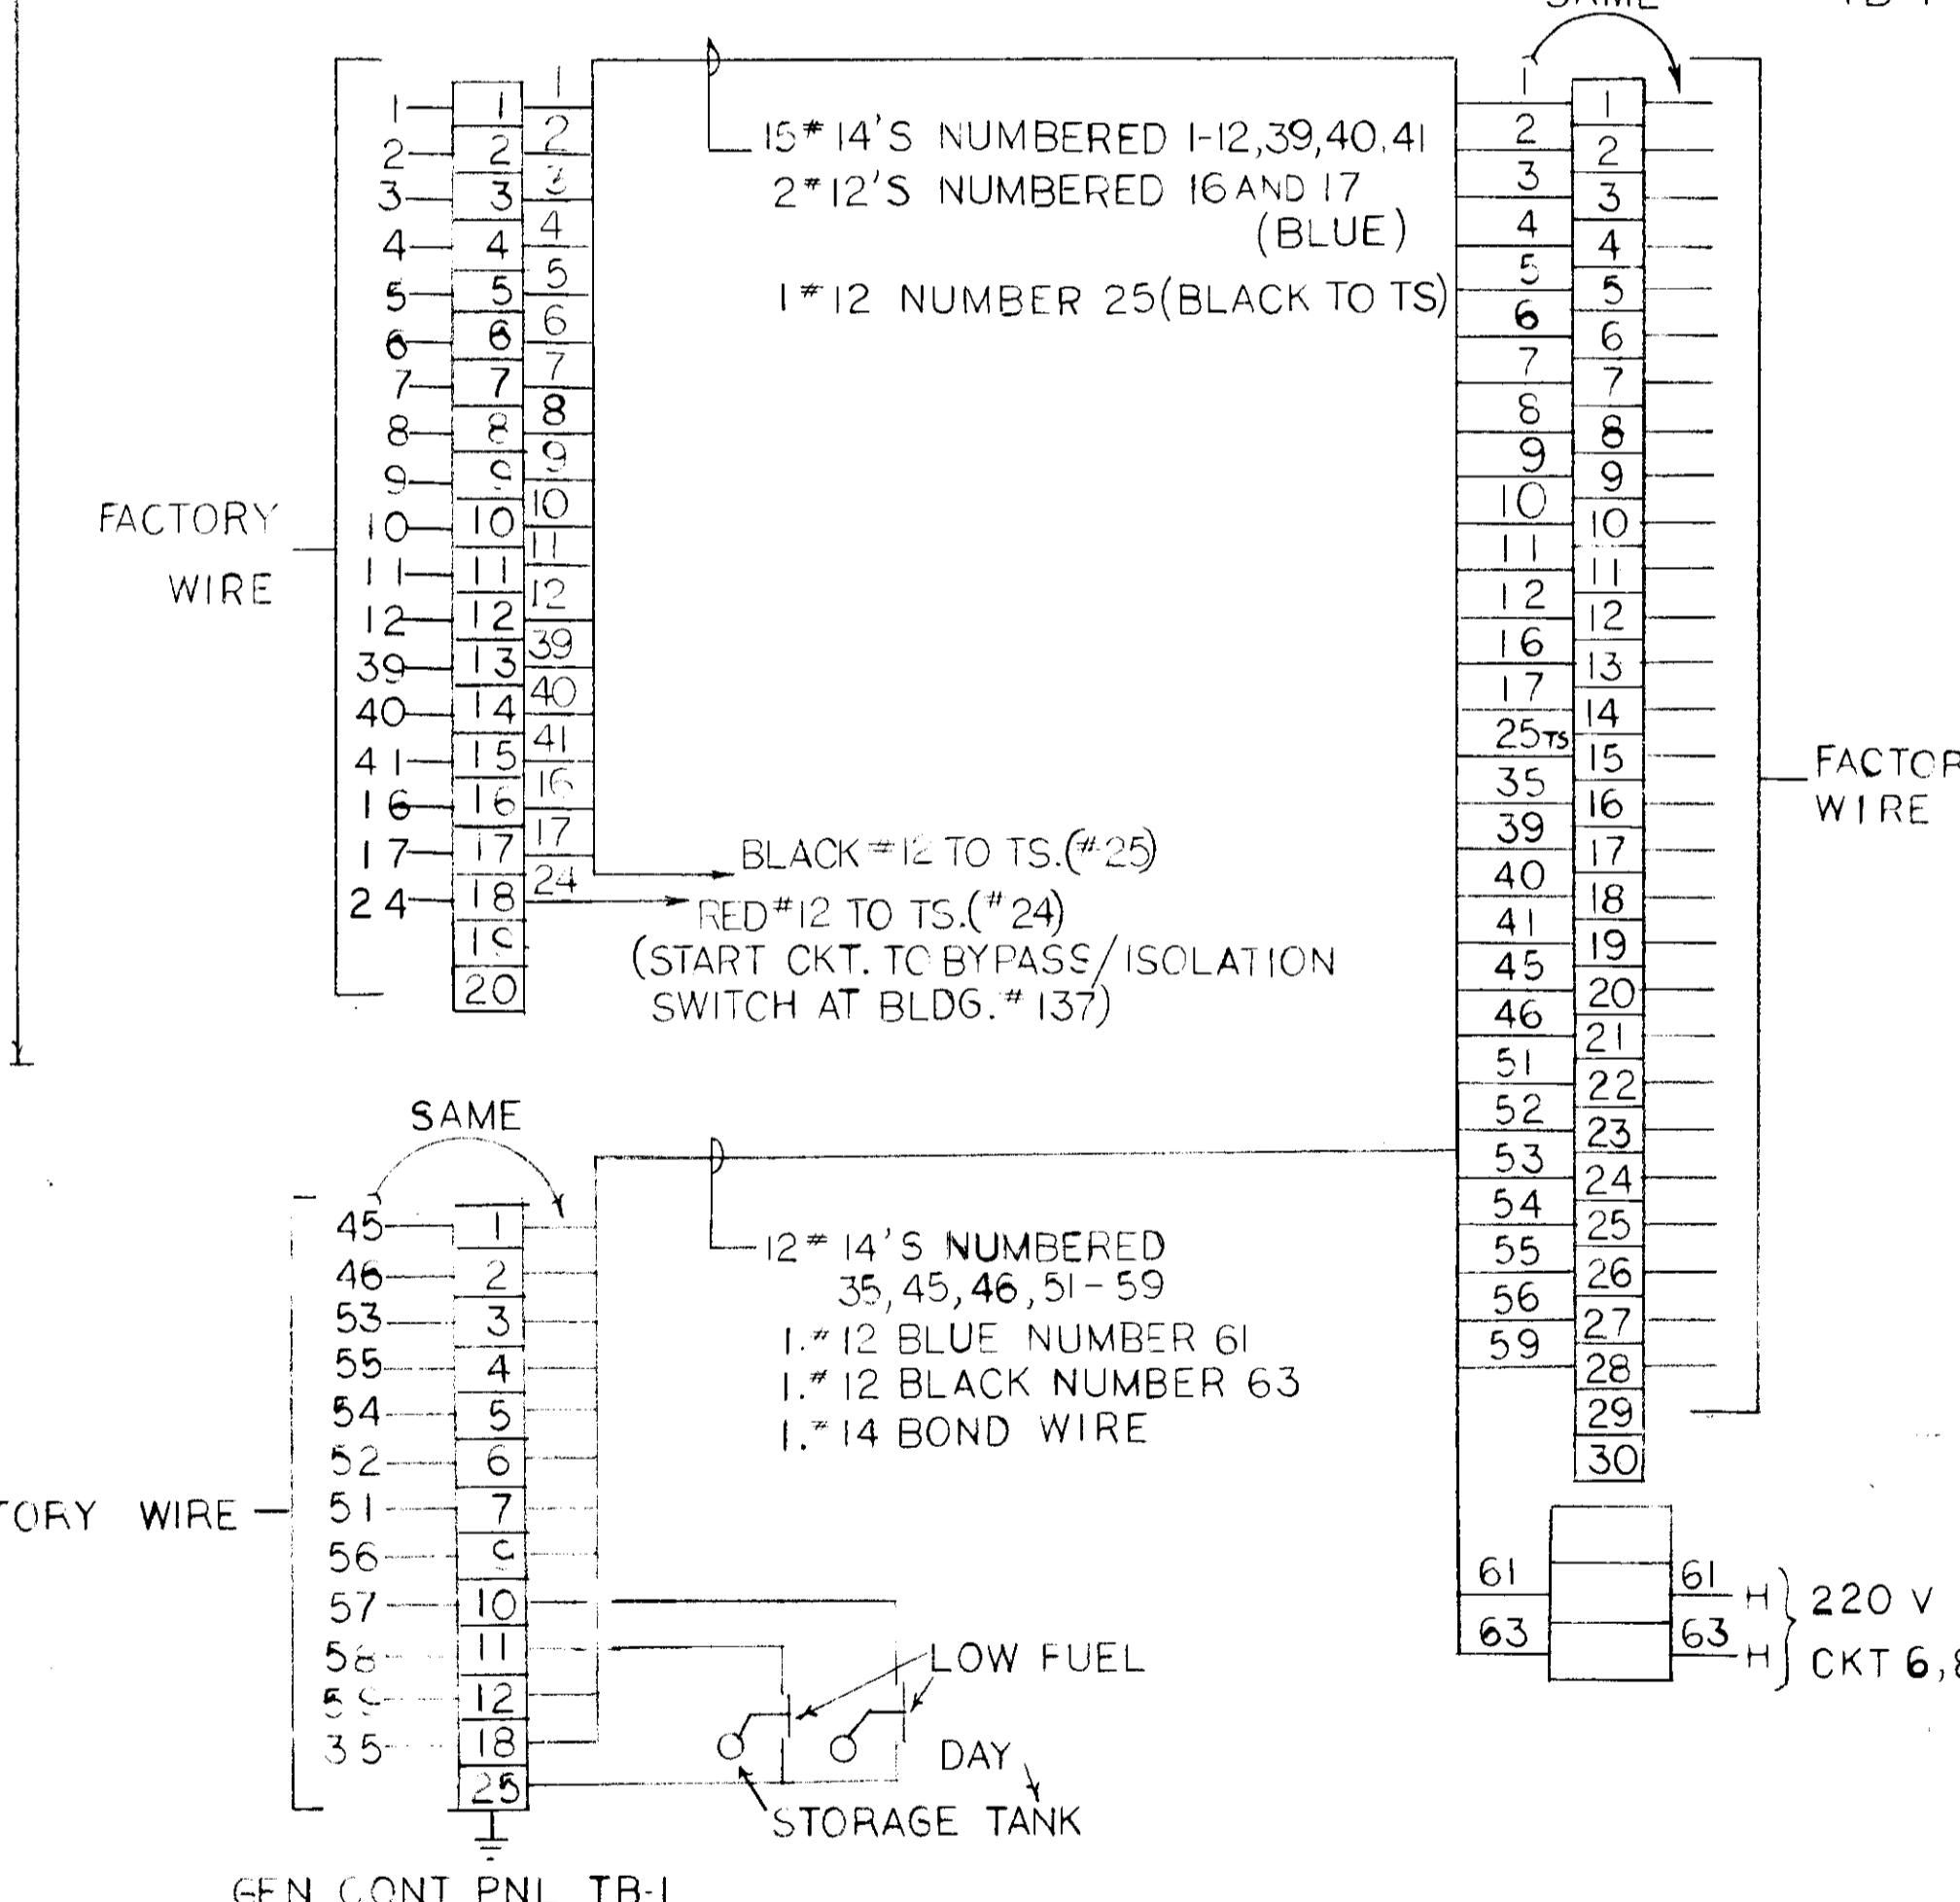

NEW SYSTEMS AND EQUIPMENT ARE INDICATED WITH HEAVY LINES.  
EXISTING SYSTEMS AND EQUIPMENT ARE SHOWN WITH LIGHTER LINES.  
EQUIPMENT AND SYSTEMS TO BE DEMOLISHED ARE HATCH-LINED.

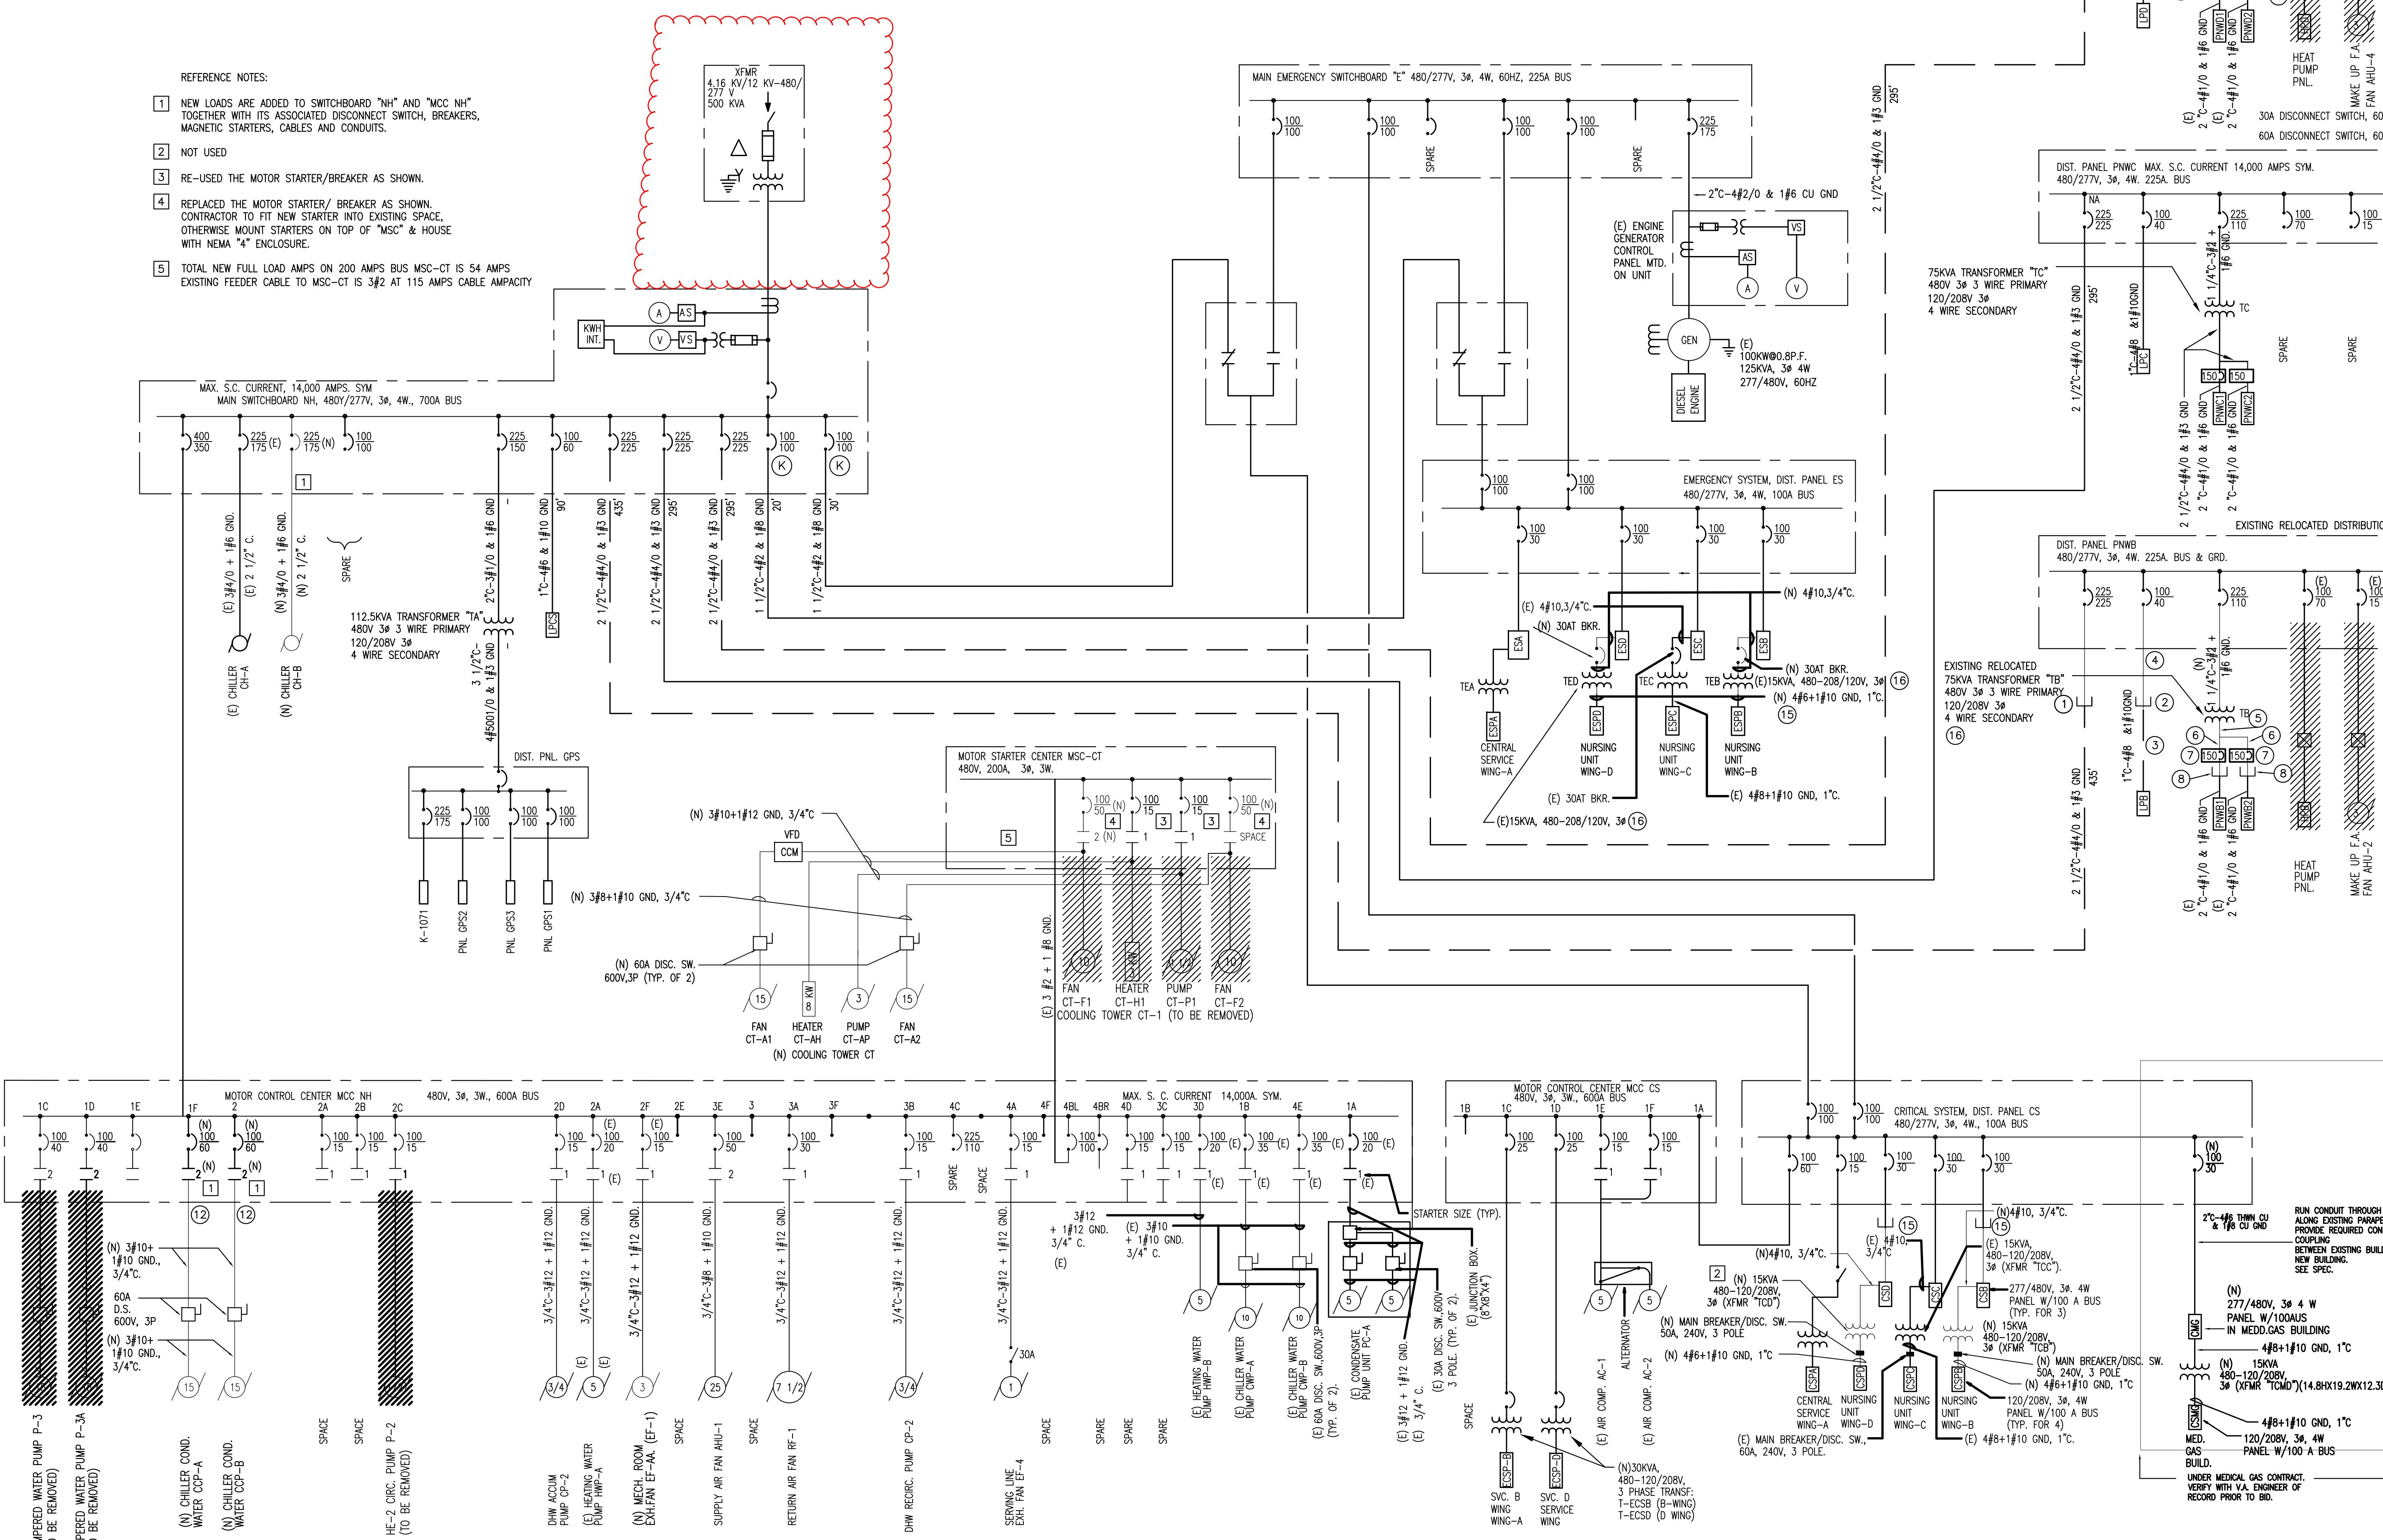

# SINGLE LINE DIAGRAM CONSTRUCTION

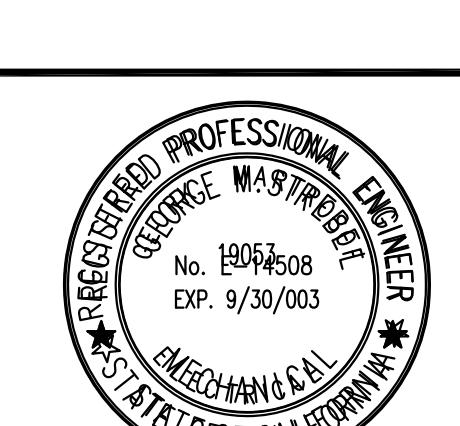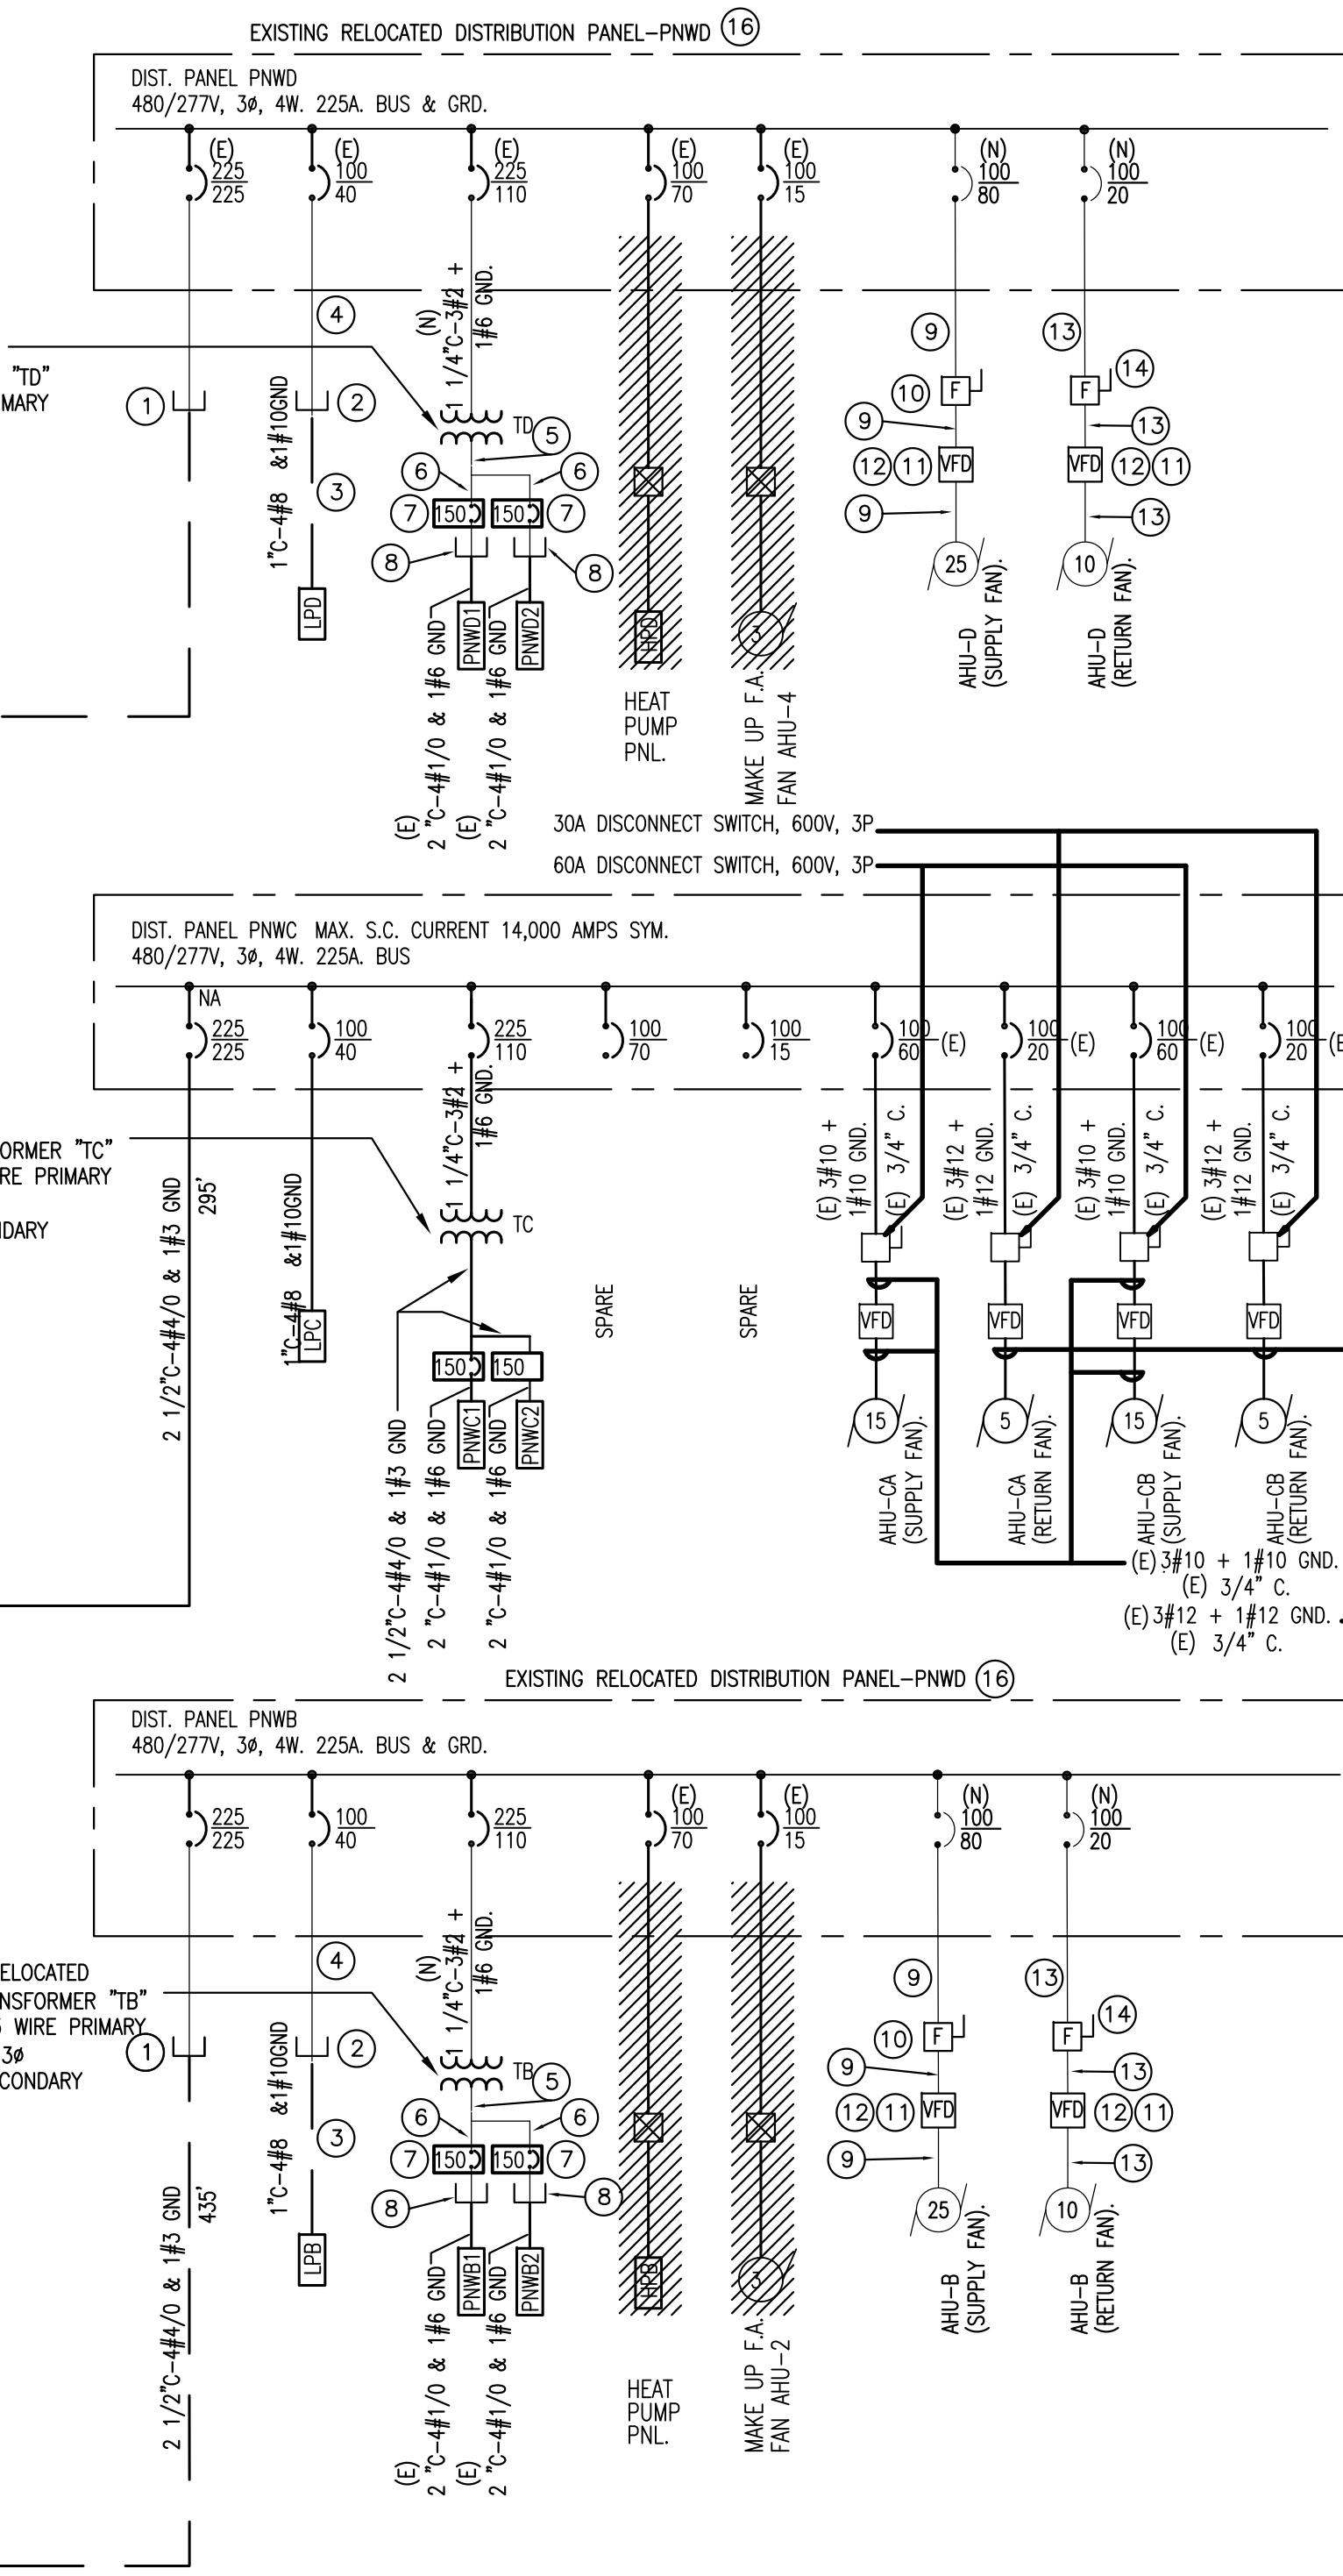

KEY PLAN

30" X 42"  
IT IS A REDUCED PRINT-  
SCALE REDUCED ACCORDINGLY

AREAS SHOWN ARE REPRESENTATIVE OF EXISTING CONDITIONS. SPECIFIC WORK WITHIN AREAS SHOWN SHOULD BE FIELD VERIFIED.

Drawn By: \_\_\_\_\_ Checked By: \_\_\_\_\_

|  |  |  |               |              |       |
|--|--|--|---------------|--------------|-------|
|  |  |  | G.M.          | Date:        | Date: |
|  |  |  | Submitted By: | Approved By: |       |

Date: \_\_\_\_\_ Date: \_\_\_\_\_  
Scale: \_\_\_\_\_ Using Service Approval: \_\_\_\_\_

AS NOTED Approval: Date:  
Reviewed For

|              |  |  |                           |       |
|--------------|--|--|---------------------------|-------|
|              |  |  | Fire & Safety Compliance: | Date: |
| Reviewed For |  |  |                           |       |

Maintenance & Repair Compliance: \_\_\_\_\_ Date: \_\_\_\_\_  
Reviewed For: \_\_\_\_\_

|          |         |                                      |              |
|----------|---------|--------------------------------------|--------------|
| AS-BUILT | 4/19/04 | Reviewed for<br>Security Compliance: | Date:        |
|          |         | Date:                                | Drawing No.: |

Final Construction Documents      8/1/01      Date: 8/1/01      Drawing No.:  
Platting      Building      Site Plan      81

|                 |             |         |      |             |       |    |
|-----------------|-------------|---------|------|-------------|-------|----|
| SYMBOL          | DESCRIPTION | INITIAL | DATE | Proj. No:   | Sheet | Of |
| R E V I S I O N |             |         |      | 640-99-101M | E050  |    |

For more information about the study, please contact Dr. John Smith at (555) 123-4567 or via email at [john.smith@researchinstitute.org](mailto:john.smith@researchinstitute.org).

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