


NOTES:

SHEET NOTES:


- A PROVIDE A SEPARATE NEUTRAL FOR EACH 120V CIRCUIT. SHARING OF NEUTRAL CONDUCTORS IS NOT ALLOWED.
- B 120V, 20A SINGLE PHASE CIRCUITS ORIGINATING FROM THE SAME PANELBOARD MAY BE COMBINED INTO A SINGLE 3/4" CONDUIT HOMERUN WITH A MAXIMUM OF 3 CIRCUITS IN ANY CONDUIT.
- C ALL HOMERUNS SHALL BE ROUTED FROM THE DEVICE OR FIXTURE INDICATED UP TO THE BRANCH CONDUIT RACK LOCATED IN THE "S4" ZONE OF INTERSTITIAL SPACE. EXTEND CONDUIT ALONG THE RACK IN THE "S4" ZONE AND THEN TRANSITION UP THE MAIN DISTRIBUTION RACKS LOCATED IN THE "S3" ZONE OF INTERSTITIAL SPACE. EXTEND THE CONDUIT ALONG THE MAIN DISTRIBUTION RACKS IN THE "S3" ZONE TO THE PANELBOARD LOCATED IN THE ELECTRICAL ROOM. SEE 1/H-EP5.510 FOR INTERSTITIAL FLOOR PENETRATION DETAIL. SEE SHEET H-EP5.504 FOR INTERSTITIAL SPACE CONDUIT RACK DETAILS.

KEY NOTES:


- 1 SEE SHEET H-EP1.4FB2 FOR CONTINUATION.
- 2 CONNECT TO MOTORIZED WINDOW SHADE EQUIPMENT CABINET ML3G202A IN ROOM 3G202. COORDINATE ALL TERMINATIONS WITH MANUFACTURER REQUIREMENTS. REFER TO 2/H-EP5.509 FOR WIRING DIAGRAM.
- 3 CONNECT TO MOTORIZED WINDOW SHADE EQUIPMENT CABINET ML3G202B IN ROOM 3G202. COORDINATE ALL TERMINATIONS WITH MANUFACTURER REQUIREMENTS. REFER TO 2/H-EP5.509 FOR WIRING DIAGRAM.
- 4 CONNECT RECEPTACLE CIRCUIT TO UNDER CABINET LIGHTING IN THIS ROOM.
- 5 CONNECT TO RECEPTACLE ON LANDING ABOVE. SEE SHEET H-EP1.5FB1 FOR CONTINUATION.
- 6 CONNECT TO RECEPTACLE ON LANDING BELOW. SEE SHEET H-EP1.3FB1 FOR CONTINUATION.
- 7 REFER TO SHEET H-ET1.4FB1 FOR FLOOR RECEPTACLE LAYOUT DIMENSIONS IN THIS ROOM. COORDINATE EXACT LOCATIONS OF RECEPTACLES WITH RESIDENT ENGINEER PRIOR TO INSTALLATION. REFER TO 3/H-EP5.503 FOR FLOOR RECEPTACLE INSTALLATION DETAIL.
- 8 NUMERAL INDICATES CIRCUIT NUMBER FOR EACH FLOOR RECEPTACLE.

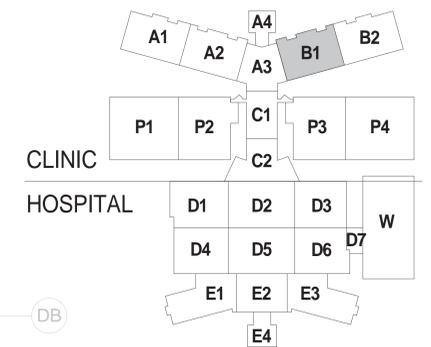

KEY PLAN
LEVEL 4, AREA B, ZONE 1

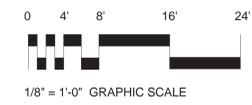

BUILDING IS FULLY SPRINKLERED

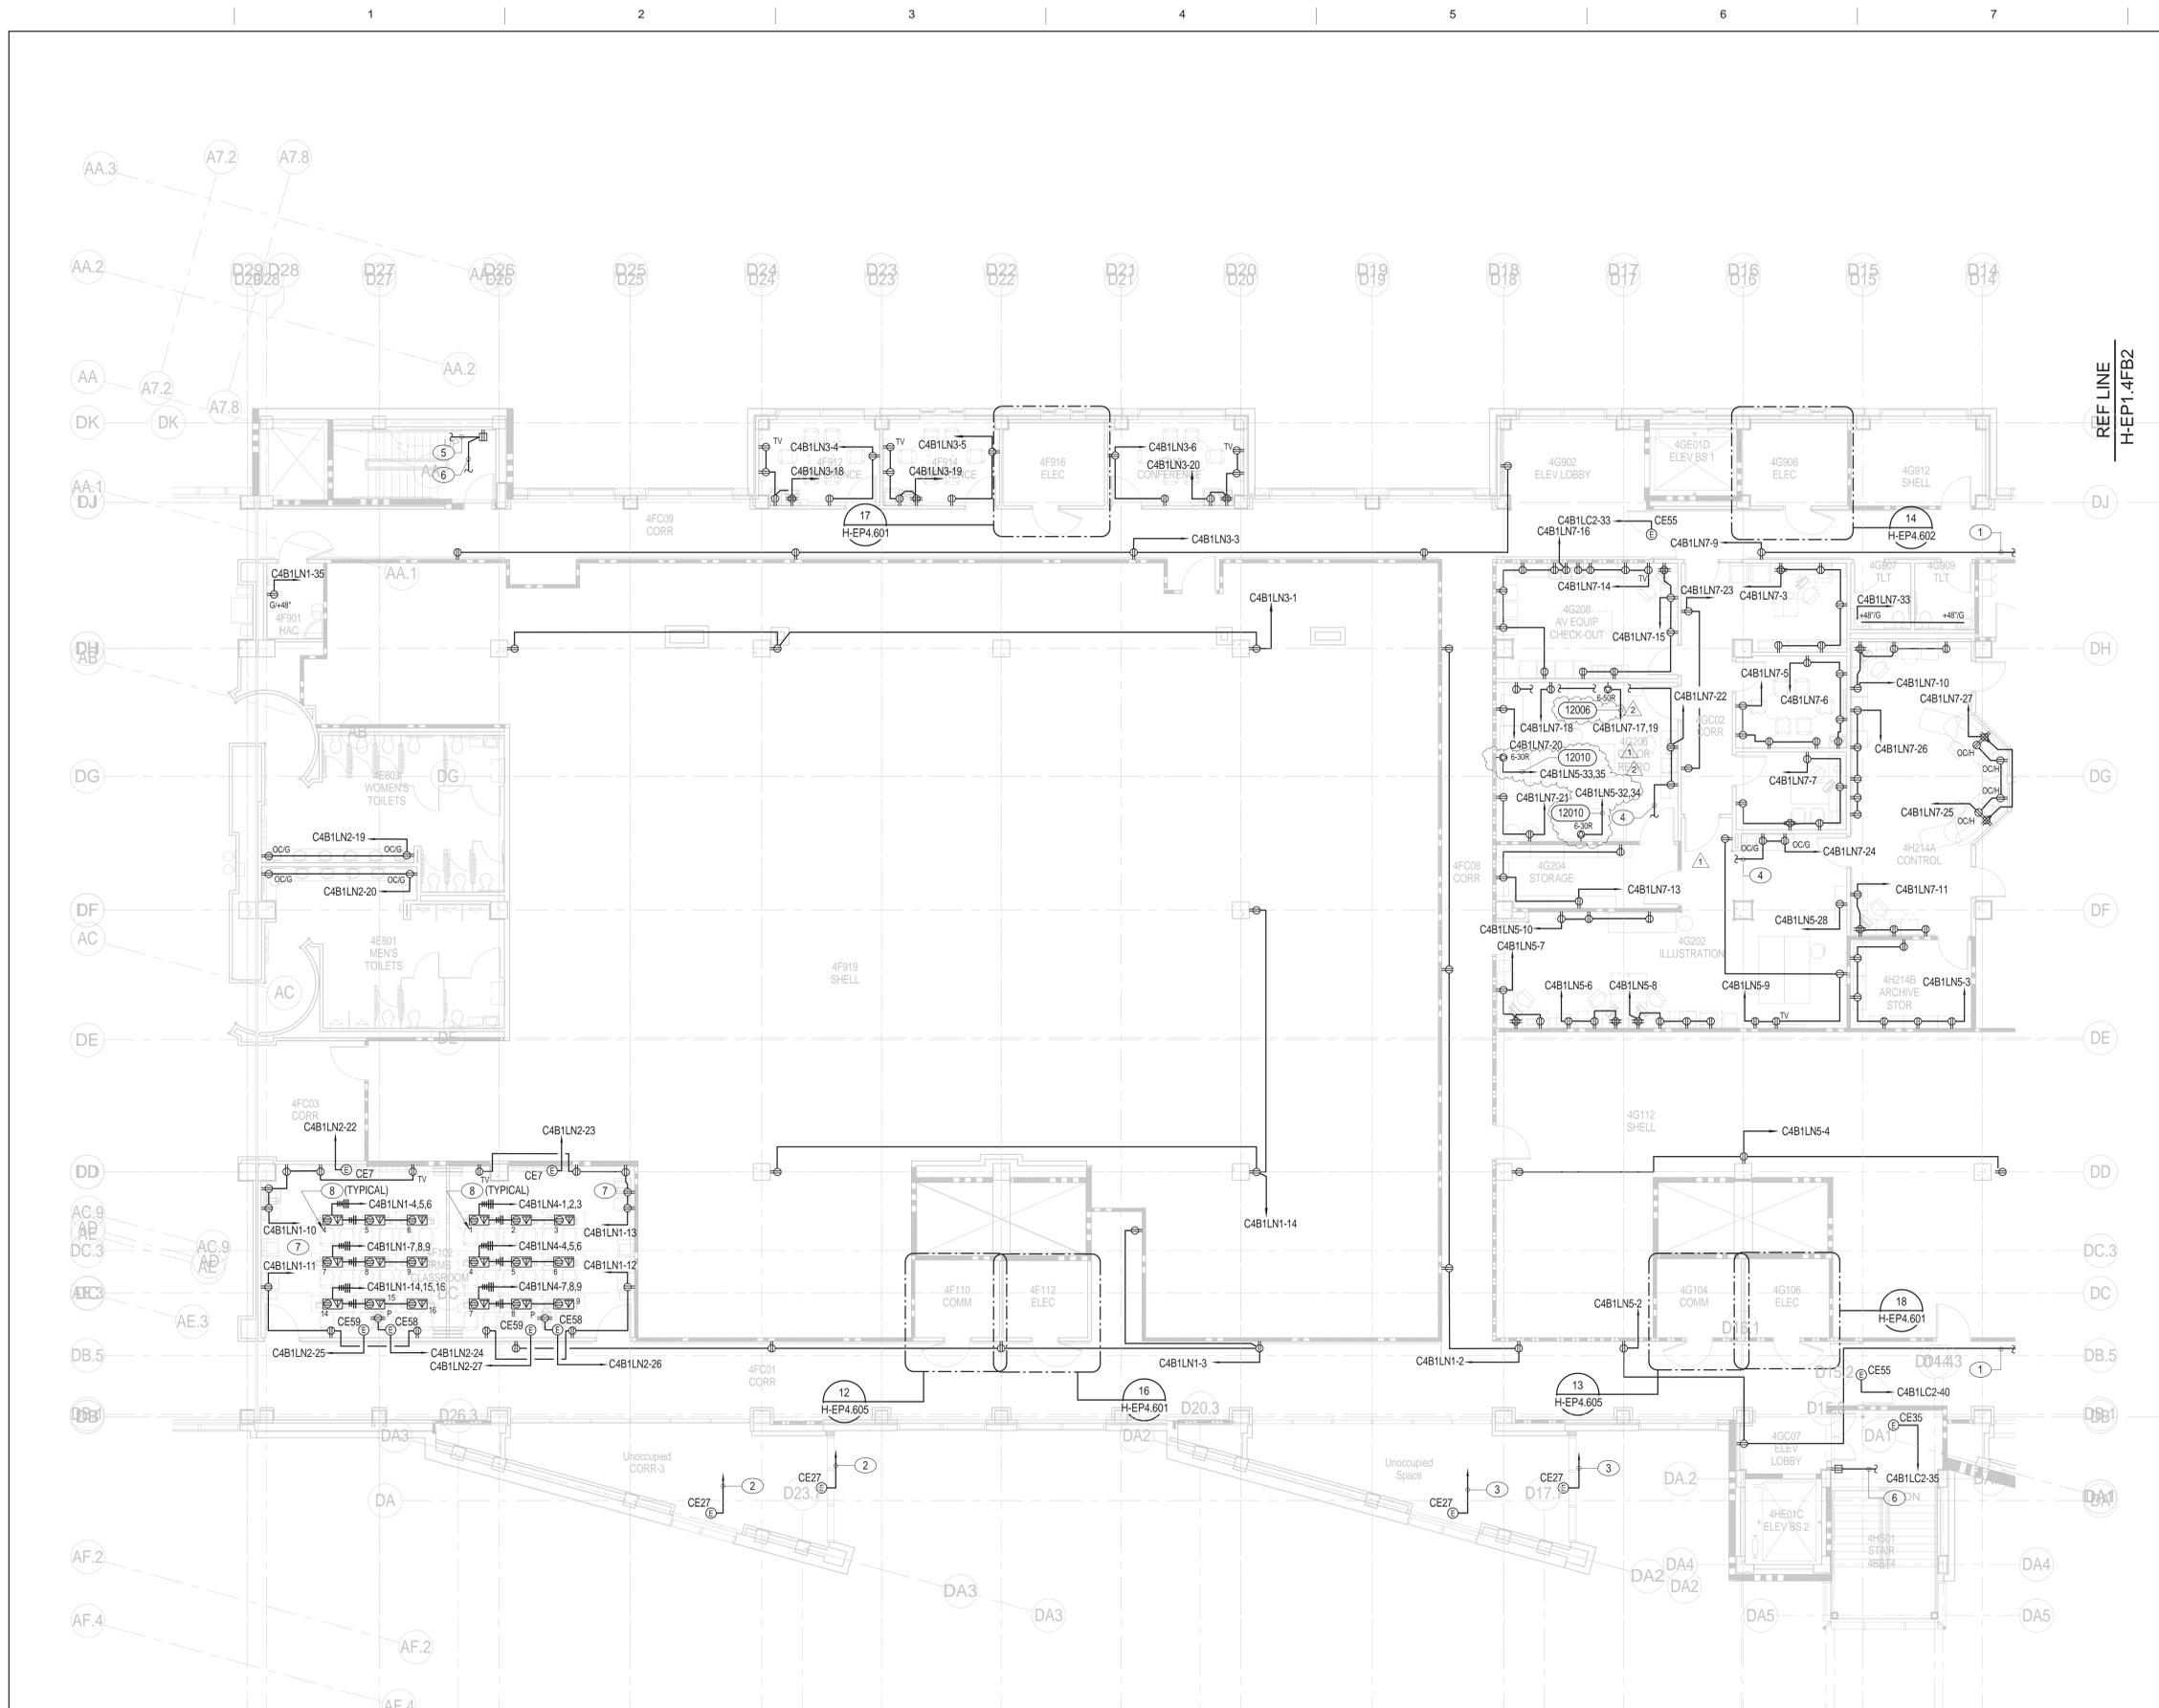

No.	Description	Date
1	CPR 019	01/14/2011
2	CPR 054	04/08/2011

CONSULTANTS:

Professional Seals:

ARCHITECT/ENGINEERS:

Professional Seals:

ARCHITECT/ENGINEERS:

RLF ELLERBE BECKET
A JOINT VENTURE

145 Lincoln Avenue Winter Park, Florida 32789 407 647 1039

1001 G Street, NW, Suite 1000 Washington, D.C. 20001 202 654 9300

HOSPITAL/CLINIC
LEVEL 4, AREA B, ZONE 1 POWER PLAN

Approved: Project Director


Milan Arakic

Project Title A NEW HOSPITAL FOR VAMC ORLANDO, FLORIDA		Project Number 673-950	OFFICE OF FACILITIES MANAGEMENT
Location Orlando, Florida		Building Number 01 AND 02	
Date 04 JUNE, 2010	Checked KLM	Drawn EB/RLF	Department of Veterans Affairs
Drawing Number H-EP1.4FB1		Dwg. 3903 of 4322	


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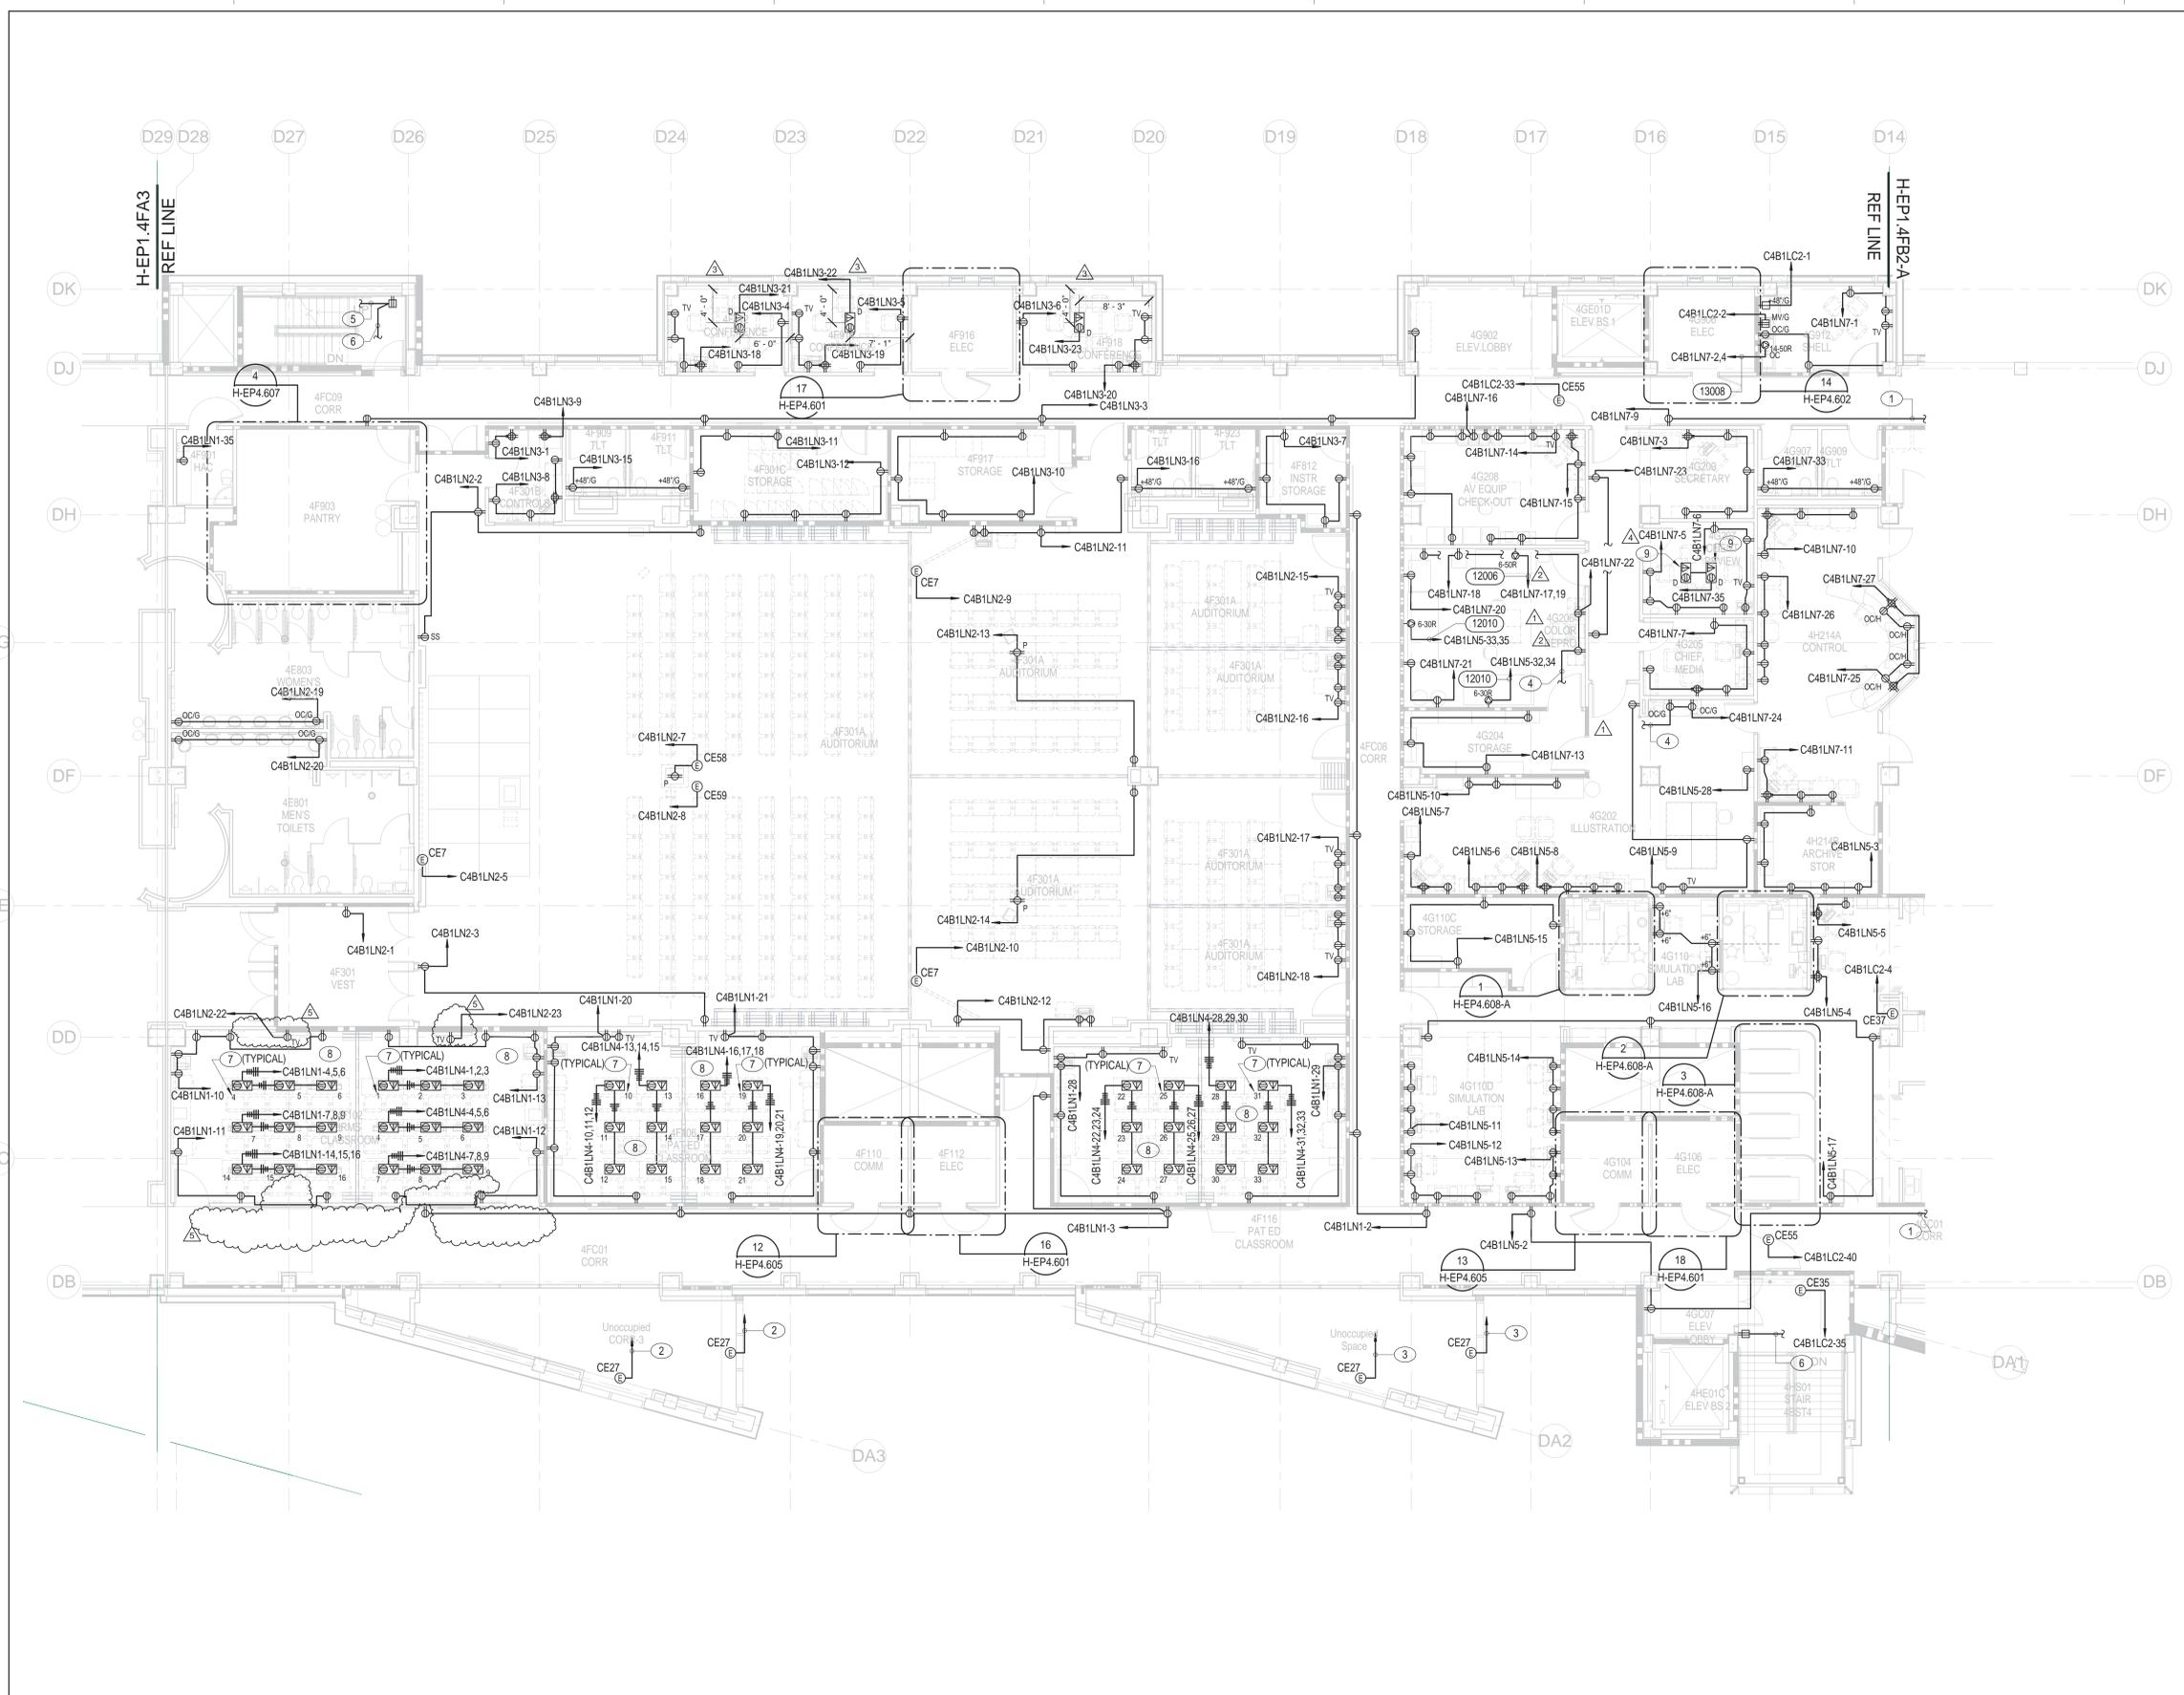
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- KEY NOTES:**
- 1 SEE SHEET H-EP1.4FB2-A FOR CONTINUATION.
 - 2 CONNECT TO MOTORIZED WINDOW SHADE EQUIPMENT CABINET ML3G202A IN ROOM 3G202. COORDINATE ALL TERMINATIONS WITH MANUFACTURER REQUIREMENTS. REFER TO 2/H-EP5.509 FOR WIRING DIAGRAM.
 - 3 CONNECT TO MOTORIZED WINDOW SHADE EQUIPMENT CABINET ML3G202B IN ROOM 3G202. COORDINATE ALL TERMINATIONS WITH MANUFACTURER REQUIREMENTS. REFER TO 2/H-EP5.509 FOR WIRING DIAGRAM.
 - 4 CONNECT RECEPTACLE CIRCUIT TO UNDER CABINET LIGHTING IN THIS ROOM.
 - 5 CONNECT TO RECEPTACLE ON LANDING ABOVE. SEE SHEET H-EP1.5FB1 FOR CONTINUATION.
 - 6 CONNECT TO RECEPTACLE ON LANDING BELOW. SEE SHEET H-EP1.3FB1 FOR CONTINUATION.
 - 7 NUMERAL INDICATES CIRCUIT NUMBER FOR EACH FLOOR RECEPTACLE.
 - 8 REFER TO SHEET H-ET1.4FB1-A FOR FLOOR RECEPTACLE LAYOUT DIMENSIONS IN THIS ROOM. COORDINATE EXACT LOCATIONS OF RECEPTACLES WITH RESIDENT ENGINEER PRIOR TO INSTALLATION. REFER TO 3/H-EP5.503 FOR FLOOR RECEPTACLE INSTALLATION DETAIL.
 - 9 REFER TO SHEET H-ET1.4B1-A FOR DIMENSIONED LOCATION OF THIS FLOOR BOX.



KEY PLAN
LEVEL 4, AREA B, ZONE 1

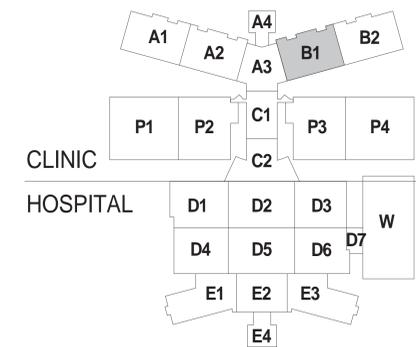

BUILDING IS FULLY SPRINKLERED

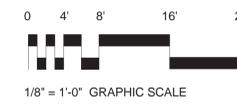

No.	Description	Date
1	CPR 019	01/14/2011
2	CPR 054	04/08/2011
3	CPR 062	04/28/2011
4	CPR 111	07/21/2011
5	CPR 137	08/24/2011

CONSULTANTS:

Professional Seals:

ARCHITECT/ENGINEERS:

RLF ELLERBE BECKET
A JOINT VENTURE


145 Lincoln Avenue
Winter Park, Florida 32789
407 647 1039

1001 G Street, NW, Suite 1000
Washington, D.C. 20001
202 654 9300

Drawing Title:
HOSPITAL/CLINIC
LEVEL 4, AREA B, ZONE 1 POWER PLAN
BID ALTERNATE NO. 4

Approved: Project Director
Melan Arakic

Project Title A NEW HOSPITAL FOR VAMC ORLANDO, FLORIDA		Project Number 673-950		OFFICE OF FACILITIES MANAGEMENT
Location Orlando, Florida		Building Number 01 AND 02		
Date 04 JUNE, 2010	Checked KLM	Drawn EB/RLF	Drawing Number H-EP1.4FB1-A	Department of Veterans Affairs
			Dwg. 3904 of 4322	

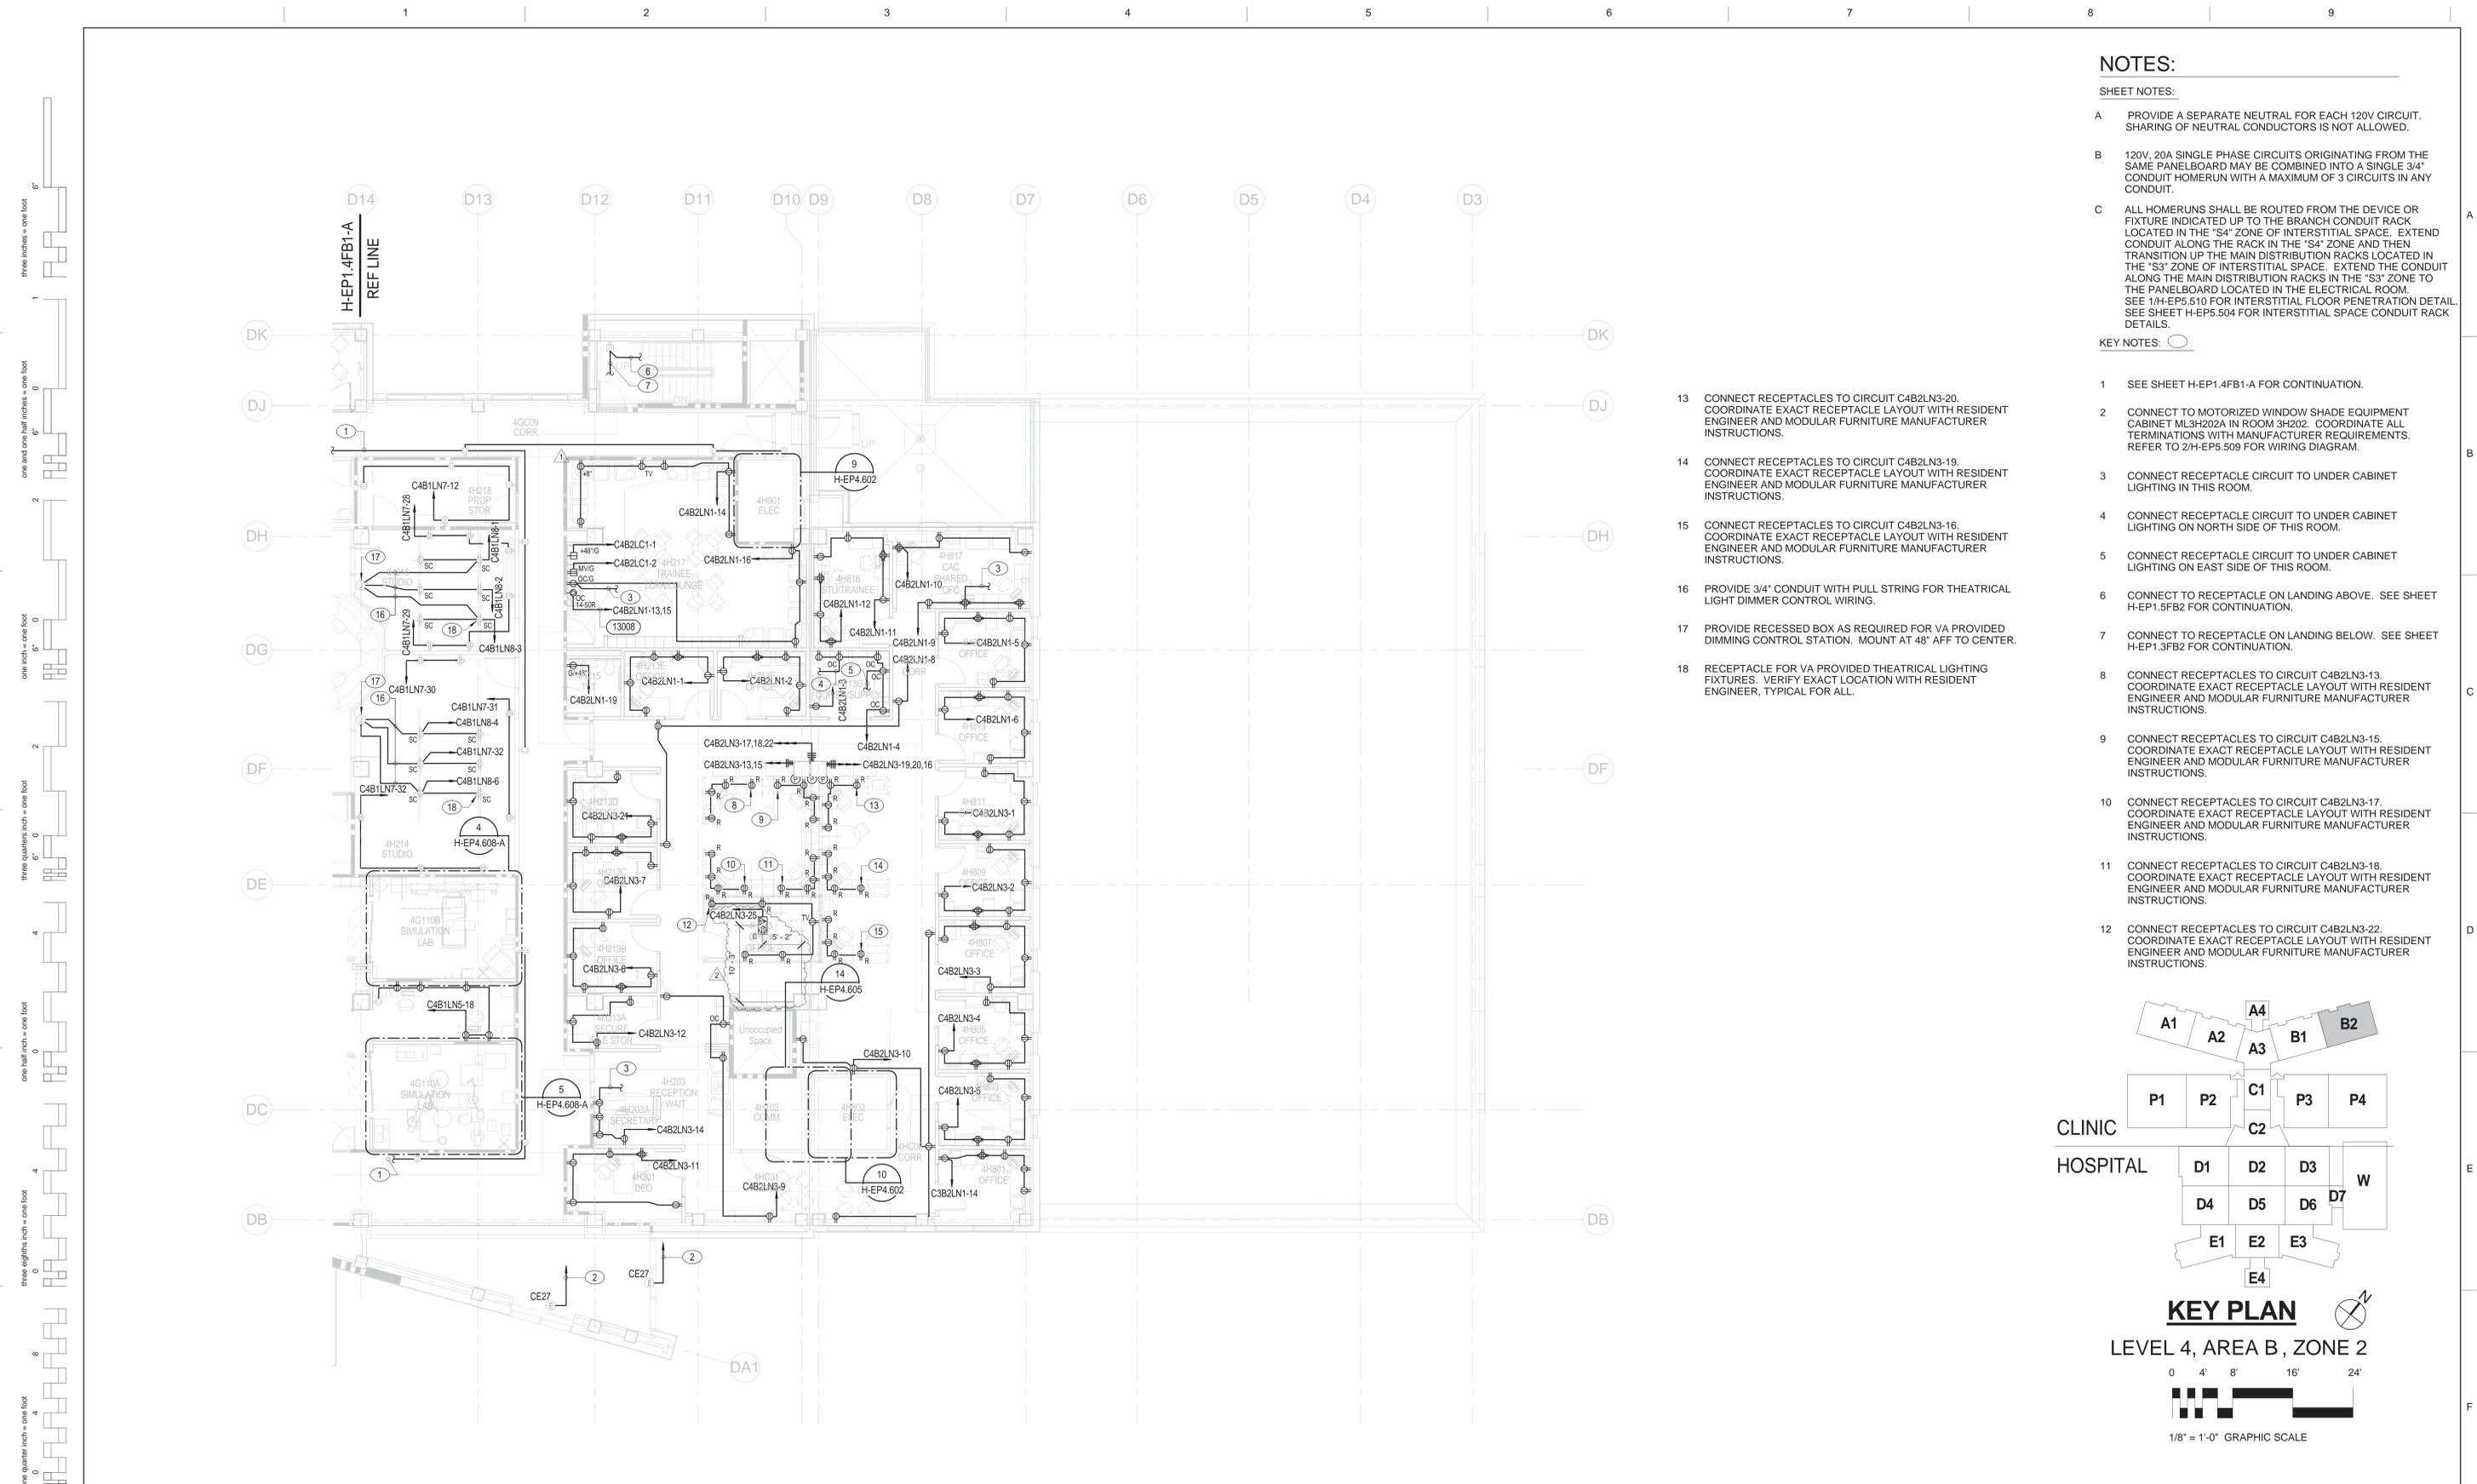

NOTES:

SHEET NOTES:

A PROVIDE A SEPARATE NEUTRAL FOR EACH 120V CIRCUIT. SHARING OF NEUTRAL CONDUCTORS IS NOT ALLOWED.


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KEY NOTES:

- 13 CONNECT RECEPTACLES TO CIRCUIT C4B2LN3-20. COORDINATE EXACT RECEPTACLE LAYOUT WITH RESIDENT ENGINEER AND MODULAR FURNITURE MANUFACTURER INSTRUCTIONS.
- 14 CONNECT RECEPTACLES TO CIRCUIT C4B2LN3-19. COORDINATE EXACT RECEPTACLE LAYOUT WITH RESIDENT ENGINEER AND MODULAR FURNITURE MANUFACTURER INSTRUCTIONS.
- 15 CONNECT RECEPTACLES TO CIRCUIT C4B2LN3-16. COORDINATE EXACT RECEPTACLE LAYOUT WITH RESIDENT ENGINEER AND MODULAR FURNITURE MANUFACTURER INSTRUCTIONS.
- 16 PROVIDE 3/4" CONDUIT WITH PULL STRING FOR THEATRICAL LIGHT DIMMER CONTROL WIRING.
- 17 PROVIDE RECESSED BOX AS REQUIRED FOR VA PROVIDED DIMMING CONTROL STATION. MOUNT AT 48" AFF TO CENTER.
- 18 RECEPTACLE FOR VA PROVIDED THEATRICAL LIGHTING FIXTURES. VERIFY EXACT LOCATION WITH RESIDENT ENGINEER, TYPICAL FOR ALL.

- 1 SEE SHEET H-EP1.4FB1-A FOR CONTINUATION.
- 2 CONNECT TO MOTORIZED WINDOW SHADE EQUIPMENT CABINET ML3H202A IN ROOM 3H202. COORDINATE ALL TERMINATIONS WITH MANUFACTURER REQUIREMENTS. REFER TO 2/H-EP5.509 FOR WIRING DIAGRAM.
- 3 CONNECT RECEPTACLE CIRCUIT TO UNDER CABINET LIGHTING IN THIS ROOM.
- 4 CONNECT RECEPTACLE CIRCUIT TO UNDER CABINET LIGHTING ON NORTH SIDE OF THIS ROOM.
- 5 CONNECT RECEPTACLE CIRCUIT TO UNDER CABINET LIGHTING ON EAST SIDE OF THIS ROOM.
- 6 CONNECT TO RECEPTACLE ON LANDING ABOVE. SEE SHEET H-EP1.5FB2 FOR CONTINUATION.
- 7 CONNECT TO RECEPTACLE ON LANDING BELOW. SEE SHEET H-EP1.3FB2 FOR CONTINUATION.
- 8 CONNECT RECEPTACLES TO CIRCUIT C4B2LN3-13. COORDINATE EXACT RECEPTACLE LAYOUT WITH RESIDENT ENGINEER AND MODULAR FURNITURE MANUFACTURER INSTRUCTIONS.
- 9 CONNECT RECEPTACLES TO CIRCUIT C4B2LN3-15. COORDINATE EXACT RECEPTACLE LAYOUT WITH RESIDENT ENGINEER AND MODULAR FURNITURE MANUFACTURER INSTRUCTIONS.
- 10 CONNECT RECEPTACLES TO CIRCUIT C4B2LN3-17. COORDINATE EXACT RECEPTACLE LAYOUT WITH RESIDENT ENGINEER AND MODULAR FURNITURE MANUFACTURER INSTRUCTIONS.
- 11 CONNECT RECEPTACLES TO CIRCUIT C4B2LN3-18. COORDINATE EXACT RECEPTACLE LAYOUT WITH RESIDENT ENGINEER AND MODULAR FURNITURE MANUFACTURER INSTRUCTIONS.
- 12 CONNECT RECEPTACLES TO CIRCUIT C4B2LN3-22. COORDINATE EXACT RECEPTACLE LAYOUT WITH RESIDENT ENGINEER AND MODULAR FURNITURE MANUFACTURER INSTRUCTIONS.



KEY PLAN

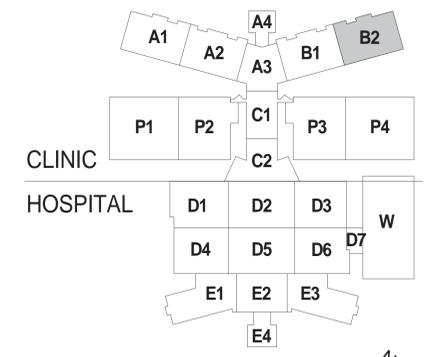LEVEL 4, AREA B, ZONE 2

0 4' 8' 16' 24'

1/8" = 1'-0" GRAPHIC SCALE

No.	Description	Date
1	CPR 002	11/12/2010
2	CPR 062	04/28/2011

CONSULTANTS:

Professional Seals:

ARCHITECT/ENGINEERS:

Professional Seals:

ARCHITECT/ENGINEERS:

ELLERBE BECKET

RLF

A JOINT VENTURE

145 Lincoln Avenue Winter Park, Florida 32789 407 647 1039

1001 G Street, NW, Suite 1000 Washington, D.C. 20001 202 654 9300

Drawing Title
**HOSPITAL/CLINIC
LEVEL 4, AREA B, ZONE 2 POWER PLAN
BID ALTERNATE NO. 4**

Approved: Project Director

Melan Arakic

Project Title
**A NEW HOSPITAL FOR
VAMC ORLANDO, FLORIDA**

Project Number
673-950

Building Number
01 AND 02

Location
Orlando, Florida

Date
04 JUNE, 2010

Checked
KLM

Drawn
EB/RLF

Drawing Number
H-EP1.4FB2-A

Dwg. 3906 of 4322

**OFFICE OF
FACILITIES
MANAGEMENT**

Department of
Veterans Affairs

BUILDING IS FULLY SPRINKLERED