

ARCHITECTURAL SYMBOLS

	DETAIL INDICATOR-PLAN
	SECTION INDICATOR
	DRAWING BLOCK TITLE
	DOOR OPENING IDENTIFIER
	INTERIOR ELEVATION INDICATOR
	ELEVATION INDICATOR
	NORTH ARROW
	ROOM NAME & NUMBER
	KEYNOTE
	FINISH TAG
	WALL PARTITION TYPE
	WINDOW TYPE IDENTIFIER
	EXISTING DOOR TO REMAIN

	CENTER LINE INDICATOR		PROPERTY LINE
	CONTRACT LIMIT LINE		DIMENSION LINE
	DEMOLITION LINE		HIDDEN FEATURES LINE
	FEATURES ABOVE LINE		MATCHLINE
	VV ITEM - VA SUPPLIED & INSTALLED		VV ITEM - VA SUPPLIED & INSTALLED
	VC ITEM - VA SUPPLIED & CONTRACTOR INSTALLED		

MATERIAL SYMBOLS

	BASE COURSE		PLYWOOD
	BRICK		SAND / MORTAR
	CONCRETE		STEEL / ALUMINUM
	CONCRETE MASONRY UNIT		STONE
	EARTH		WOOD
	BATT INSULATION		EXIST CONSTRUCTION TO BE REMOVED
	EXIST CONSTRUCTION TO REMAIN		

REFLECTED CEILING LEGEND

	2x4 FLUORESCENT LIGHT FIXTURE
	2x2 FLUORESCENT LIGHT FIXTURE
	CEILING MOUNTED DOME MIRROR
	LINEAR FLUORESCENT LIGHT FIXTURE
	COVE LIGHT FIXTURE
	UNDER-CABINET LIGHT FIXTURE
	RECESSED LIGHT FIXTURE
	SPRINKLER HEAD
	EMERGENCY LIGHT FIXTURE
	EMERGENCY EXIT LIGHT FIXTURES
	SUPPLY DIFFUSER (ROUND)
	SUPPLY DIFFUSER (SQUARE)
	RETURN REGISTER
	ACCESS PANEL, AP
	SPEAKER
	OCCUPANT SENSOR
	FIRE ALARM CEILING MOUNTED W/ AUDIO & VISUAL ALARM
	CEILING MOUNTED ALARM

PROJECT GENERAL INFORMATION

- ALL DRAWINGS SHALL BE READ IN CONJUNCTION WITH ALL OTHER DRAWINGS, SPECIFICATIONS, THESE NOTES, SYMBOLS AND GENERAL INFORMATION ON THIS SHEET AND ABBREVIATIONS SHOWN ON SHEET "A-0.02".
- DO NOT SCALE DRAWINGS. USE NOTED DIMENSIONS ONLY. VERIFY ALL DIMENSIONS PRIOR TO WORK. VERIFY ALL DISCREPANCIES BETWEEN FIELD CONDITIONS AND THE CONTRACT DOCUMENTS. IN THE EVENT OF DISCREPANCY, NOTIFY THE ARCHITECT AND OBTAIN RESOLUTION BEFORE PROCEEDING. FAILURE TO NOTIFY THE ARCHITECT WILL NOT RELIEVE THE CONTRACTOR OF RESPONSIBILITY TO PERFORM THE WORK AS INTENDED BY THE CONTRACT DOCUMENTS. CONTRACTOR SHALL BE RESPONSIBLE FOR ANY AND ALL WORK ARISING FROM SUCH FAILURE TO COORDINATE DISCREPANCIES TO THE SATISFACTION OF THE ARCHITECT.
- LARGE SCALE DRAWINGS TAKE PRECEDENCE OVER SMALLER SCALE DRAWINGS.
- GRID LINES ARE LOCATED AT THE EXTERIOR SIDE OF PARTITIONS METAL STUDS EXCEPT GRID LINE 3 THAT IS CENTER AT THE PARTITION METAL STUD.
- FLOOR PLANS AND INTERIOR ELEVATIONS INDICATE SPECIFIC INFORMATION, SEE TYPICAL PARTITION DETAILS, TYPICAL DOOR DETAILS, TYPICAL CASEWORK TYPES, TOP TYPES, SHELF TYPES, NOTES AND TYPICAL DETAILS FOR TYPICAL CONSTRUCTION UNLESS INDICATED OTHERWISE.

SPECIFICATION

- SEE SPECIFICATION FOR FINISHES, MATERIALS, BUILDING ACCESSORIES, ETC UNLESS NOTED OTHERWISE.
- REFER TO PROJECT SPECIFICATIONS FOR SPECIFIC PRODUCT MATERIALS, PRODUCTS AND SYSTEMS IDENTIFIED ON THE DRAWINGS WITH EITHER A NUMBER '09260-11, 09510-1, ETC' OR 'GYP-11, RF-1, ETC'. FOR SPECIFIC PRODUCT SELECTIONS AND OTHER REQUIREMENTS.

COORDINATION

VERIFY AND COORDINATE THE FOLLOWING WITH THE RESPECTIVE TRADES:

- VERIFY ALL NEW AND EXISTING CONDITIONS, SIZES AND LOCATIONS OF MECH AND/OR ELECTRICAL PENETRATIONS PRIOR TO COMMENCEMENT OF ANY WORK
- LOCATIONS FOR BACKING OR BLOCKING REQUIRED FOR MOUNTING ARCH, MECH, ELEC, OR OWNER FURNISHED EQUIPMENT, ACCESSORIES AND/OR SYSTEMS.

DRAWINGS

- SEE SHEET "A-0.01" FOR PARTITION TYPES, NOTES AND TYPICAL DETAILS.
- FLOOR PLANS INDICATE ROOM OPENING NUMBERS FOR DOOR AND WINDOWS, FOR FRAME TYPES, FRAME PROFILES, OPENING NOTES AND DETAILS. SEE ROOM OPENING SCHEDULE, FRAME WINDOW AND DOOR FRAMES TYPES ON SHEET "A-0.20".
LOCATE DOORS IN PARTITIONS ADJACENT TO PERPENDICULAR WALLS. SEE TYPICAL DOOR LOCATION AT SHEET "A-0.20". MAINTAIN MINIMUM ACCESSIBILITY DOOR LATCH SIDE CLEARANCE REQUIREMENTS, PUSH SIDE 12" MIN. 4'-0" DEEP IF DOOR IS PROVIDED WITH A CLOSER AND PULL SIDE 1'-6" MIN. 4'-0" DEEP IF DOOR IS PROVIDED WITH A CLOSER.
- CASEWORK, SHELF AND TOP TYPES, NOTES AND SPECIFIC DETAILS ARE AS SHOWN ON INTERIOR ELEVATIONS. SEE SHEET "A-0.30" FOR TYPICAL CASEWORK, SHELF AND TOP TYPES AND TYPICAL NOTES AND DETAILS.
- FINISHES ARE INDICATED IN THE FINISH SCHEDULE AND/OR FLOOR PLAN AND INTERIOR ELEVATIONS. SEE TYPICAL FINISH TRANSITION DETAILS ON SHEET "A-0.20".
- CONCRETE CURBS AND EQUIPMENT PADS SHOWN ON PROJECT DOCUMENTS TO BE COORDINATED WITH MECHANICAL AND ELECTRICAL VENDORS FOR FINAL LOCATIONS, SIZES, DETAILS AND SPECIAL EQUIPMENT REQUIREMENTS.

PARTITIONS

- PLAN DIMENSIONS ARE TO OUTSIDE FACE OF PARTITIONS EXCLUDING DIRECTLY APPLIED FINISH MATERIAL SUCH AS CERAMIC TILE UNLESS NOTED OTHERWISE.
- THE FACE OF EVERY PARTITION SHALL BE FLUSH WITHOUT OFFSETS. CHANGES IN PARTITION THICKNESS SHALL OCCUR AT CORNERS, PARTITION INTERSECTIONS OR OTHER FEATURES WHICH INTERRUPT THE PLANE OF THE PARTITION. FACE OF CORRIDOR PARTITIONS SHALL BE FLUSH FOR THE ENTIRE LENGTH OF THE CORRIDOR REGARDLESS OF CHANGES IN PARTITION THICKNESS. ALL ADJUSTMENTS SHALL BE MADE TO THE ROOM SIDE OF THE CORRIDOR PARTITION AND AT CORNERS.

WALL BLOCKING AND ANCHORAGE

- PROVIDE SHEET METAL WALL BLOCKING FOR EQUIPMENT, FITTINGS, FIXTURES AND ACCESSORIES IN ACCORDANCE WITH MANUFACTURER RECOMMENDATIONS AND REQUIREMENTS. SEE PARTITION BLOCKING DETAILS.

CEILING

- CEILING HEIGHT SHALL BE 8'-0" MINIMUM. SEE ALSO REFLECTED CEILING PLAN.

Revisions:	Date

CONSULTANTS:

<p>AMERICAN ENGINEERS, INC. 65 ABERDEEN DR. GLASGOW, KY 42341 (270) 651-7220 TEL. (270) 651-3246 FAX WWW.AEI.CC</p>	<p>ADVANCED STRUCTURAL TECHNOLOGIES 7212 METRO BLVD EDINA, MN 55439 (952) 854-9202 TEL. (952) 854-9690 FAX WWW.ASTMN.COM</p>	<p>ENGINEERING CONSULTANTS Experience you can build on. STRUCTURAL, MECHANICAL, ELECTRICAL, TECHNOLOGY, MEDICAL EQUIPMENT SOLUTIONS (309) 788-0673 TEL. (309) 788-5967 FAX QUAD CITIES, IL. WWW.KJWW.COM</p>
---	--	--

I HEREBY CERTIFY THAT THIS PLAN, SPECIFICATION OR REPORT WAS PREPARED BY ME OR UNDER MY DIRECT SUPERVISION, AND THAT I AM A DULY LICENSED ARCHITECT UNDER THE LAWS OF THE STATE OF MINNESOTA.

PRINTED NAME: PAUL D. DAHLBERG
SIGNATURE:

DATE: 05-20-2015
LICENSE #: 15870

ARCHITECT/ENGINEERS:

Anderson Engineering of Minnesota, LLC
13605 1st Avenue North
Suite 100
Plymouth, MN 55441
763-412-4000 (t) 763-412-4090 (f)
www.ae-mn.com

Drawing Title ARCHITECTURAL GENERAL INFORMATION & SYMBOLS	Project Title WASH BAY / STORAGE BUILDING	Project Number 833-CM3-026	National Cemetery Administration
Approved: Project Director	Location CAMP NELSON NATIONAL CEMETERY NICHOLASVILLE, KENTUCKY	Building Number 3003	
Date May 20, 2015	Checked PD	Drawn SC	Drawing Number A-0.01 Dwg. 16 of 53

100% CONSTRUCTION DOCUMENTS

ARCHITECTURAL ABBREVIATIONS	
	DESCRIPTION
#	POUND / NUMBER
&	AND
@	AT
A	AIR
A/C or A/C UNIT	AIR CONDITION or AIR CONDITIONING UNIT
AE	ARCHITECT / ENGINEER
AAMA	AMERICAN ARCHITECTURAL MANUFACTURERS ASSOCIATION
AAP	ALARM ANNUNCIATOR PANEL
AB	ANCHOR BOLT
ABC	AGGREGATE BASE COURSE
AC	ASBESTOS CEMENT or ASPHALTIC CONCRETE
ACC	ACCESSIBLE
ACC DR	ACCESS DOOR
ACC FLR	ACCESS FLOOR
ACC PNL or AP	ACCESS PANEL
ACI	AMERICAN CONCRETE INSTITUTE
ACOUS	ACOUSTICAL
ACT or AT	ACOUSTICAL CEILING TILE
AD	AREA DRAIN
ADA	AMERICANS WITH DISABILITY ACT
ADB or ADG	AUTOMATIC DOOR BOTTOM or AUTOMATIC DOOR CLOSER
ADD	ADDENDUM
ADDN or ADDL	ADDITION or ADDITIONAL
ADH	ADHESIVE
ADJ	ADJUNCT / ADJOINING / ADJUSTABLE
ADMIN	ADMINISTRATION
AFC	ABOVE FINISHED CURB
AFD	ACCORDIAN FOLDING DOOR
AFI	ABOVE FINISH FLOOR
AFG	ABOVE FINISHED GRADE
AFS	ABOVE FINISHED SLAB
AGA	AMERICAN GAS ASSOCIATION
AGD	ALL GLASS ENTRANCE DOOR
AGE	ALL GLASS ENTRANCE WALL
AGGR	AGGREGATE
AGS	ANESTHESIA GAS SCAVENGER
AHJ	AUTHORITY HAVING JURISDICTION
AHR	ANCHOR
AHU	AIR HANDLING UNIT
AIA	AMERICAN INSTITUTE OF ARCHITECTS
AID	AUDIO INPUT DEVICE
AISC	AMERICAN INSTITUTE OF STEEL CONSTRUCTION
ALT or ALT NO	ALTERNATE or ALTERNATE NUMBER
ALUM	ALUMINUM
AM	ANESTHESIA MONITOR
AMEND	AMENDMENT
AMP	AMPERE
AMT	AMOUNT
ANES	ANESTHESIOLOGY
ANOD	ANODIZE / ANODIZED
ANSI	AMERICAN NATIONAL STANDARDS INSTITUTE
ANT	ANTENNA
ANUN	ANNUNCIATOR
APA	AMERICAN PLYWOOD ASSOCIATION
APC	ARCHITECTURAL PRECAST CONCRETE
APPROX	APPROXIMATE
APT	APARTMENT
AR	APRON RACK / AS REQUIRED
ARCH	ARCHITECT / ARCHITECTURAL
ASD	AUTOMATIC SLIDING DOOR
ASRLR	AUTOMATIC SPRINKLER / SYSTEM
ASPH	ASPHALT
ASSN	ASSOCIATION
ASST	ASSISTANT
ASTM	AMERICAN SOCIETY FOR TESTING MATERIALS
ATCH	ATTACHED / ATTACHMENT
ATM	AUTOMATIC TELLER MACHINE
ATS	AUTOMATIC TRANSFER SWITCH
AUTO	AUTOMATIC
AUX	AUXILIARY
AV	AUDIO VISUAL / AUDIO VIDEO
AVE	AVENUE
AVG	AVERAGE
AW	ALUMINUM WINDOW / ACID WASTE
AWI	ARCHITECTURAL WOODWORKING INSTITUTE
AWP	ACOUSTIC WALL PANEL
AWPA	AMERICAN WOOD PRESERVERS ASSOCIATION
AWS	AMERICAN WELDING SOCIETY
AWT	ACOUSTICAL WALL TREATMENT
B	BLANK
B PL	BASE PLATE
BA	BUILDING ACCESSORY / BATHROOM ACCESSORY
BACT	BACTERIOLOGY
BALC	BALCONY
BAS	BUILDING AUTOMATION SYSTEM
BASS	BASSINET
BAT	BATTEN
BB	BULLETTIN BOARD
BD or BD FT	BOARD / BOARD FOOT/FEET
BEV	BEVEL / BEVELLED
BFE	BOTTOM FOOTING ELEVATION
BG	BUMPER GUARD
BHMA	BUILDER HARDWARE MANUFACTURERS ASSOCIATION
BI FLD DR	BI FOLD DOOR
BM	BUILDING INFORMATION MODEL
BIT or BITUM	BITUMINOUS
BKT or BRKT	BRACKET
BLDG or BLD	BUILDING / BUILD
BLKG or BKG	BLOCKING / BACKING
BLKT	BLANKET
BLT	BORROWED LIGHT
BLVD	BOULEVARD
BLW	BELOW
BM	BEAM / BENCHMARK
BMS	BUILDING MANAGEMENT / MAINTENANCE SYSTEM
BO	BY OWNER, FUTURE
BOF	BY OWNER, FUTURE
BOS	BOTTOM OF STEEL
BOT	BOTTOM
BPC	BED PAN CABINET
BR	BRICK / BEDROOM
BRG	BRICK COURSES
BRGD	BRACING
BRGD or BRDG	BRIDGING / BRIDGING JOIST
JST	JOIST
BRG	BEARING
BRG or BRG PL	BEARING / BEARING PLATE
BRL	BRICK LEDGE
BRZ	BRONZE
BSMT	BASEMENT
BTWN	BETWEEN
BU	BUSH
BUR	BUILT-UP ROOFING
BZ	BUZZER
C	CHANNEL
CAB	CABINET
CAC	CEILING ATTENUATION CLASS
CANTL	CANTILEVER
CAP	CAPACITY / COMPOSITE ALUMINIUM PANELS

ARCHITECTURAL ABBREVIATIONS	
	DESCRIPTION
CAT	CATEGORY
CATV	CABLE-ACCESSIBLE TELEVISION
CB	CATCH BASIN / CODE BLUE / CORNER BEAD
CC	CUBICLE CURTAIN / CUBIC CENTERMETER
CCD	COLLING COUNTER DOOR / CONSTRUCTION CHANGE DIRECTIVE
CCT	CUBICLE CURTAIN TRACK
CCV	CLOSED CIRCUIT TELEVISION
CCU	CRITICAL CARE UNIT
CD	CEILING DOOR / CONSTRUCTION DOCUMENTS
CEM or GEM PLS or CDB or CBB	CEMENT or CEMENT PLASTER or CEMENT BOARD or CEMENT BACKER BOARD
CF	CUBIC FOOT / CONTRACTOR FURNISHED
CF/CI	CONTRACTOR FURNISHED, CONTRACTOR INSTALLED
CF/CI	CONTRACTOR FURNISHED, OWNER INSTALLED
CFLG	COUNTERFLASHING
CFM or CFS	CUBIC FEET PER MINUTE / CUBIC FEET PER SECOND
CFMF	COLD FORMED METAL FRAME / FRAMING
CG	CORNER GUARD / CENTER OF GRAVITY
CSR	COLLING GRILLE
CH	COAT HOOK / CLOTHES HOOK / CHIME
CHBD or Ch BD	CHALK BOARD
CHEM	CHEMISTRY
CI	CAST IRON / CONSTRUCTION ISSUE
CIP	CAST IN PLACE
CIR or CIR/C	CIRCLE / CIRCULAR or CIRCUIT
CJ or CJ	CONTROL JOINT
CL or C to C	CENTER LINE or CENTER TO CENTER
CLG	CEILING
CLO	CLOSED
CLR	CLEAR
CM	CONSTRUCTION MANAGER
CMJ	CONCRETE MASONRY UNIT
CO	CLEAN OUT / GASED OPENING / COMPANY / CARBON MONOXIDE
CO2	CARBON DIOXIDE
COL	COLUMN
COMB	COMBINE / COMBINED
COMM	COMMUNICATION
COMP	COMPONENT
CONC or CONC FLR or CIP	CONCRETE or CONCRETE FLOOR or CAST IN PLACE CONCRETE
CONF	CONFERENCE
CONN	CONNECT / CONNECTED / CONNECTION
CONST or CM	CONSTRUCTION or CONSTRUCTION MANAGEMENT
CONT	CONTINUE / CONTINUOUS
CONTR	CONTRACT / CONTRACTOR
COORD	COORDINATE
CORR	CORRIDOR
CPRS	COMPRESSIBLE
CPT	CARPET
CR	CRASH RAIL / CHAIR RAIL / CARDREADER
CRF	CONDUCTIVE RESILIENT FLOORING
CRS	COLD ROLLED STEEL
CRSI	CONCRETE REINFORCING STEEL INSTITUTE
CSB	CONCRETE SPLASH BLOCK
CSG	CASING
CSI	CONSTRUCTION SPECIFICATION INSTITUTE
CSK	COUNTER SUNK
CSN	CAST STONE
CT	CERAMIC TILE / CAT SCAN
CTB	CERAMIC TILE BASE
CTF	CERAMIC TILE FLOOR
CTG	COATING
CTOP	COUNTERTOP
CTR	CENTER / CENTER COUNTER
CTRL or CTRL RM	CONTROL or CONTROL ROOM
CTSK	COUNTERSUNK
CTV	CABLE TELEVISION
CU or CU FT or CU YD	COPPER or CUBIC FEET/FOOT or CUBIC YARD
CUH	CABINET UNIT HEATER
CV	CARDIOVASCULAR
CW	CURTAIN WALL / COLD WATER
CYL or CYL L	CYLINDER or CYLINDER LOCK
CYSTO	CYSTOSCOPY
D	DEPTH / DEEP / DUTCH / PENNY NAIL
DAT	DATUM
DB	DECIBEL
DBL or DBL GLZ	DOUBLE or DOUBLE GLAZED
DC	DIRECT CURRENT
DCS	DIAPER CHANGING STATION
DD	DESIGN DEVELOPMENT
DEFS	DIRECT APPLIED EXTERIOR FINISH SYSTEM
DEG	DEGREE
DEMO	DEMOLITION
DEPR	DEPRESSION / DEPRESSED
DEPT	DEPARTMENT
DET	DETAIL / DETAILS
DFF	DOOR FRAME PROTECTION
DIA	DIAMETER
DIAG	DIAGONAL / DIAGRAM
DICT	DICTATION
DIF	DIFFUSER
DIM	DIMENSION
DIR	DIRECTOR / DIRECTION
DISP	DISPENSER
DIST	DISTANCE / DISTRIBUTION
DIV	DIVIDE / DIVISION
DW	DEIONIZED WATER
DWL	DEAD LOAD / DIRECT LOAD
DLO	DAY LIGHT OPENING
DN	DOWN
DP	DAMP PROOFING / DATA PROCESSING / DEMOUNTABLE PARTITION
DR or DR CL or DR FR	DOCTOR / DOOR / DOOR CLOSER or DOOR FRAME or DOOR AND FRAME
DS	DOWNSPOUT
DSW	DISTILLED WATER
DW or DWTR	DISHWASHER / DUMBWAITER
DWG	DRAWING
DWLS	DOWELS
E	EAST / EXISTING / ENTONOX (N2/O2/OXYGEN BLEND)
E	EACH
EC	ELECTRIC CABINET
ECG	ELECTROCARDIOGRAPHY
EEG	ELECTROENCEPHALOGRAPHY
EENT	EYE EAR NOSE AND THROAT
EF	EXHAUST FAN
EHS	EQUIPMENT HOOK
EI or EJ	EXTERIOR INSUL AND FINISH SYSTEM
EL or EJ	EXPANSION JOINT
EL	ELEVATION
ELEC	ELECTRICAL / ELECTRIC
ELEV	ELEVATOR
EMERG or EMERG SHR	EMERGENCY or EMERGENCY SHOWER
EMG	ELECTROMYOGRAPHY
ENCL	ENCLOSURE / ENCLOSED
ENGR or ENGR	ENVIRONMENTAL PROTECTION AGENCY
ENT	EAR NOSE AND THROAT
ENTR	ENTRANCE
EO	ELECTRICAL OUTLET
EP	EXPLOSION PROOF / EPOXY PAINT / ELECTROPHYSIOLOGY
EPA	ENVIRONMENTAL PROTECTION AGENCY
EPDM	ETHYLENE PROPYLENE DIENE MONOMER
EPO	ELECTRICAL POWER OFF

ARCHITECTURAL ABBREVIATIONS	
	DESCRIPTION
EPS	EXPANDED POLYSTYRENE BOARD
EQ or EQ SP or EQUIV	EQUAL / EQUALLY SPACED / EQUIVALENT
EQUIP	EQUIPMENT
ES	ELEVATOR SMOKE CONTAINMENT DOOR
ESC	ESCAPE OR ESCUTOHEON
ESCAL	ESCALATOR
ESMT	EASEMENT
EST	ESTIMATE
EW	ELECTRIC WATER COOLER
EWS	EYE WASH STATION
EXC	EXCAVATE / EXCAVATED / EXCAVATION
EXH	EXHAUST / EXHAUST HOOD
EXIST	EXISTING
EXP or EXP BT	EXPANSION / EXPOSED or EXPANSION BOLT
EXT or EXT GR	EXTINGUISHER / EXTERIOR or EXTERIOR GRADE
F	F
F	FLUSH DOOR
FA	FIRE ALARM
FAA	FIRE ALARM ANNUNCIATOR
FAB	FABRIC / FABRICATE
FACIL	FACILITY
FBC	FIRE BLANKET CABINET
FBR	FACE BRICK
FD	FLOOR DRAIN
FDN or FDTN	FOUNDATION
FDV	FIRE DEPARTMENT VALVE
FE	FIRE EXTINGUISHER
FEC	FIRE EXTINGUISHER CABINET
FF & E	FURNITURE, FURNISHINGS AND EQUIPMENT
FF EL	FINISHED FLOOR ELEVATION
FG	FULL GLASS
FGA	FRONT GLASS ALUMINUM
FGS	FOAM GASKET SEAL
FHP	FULL HEIGHT PARTITION
FHV	FIRE HOSE VALVE
FIN or FIN FL or FIN GR	FINISH / FINISHED or FINISHED FLOOR or FINISHED GRADE
FIXT	FIXTURE
FL MAT	FLOOR / FLOOR LINE
FLASH	FLASHING
FLDG	FOLDING
FLEX	FLEXIBLE
FLUOR	FLUORESCENT
FLURO	FLUROSCOPY / FLUROSCOPE
FO	FINISHED OPENING / FRAMED OPENING
FR	FIRE PROOFING / FIREPROOF
FR or FRMG	FRAME or FRAMING
FRQ	FREQUENT / FREQUENCY
FRP	FIBERGLASS REINFORCED PLASTIC PANEL
FRS or FR SNK	FLUSH RIM SINK
FRZ or FRZR	FREEZER
FS or FLR SK	FLOOR SINK
FASTNER	FASTENER
FR	FIRESTOPPING
FT	FOOT / FEET
FTG	FOOTING
FTR	FIN TUBE RADIATION
FURN	FURNITURE
FURR or FURG	FURRING
FUT	FUTURE
FV	FILM VIEWER
FVC	FIRE VALVE CABINET
FWC	FABRIC WALLCOVERING
FWP	FABRIC WRAPPED PANEL
G	GAS
GA	GAUGE
GAL	GALLON / GALLONS
GALV or GLAV	GALVANIZED / GALVANIZED STEEL
STEEL	STEEL
GB	GRAB BAR / GRADE BEAM
GC	GENERAL CONTRACTOR
GD or GDR	GUARD or GUARD RAIL
GEN	GENERATOR / GENERAL
GF	GROUND FAULT INTERRUPTER
GFRR or GFRC or GFRR	GLASS FIBER REINFORCED GYPSUM or CONCRETE or PLASTIC
GL	GLAZING
GL	GLASS / GLAZING
GM	GLASS MASONRY UNIT
GPS	GRAPHIC PANEL SYSTEM
GSM	GALVANIZED SHEET METAL
GT	GLASS TILE / GROUT
GYN	GYNECOLOGY
GYP or GYB or GYW	GYPSUM / GYPSUM BOARD
GYP SHTG or GSB	GYPSUM SHEATHING
H	H
H	HUMIDISTAT
HAZ MAT	HAZARDOUS MATERIAL
HB	HOSE BIB
HD	HAND DRYER
HDWR or HDW	HARDWARE
HG	HALF GLASS
HM	HOLLOW METAL
HMD or HMD/ or HMF	HOLLOW METAL DOOR or HOLLOW METAL DOOR AND FRAME or HOLLOW METAL FRAME
HO	HOLD OPEN
HORIZ	HORIZONTAL
HOSP	HOSPITAL
HPC	HIGH PERFORMANCE COATING
HPDL	PLASTIC LAMINATE
HPT	HIGHPOINT
HQ	HEADQUARTERS
HR or HNRDL	HANDRAIL / HOUR
HS	HIGH STRENGTH
HSAN	HAND SANITIZER
HSE or HSKG	HOUSE / HOUSEKEEPING
HST	HIGH STRENGTH
HT	HEIGHT
HTR	HEATER
HVAC	HEATING, VENTILATING, AIR CONDITIONING
HWD	HARDWOOD
HWR	HAZARDOUS WASTE RECEPTACLE
HWS	HANDWASH STATION
HWU	HEAD WALL UNIT / HOT WATER UNIT
HYD	HYDRANT
HYDR	HYDRAULIC
I	I
IBC	INTERNATIONAL BUILDING CODE
IC or INTERCOM	INTERCOM / INTERCOMMUNICATION
ICU	INTENSIVE CARE UNIT
ID	INSIDE DIAMETER / IDENTIFICATION / INTERIOR DESIGN
ILLUM	ILLUMINATION
IMPF	INTUMESCENT MASTIC FIRE PROOFING
IN	INTERIOR
INCL	INCLUDE / INCLUDED / INCLUSIVE
INFO	INFORMATION
INSUL	INSULATION
INT	INTERIOR
INTL	INTERNATIONAL
IO	INFORMATION OUTLET
IOP	ISOLATED POWER PANEL


ARCHITECTURAL ABBREVIATIONS	
	DESCRIPTION
ISOL	ISOLATION / ISOLATED
INTROV	INTROVENOUS
INTV	INTROVENOUS TRACK
J	J
JAN	JANITOR
JB or J-BOX	JUNCTION BOX
JST	JOIST
JT	JOINT
K	K
KBD	KEYBOARD
KITCH	KITCHEN
KD or KD	KNOCK-OUT PANEL / KNOCK-DOWN PANEL
KPL	KICK PLATE
L	L
L	ANGLE
L/S	LIFE SAFETY
LA	LABORATORY AIR
LAB	LABORATORY
LAD	LADDER
LAM	LAMINATED
LAN	LOCAL AREA NETWORK
LAV	LAVATORY
LB	POUND / POUNDS
LD	LINEAR CEILING DIFFUSER / LIQUID CRYSTAL DISPLAY
LDPR	LABOR DELIVERY RECOVERY POSTPARTUM
LED	LIGHT EMITTING DIODE
LEED	LEADERSHIP IN ENERGY & ENVIRONMENTAL DESIGN
LEF	LINEAR FOOT / FEET / LINE FIGURED
LH or LHR	LEFT HAND / LEFT HAND REVERSE or LATENT HEAT RATIO
LIB	LIBRARY
LIN	LINEAR
LKR or LKR RM	LOCKER / LOCKER ROOM
LL	LEAD LINED
LLH	LONG LEG HORIZONTAL
LHP	LONG LEG VERTICAL
LMC	LINEAR METAL CEILING
LNDSCP	LANDSCAPE / LANDSCAPING
LOC	LOCATION / LOCATE
LPT	LOW POINT
LT or LT GA or LT WT	LIGHT / LIGHT GAGE / LIGHT WEIGHT
FLR MAT	FLOOR MAT
FLASH	FLASHING
LTG or LTNG	LIGHTING / LIGHTNING
LVR	LOUVER
LWC	LINEAR WOOD CEILING
LWC or LWIC	LIGHTWEIGHT CONCRETE / LIGHTWEIGHT INSULATING CONCRETE
LWT	LIGHT WEIGHT
LVR	LAYER
M	METER / METERS
MA	MEDICAL AIR
MACH or MACH ROOM	MACHINE / MACHINE ROOM
MAINT	MAINTENANCE
MATL	MATERIAL
MAX	MAXIMUM
MBD or MKR BD or MKR	MARKER BOARD / MARKER
MOP or MOPR	MOP AND BROOM HOLDER / MOP RACK
MC	MEDICINE CABINET
MCU	MODULAR COOLING UNIT
MD	MEDIUM DENSITY FIBERBOARD
MECH or MECH RM	MECHANICAL / MECHANICAL ROOM
MEM	MEMBRANE
MEP	MECHANICAL, ELECTRICAL AND PLUMBING
MET or MTL	METAL / ORNAMENTAL METAL
MEZZ	MEZZANINE
MFG or MFD or MFG	MANUFACTURER / MANUFACTURED / MANUFACTURING
MGA	MEDICAL GAS ALARM
MH	MARSHALE
MHC	MATERIAL HANDLING CONVEYOR
MHO	MAGNETIC HOLD OPEN
MIC	MICROPHONE
MICRO	MICROWAVE
MIN	MINIMUM / MINUTE
MIR or MRR	MIRROR
MISC	MISCELLANEOUS
MLDG	MOLDING
MOLD	MOLDING
MLWK	MILLWORK
MO	MASONRY OPENING / MOTOR OPERATED
MOD or MOD BIT	MODIFY / MODIFIED or MODIFIED BITUMIN
MON	MONITOR / MONITORING
MONO	MONOLITH
MP	METAL PANEL
MP or MPU	MULTI-PURPOSE / MULTI-PURPOSE UNIT
MPC	METAL PAN CEILING
MR	MOISTURE RESISTANT
MRI	MAGNETIC RESONANCE IMAGING
MTD or MTG	MOUNTED / MOUNTING
MTR	MOTOR
MULL	MULLION
N	N
N	NARROW LITE / NORTH / NITROGEN
NZO	NITROUS OXIDE
NA	NOT APPLICABLE
NAAMN	NATIONAL ASSOCIATION OF ARCHITECTURAL METAL MANUFACTURERS
NAT or NATL	NATURAL / NATIONAL
N	NURSE CALL / NOISE CRITERIA
NEC	NATIONAL ELECTRICAL CODE
NEMA	NATIONAL ELECTRICAL MANUFACTURERS ASSOCIATION
NFC	NATIONAL FIRE CODE
NFPA	NATIONAL FIRE PROTECTION ASSOCIATION
NIC	NOT IN CONTRACT
NICU	NEONATAL INTENSIVE CARE UNIT
NIGHT LIGHT	NIGHT LIGHT
NO	NUMBER
NOM	NOMINAL
NOUR	NOURISHMENT
NR or NRP	NONREMOVABLE / NONREMOVABLE PANEL
NRC	NOISE REDUCTION COEFFICIENT
NRCA	NATIONAL ROOFING CONTRACTORS ASSOCIATION
NS	NURSE STATION
NT	NOTE
NTS	NOT TO SCALE
NUC	NUCLEAR
O	O
O	OXYGEN
OA	OVERALL / OUTSIDE AIR
OB	ON BOARD
OC	ON CENTER
OC or OCCY	OCCUPANT / OCCUPY or OCCUPANCY
OD	OUTSIDE DIAMETER
OFCI or OFCI	OWNER FURNISHED CONTRACTOR INSTALLED
OFF	OFFICE
OFOI or OFOI	OWNER FURNISHED OWNER INSTALLED
OFS	OVERFLOW SCUPPER
OH or OH DR or QHD	OVERHEAD / OVERHEAD DOOR
OP	OPERABLE PARTITION / OUT PATIENT
OPER	OPERATOR
OPNG	OPENING
OPP	OPPOSITE
OR	OPERATING ROOM / OUTSIDE RADIUS

ARCHITECTURAL ABBREVIATIONS	
	DESCRIPTION
ORD or OFD	OVERFLOW ROOF DRAIN
ORIG	ORIGIN / ORIGINAL
ORN	ORNAMENTAL
ORTHO	ORTHOPEDICS
OSHA	OPERATIONAL SAFETY AND HEALTH ADMINISTRATION
OT	OPERATIONAL THERAPY / OPERATING THEATER
OTO	OTOSCOPE
OZ	OUNCE
P	P
OR PT	PAINT
PACU	POST ANESTHESIA CARE UNIT
PAR	PARALLEL / PARAPET
PARK or PRKG	PARKING
PART or PTN	PARTIAL / PARTITION
PAT	PATTERN
PB	PUSH BUTTON
PBD	PARTIALBOARD
PC	PERSONAL COMPUTER / PRECAST CONCRETE / PORTLAND CEMENT
PCD	PAPER CUP DISPENSER
PCT	PORCELINO TILE
PED	PEDESTAL

FLOOR PLAN GENERAL NOTES

- FOR GENERAL SYMBOLS, MATERIALS AND ABBREVIATIONS, SEE A-0.01 & A-0.02.
- FOR FLOOR FINISHES REFER TO FLOOR PLAN AT A-1.01 AND SCHEDULE OF FINISHES.
- FOR CEILING INFORMATION REFER TO A-2.01
- ALL WALLS TO BE 44 UNO.

LIFE SAFETY LEGEND

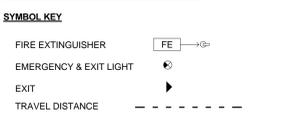

GENERAL:
THE VA HAS ADOPTED THE LATEST EDITION OF THE FOLLOWING CODES & STANDARDS:

- CODES, STANDARDS AND EXECUTIVE ORDERS**
- VA DIRECTIVES, DESIGN MANUALS, MASTER SPECIFICATIONS, VA NATIONAL CAD STANDARD APPLICATION GUIDE, AND OTHER GUIDANCE ON THE TECHNICAL INFORMATION LIBRARY (TIL)
 - INTERNATIONAL BUILDING CODE (IBC) (SEE NOTES BELOW)
 - NFPA 101 LIFE SAFETY CODE (SEE NOTES BELOW)
 - NFPA NATIONAL FIRE CODES WITH EXCEPTION OF NFPA 5000 AND NFPA 900
 - OCCUPATIONAL SAFETY AND HEALTH ADMINISTRATION (OSHA) STANDARDS
 - VA SEISMIC DESIGN REQUIREMENTS, H-18-8
 - NATIONAL ELECTRICAL CODE (NEC)
 - NATIONAL STANDARD PLUMBING CODE (NSPC)
 - ASME BOILER AND PRESSURE VESSEL CODE
 - ASME CODE FOR PRESSURE PIPING
 - UNIFORM FEDERAL ACCESSIBILITY STANDARDS (UFAS) INCLUDING VA SUPPLEMENT BARRIER FREE DESIGN
 - BUILDING CODE REQUIREMENTS FOR REINFORCED CONCRETE, AMERICAN CONCRETE INSTITUTE AND COMMENTARY (ACI 318)
 - MANUAL OF STEEL CONSTRUCTION, LOAD AND RESISTANCE FACTOR DESIGN SPECIFICATIONS FOR STRUCTURAL STEEL BUILDINGS, AMERICAN INSTITUTE OF STEEL CONSTRUCTION (AISC)
 - ENERGY POLICY ACT OF 2005 (EPAct)
 - DOE INTERIM FINAL RULE: ENERGY CONSERVATION STANDARDS FOR NEW FEDERAL, COMMERCIAL AND MULTI-FAMILY HIGH-RISE RESIDENTIAL BUILDINGS AND NEW LOW-RISE RESIDENTIAL BUILDINGS, 10 CFR PARTS 433, 434 AND 435
 - FEDERAL LEADERSHIP IN HIGH PERFORMANCE AND SUSTAINABLE BUILDING: MEMORANDUM OF UNDERSTANDING (MOU)
 - EXECUTIVE ORDER 13423: STRENGTHENING FEDERAL ENVIRONMENTAL, ENERGY, AND TRANSPORTATION MANAGEMENT
 - THE PROVISIONS FOR CONSTRUCTION AND SAFETY SIGNS, STATED IN THE GENERAL REQUIREMENTS SECTION 01010 OF THE VA MASTER CONSTRUCTION SPECIFICATION
 - VENTILATION FOR ACCEPTABLE INDOOR AIR QUALITY - ASHRAE STANDARD 62.1-2004
 - SAFETY STANDARD FOR REFRIGERATION SYSTEMS - ASHRAE STANDARD 15 - 2007
 - VA FIRE PROTECTION DESIGN MANUAL

OCCUPANCY CLASSIFICATION

IBC SECTION 304 BUSINESS GROUP "B" AND SECTION 311.2 STORAGE GROUP S-1 MODERATE HAZARD OCCUPANCY.

REQUIRED SEPARATION OF OCCUPANCY

IBC TABLE 508.4 REQUIRED SEPARATION OF OCCUPANCIES (HOURS)
BUSINESS AND STORAGE S-1 MODERATE HAZARD STORAGE, NO SPRINKLERED BUILDINGS, IS PERMITTED, NO SEPARATION REQUIREMENT.

OCCUPANT LOAD FACTOR

PER IBC 1004.1.2
100 SF/OCCUPANT LOAD FACTOR AT BUSINESS OCCUPANCY
15 NET OCCUPANT LOAD FACTOR AT MODERATE HAZARD STORAGE.

AREAS

BUSINESS AREA 1,103 GSF
MODERATE HAZARD STORAGE AREA 597 GSF
BUSINESS: 1,103 GSF / 100 SF/OCC = 12 OCCUPANTS
MODERATE HAZARD STORAGE: 720 GSF / 15 OCC/NET = 15 OCCUPANTS

TOTAL OCCUPANCY LOAD: 27 OCCUPANTS

EXITS

BUSINESS AREA:
2 EXITS CLEAR WIDTH PROVIDED 68"
1 EXIT EACH BATHROOM CLEAR WIDTH 34" EACH
MODERATE HAZARD STORAGE AREA:
1 EXIT CLEAR WIDTH PROVIDED 34"

AS PER IBC TABLE 1006.1 MINIMUM EXIT WIDTH REQUIRED 44.5' CLEAR

BUILDING CODES AND STANDARDS, VA KENTUCKY WASH BAY AND STORAGE BUILDING PROJECT.

Permitted Means of Egress Components per section 38 include: Doors, Stairs, Horizontal Exits, Ramps, Passage ways, Fire Escape Ladders, Alternating tread devices.

Travel Distance to Exit as per 38.2.6.2 shall not exceed 200 ft if not equipped with automatic sprinkler system.

As per IBC Table 503, allowable height and building areas:
Type V (B) for B and S occupancy.
B occupancy, 2 stories height, 8,000 sq. ft per story.
S-1 occupancy, 2 stories height, 13,500 sq ft per story.


Unlimited area per floor:
Construction Type I (442), I (332), or Type II (222) with roof and supports complying with Class A ASTM E108 and NFPA 220.

Noncontinuous projections 6" or less from the wall and not less than 38" above the floor are permitted, per 19.2.3.4 and 19.2.3.4.


Dead End Corridors per 19.2.5.2, maximum length 30'-0".
Travel Distance to an Exit per 19.2.6 150'-0"
Boiler, Mechanical and Electrical room maximum travel distance 100'-0" per 7.12.1 (1). Elsewhere travel distance 500'-0".

Fire Extinguishers per 19.3.5 and NFPA 10, required to be placed no more than 75'-0" apart.
GENERAL REQUIREMENTS: NFPA 101 LIFE SAFETY CODE.
Headroom, minimum 7'-6" with projections minimum 6'-8".
Doors, must swing in the direction of egress where numbers of occupants exceed 50. As per 7.2.1.2.3.2 door opening in means of egress shall be not less than 32" in clear width.

Egress widths factor per Table 7.3.3.1, level components 0.2' per occupant per 19.2.3.2.

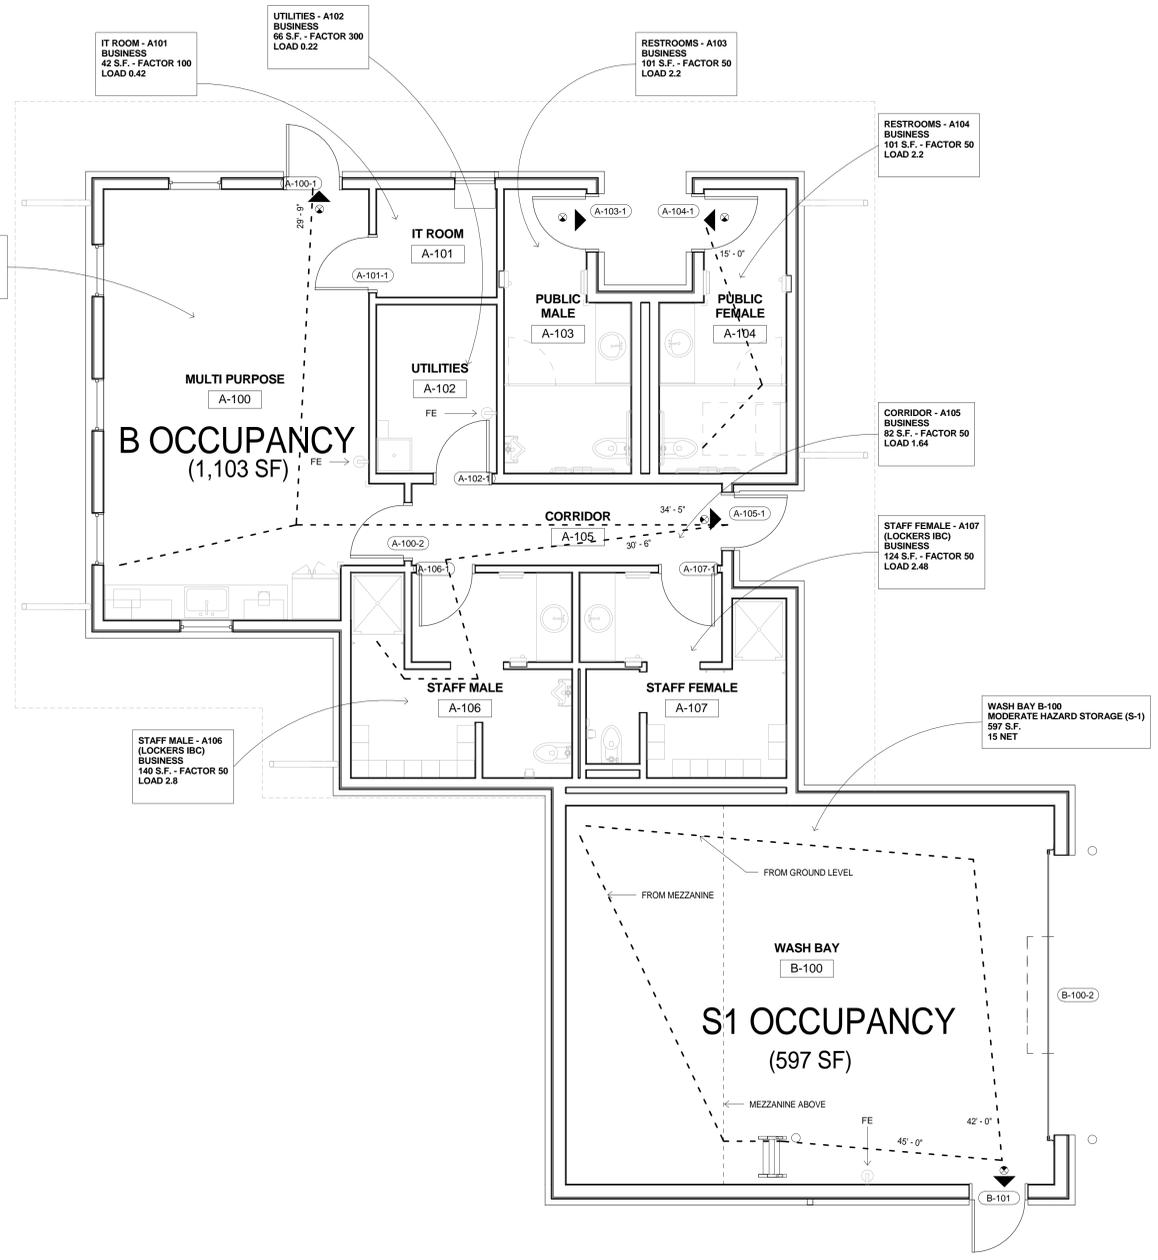

1 CODE REVIEW PLAN
1/4" = 1'-0"

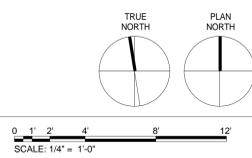

100% CONSTRUCTION DOCUMENTS

<p>CONSULTANTS:</p> <p>AEI AMERICAN ENGINEERS, INC. 65 ABERDEEN DR. GLASGOW, KY 42341 (270) 651-7220 TEL. (270) 651-3246 FAX WWW.AEI.CC</p> <p>AST ADVANCED STRUCTURAL TECHNOLOGIES 7212 METRO BLVD EDINA, MN 55439 (952) 854-9302 TEL. (952) 854-9690 FAX WWW.ASTMN.COM</p> <p>KJWW ENGINEERING CONSULTANTS Experience you can build on™ STRUCTURAL, MECHANICAL, ELECTRICAL, TECHNOLOGY, MEDICAL EQUIPMENT SOLUTIONS (309) 788-0673 TEL. (309) 786-5947 FAX QUAD CITIES, IL. WWW.KJWW.COM</p>	<p>I HEREBY CERTIFY THAT THIS PLAN, SPECIFICATION OR REPORT WAS PREPARED BY ME OR UNDER MY DIRECT SUPERVISION, AND THAT I AM A DULY LICENSED ARCHITECT UNDER THE LAWS OF THE STATE OF MINNESOTA.</p> <p>PRINTED NAME: PAUL D. DAHLBERG SIGNATURE: [Signature] DATE: 05-20-2015 LICENSE #: 15870</p>	<p>ARCHITECT/ENGINEERS:</p> <p>ANDERSON ENGINEERING Anderson Engineering of Minnesota, LLC 13605 1st Avenue North Suite 100 Plymouth, MN 55441 763-412-4000 (O) 763-412-4090 (F) www.ae-mn.com</p>	<p>Drawing Title LIFE SAFETY CODE NOTES AND LIFE SAFETY PLAN</p> <p>Approved: Project Director</p>	<p>Project Title WASH BAY / STORAGE BUILDING</p>	<p>Project Number 833-CM3-026</p>	<p>National Cemetery Administration Department of Veterans Affairs</p>	
				<p>Location CAMP NELSON NATIONAL CEMETERY NICHOLASVILLE, KENTUCKY</p>	<p>Building Number 3003</p>		<p>Drawing Number A-0.03</p>
<p>Revisions:</p>	<p>Date</p>	<p>Date May 20, 2015</p>	<p>Checked PD</p>	<p>Drawn SC</p>	<p>Date May 20, 2015</p>	<p>Checked PD</p>	<p>Drawn SC</p>


- FLOOR PLAN GENERAL NOTES**
- FOR GENERAL SYMBOLS, MATERIALS AND ABBREVIATIONS, SEE A-0.01 & A-0.02.
 - FOR FLOOR FINISHES REFER TO FLOOR PLAN AT A-1.01 AND SCHEDULE OF FINISHES.
 - FOR CEILING INFORMATION REFER TO A-2.01
 - ALL WALLS TO BE A4, UNO.

- FINISH NOTES**
- REFER TO FLOOR PLAN AND INTERIOR ELEVATIONS FOR ADDITIONAL FINISH INFORMATION.
 - CEILING HEIGHTS ARE MEASURED FROM FINISH FLOOR, CEILING HEIGHTS AND CEILING MATERIALS/FINISHES CALLED OUT ON THE REFLECTED CEILING PLAN ARE FOR ENTIRE CEILING OR MAJORITY OF THAT ROOM, UNLESS OTHERWISE INDICATED. SEE REFLECTED CEILING PLAN FOR CHANGES IN CEILING MATERIAL AND CEILING HEIGHT.
 - LOCATE CHANGES IN FLOOR FINISH MATERIAL UNDER CENTERLINE OF CLOSED DOOR UNLESS OTHERWISE INDICATED.
 - PROVIDE SEALANT AT JOINT BETWEEN COUNTER TOP, BACK OR SIDE SPLASH AND WALLS.
 - ALL CEILING MATERIAL MUST HAVE CLASS 'A' FIRE RATING.
 - PAINT ALL NON SST FIRE EXTINGUISHER CABINETS, VENTS, GRILLES, PLUG STRIP, ELECTRICAL PANEL BOARDS, DIFFUSERS, AND EXPOSED DUCTS TO MATCH ADJACENT SURFACE FINISH.


- TYPICAL INTERIOR FINISHES**
- ALL WALLS TO BE PAINTED PT-1, UNO.
 - ALL VANITY TOPS IN PUBLIC AND STAFF BATHROOMS TO BE SSF-1, UNO.
 - KITCHEN TOP TO BE PLAM-1.
 - ALL WALL APPLIED CERAMIC TILE CT-1, UNO.
 - FLOOR TILE TO BE PORCELAIN TILE-1 (PCT-1)
 - PROVIDE AND MATCH PORCELAIN TILE BASE IN ROOMS WITH FLOOR TILE, UNO.
 - HOLLOW EXTERIOR METAL DOORS AND FRAMES TO BE PAINTED P15, UNO. THE SAME COLOR AND TYPE OF PAINT ON BOTH SIDES, UNO.
 - HOLLOW INTERIOR METAL DOORS AND FRAMES TO BE PAINTED P15, UNO. THE SAME COLOR AND TYPE OF PAINT ON BOTH SIDES, UNO.

FINISHES
REFER TO SCHEDULE OF FINISHES.

2 MEZZANINE FLOOR PLAN
1/4" = 1'-0"

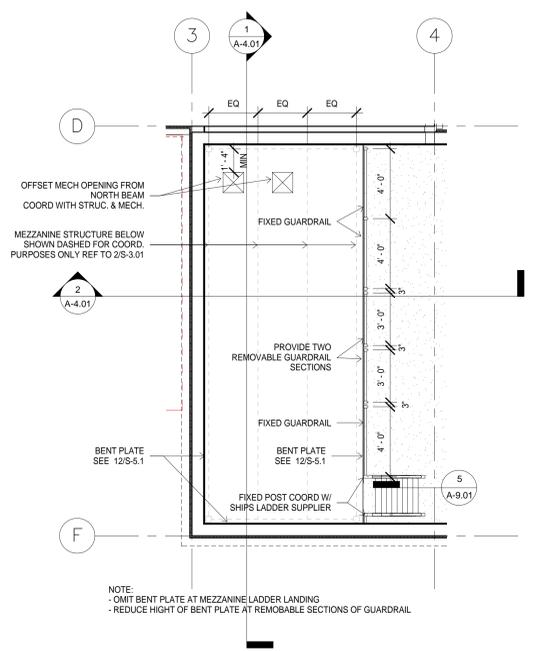


1 FIRST FLOOR PLAN
1/4" = 1'-0"

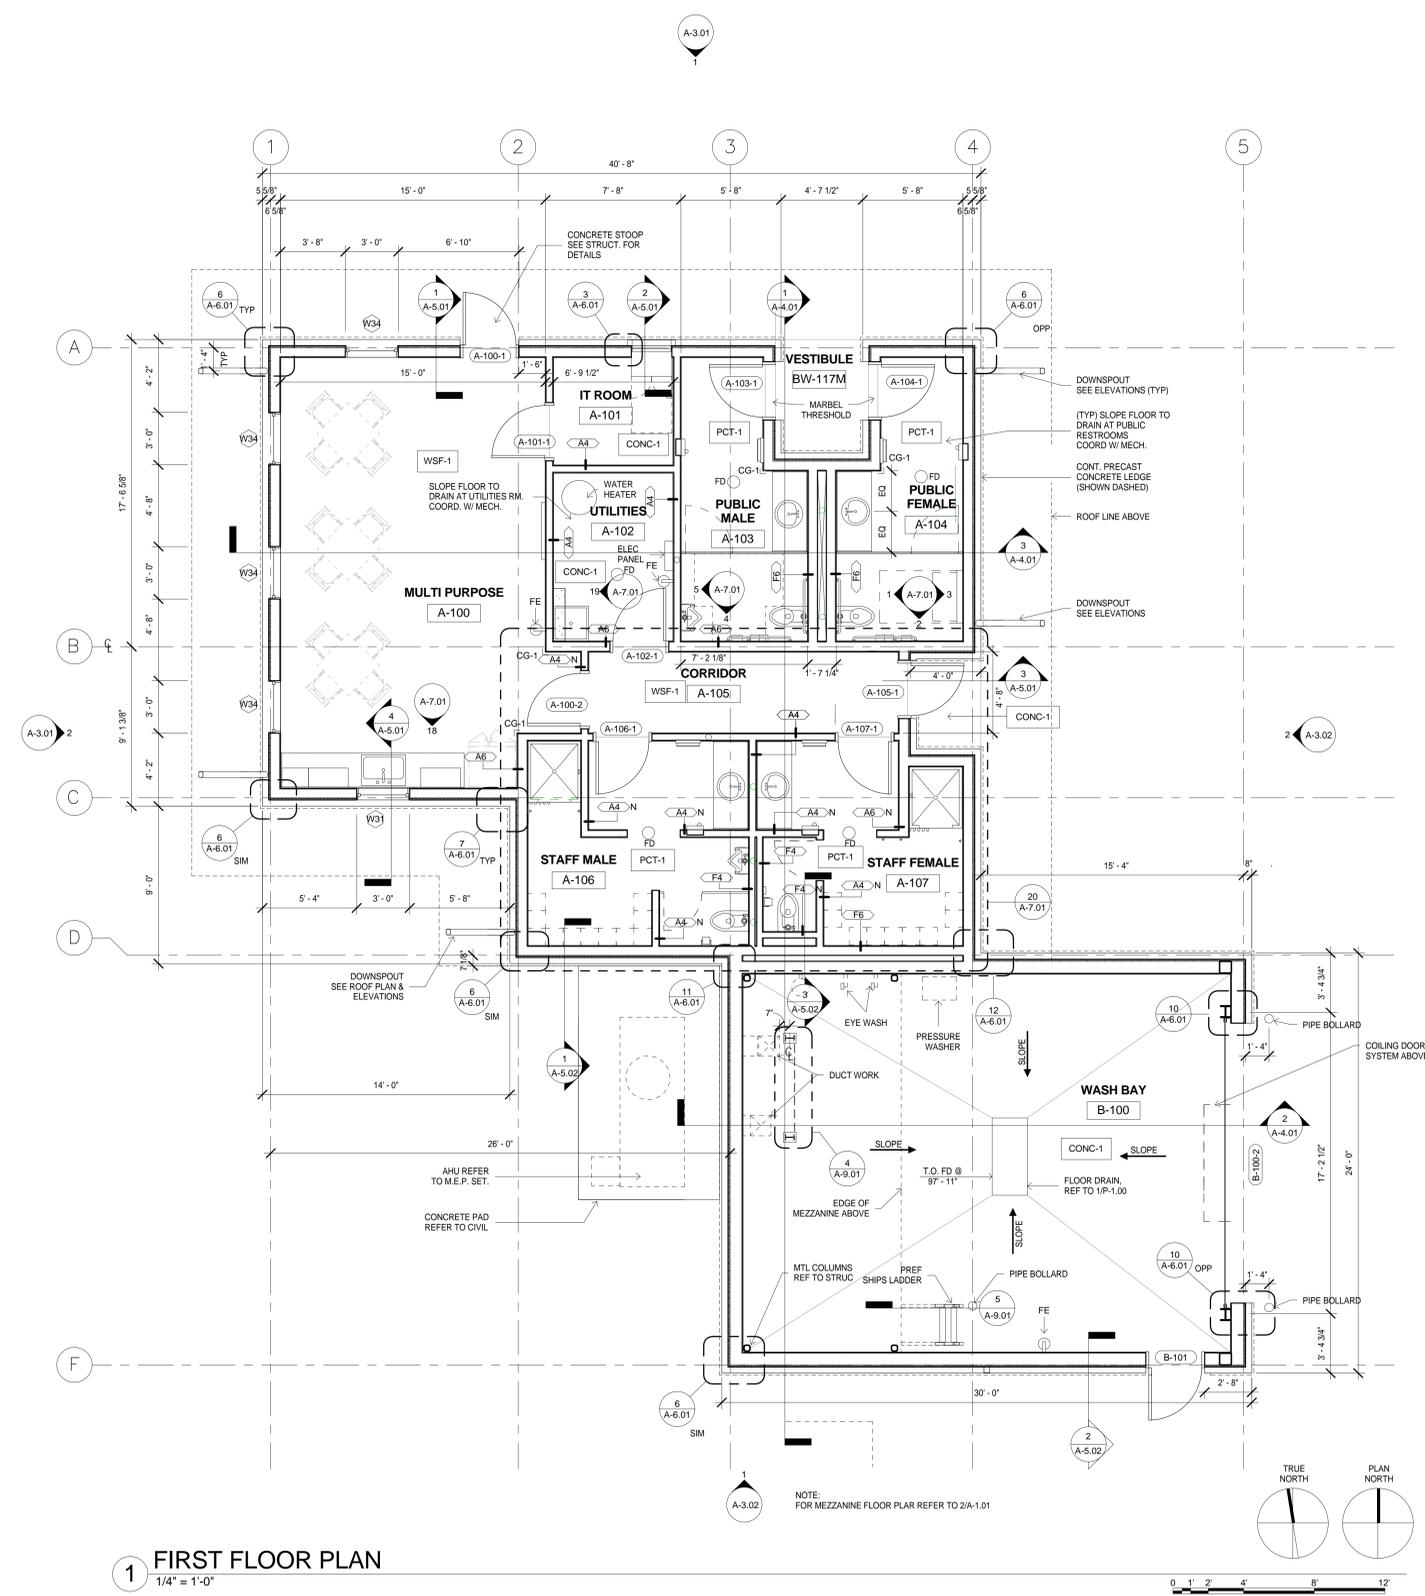


100% CONSTRUCTION DOCUMENTS

CONSULTANTS: 	ARCHITECT/ENGINEERS: Anderson Engineering of Minnesota, LLC 13605 1st Avenue North Suite 100 Plymouth, MN 55441 763-412-4000 (o) 763-412-4090 (f) www.ae-mn.com		Drawing Title FIRST FLOOR PLAN	Project Title WASH BAY / STORAGE BUILDING	Project Number 833-CM3-026	National Cemetery Administration 	
	I HEREBY CERTIFY THAT THIS PLAN, SPECIFICATION OR REPORT WAS PREPARED BY ME OR UNDER MY DIRECT SUPERVISION, AND THAT I AM A DULY LICENSED ARCHITECT UNDER THE LAWS OF THE STATE OF MINNESOTA. PRINTED NAME: PAUL D. DAHLBERG SIGNATURE: DATE: 05-20-2015 LICENSE #: 15870		Approved: Project Director	Location CAMP NELSON NATIONAL CEMETERY NICHOLASVILLE, KENTUCKY	Building Number 3003		
	Revisions: _____ Date _____		Date May 20, 2015	Checked PD	Drawn SC		Drawing Number A-1.01
	VA FORM 08-6231		License # 15870	Date May 20, 2015	Checked PD		Drawn SC

- FLOOR PLAN GENERAL NOTES
1. FOR GENERAL SYMBOLS, MATERIALS AND ABBREVIATIONS, SEE A-0.01 & A-0.02.
 2. FOR FLOOR FINISHES REFER TO FLOOR PLAN AT A-1.01 AND SCHEDULE OF FINISHES.
 3. FOR CEILING INFORMATION REFER TO A-2.01
 4. ALL WALLS TO BE A4, UNO.

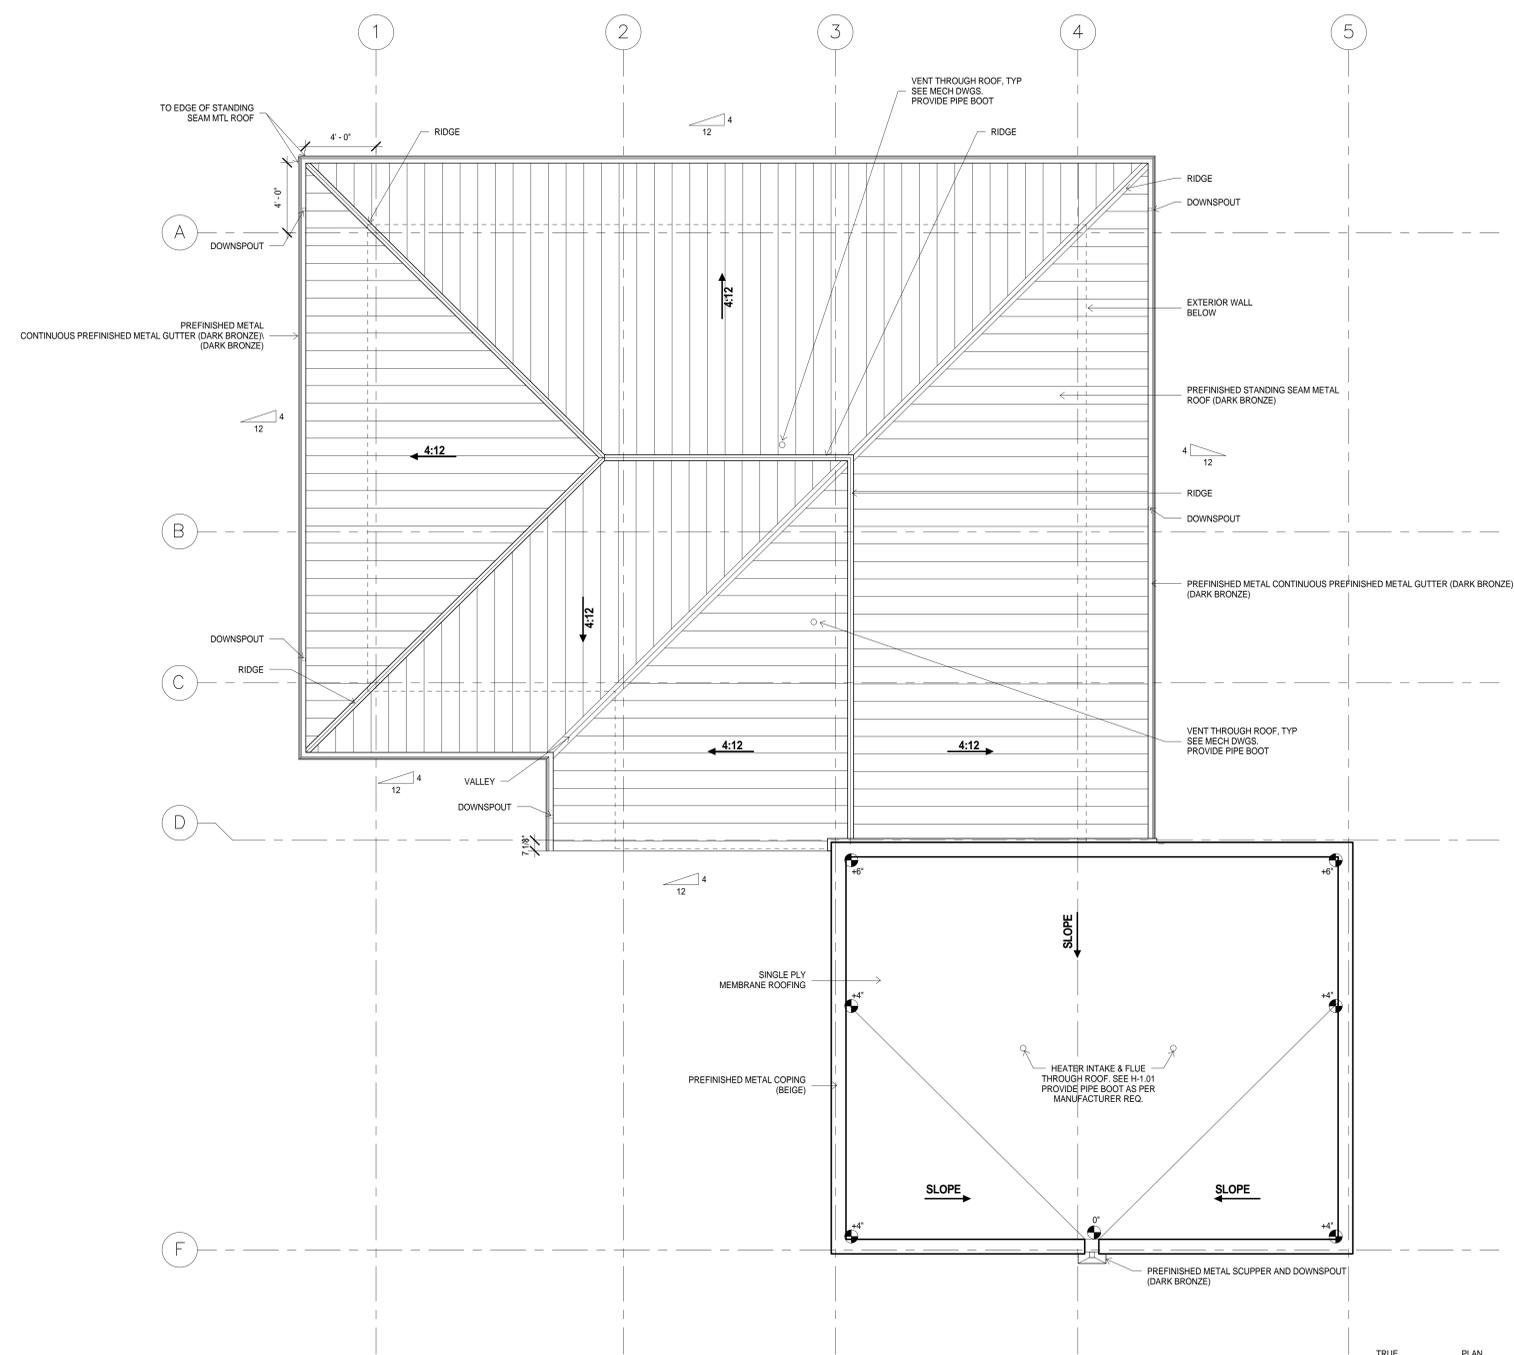

1 ROOF PLAN
1/4" = 1'-0"

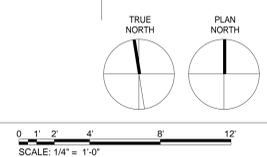

100% CONSTRUCTION DOCUMENTS

Revisions:	Date

CONSULTANTS:

AEI AMERICAN ENGINEERS, INC.
65 ABERDEEN DR.
GLASGOW, KY 42341
(270) 651-7220 TEL. (270) 651-3246 FAX
WWW.AEI.CC

AST ADVANCED STRUCTURAL TECHNOLOGIES
7212 METRO BLVD
EDINA, MN 55439
(952) 854-9202 TEL. (952) 854-9690 FAX
WWW.ASTMN.COM

KJWW ENGINEERING CONSULTANTS
Experience you can build on.
STRUCTURAL, MECHANICAL, ELECTRICAL
TECHNOLOGY, MEDICAL EQUIPMENT SOLUTIONS
(309) 788-0673 TEL. (309) 786-5967 FAX
QUAD CITIES, IL. WWW.KJWW.COM

I HEREBY CERTIFY THAT THIS PLAN, SPECIFICATION OR REPORT WAS PREPARED BY ME OR UNDER MY DIRECT SUPERVISION, AND THAT I AM A DULY LICENSED ARCHITECT UNDER THE LAWS OF THE STATE OF MINNESOTA.

PRINTED NAME: PAUL D. DAHLBERG
SIGNATURE: *[Signature]*
DATE: 05-20-2015
LICENSE #: 15870

ARCHITECT/ENGINEERS:

ANDERSON ENGINEERING
ENGINEERING • ARCHITECTURE • LAND SURVEYING
ENVIRONMENTAL SERVICES • LANDSCAPE ARCHITECTURE

Anderson Engineering of Minnesota, LLC
13605 1st Avenue North
Suite 100
Plymouth, MN 55441
763-412-4000 (t) 763-412-4090 (f)
www.ae-mn.com


Drawing Title
ROOF PLAN

Approved: Project Director


Project Title WASH BAY / STORAGE BUILDING		Project Number 833-CM3-026
Location CAMP NELSON NATIONAL CEMETERY NICHOLASVILLE, KENTUCKY		Building Number 3003
Date May 20, 2015	Checked PD	Drawn SC
Drawing Number A-1.02		Dwg 20 of 53

National Cemetery Administration


Department of Veterans Affairs

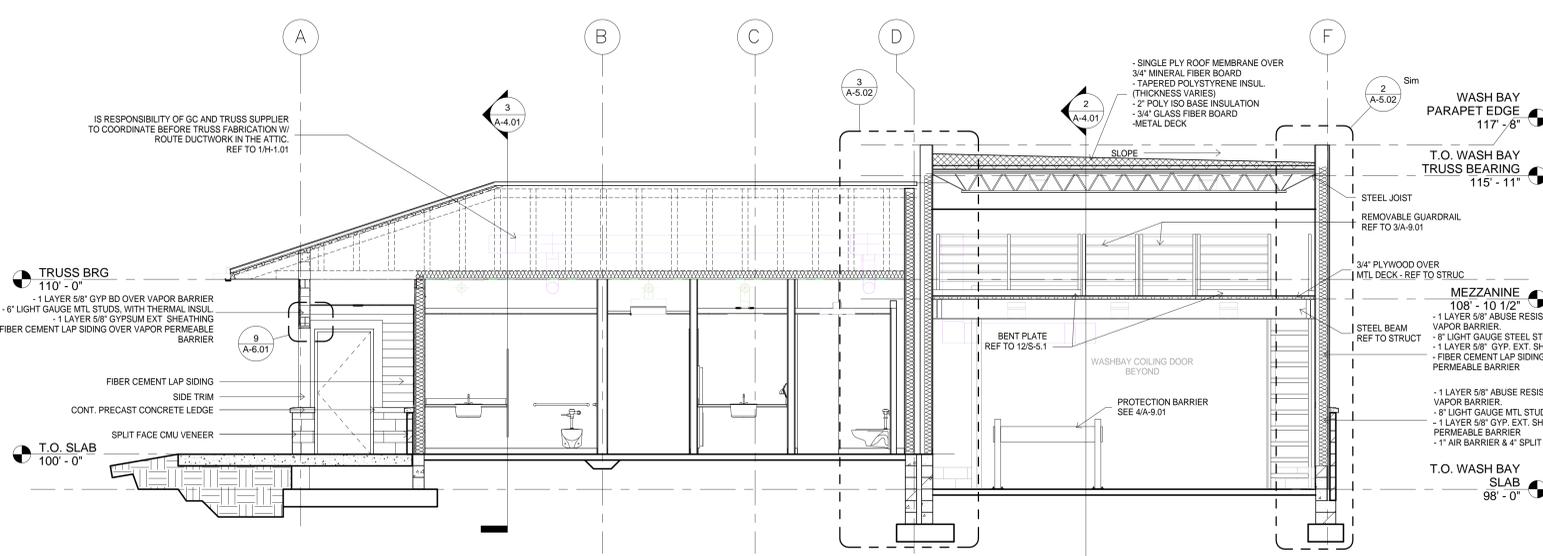

1 NORTH-SOUTH OVERALL BUILDING SECTION
1/4" = 1'-0"

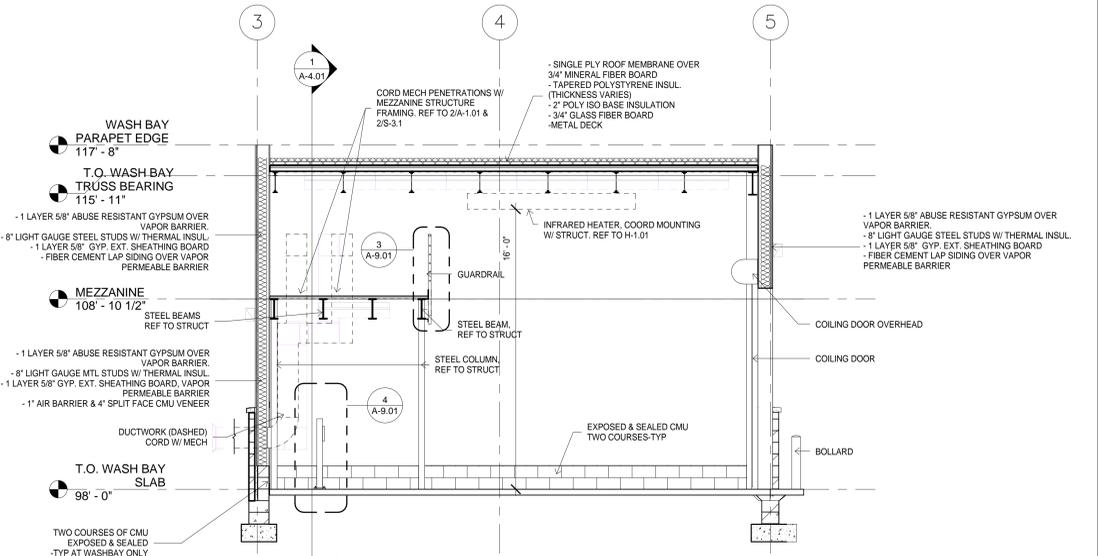


2 WASH BAY BUILDING SECTION EAST-WEST
1/4" = 1'-0"

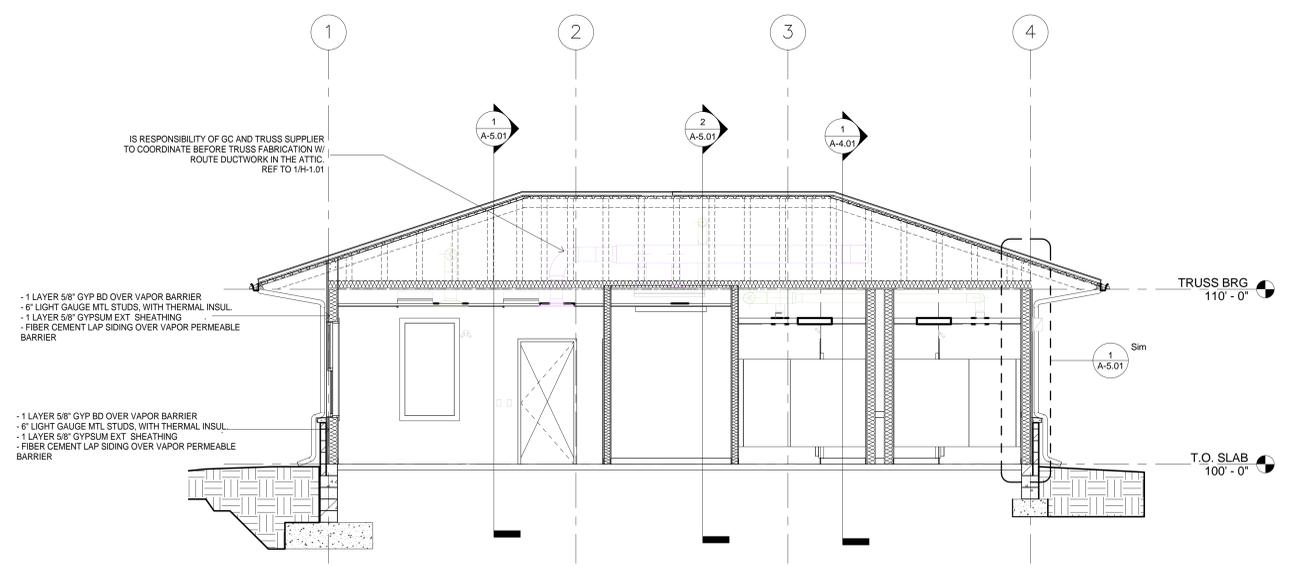


3 STORAGE BUILDING EAST-WEST SECTION
1/4" = 1'-0"

100% CONSTRUCTION DOCUMENTS


CONSULTANTS: 	ARCHITECT/ENGINEERS: 	Drawing Title BUILDING SECTIONS	Project Title WASH BAY / STORAGE BUILDING	Project Number 833-CM3-026	National Cemetery Administration 	
		Approved: Project Director	Location CAMP NELSON NATIONAL CEMETERY NICHOLASVILLE, KENTUCKY	Building Number 3003		Drawing Number A-4.01
Revisions:	I HEREBY CERTIFY THAT THIS PLAN, SPECIFICATION OR REPORT WAS PREPARED BY ME OR UNDER MY DIRECT SUPERVISION, AND THAT I AM A DULY LICENSED ARCHITECT UNDER THE LAWS OF THE STATE OF MINNESOTA. PRINTED NAME: PAUL D. DAHLBERG SIGNATURE: DATE: 05-20-2015 LICENSE #: 15870	Anderson Engineering of Minnesota, LLC 13605 1st Avenue North Suite 100 Plymouth, MN 55441 763-412-4000 (o) 763-412-4090 (f) www.ae-mn.com	Date May 20, 2015	Checked PD	Drawn SC	Dwg. 24 of 53

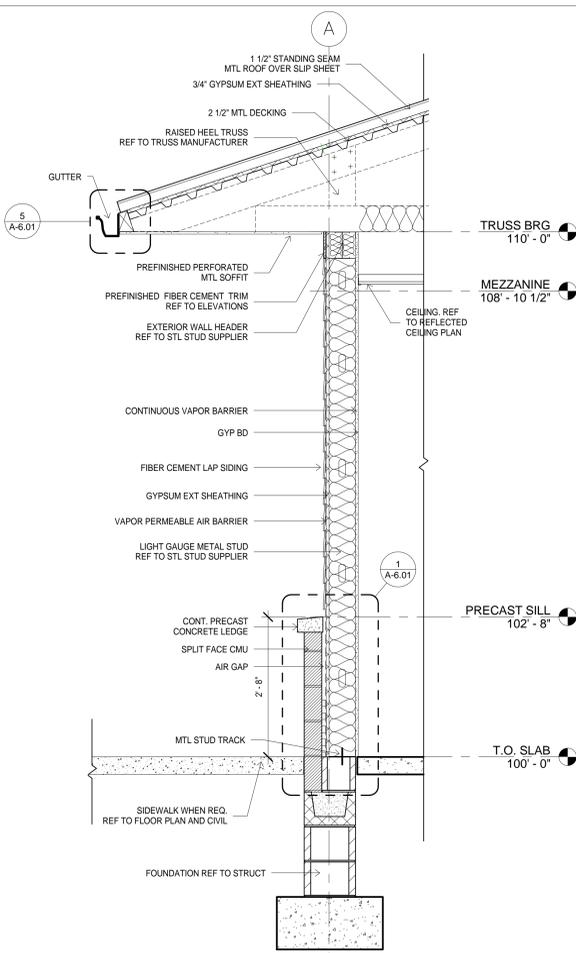


1 WALL SECTION STORAGE BUILDING-TYP
3/4" = 1'-0"

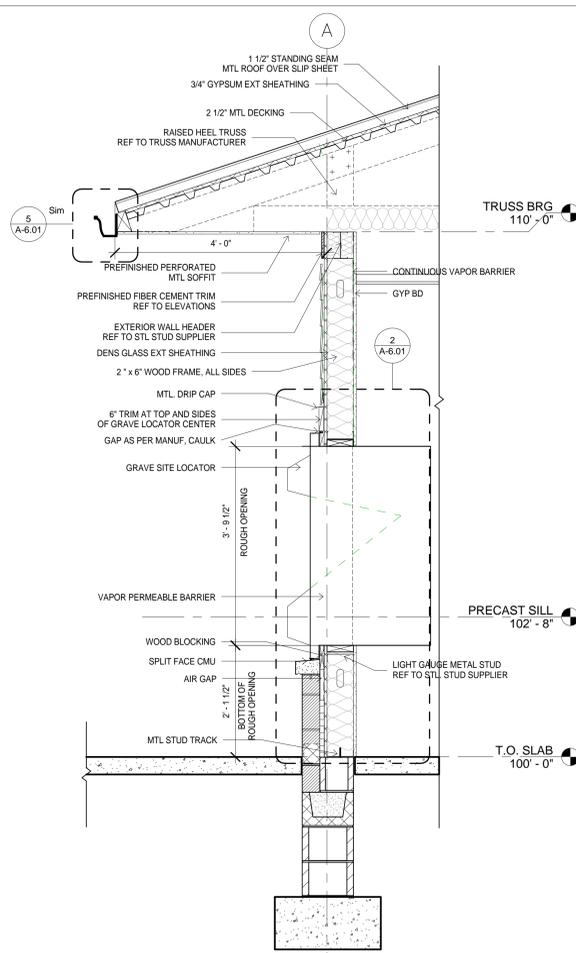

2 WALL SECTION AT GRAVE SITE LOCATOR
3/4" = 1'-0"

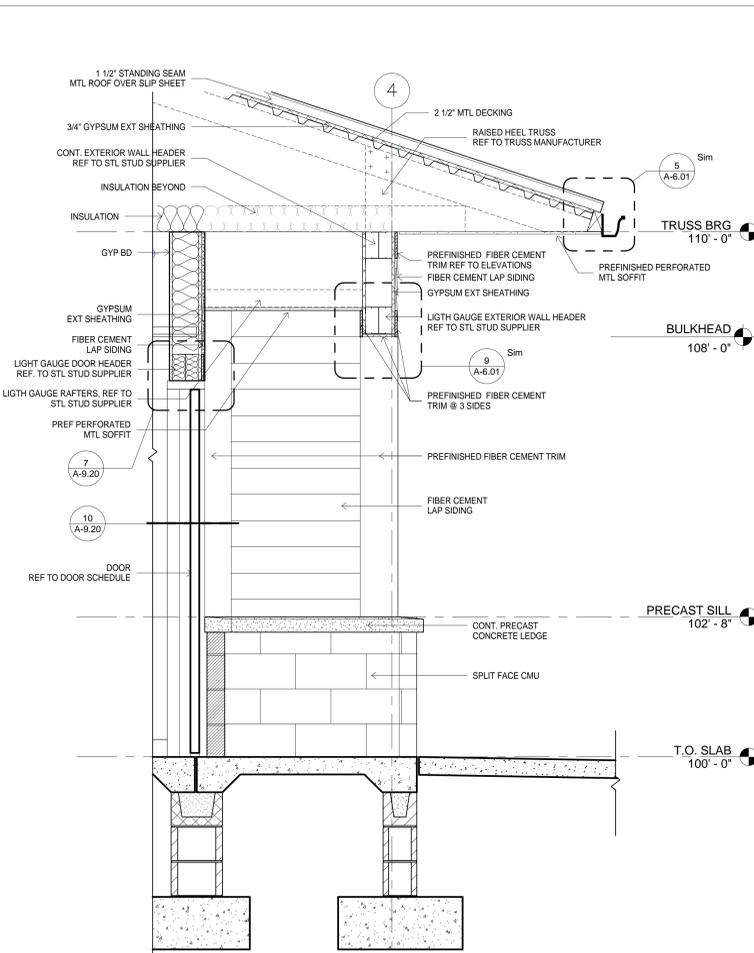

3 WALL SECTION AT STAFF ENTRY
3/4" = 1'-0"

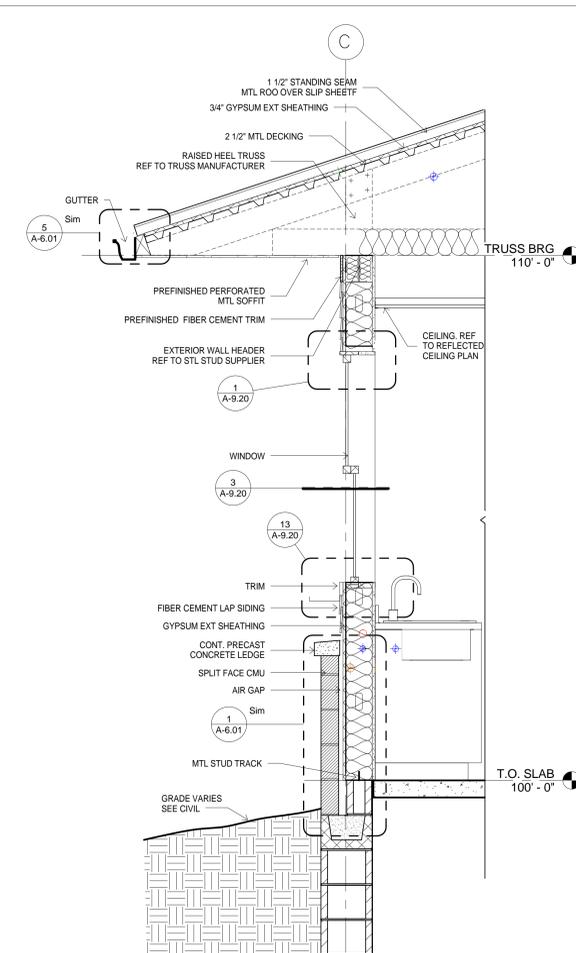

4 WALL SECTION BREAK ROOM SOUTH WALL
3/4" = 1'-0"

CONSULTANTS:



AMERICAN ENGINEERS, INC.
65 ABERDEEN DR.
GLASGOW, KY 42341
(270) 651-7220 TEL. (270) 651-3246 FAX
WWW.AEI.CC



ADVANCED STRUCTURAL TECHNOLOGIES
7212 METRO BLVD
EDINA, MN 55439
(952) 854-9302 TEL. (952) 854-9690 FAX
WWW.ASTMN.COM



ENGINEERING CONSULTANTS
Experience you can build on
STRUCTURAL, MECHANICAL, ELECTRICAL,
TECHNOLOGY, MEDICAL EQUIPMENT SOLUTIONS
(309) 788-0673 TEL. (309) 786-5967 FAX
QUAD CITIES, IL. WWW.KJWW.COM

I HEREBY CERTIFY THAT THIS PLAN,
SPECIFICATION OR REPORT WAS
PREPARED BY ME OR UNDER MY
DIRECT SUPERVISION, AND THAT I AM
A DULY LICENSED ARCHITECT UNDER
THE LAWS OF THE STATE OF
MINNESOTA.

PRINTED NAME: PAUL D. DAHLBERG
SIGNATURE: *[Signature]*
DATE: 05-20-2015
LICENSE #: 15872

ARCHITECT/ENGINEERS:



ENGINEERING • ARCHITECTURE • LAND SURVEYING
ENVIRONMENTAL SERVICES • LANDSCAPE ARCHITECTURE


Anderson Engineering of Minnesota, LLC
13605 1st Avenue North
Suite 100
Plymouth, MN 55441
763-412-4000 (t) 763-412-4090 (f)
www.ae-mn.com

Drawing Title
WALL SECTIONS


Approved: Project Director

100% CONSTRUCTION DOCUMENTS


Project Title WASH BAY / STORAGE BUILDING		Project Number 833-CM3-026		National Cemetery Administration
Location CAMP NELSON NATIONAL CEMETERY NICHOLASVILLE, KENTUCKY		Building Number 3003		
Date May 20, 2015	Checked PD	Drawn SC	Drawing Number A-5.01	Department of Veterans Affairs
			Dwg. 25 of 53	

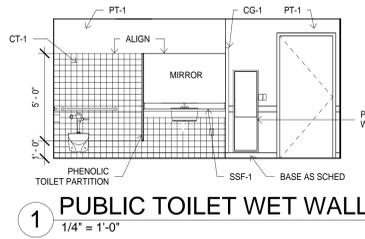


1 PUBLIC TOILET WET WALL
1/4" = 1'-0"

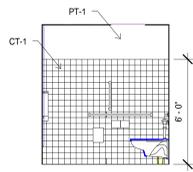


2 PUBLIC TOILET BACK WALL
1/4" = 1'-0"

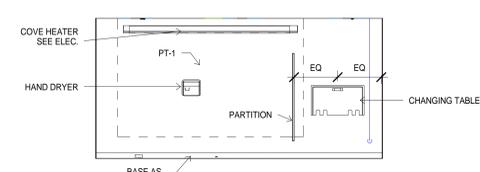


3 PUBLIC CHANGING TABLE
1/4" = 1'-0"

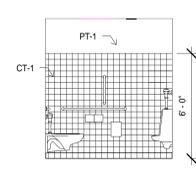


4 PUBLIC M SIDE WALL
1/4" = 1'-0"

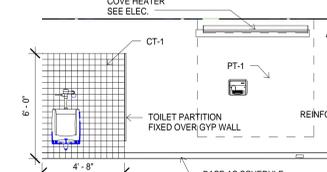


5 PUBLIC MALE URINAL
1/4" = 1'-0"

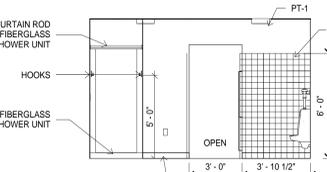


6 STAFF M SHOWER
1/4" = 1'-0"

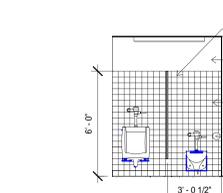


7 STAFF M WET WALL
1/4" = 1'-0"

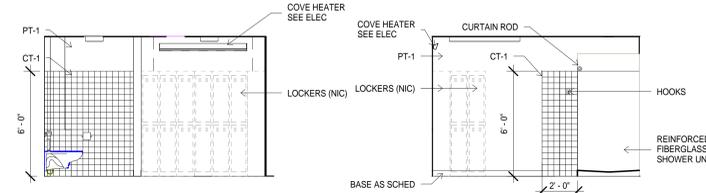


8 STAFF M LOCKER
1/4" = 1'-0"

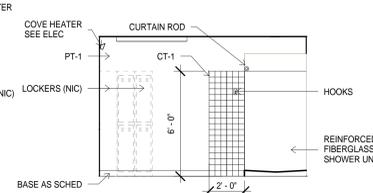


9 STAFF M SIDE WALL
1/4" = 1'-0"

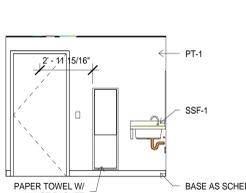


10 STAFF M ENTRY
1/4" = 1'-0"

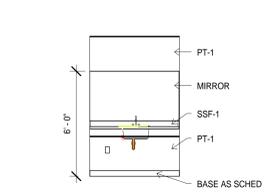


11 STAFF SINK WALL
1/4" = 1'-0"

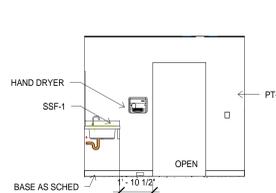


12 STAFF ENTRY
1/4" = 1'-0"

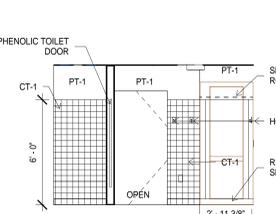


13 STAFF F SHOWER
1/4" = 1'-0"

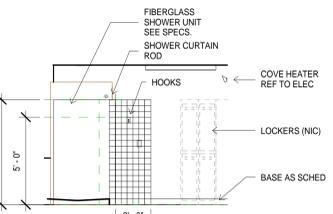


14 STAFF F SIDE WALL
1/4" = 1'-0"

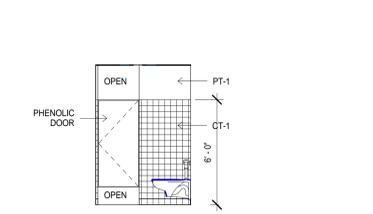


15 STAFF F STALL-1
1/4" = 1'-0"

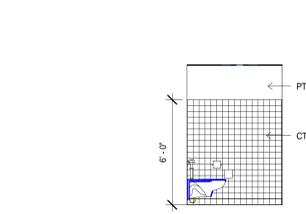


16 STAFF F STALL-2
1/4" = 1'-0"

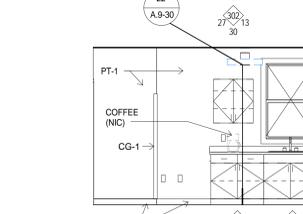


17 STAFF F STALL-3
1/4" = 1'-0"

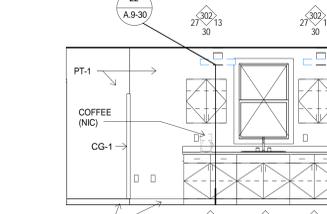


18 STAFF KITCHEN
1/4" = 1'-0"

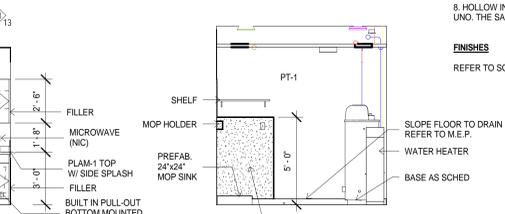

19 UTILITIES
1/4" = 1'-0"

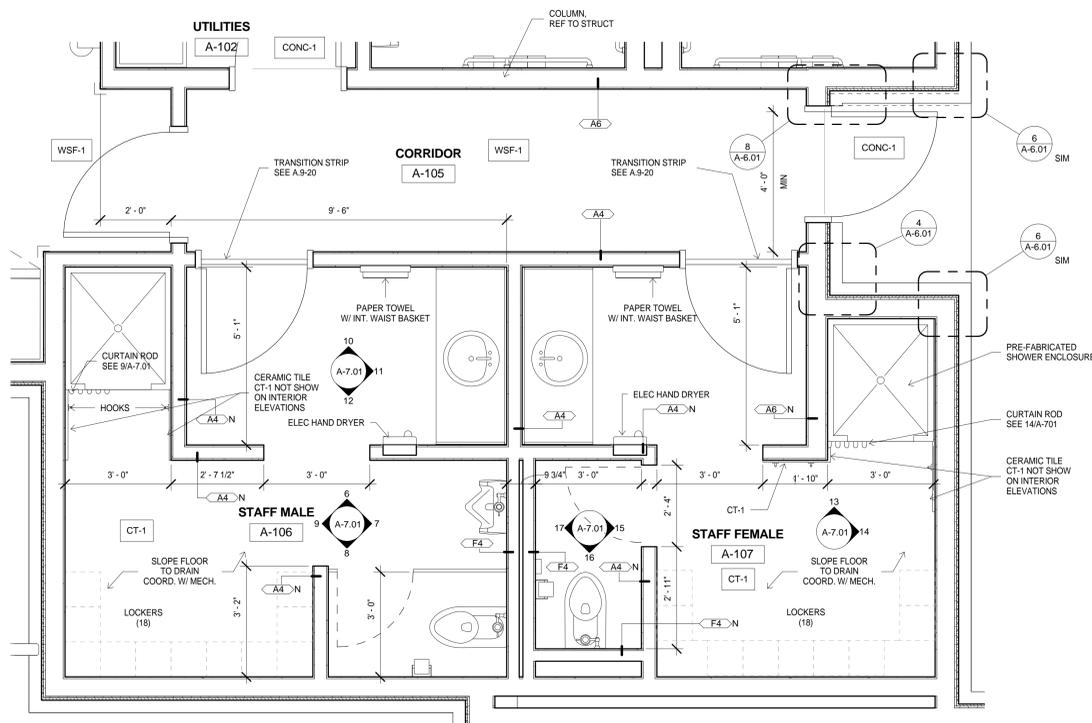

20 ENLARGED PLAN STAFF LOCKER ROOMS
1/2" = 1'-0"

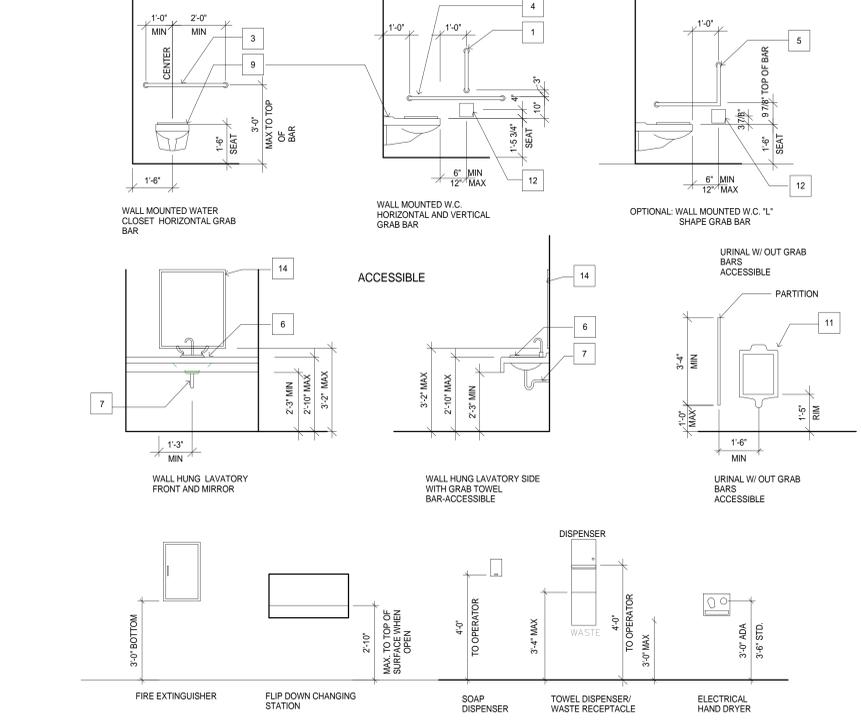

21 ADA PLUMBING MOUNTING HEIGHTS
3/8" = 1'-0"

- FLOOR PLAN GENERAL NOTES**
- FOR GENERAL SYMBOLS, MATERIALS AND ABBREVIATIONS, SEE A-0.01 & A-0.02.
 - FOR FLOOR FINISHES REFER TO FLOOR PLAN AT A-1.01 AND SCHEDULE OF FINISHES.
 - FOR CEILING INFORMATION REFER TO A-2.01
 - ALL WALLS TO BE A4, UNO.

- FINISH NOTES**
- REFER TO FLOOR PLAN AND INTERIOR ELEVATIONS FOR ADDITIONAL FINISH INFORMATION.
 - CEILING HEIGHTS ARE MEASURED FROM FINISH FLOOR. CEILING HEIGHTS AND CEILING MATERIALS/FINISHES CALLED OUT ON THE REFLECTED CEILING PLAN ARE FOR ENTIRE CEILING OR MAJORITY OF THAT ROOM, UNLESS OTHERWISE INDICATED. SEE REFLECTED CEILING PLAN FOR CHANGES IN CEILING MATERIAL AND CEILING HEIGHT.
 - LOCATE CHANGES IN FLOOR FINISH MATERIAL UNDER CENTERLINE OF CLOSED DOOR UNLESS OTHERWISE INDICATED.
 - PROVIDE SEALANT AT JOINT BETWEEN COUNTER TOP, BACK OR SIDE SPLASH AND WALLS.
 - ALL CEILING MATERIAL MUST HAVE CLASS 'A' FIRE RATING.
 - PAINT ALL NON SST FIRE EXTINGUISHER CABINETS, VENTS, GRILLES, PLUG STRIP, ELECTRICAL PANEL BOARDS, DIFFUSERS, AND EXPOSED DUCTS TO MATCH ADJACENT SURFACE FINISH.

- TYPICAL INTERIOR FINISHES**
- ALL WALLS TO BE PAINTED PT-1, UNO.
 - ALL VANITY TOPS IN PUBLIC AND STAFF BATHROOMS TO BE SSF-1, UNO.
 - KITCHEN TOP TO BE PLAM-1.
 - ALL WALL APPLIED CERAMIC TILE CT-1, UNO.
 - ALL FLOOR TILE TO BE PORCELAIN TILE-1 (PCT-1).
 - PROVIDE AND MATCH PORCELAIN TILE BASE IN ROOMS WITH FLOOR TILE, UNO.
 - HOLLOW EXTERIOR METAL DOORS AND FRAMES TO BE PAINTED PTD, UNO. THE SAME COLOR AND TYPE OF PAINT ON BOTH SIDES, UNO.
 - HOLLOW INTERIOR METAL DOORS AND FRAMES TO BE PAINTED PTD, UNO. THE SAME COLOR AND TYPE OF PAINT ON BOTH SIDES, UNO.

FINISHES
REFER TO SCHEDULE OF FINISHES.

- KEY NOTES**
- 18" GRAB BAR
 - 24" GRAB BAR
 - 36" GRAB BAR
 - 42" GRAB BAR
 - 18" X 30" "L" GRAB BAR
 - DROP IN LAVATORY
 - PLASTIC COATED FOAM PIPE WRAP
 - VALANCE BELOW VANITY TOP (NOT USED)
 - WALL HUNG W.C.
 - FLOOR SET W.C. (NOT USED)
 - URINAL
 - TOILET PAPER HOLDER
 - PAPER HOLDER
 - MIRROR WITH FRAME

Revisions:	Date:

CONSULTANTS:

AEI AMERICAN ENGINEERS, INC.
712 METRO BLVD
EDINA, MN 55439
(763) 651-7220 TEL. (763) 651-3246 FAX
WWW.AEI.CC

AST ADVANCED STRUCTURAL TECHNOLOGIES
712 METRO BLVD
EDINA, MN 55439
(952) 854-9602 TEL. (952) 854-9690 FAX
WWW.ASTMN.COM

KJW ENGINEERING CONSULTANTS
STRUCTURAL, MECHANICAL, ELECTRICAL, TECHNOLOGY, MEDICAL EQUIPMENT SOLUTIONS
(309) 788-0673 TEL. (309) 788-5973 FAX
QUAD CITIES, IL. WWW.KJWC.COM

I HEREBY CERTIFY THAT THIS PLAN, SPECIFICATION OR REPORT WAS PREPARED BY ME OR UNDER MY DIRECT SUPERVISION, AND THAT I AM A DULY LICENSED ARCHITECT UNDER THE LAWS OF THE STATE OF MINNESOTA.

PRINTED NAME: PAUL D. DAHLBERG
SIGNATURE: *[Signature]*
DATE: 05-20-2015
LICENSE #: 15872

ARCHITECT/ENGINEERS:

ANDERSON ENGINEERING
ENGINEERING • ARCHITECTURE • LAND SURVEYING
ENVIRONMENTAL SERVICES • LANDSCAPE ARCHITECTURE

Anderson Engineering of Minnesota, LLC
13605 1st Avenue North
Suite 100
Plymouth, MN 55441
763-412-4000 (o) 763-412-4090 (f)
www.ae-min.com

Drawing Title
INTERIOR ELEVATIONS

Approved: Project Director

Project Title
WASH BAY / STORAGE BUILDING

Project Number
833-CM3-026

Building Number
3003

Location
**CAMP NELSON NATIONAL CEMETERY
NICHOLASVILLE, KENTUCKY**

Drawing Number
A-7.01

Date
May 20, 2015


Checked
PD

Drawn
SC

Dwg 28 of 53

National Cemetery Administration
Department of Veterans Affairs

INTERIOR PARTITION TYPES (NON-COMBUSTIBLE)

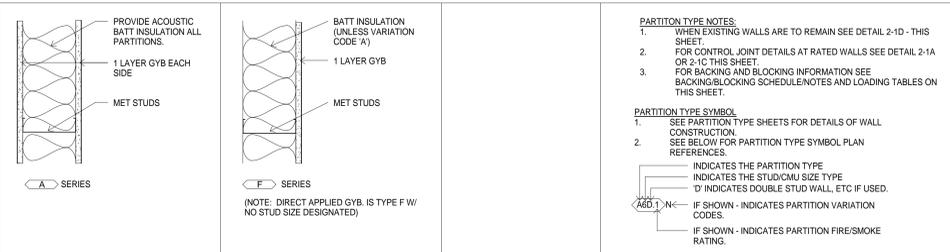

PARTITION TYPE NOTES:
 1. WHEN EXISTING WALLS ARE TO REMAIN SEE DETAIL 2-1D - THIS SHEET.
 2. FOR CONTROL JOINT DETAILS AT RATED WALLS SEE DETAIL 2-1A OR 2-1C THIS SHEET.
 3. FOR BACKING AND BLOCKING INFORMATION SEE BACKING/BLOCKING SCHEDULE NOTES AND LOADING TABLES ON THIS SHEET.

PARTITION TYPE SYMBOL:
 1. SEE PARTITION TYPE SHEETS FOR DETAILS OF WALL CONSTRUCTION.
 2. SEE BELOW FOR PARTITION TYPE SYMBOL PLAN REFERENCES.
 A INDICATES THE PARTITION TYPE.
 B INDICATES THE STUD/CMU SIZE TYPE.
 C INDICATES DOUBLE STUD WALL, ETC IF USED.
 D IF SHOWN - INDICATES PARTITION VARIATION CODES.
 E IF SHOWN - INDICATES PARTITION FIRE/SMOKE RATING.

PARTITION TYPE SCHEDULE

TYPE	WIDTH	STUD	FIRE ASSEMBLY TEST	STC RATING	DESCRIPTION
A-SERIES					
A4	5 1/4"	4"	N/A	45	
A6	7 1/4"	6"	N/A	45	
F-SERIES					
F4	4 1/4"	4"	N/A	N/A	
F6	6 5/8"	6"	N/A	N/A	

GYPSBOARD PARTITIONS GENERAL NOTES

- GRID LINES ARE SET TO EDGE OF METAL STUDS. GRID B IS SET TO CENTER OF METAL STUDS.
- ALL PARTITIONS INDICATED ON THE PLANS SHALL COMPLY WITH THE FOLLOWING CRITERIA. SEE PLANS FOR SPECIFIC PARTITION TYPE, RATINGS AND VARIATION CODE REQUIREMENTS.
- ALL PARTITIONS SHALL BE TYPE F4, TYP. UNO. SEE PLANS.
- ALL PARTITIONS SHALL BE ACOUSTIC INSULATED. FULL HEIGHT TO UNDERSIDE OF ROOF DECK OR BOTTOM CORD OF TRUSSES, GYB TO BE 5/8" GYB-11, UNO. SEE PARTITION DEFLECTION DETAIL AT ACOUSTIC WALL DETAIL, FULL HEIGHT WALL TOP DETAIL (NO VARIATION CODE).
- ALL INTERIOR STEEL STUDS SHALL BE NOT LESS THAN 20 GAUGE AND NOT MORE THAN 16" ON CENTER UNLESS INDICATED OTHERWISE IN PARTITION TYPE. SEE ALSO MAXIMUM WALL HEIGHT SCHEDULES BELOW AND TYPICAL DOOR AND WINDOW/BORROWED LIGHT FRAMING ELEVATIONS. REFER TO STUD WALL SUPPLIER FOR FINAL INFORMATION.
- DIMENSIONING OF PARTITIONS ON THE FLOOR PLANS ARE TO THE FACE OF PARTITION TYPE. THICKNESS OF FINISHES ARE NOT FIGURED INTO FLOOR PLAN DIMENSIONS UNLESS FINISH IS SHOWN IN PARTITION TYPE.

STUD FRAMING MAXIMUM HEIGHTS:
 3 5/8" 20 GA STUD, MAX HEIGHT 14'-0"
 4" 20 GA STUD, MAX HEIGHT 15'-5"

ACOUSTIC PARTITIONS

- ALL GYB PARTITION TYPES WITH SOUND ATTENUATION BATTS SHALL HAVE THE BATTS INSTALLED FOR THE FULL THICKNESS AND HEIGHT OF PARTITION, ABOVE AND BELOW ALL OPENINGS.
- SEAL ALL PENETRATIONS AND HORIZONTAL / VERTICAL PERIMETER OF PARTITION WITH ACOUSTICAL SEALANT AS APPROPRIATE.

CONTROL JOINTS

- PROVIDE CONTROL JOINTS IN PARTITIONS WHERE INDICATED ON PLANS AND/OR INTERIOR ELEVATIONS. AT END INTERSECTION WITH CONC/CMU WALLS, INTERSECTION WITH EXISTING PARTITIONS, ABOVE THE STRIKE SIDE OF EACH DOOR FRAME AND NOT MORE THAN 30'-0" O.C. SEE ALSO TYPICAL GYPSBOARD PARTITION CONTROL JOINT DETAILS.
- PROVIDE CONTROL JOINTS IN UNINTERRUPTED LONG EXPANSES OF GYB AT 30'-0" O.C. MAX. WITH EACH SIDE OF PARTITION CONSIDERED SEPARATELY.

GYPSBOARD BASE


- PROVIDE 1/4" SLANT JOINT AND BASE OF ALL GYPSBOARD PARTITIONS.

GYPSBOARD TERMINATION


- ALL GYB TERMINATING IN AREAS EXPOSED TO VIEW SHALL HAVE NON-EXPOSED METAL TRIM AND BE FINISHED WITH JOINT TREATMENT.

GYPSBOARD ENDS AND CORNERS


- ALL OUTSIDE CORNERS OF GYB PARTITIONS SHALL HAVE GALV METAL CORNER BEADS AND BE FINISHED WITH JOINT TREATMENT.

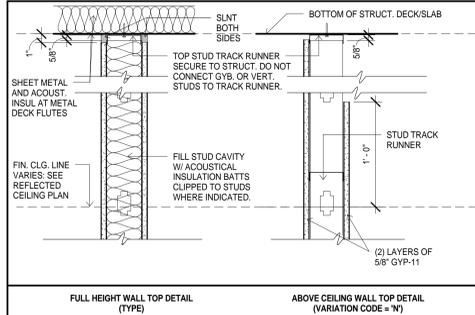


PARTITION DEFLECTION DETAIL AT ACOUSTIC WALLS
 1 1/2" = 1'-0"

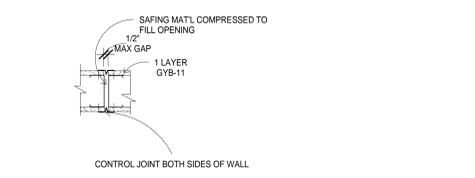


GYPSBOARD CONTROL JOINTS
 1 1/2" = 1'-0"

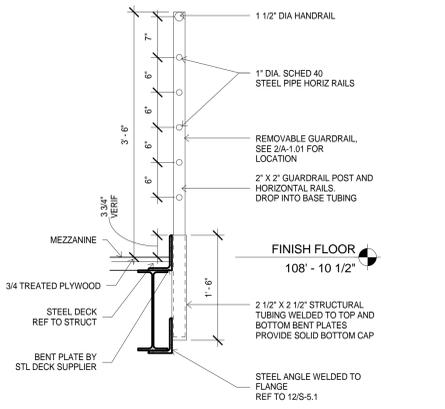


REMOVABLE GUARDRAIL SECTION
 1" = 1'-0"

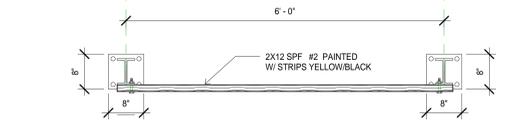

PROTECTION BARRIER
 3/4" = 1'-0"

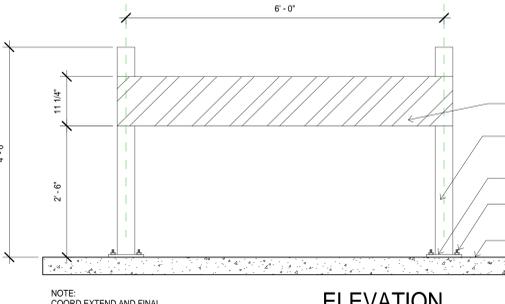

PROTECTION BARRIER
 3/4" = 1'-0"

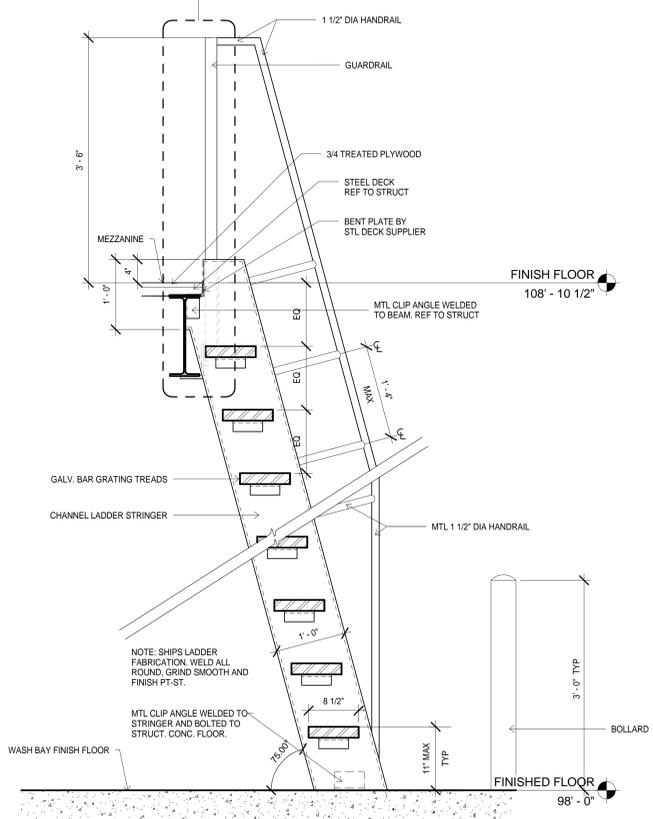

SHIP LADDER SECTION
 1" = 1'-0"

BACKING/BLOCKING SCHEDULE NOTES

- PROVIDE BACKING/BLOCKING IN GYB PARTITIONS FOR ALL WALL-HUNG ITEMS.
- THESE ANCHORING DETAILS ARE SHOWN AS TYPICAL AND ARE NOT INTENDED TO BE ALL INCLUSIVE. PROVIDE WOOD OR STEEL BACKING IN PARTITIONS FOR WALL HUNG ITEMS, SUCH AS WALL CABINETS, BLDG ACCESS, BATHROOM ACCESS, SHELVING, DOOR HOLD-OPENS, & STOPS, ETC. INCLUDING NIC, BY OWNER. BY OWNER FUTURE, & RELOCATE EXISTING ITEMS.
- USE THE FOLLOWING ASSUMED LOADS TO DETERMINE BLKG & FASTENER REQUIREMENTS UNLESS GREATER LOADS ARE KNOWN.
 A. S DISP. PTC, TPH, MIRRORS, COAT HOOKS, BPG, TOWEL BAR & RING, MOP HOLDER, ASH URN, ETC USE 100lb MOP HOLDER, ASH URN ETC - USE 100 LB.
 B. HANDRAIL, BUMPER RAILS - USE 200 LB CONCENTRATED LOAD.
 C. GRAB BARS - USE 250 LB CONCENTRATED LOAD.
 D. WALL CABINETS - USE WEIGHT OF CABINET PLUS 100LB PER FOOT OF SHELF.
 E. COUNTERTOPS - USE WEIGHT OF COUNTER PLUS 55 LB PER FOOT OF COUNTER.
 F. 12" ADJ SHELVES - USE 40 LB PER BRKT.
 G. 18" ADJ SHELVES - USE 55 LB PER BRKT.
 H. 24" ADJ SHELVES - USE 83 LB PER BRKT.

LOADING TABLE NOTES:

- SEE TABLE 1 BELOW FOR SIZE OF WOOD BLKG, QUANTITY AND SIZE OF SCREWS FOR CONNECTION TO EACH STUD.
- SEE TABLE 2 OR 3 BELOW FOR QUANTITY AND SIZE OF SCREWS FOR CONNECTION OF WALL HUNG ITEMS. IF NOT ALREADY PROVIDED BY MFR OF WALL HUNG ITEM.

TABLE 1
 MAXIMUM ALLOWABLE LOAD-IN POUNDS

WOOD SCREW	LENGTH OF WALL HUNG ITEM	QUAN.	SIZE	1'-4" OR LESS	2'-8" OR LESS	2'-9" OR MORE
2x4 WOOD BLOCKING						
2	#6	160	320	480		
2	#8	240	480	700		
2	#10	320	640	700		
2x6 WOOD BLOCKING						
3	#6	240	480	700		
3	#8	360	700	700		
3	#10	480	700	700		

LOADS BASED ON GROUP II WOOD SPECIES & SCREWS EMBEDDED IN WOOD A MIN OF 7 TIMES THE SCREW DIA WITH SCREWS INSERTED IN SIDE GRAIN ON ONE SIDE & SIDE GRAIN ON OPPOSITE END.

TABLE 2
 MAXIMUM ALLOWABLE LOAD-IN POUNDS


SCREW SIZE	QUANTITY OF SCREWS				
	2	3	4	5	
#6	150	225	300	375	
#8	212	318	424	530	
#10	286	429	572	700	
#12	370	555	700	700	

LOADS BASED ON GROUP II WOOD SPECIES & SCREWS EMBEDDED IN WOOD A MIN OF 7 TIMES THE SCREW DIA WITH SCREWS INSERTED IN SIDE GRAIN.

TABLE 3
 MAXIMUM ALLOWABLE LOAD-IN POUNDS

SCREW SIZE	QUANTITY OF SCREWS				
	2	3	4	5	
#6-S12	224	336	448	560	
#8-18	236	354	472	590	
#10-16	272	438	584	700	
#12-14	288	438	576	700	

LOADS BASED ON PUBLISHED DATA FOR MILCOR TITELOCK SCREWS WITH 20 GA GALV STEEL BACKING AND LIMITING CRITERIA BEING PULL-OUT STRENGTH.

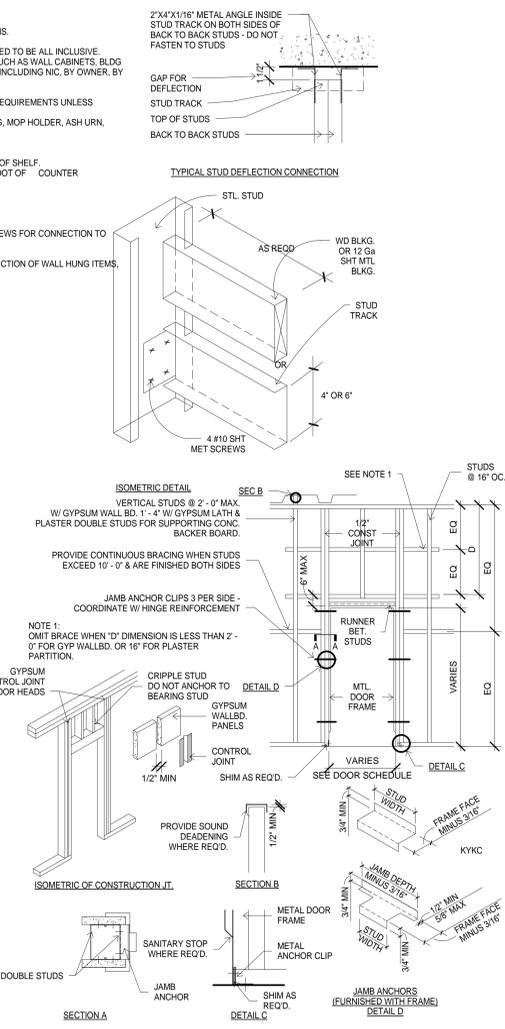

SHEET GENERAL NOTES
 1. FOR GENERAL ABBREVIATIONS, SYMBOLS AND MATERIALS, ETC SEE A-02. FOR GENERAL NOTES SEE A-01.

100% CONSTRUCTION DOCUMENTS

<p>CONSULTANTS:</p> <p>AEI AMERICAN ENGINEERS, INC. 65 ABERDEEN DR. GLASGOW, KY 42341 (270) 651-7220 TEL. (270) 651-3246 FAX WWW.AEI.CC</p> <p>AST ADVANCED STRUCTURAL TECHNOLOGIES 7212 METRO BLVD EDINA, MN 55439 (952) 854-9022 TEL. (952) 854-9690 FAX WWW.ASTMN.COM</p> <p>KJWW ENGINEERING CONSULTANTS Experience you can build on. STRUCTURAL, MECHANICAL, ELECTRICAL, TECHNOLOGY, MEDICAL EQUIPMENT SOLUTIONS (309) 788-0673 TEL. (309) 786-5967 FAX QUAD CITIES, IL. WWW.KJWW.COM</p>	<p>ARCHITECT/ENGINEERS:</p> <p>ANDERSON ENGINEERING Anderson Engineering of Minnesota, LLC 13605 1st Avenue North Suite 100 Plymouth, MN 55441 763-412-4000 (o) 763-412-4090 (f) www.ae-mn.com</p>	<p>Drawing Title INTERIOR DETAILS AND PARTITION TYPES</p>	<p>Project Title WASH BAY / STORAGE BUILDING</p>	<p>Project Number 833-CM3-026</p>	<p>National Cemetery Administration Department of Veterans Affairs</p>
		<p>Approved: Project Director</p>	<p>Location CAMP NELSON NATIONAL CEMETERY NICHOLASVILLE, KENTUCKY</p>	<p>Drawing Number A-9.01</p>	
<p>Revisions:</p>	<p>DATE: 05-20-2015 SIGNATURE: [Signature] LICENSE #: 15870</p>	<p>Date May 20, 2015</p>	<p>Checked PD</p>	<p>Drawn SC</p>	<p>Dwg 29 of 53</p>

