

EXPAND / CONSTRUCT OUTPATIENT MENTAL HEALTH CLINIC


Veteran's Affairs Medical Center St. Cloud, Minnesota

General Notes & Conditions

- ALL DIMENSIONS ON DRAWINGS ARE APPROXIMATE; DRAWINGS ARE NOT TO BE SCALED. IT IS THE RESPONSIBILITY OF THE CONTRACTOR TO VERIFY ALL FIELD CONDITIONS AND PHYSICAL DIMENSIONS THAT INFLUENCE THE CONSTRUCTION AREA.
- IT IS RECOMMENDED THAT CONTRACTORS VISIT THE PROPOSED CONSTRUCTION SITE PRIOR TO SUBMITTING THEIR BIDS AND THEY ARE ENCOURAGED TO DO SO.
- CONTRACTOR SHALL ADHERE STRICTLY TO STATE AND FEDERAL OCCUPATIONAL SAFETY AND HEALTH ADMINISTRATION (OSHA) STANDARDS.
- CONTRACTOR SHALL PARK ONLY IN THE DESIGNATED PARKING AREAS AND ARE NOT TO PARK ON THE LAWN AREAS; THE ONLY EXCEPTION IS TO LOAD OR UNLOAD SUPPLIES OR EQUIPMENT.
- CONTRACTOR IS RESPONSIBLE FOR THE SAFEGUARDING OF THEIR TOOLS AND EQUIPMENT. ALL TOOLS AND EQUIPMENT ARE NOT TO BE LEFT UNATTENDED AND ARE TO BE SECURED AT ALL TIMES WHEN THE CONTRACTOR IS NOT PRESENT, OR THE CONSTRUCTION SITE IS NOT SUPERVISED BY THE CONTRACTOR.
- ALL VA PROPERTY IS TO BE SAFEGUARDED FROM DAMAGE. ANY DAMAGED VA PROPERTY IS TO BE RESTORED TO ORIGINAL CONDITION PRIOR TO DAMAGE OR REPLACED COMPLETELY. THIS INCLUDES INSTALLATION, LABOR, AND PROCUREMENT EXPENSES.
- ALL DEMOLISHED MATERIAL BECOMES THE PROPERTY AND THE RESPONSIBILITY OF THE CONTRACTOR WITH THE EXCEPTION OF SPECIFIED ITEMS DESIGNATED EITHER IN THE PLANS OR VERBALLY REQUESTED BY THE CONTRACTING OFFICERS REPRESENTATIVE (C.O.R.) TO BE RETAINED BY THE VA. OFFSITE DISPOSAL OF THE DEMOLISHED ITEMS IS THE RESPONSIBILITY OF THE CONTRACTOR.
- CONTRACTOR MUST CONTROL DEMOLITION AND CONSTRUCTION DUST FROM FACILITY BY ERECTING A DUST BARRIER AND VENTILATION WITH HEPA FILTERS. IF VENTING TO OUTSIDE, THE CONTRACTOR WILL INSURE NEGATIVE AIR PRESSURE IS MAINTAINED IN ENCAPSULATED WORK AREA. WHEN TRANSPORTING DEBRIS, WET DOWN SUFFICIENTLY TO PREVENT DUST SPREADING.
- IF SCAFFOLDING IS USED, IT MUST BE USED IN ACCORDANCE WITH (OSHA) REGULATIONS AND IS TO BE ENCLOSED FOR THE FIRST EIGHT FEET ABOVE GROUND UNTIL DISMANTLED. LADDERS MUST BE REMOVED AND LOCKED UP AT THE END OF EACH WORKING DAY TO PREVENT UNAUTHORIZED PERSONS FROM HAVING ACCESS.
- CLEAN ALL DEBRIS FROM CONSTRUCTION SITE DAILY TO THE SATISFACTION OF THE CONTRACTING OFFICERS REPRESENTATIVE.
- CONTRACTOR IS RESPONSIBLE FOR ERECTING A BARRIER AROUND WORK SITE TO PREVENT PATIENTS, STAFF AND VISITORS FROM ENTERING CONSTRUCTION SITE. THIS FENCE SHALL BE A CHAIN LINK FENCE. COORDINATE CONSTRUCTION MATERIALS AND LOCATION OF FENCE WITH COR. - SEE PHASING PLANS SHEET G1103.
- CONTRACTOR IS RESPONSIBLE FOR REPAIRING AND REPLACING ANY DAMAGED LAWN. THE RESTORATION WILL BE PERFORMED BY A LANDSCAPE CONTRACTOR THAT REGULARLY DOES SODDING AS PART OF THEIR BUSINESS. ALL DAMAGED LAWN WILL BE OVERTURN BY 6" OR MORE TO ACCOMMODATE FULL WIDTH ROLLS OF SOD. TOP SOIL TO BE TILLED AND GRADED TO A SMOOTH MATCHING GRADE OF UNLAWNED LAWN. SOD TO BE THOROUGHLY SATURATED WITH WATER UPON PLACEMENT. THE CONTRACTOR IS RESPONSIBLE FOR WATERING NEW SOD UNTIL PROJECT ACCEPTANCE BY THE C.O.R.
- ACCESS TO ALL BUILDINGS AND PARKING AREAS MUST BE MAINTAINED THROUGHOUT THE PROJECT.
- CONTRACTORS ARE TO COORDINATE ALL WORK WITH THE C.O.R.
- ALL ITEMS INDICATED IN THE CONSTRUCTION DOCUMENTS SHALL BE SUPPLIED AND INSTALLED BY THE CONTRACTOR (CC), UNLESS NOTED OTHERWISE, OR THUS: (CV) SUPPLIED BY CONTRACTOR AND INSTALLED BY VA, (VC) SUPPLIED BY VA AND INSTALLED BY CONTRACTOR, OR (VV) SUPPLIED BY VA AND INSTALLED BY VA.

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VA MEDICAL CENTER, ST. CLOUD, MINNESOTA--CAMPUS MAP

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EARTH	GRAVEL FILL	CONCRETE	CMU
BRICK	PLASTER, SAND, GROUT	IRON/STEEL	METAL STUDS-PLAN
GYPSUM WALLBOARD	WOOD-FINISH	WOOD-DIMENSION	PLYWOOD
INSULATION-BATT	INSULATION-RIGID	PARTICLE BOARD	

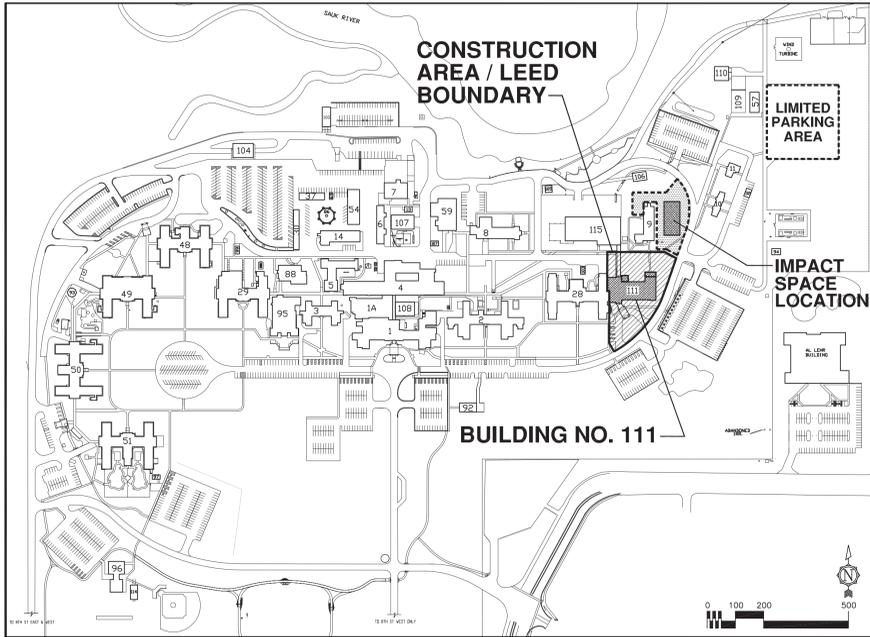
ABBREVIATIONS

∅	Angle	C	Channel	D or DP	Deep	F/A	Fire Alarm	H	High	M	Men/Meter	PART	Partition/Particle	R.L.	Rain Leader	T	Tile	V	Volt/Vent
∠	Angle	CAB	Cabinet	DBL	Double	F.A.	Fresh Air	H.B.	Hose Bid	MAS	Masonry	P.B.	Particle Board	R.M.	Room	TB	Tackboard	(V)	Verify
∅	Diameter	CASG	Casing	D.C.S.	Double Compartment	F.B.	Face Brick	H.C.	Hose Cabinet	MAT	Material	P	Plate	R.O.	Roof Opening	T.C.	Towel Cabinet	VAC	Vacuum
#	Number/Pound	C.B.	Chalk Board/Catch Basin	DET	Detail	F.C.O.	Floor Clean-out	H.D.	Heavy Duty	MAX	Maximum	P.LAM.	Plastic Laminate	R & S	Rod & Shelf	TELE	Telephone	V.B.	Vapor Barrier or Vacuum Breaker
A.B.	Anchor Bolt	C.C.	Center to Center	D.F.	Drinking Fountain	F.D.	Floor Drain	HDBD	Hardboard	M.B.	Machine Bolt/Map Basin	PLAS	Plaster	R.T.	Rubber Tile	TEMP	Tempored/Temporary/Temperature	V.V.	Vinyl Base or Vacuum Breaker
AC	Acoustic	C.C.J.	Construction Control Joint	DIA/∅	Diameter	F.D.V.	Fire Department Valve	HDWE	Hardware	M.D.O.	Medium Density Overlay	PLWD	Plywood	R.U.B.	Rubber	TER	Terrazzo	VC	Owner Furnished Contractor Installed
A.C.	Air Conditioning	C.E.M.	Cement	DISC	Disconnect	F.E.	Fire Extinguisher	H.M./HM	Hollow Metal	M.E.	Match Existing	PNT	Panel	P.P.G.	Polished Plate Glass	T & G	Tongue & Groove	V.C.P.	Vitrified Clay Pipe
A.D.	Access Door	CER	Ceramic	DIV.	Divisions Division	F.F.C.	Fire Extinguisher Cabinet	HORIZ	Horizontal	MECH	Mechanical	RD/∅	Round	FR	Pair	TH	Towel Hook	V.C.T.	Vinyl Composition Tile
ADD	Addition	C.F.M.	Cubic Feet per Minute	DK	Deck	F.G.	Finish Floor	H.P.	Horsepower	MED	Medicine	POL	Polished(ed)	PRE-FIN.	Pre-finished	T.O.B.	Top of Beam	VENT	Ventilate(s)(ing)
ADJ.	Adjustable	C.C.	Corner Guard	DN	Down	FG	Fiberglass	HR	Hour	MEMB	Membrane	POL	Polish(ed)	PRV	Pressure Relief Valve(Vent)	S.A.	Sink/Sewer/Supply Air	VER.	Verify
A.F.F.	Above Finish Floor	CGG	Curb & Gutter	DO	Door	F.H.	Flat Head	HT	Height	MET/MTL	Metal	P.P.	Pressure Treated	PT	Point	S.D.	Section	V.C.P.	Vitrified Clay Pipe
AGG	Aggregate	CH	Coat Hook	DO	Ditto/Duplicate	F.H.C.	Fire Hose Cabinet	HTR	Heating	MFR	Manufacturer	FR	Fire Resistant	P.T.	Paper Towel or Pressure Treated	S.E.	Shower	V.C.T.	Vinyl Composition Tile
A.H.U.	Air Handling Unit	C.H.	Cast Iron	DR	Door	FIN	Finish	HTR	Heater	M.H.	Man Hole	PRE-FIN.	Pre-finished	PRV	Pressure Relief Valve(Vent)	S.D.	Shower	V.C.T.	Vinyl Composition Tile
ALT.#	Alternate Number	C.I.	Cast Iron	D.S.	Downspout	F.O.	Finished Opening	H & V	Heating & Ventilating	MK	Mark	PRV	Pressure Relief Valve(Vent)	SCHED	See Detail	S.E.C.T.	Section	V.V.	Vinyl Wall Fabric
ALUM/AL	Aluminum	C.I.C.	Circle/Circumference	D.T.	Dishtowel	FLR	Floor	H.W.	Hot Water	MKBD	Markerboard	PT	Point	SCHED	See Detail	S.E.C.T.	Section	V.V.	Vinyl Wall Fabric
ANCH	Anchor	C.L.	Center Line	D.W.	Dowel	FLR	Floor			MISC	Miscellaneous	P.T.	Pressure Treated	SCHED	See Detail	S.E.C.T.	Section	V.V.	Vinyl Wall Fabric
ANOD	Anodized	CLG	Ceiling	DWL	Dowel	FR	Frame			MISC	Miscellaneous	P.T.	Pressure Treated	SCHED	See Detail	S.E.C.T.	Section	V.V.	Vinyl Wall Fabric
A.P.	Access Panel	CLR	Clear	EA	East	FR	Fire Resistant/Resistive			MISC	Miscellaneous	P.T.	Pressure Treated	SCHED	See Detail	S.E.C.T.	Section	V.V.	Vinyl Wall Fabric
APPROX	Approximate	CLT or CLO	Clear	EA	Each	FR	Fire Resistant/Resistive			MISC	Miscellaneous	P.T.	Pressure Treated	SCHED	See Detail	S.E.C.T.	Section	V.V.	Vinyl Wall Fabric
ARCH	Architectural	CMU	Concrete Masonry Unit	E.A.	Exhaust Air	FR	Frame			MISC	Miscellaneous	P.T.	Pressure Treated	SCHED	See Detail	S.E.C.T.	Section	V.V.	Vinyl Wall Fabric
ASPH	Asphalt	CMU	Concrete Masonry Unit	E.B.	Erection Bolt	FR	Frame			MISC	Miscellaneous	P.T.	Pressure Treated	SCHED	See Detail	S.E.C.T.	Section	V.V.	Vinyl Wall Fabric
A.T.C.	Automatic Temperature Control	CMU	Concrete Masonry Unit	E.C.	Electrical Contractor	FR	Frame			MISC	Miscellaneous	P.T.	Pressure Treated	SCHED	See Detail	S.E.C.T.	Section	V.V.	Vinyl Wall Fabric
		COMP	Composition	E.E.	Expansion Joint	FR	Frame			MISC	Miscellaneous	P.T.	Pressure Treated	SCHED	See Detail	S.E.C.T.	Section	V.V.	Vinyl Wall Fabric
		CONC	Concrete	E.L.	Elevation	FR	Frame			MISC	Miscellaneous	P.T.	Pressure Treated	SCHED	See Detail	S.E.C.T.	Section	V.V.	Vinyl Wall Fabric
		CONST	Construction	ELEV	Elevator	FR	Frame			MISC	Miscellaneous	P.T.	Pressure Treated	SCHED	See Detail	S.E.C.T.	Section	V.V.	Vinyl Wall Fabric
		CONT	Continuous	EMER	Emergency	FR	Frame			MISC	Miscellaneous	P.T.	Pressure Treated	SCHED	See Detail	S.E.C.T.	Section	V.V.	Vinyl Wall Fabric
		CONTR	Contractor	ENT	Entrance	FR	Frame			MISC	Miscellaneous	P.T.	Pressure Treated	SCHED	See Detail	S.E.C.T.	Section	V.V.	Vinyl Wall Fabric
		CONV	Converter	EXP	Expanded Polystyrene	FR	Frame			MISC	Miscellaneous	P.T.	Pressure Treated	SCHED	See Detail	S.E.C.T.	Section	V.V.	Vinyl Wall Fabric
		COR	Corner	E.P.S.	Expanded Polystyrene	FR	Frame			MISC	Miscellaneous	P.T.	Pressure Treated	SCHED	See Detail	S.E.C.T.	Section	V.V.	Vinyl Wall Fabric
		CORR	Corridor	EQUIP	Equipment	FR	Frame			MISC	Miscellaneous	P.T.	Pressure Treated	SCHED	See Detail	S.E.C.T.	Section	V.V.	Vinyl Wall Fabric
		C.P.	Cement Plaster/Chrome Plated	EQUIP	Equipment	FR	Frame			MISC	Miscellaneous	P.T.	Pressure Treated	SCHED	See Detail	S.E.C.T.	Section	V.V.	Vinyl Wall Fabric
		CPT	Carpet	EQUIP	Equipment	FR	Frame			MISC	Miscellaneous	P.T.	Pressure Treated	SCHED	See Detail	S.E.C.T.	Section	V.V.	Vinyl Wall Fabric
		CSG	Casing	EQUIP	Equipment	FR	Frame			MISC	Miscellaneous	P.T.	Pressure Treated	SCHED	See Detail	S.E.C.T.	Section	V.V.	Vinyl Wall Fabric
		C.T.	Ceramic Tile	EQUIP	Equipment	FR	Frame			MISC	Miscellaneous	P.T.	Pressure Treated	SCHED	See Detail	S.E.C.T.	Section	V.V.	Vinyl Wall Fabric
		C-TOP	Countertop	EQUIP	Equipment	FR	Frame			MISC	Miscellaneous	P.T.	Pressure Treated	SCHED	See Detail	S.E.C.T.	Section	V.V.	Vinyl Wall Fabric
		CTR	Counter/Center	EQUIP	Equipment	FR	Frame			MISC	Miscellaneous	P.T.	Pressure Treated	SCHED	See Detail	S.E.C.T.	Section	V.V.	Vinyl Wall Fabric
		CTS	Countersink	EQUIP	Equipment	FR	Frame			MISC	Miscellaneous	P.T.	Pressure Treated	SCHED	See Detail	S.E.C.T.	Section	V.V.	Vinyl Wall Fabric
		C.U.H.	Cabinet Unit Heater	EQUIP	Equipment	FR	Frame			MISC	Miscellaneous	P.T.	Pressure Treated	SCHED	See Detail	S.E.C.T.	Section	V.V.	Vinyl Wall Fabric
		CUST	Custodian	EQUIP	Equipment	FR	Frame			MISC	Miscellaneous	P.T.	Pressure Treated	SCHED	See Detail	S.E.C.T.	Section	V.V.	Vinyl Wall Fabric
		C.W.	Cold Water	EQUIP	Equipment	FR	Frame			MISC	Miscellaneous	P.T.	Pressure Treated	SCHED	See Detail	S.E.C.T.	Section	V.V.	Vinyl Wall Fabric
		C.Y.	Cubic Yard	EQUIP	Equipment	FR	Frame			MISC	Miscellaneous	P.T.	Pressure Treated	SCHED	See Detail	S.E.C.T.	Section	V.V.	Vinyl Wall Fabric


CONSTRUCTION DOCUMENTS SUBMISSION

<p>Q1 INDEX OF DRAWINGS REVISED</p> <table border="1"> <tr> <th>NO.</th> <th>REVISION</th> <th>DATE</th> </tr> <tr> <td> </td> <td> </td> <td> </td> </tr> </table>	NO.	REVISION	DATE				<p>12/24/14</p>	<p>STRUCTURAL RYDER ENGINEERING 810 First Avenue North Fargo, North Dakota 58102 Phone: 701-845-9338 Fax: 701-232-5338 info@ryder.com</p>	<p>MECHANICAL, FIRE PROTECTION & ELECTRICAL OSBERMILLER-NELSON ENGINEERING, INC. 201 1ST STREET NORTH, STE. 2 FARGO, NORTH DAKOTA 58103</p>	<p>CIVIL HANSEN THOMP FELLINEN OLSON, INC. 715 MARKET STREET ST. CLOUD, MINNESOTA 56304</p>	<p>INDUSTRIAL HYGIENIST LIBREND TECHNICAL SERVICES, INC. 118 W. WASHINGTON AVENUE FARGO, ND 58102</p>	<p>I HEREBY CERTIFY THAT THIS PLAN, SPECIFICATION OR REPORT WAS PREPARED BY ME OR UNDER MY DIRECT SUPERVISION AND THAT I AM A FULLY REGISTERED ARCHITECT UNDER THE LAWS OF THE STATE OF MINNESOTA.</p> <p><i>Robert Corp</i> ROCHELLE CONZUMUS DATE: 12/16/2014 REG. NO: 46294</p>	<p>APPROVED: SERVICE LINE DIRECTOR DATE: _____</p> <p>APPROVED: GEMC COORDINATOR DATE: _____</p> <p>APPROVED: PROJECT SECTION MANAGER DATE: _____</p> <p>APPROVED: DIRECTOR FMS DATE: _____</p>	<p>APPROVED: INFECTON CONTROL NURSE DATE: _____</p> <p>APPROVED: PATIENT SAFETY DATE: _____</p> <p>APPROVED: CHIEF OF POLICE DATE: _____</p> <p>APPROVED: SWEET MANAGER DATE: _____</p>	<p>DRAWING TITLE: COVER SHEET</p> <p>DATE: _____</p> <p>APPROVED: ASSOCIATE HEALTH CARE SYSTEM DIRECTOR DATE: _____</p> <p>APPROVED: CHIEF OF STAFF DATE: _____</p> <p>APPROVED: HEALTH CARE SYSTEM DIRECTOR DATE: _____</p>	<p>PROJECT TITLE: EXPAND / CONSTRUCT OUTPATIENT MENTAL HEALTH CLINIC</p> <p>BUILDING No: 111</p> <p>FDC: _____</p> <p>MFB: _____</p> <p>LOCATION: V.A. MEDICAL CENTER ST. CLOUD, MN 56302</p>	<p>SUBMISSION DATE: 12/16/14</p> <p>PROJECT NO: 656-341</p> <p>DWG. NO: 111-G101</p> <p>DWG. 1 OF 120</p>	<p>St. Cloud VA Health Care System Brainerd Monticello Alexandria</p>
NO.	REVISION	DATE																


three inches = one foot
 one and one half inches = one foot
 one inch = one foot
 three quarters inch = one foot
 one half inch = one foot
 three eighths inch = one foot
 one quarter inch = one foot
 one eighth inch = one foot

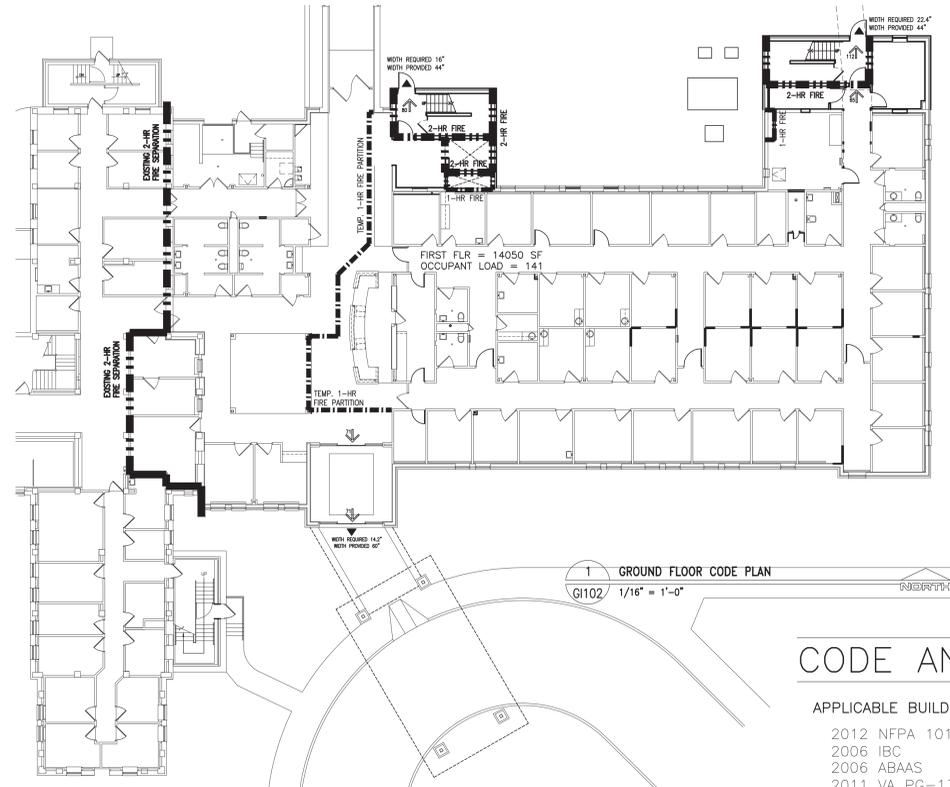

1 GROUND FLOOR CODE PLAN
 G102 1/16" = 1'-0"

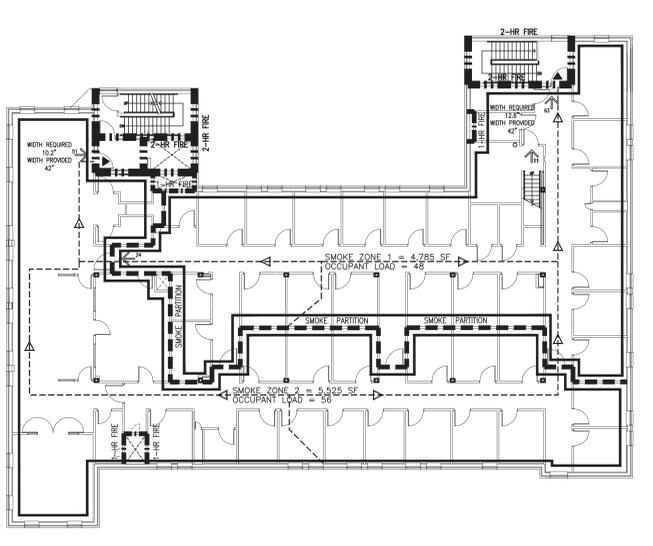

2 FIRST FLOOR CODE PLAN
 G102 1/16" = 1'-0"

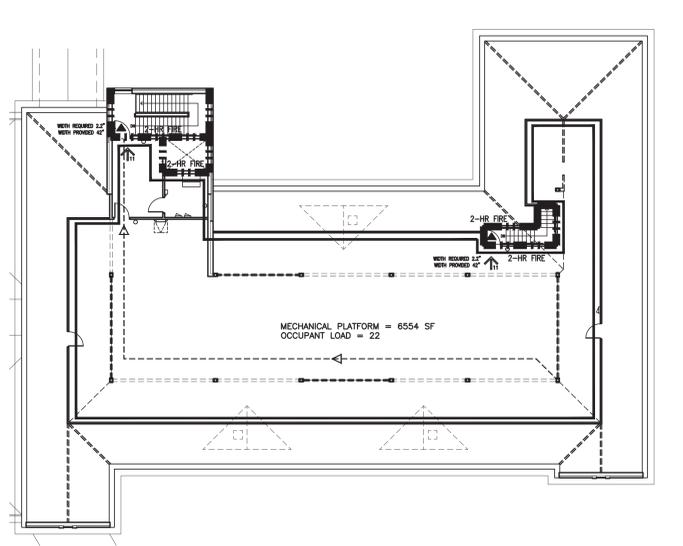

3 MECHANICAL PLATFORM CODE PLAN
 G102 1/16" = 1'-0"

CODE ANALYSIS - BUILDING 111

APPLICABLE BUILDING CODES:
 2012 NFPA 101 & 220
 2006 IBC
 2006 ABAAS
 2011 VA PG-13-18
 OSHA
 MISC. VA DESIGN MANUALS FOUND ON TIL: WWW.CFM.VA.GOV/TIL

SQUARE FOOTAGE / HEIGHT
 EXIST GROUND FLOOR: 12,923 S.F.
 GND FLOOR ADDITIONS: 1,127 S.F.
 TOTAL GROUND FLOOR: 14,050 S.F.
 FIRST FLOOR: 11,672 S.F.
 MECH. PLATFORM: 11,672 S.F.
 (INCLUDES ATTIC SPACE)
 TOTAL S.F. 37,394 S.F.

BUILDING HEIGHT: 44'-6"

BUILDING CLASSIFICATION:
 1. OCCUPANCY - NFPA 101
 ALL AREAS NEW AND EXISTING ARE NFPA CLASSIFICATION 'BUSINESS' - CHAPS. 38 & 39

2. TYPE OF CONSTRUCTION - NFPA 220
 CONSTRUCTION IS NFPA TYPE II (222), AND IS FULLY SPRINKLERED. FIRE RESISTIVE RATINGS ARE AS FOLLOWS:


BUILDING ELEMENT	RATING	U.L. DES.#
EXTERIOR BEARING WALLS	2 HR.	U905
INTERIOR BEARING WALLS	2 HR.	U905
ROOF ONLY	1 HR.	
COLUMNS		
FLOOR,COLUMNS,WALLS	2 HR.	X528-C
ROOF ONLY	1 HR.	X528-B
BEAMS		
FLOOR, COLUMNS, WALLS	2 HR.	N501
ROOF ONLY	1 HR.	L524 SIM.
SHAFT ENCLOSURES	1 HR.	U469
		U465
		J903
FLOOR CONSTRUCTION	2 HR.	P512
ROOF CONSTRUCTION	1 HR.	P518
		P519
STAIR ENCLOSURE	2 HR.	U905

ADDITIONAL CODE INFORMATION
 BUILDING IS FULLY SPRINKLERED
 OCCUPANT LOAD BUSINESS AREAS = 100
 OCCUPANT LOAD MECHANICAL = 300
 EGRESS WIDTH COMPONENT = .2 INCHES PER OCCUPANT
 MAX TRAVEL DISTANCE ALLOWED: 300' IN SPRINKLERED BUILDINGS
 MAX. DEAD END CORRIDOR LENGTH ALLOWED: 50' IN SPRINKLERED BUILDINGS

SYMBOL KEY

	EXISTING 2 HR FIRE SEPARATION
	2-HR STAIR/ELEVATOR ENCLOSURE
	1HR SHAFT ENCLOSURE/PARTITION
	SMOKE PARTITION
	AREA OF REFUGE
	DIRECTION OF EXIT FROM AREA
	EGRESS EXIT WIDTH
	FIRE EXTINGUISHER
	MAXIMUM TRAVEL DISTANCE

SEE ALSO REFLECTED CEILING PLAN SHEETS AS105A, AS105B, AND AS105C FOR RATED PARTITION INFORMATION

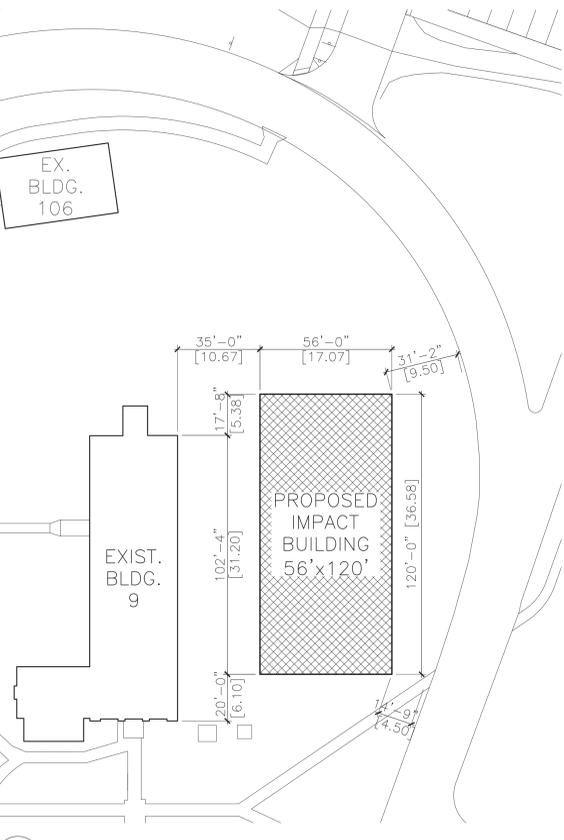

4 IMPACT BUILDING SITE LOCATION PLAN
 G102 1" = 30'-0"

IMPACT BUILDING FIRE SEPARATION

APPLICABLE BUILDING CODES:
 2012 NFPA 101, 220, & 80A
 2006 IBC
 2006 ABAAS
 2011 VA PG-13-18

BUILDING CONFIGURATIONS:
 BUILDING 9 (EXISTING): TWO-STORIES, BRICK EXTERIOR, SHINGLED SLOPED ROOF. SPRINKLERING ASSUMED

EXPOSED WALL APPROX. 102'x24'

IMPACT BUILDING: FULLY SPRINKLERED ONE STORY, EXT. WALLS ARE WOOD PANELS OVER 1/2" EXT. GWB. ROOF IS EPDM OVER OSB ON WD. TRUSSES

EXPOSING WALL 120'x11'

FIRE SEPARATION DISTANCE:
 AS PER NFPA 80A, SECTION 5.6.3: 'WHERE THE EXPOSING BUILDING OR STRUCTURE IS PROTECTED THROUGHOUT BY AN APPROVED, PROPERLY MAINTAINED AUTOMATIC SPRINKLER SYSTEM...NO EXPOSURE HAZARD SHOULD BE CONSIDERED TO EXIST.'

MINIMUM FIRE SEPARATION DISTANCE AS PER NFPA 80A: 0 FEET BETWEEN BUILDINGS.

IBC 2006, TABLE 602:


FOR B&I OCCUPANCIES IN CONSTR. TYPES IIB OR VB WITH NON-RATED EXTERIOR WALLS AND OPENINGS:

MINIMUM FIRE SEPARATION DISTANCE AS PER IBC 2006: 10' (20' BETWEEN BLDGS.)

BUILDING CLASSIFICATION:
 1. OCCUPANCY BUILDING 9: I
 IMPACT BLDG: B

2. TYPE OF CONSTRUCTION BUILDING 9: ASSUMED II-B (222)
 IMPACT BLDG: V-B (000)

ROOF TYPES SEE SHEET AS102B FOR WALL TYPES

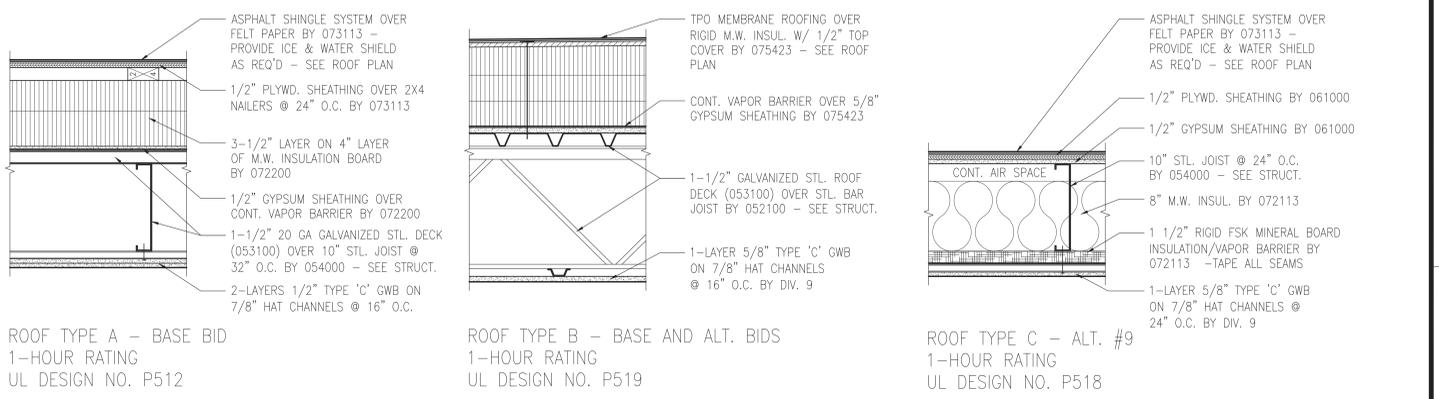

CONSTRUCTION DOCUMENTS SUBMISSION


<p>STRUCTURAL HEYER ENGINEERING 1800 NORTH STREET PARK, NORTH DAKOTA 58103</p> <p>MECHANICAL, FIRE PROTECTION & ELECTRICAL OSBOMER-NELSON ENGINEERING, INC 2011 12TH STREET NORTH, STE. 4 PARK, NORTH DAKOTA 58103</p> <p>CIVIL HANSEN THORP FELLEMAN OLSON, INC 7018 MARKET PLACE BOYD BOYD, NORTH DAKOTA 58209</p> <p>LEED SANDERUP 2140 ROBERTSON AVE WAXY PARK, MN 55114</p> <p>BUILDING COMMISSIONING COMMISSIONING SOLUTIONS 2001 12TH STREET NORTH, STE. 8 PARK, NORTH DAKOTA 58103</p> <p>INDUSTRIAL HYGIENE LEIBEND TECHNICAL SERVICES, INC. 1104 WORTAL PARK PARK, MN 55103</p>	<p>I HEREBY CERTIFY THAT THIS PLAN, SPECIFICATION OR REPORT WAS PREPARED BY ME OR UNDER MY DIRECT SUPERVISION AND THAT I AM A DULY REGISTERED ARCHITECT UNDER THE LAWS OF THE STATE OF MINNESOTA.</p> <p><i>Rochelle Conzemius</i> ROCHELLE CONZEMIUS DATE: 12/16/2014 REG. NO. 46294</p>	<table border="1"> <tr> <td>APPROVED: SERVICE LINE DIRECTOR</td> <td>DATE:</td> <td>APPROVED: INFECTION CONTROL NURSE</td> <td>DATE:</td> </tr> <tr> <td>APPROVED: GONG COORDINATOR</td> <td>DATE:</td> <td>APPROVED: PATIENT SAFETY</td> <td>DATE:</td> </tr> <tr> <td>APPROVED: PROJECTS SECTION MANAGER</td> <td>DATE:</td> <td>APPROVED: CHIEF OF POLICE</td> <td>DATE:</td> </tr> <tr> <td>APPROVED: DIRECTOR FMS</td> <td>DATE:</td> <td>APPROVED: SAFETY MANAGER</td> <td>DATE:</td> </tr> </table>	APPROVED: SERVICE LINE DIRECTOR	DATE:	APPROVED: INFECTION CONTROL NURSE	DATE:	APPROVED: GONG COORDINATOR	DATE:	APPROVED: PATIENT SAFETY	DATE:	APPROVED: PROJECTS SECTION MANAGER	DATE:	APPROVED: CHIEF OF POLICE	DATE:	APPROVED: DIRECTOR FMS	DATE:	APPROVED: SAFETY MANAGER	DATE:	<table border="1"> <tr> <td> DRAWING TITLE CODE SHEET ROOF TYPES </td> <td> PROJECT TITLE EXPAND / CONSTRUCT OUTPATIENT MENTAL HEALTH CLINIC </td> <td> SUBMISSION DATE 12/16/14 </td> </tr> <tr> <td> APPROVED ASSOCIATE HEALTH CARE SYSTEM DIRECTOR DATE: </td> <td> APPROVED CHIEF OF STAFF DATE: </td> <td> PROJECT NO. 656-241 </td> </tr> <tr> <td> APPROVED: HEALTH CARE SYSTEM DIRECTOR DATE: </td> <td> BUILDING No. 111 </td> <td> PROJECT NO. NO. 1327.00 </td> </tr> <tr> <td> APPROVED: HEALTH CARE SYSTEM DIRECTOR DATE: </td> <td> CHECKED BY RDC </td> <td> DRAWING NO. 111-G102 </td> </tr> <tr> <td> LOCATION V.A. MEDICAL CENTER ST. CLOUD, MN 56303 </td> <td> DATE: 12/16/2014 </td> <td> SHEET NO. 2 OF 120 </td> </tr> </table>	DRAWING TITLE CODE SHEET ROOF TYPES	PROJECT TITLE EXPAND / CONSTRUCT OUTPATIENT MENTAL HEALTH CLINIC	SUBMISSION DATE 12/16/14	APPROVED ASSOCIATE HEALTH CARE SYSTEM DIRECTOR DATE:	APPROVED CHIEF OF STAFF DATE:	PROJECT NO. 656-241	APPROVED: HEALTH CARE SYSTEM DIRECTOR DATE:	BUILDING No. 111	PROJECT NO. NO. 1327.00	APPROVED: HEALTH CARE SYSTEM DIRECTOR DATE:	CHECKED BY RDC	DRAWING NO. 111-G102	LOCATION V.A. MEDICAL CENTER ST. CLOUD, MN 56303	DATE: 12/16/2014	SHEET NO. 2 OF 120
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LOCATION V.A. MEDICAL CENTER ST. CLOUD, MN 56303	DATE: 12/16/2014	SHEET NO. 2 OF 120																																



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GENERAL ACCESSIBILITY NOTES:


- PROJECT SHALL MEET FEDERAL ACCESSIBILITY REQUIREMENTS AS OUTLINED IN THE 2006 ARCHITECTURAL BARRIERS ACT ACCESSIBILITY STANDARD (ABAAS), AS AMENDED BY THE 2011 DEPT. OF VETERANS AFFAIRS BARRIER FREE DESIGN GUIDE PG-18-13 (*).
- CONTRACTOR SHALL MEET VA ACCESSIBILITY REQUIREMENTS REGARDLESS OF INDICATION IN CONSTRUCTION DOCUMENTS.
- MINIMUM WIDTH OF ANY ACCESSIBLE ROUTE SHALL BE 60" (1500).
- MAXIMUM RUNNING SLOPE OF ANY WALKING SURFACE SHALL BE 1:33 (3%), EXCEPT RAMPS WHICH SHALL BE 1:20 (5%) MAX. MAXIMUM CROSS SLOPE SHALL BE 1:48 (2.08%)

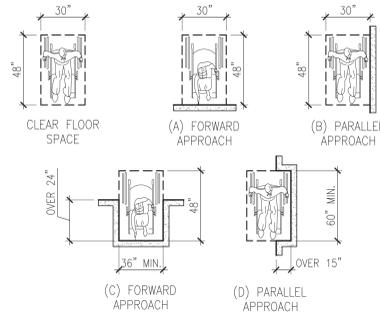

CLEAR FLOOR SPACE IN ALCOVES SHALL BE 48"x30" MIN. EXCEPT WHERE ALCOVE DEPTH IS AS NOTED IN (C) AND (D).
KNEE CLEARANCE SHALL BE 25 IN. (635 MM) IN DEPTH MAXIMUM, 30 IN. (760 MM) WIDE MINIMUM, AND 27 IN. (685 MM) HIGH MINIMUM. TOE CLEARANCE SHALL BE 6 IN. (150 MM) DEEP MAXIMUM AND 9 IN. (225 MM) HIGH MINIMUM.


ONE FULL UNOBSTRUCTED SIDE OF THE CLEAR FLOOR OR GROUND SPACE FOR A WHEELCHAIR SHALL ADJOIN OR OVERLAP AN ACCESSIBLE ROUTE OR ADJOIN ANOTHER WHEELCHAIR CLEAR FLOOR SPACE. IF A CLEAR FLOOR SPACE IS LOCATED IN AN ALCOVE OR OTHERWISE CONFINED ON ALL OR PART OF THREE SIDES, ADDITIONAL MANEUVERING CLEARANCES SHALL BE PROVIDED AS FOLLOWS:

- FORWARD APPROACH. THE WIDTH OF AN ALCOVE SHALL BE 36 IN. (915 MM) MINIMUM WHEN THE DEPTH EXCEEDS 24 IN. (610 MM). (SEE FIG. ABOVE)
- PARALLEL APPROACH. THE LENGTH OF AN ALCOVE SHALL BE 60 IN. (1525 MM) MINIMUM WHEN THE DEPTH EXCEEDS 15 IN. (380 MM). (SEE FIG. ABOVE)

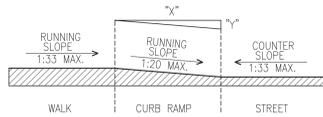

NOTE:
(1) SLOPE = "Y"/"X", WHERE "X" IS A LEVEL PLANE.
(2) COUNTERSLOPE SHALL NOT EXCEED 1:33.


MEASUREMENT OF CURB RAMP SLOPES

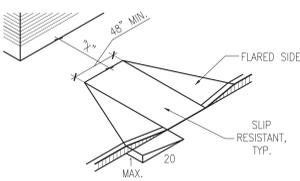


SIDES OF CURB RAMP

CURB RAMPS ABAAS §406*
N.T.S.


CLEAR FLOOR/GROUND SPACE ABAAS §305
N.T.S.

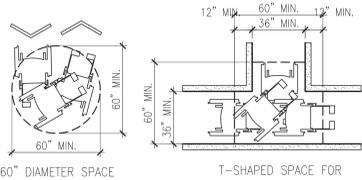

WHEELCHAIR TURNING SPACE ABAAS §304
N.T.S.

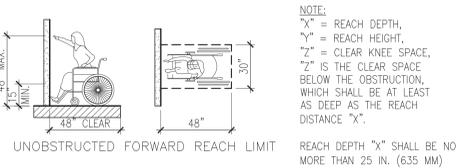


PARALLEL APPROACH

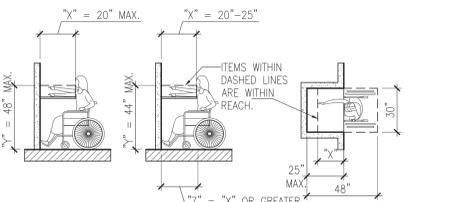


FORWARD REACH OVER AN OBSTRUCTION

FORWARD REACH ABAAS §308.2
N.T.S.

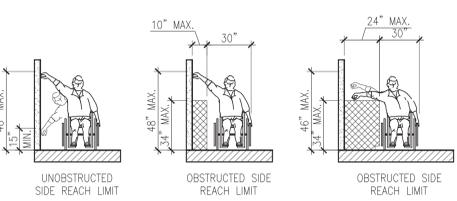


SIDE REACH ABAAS §308.3
N.T.S.

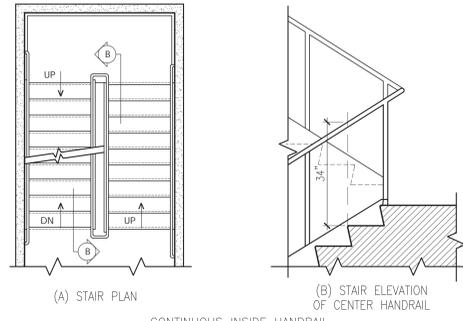


CONTINUOUS INSIDE HANDRAIL
HANDRAILS SHALL BE PROVIDED ON BOTH SIDES OF STAIRS AND RAMPS.
HANDRAILS SHALL BE CONTINUOUS WITHIN THE FULL LENGTH OF EACH STAIR FLIGHT OR RAMP RUN.
GRIPPING SURFACES SHALL BE CONTINUOUS, WITHOUT INTERRUPTION BY NEWEL POSTS, OTHER CONSTRUCTION ELEMENTS, OR OBSTRUCTIONS.
EDGES SHALL BE ROUNDED.
HANDRAILS SHALL NOT ROTATE WITHIN THEIR FITTINGS.


HANDRAILS ABAAS §505*
N.T.S.

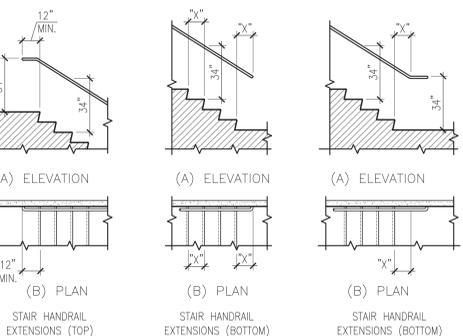

HANDRAIL EXTENSIONS ABAAS §505.10*
N.T.S.

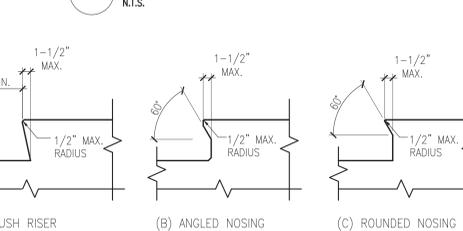


STAIR NOSINGS ABAAS §504.5
N.T.S.

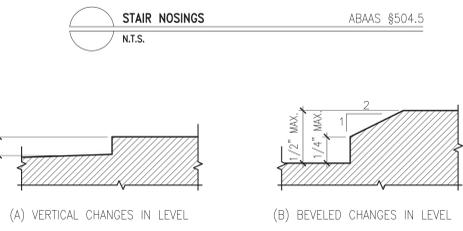


CHANGES IN LEVEL ABAAS §303
N.T.S.

ALL CHANGES IN LEVEL GREATER THAN 1/2 IN. (13 MM) SHALL BE ACCOMPLISHED BY A RAMP
CARPET OR CARPET TILE SHALL BE SECURELY ATTACHED AND SHALL HAVE A FIRM CUSHION, PAD, OR BACKING OR NO CUSHION OR PAD. CARPET OR CARPET TILE SHALL HAVE A LEVEL LOOP, TEXTURED LOOP, LEVEL CUT PILE, OR LEVEL CUT/ANGUT PILE TEXTURE. THE PILE SHALL BE 1/2 INCH MAXIMUM IN HEIGHT. EXPOSED EDGES TO CARPET SHALL BE FASTENED TO THE FLOOR AND SHALL HAVE TRIM ALONG THE ENTIRE LENGTH OF THE EXPOSED EDGE.
OPENINGS IN FLOOR SURFACES SHALL BE OF A SIZE THAT DOES NOT PERMIT THE PASSAGE OF A 1/2 INCH DIAMETER SPHERE. ELONGATED OPENINGS SHALL BE PLACED SO THAT THE LONG DIMENSION IS PERPENDICULAR TO THE DOMINANT DIRECTION OF TRAVEL.

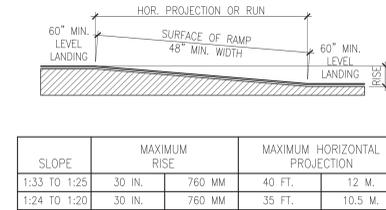


SLOPE	MAXIMUM RISE	MAXIMUM HORIZONTAL PROJECTION
1:33 TO 1:25	30 IN.	760 MM
1:24 TO 1:20	30 IN.	760 MM
		40 FT. / 12 M.
		35 FT. / 10.5 M.


COMPONENTS OF A SINGLE RAMP RUN AND SAMPLE RAMP DIMENSIONS

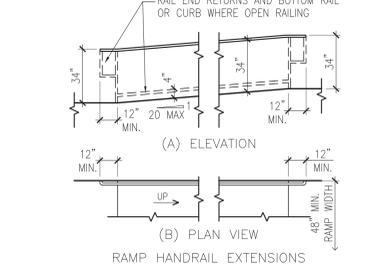


RAMPS ABAAS §405*
N.T.S.

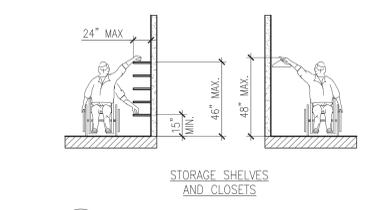

STORAGE ABAAS §8811 & 308
N.T.S.

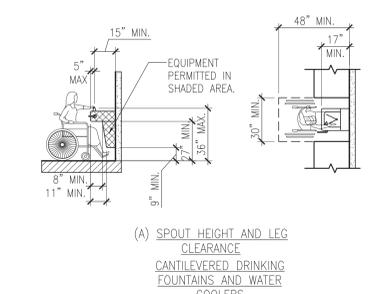


DRINKING FOUNTAINS ABAAS §602
N.T.S.

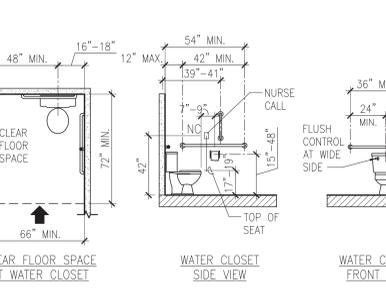


WATER CLOSETS ABAAS §8604* & 609*
N.T.S.


WATER CLOSETS SHALL BE MOUNTED ADJACENT TO A SIDE WALL OR PARTITION. THE DISTANCE FROM THE SIDE WALL OR PARTITION TO THE CENTERLINE OF THE WATER CLOSET SHALL BE 16-18 IN. (405-455 MM).
HAND OPERATED CONTROLS FOR FLUSHMETERS SHALL BE MOUNTED 44 IN. (1120 MM) MAXIMUM ABOVE THE FLOOR ON THE WIDE SIDE OF THE TOILET STALL.

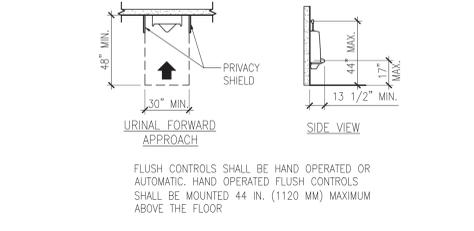

URINALS ABAAS §8605 & 308
N.T.S.

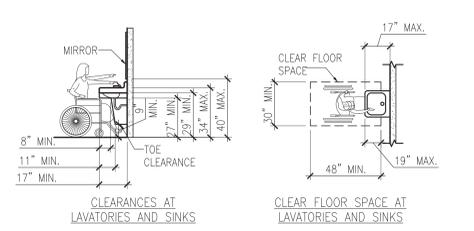


CLEARANCES AT LAVATORIES AND SINKS ABAAS §8606 & 306
N.T.S.

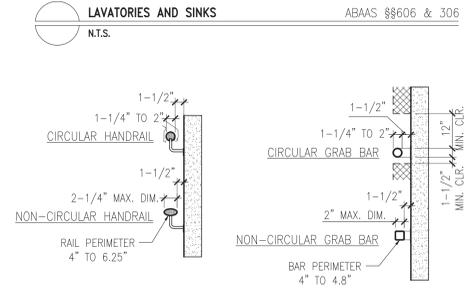

LAVATORIES AND SINKS ABAAS §8606 & 306
N.T.S.

* GRAB BARS ARE REQUIRED IN ALL TOILET STALLS
GRAB BARS SHALL BE MOUNTED IN A HORIZONTAL POSITION, 33 IN. TO 36 IN. (840 MM TO 915 MM) ABOVE THE FLOOR EXCEPT WHERE A SUPPLEMENTAL GRAB BAR IS INSTALLED IN A FIXTURE RIM OR SURFACE.
ALLOWABLE STRESSES IN BENDING, SHEAR AND TENSION SHALL NOT BE EXCEEDED FOR MATERIALS USED WHEN A VERTICAL OR HORIZONTAL FORCE OF 250 LB. (112 N) IS APPLIED AT ANY POINT ON THE GRAB BAR, SEAT, FASTENER MOUNTING DEVICE OR SUPPORTING STRUCTURE.

HANDRAILS AND GRAB BARS ABAAS §8505 & 609
N.T.S.

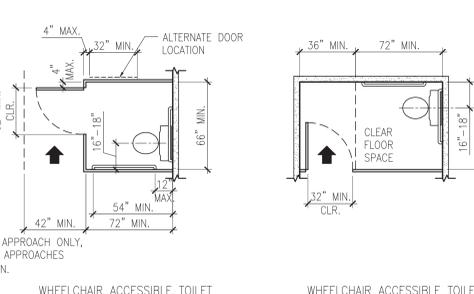

WHEELCHAIR ACCESSIBLE TOILET STALLS - DOOR SWING IN ABAAS §8604.8* & 404
N.T.S.

IF THE DOOR SWINGS INTO THE STALL, THE REQUIRED DEPTH SHALL BE INCREASED BY 36 IN. (915 MM) MINIMUM.
IN WHEELCHAIR ACCESSIBLE STALLS, THE FRONT PARTITION AND AT LEAST ONE SIDE PARTITION SHALL PROVIDE A TOE CLEARANCE OF 9 IN. (230 MM) MINIMUM ABOVE THE FLOOR. TOE CLEARANCE IS NOT REQUIRED IN STALLS GREATER THAN 60 IN. (1525 MM) DEEP.
IF THE APPROACH IS TO THE LATCH SIDE OF THE STALL, THE CLEARANCE BETWEEN THE DOOR SIDE OF THE STALL AND ANY OBSTRUCTION SHALL BE 42 IN. (1065 MM) MINIMUM. THE DOOR SHALL BE HINGED 4 IN. (100 MM) MAXIMUM FROM THE PARTITION FARTHEST FROM THE WATER CLOSET. A HANDLE SHALL BE PLACED ON THE INNER SIDE OF THE DOOR NEAR THE PIVOT POINT OR SELF-CLOSING HINGES SHALL BE PROVIDED.

TOILET COMPARTMENTS ABAAS §8604.8* & 404
N.T.S.

NOTE: PROJECT SHALL MEET FEDERAL ABAAS AND VA BARRIER FREE DESIGN GUIDE (*) REQUIREMENTS

CONSTRUCTION DOCUMENTS SUBMISSION


<p>STRUCTURAL HEYER ENGINEERING 1600 NORTH CENTRAL P.O. BOX 1000 MINNETONKA, MN 55345</p> <p>MECHANICAL, FIRE PROTECTION & ELECTRICAL OSBORN-NEALSON ENGINEERING, INC 2001 NORTH CENTRAL AVE. S.W. P.O. BOX 1000 MINNETONKA, MN 55345</p> <p>CIVIL HANSEN THORP FELLEMAN OLSON, INC 7000 HUNTER PLACE, SUITE 200 MINNETONKA, MN 55345</p> <p>LEED LEED RATED 2100 UNIVERSITY AVE MINNETONKA, MN 55345</p> <p>BUILDING COMMISSIONING COMMISSIONING SOLUTIONS 2001 NORTH CENTRAL AVE. S.W. P.O. BOX 1000 MINNETONKA, MN 55345</p> <p>INDUSTRIAL HYGIENIST LEIBNIZ TECHNICAL SERVICES, INC. 1100 VERTICAL PARK MINNETONKA, MN 55345</p>	<p>I HEREBY CERTIFY THAT THIS PLAN, SPECIFICATION OR REPORT WAS PREPARED BY ME OR UNDER MY DIRECT SUPERVISION AND THAT I AM A DULY REGISTERED ARCHITECT UNDER THE LAWS OF THE STATE OF MINNESOTA.</p> <p><i>Robt Corp.</i> ROCHELLE CONZEMUS DATE: 12/16/2014 REG. NO: 46294</p>	<p>APPROVED: SERVICE LINE DIRECTOR DATE: _____</p> <p>APPROVED: INFECTION CONTROL NURSE DATE: _____</p> <p>APPROVED: GONG COORDINATOR DATE: _____</p> <p>APPROVED: PATIENT SAFETY DATE: _____</p> <p>APPROVED: ASSOCIATE HEALTH CARE SYSTEM DIRECTOR DATE: _____</p> <p>APPROVED: PROJECTS SECTION MANAGER DATE: _____</p> <p>APPROVED: CHIEF OF POLICE DATE: _____</p> <p>APPROVED: CHIEF OF STAFF DATE: _____</p> <p>APPROVED: DIRECTOR FMS DATE: _____</p> <p>APPROVED: SAFETY MANAGER DATE: _____</p> <p>APPROVED: HEALTH CARE SYSTEM DIRECTOR DATE: _____</p>	<p>PROJECT FILE: TYP. MOUNTING HEIGHTS ADA STANDARDS</p> <p>PROJECT NO: 656-341</p> <p>DATE: 12/16/2014</p> <p>PROJECT NO: 111-G103</p> <p>DATE: 12/16/2014</p> <p>PROJECT NO: 111-G103</p> <p>DATE: 12/16/2014</p>	<p>ST. Cloud VA Health Care System Brainerd Monticello Alexandria</p>
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PHASE 1A NOTES

- EXISTING SITE UTILITY LOCATE AND MARKING
- ERECT SITE FENCING AT NORTH B111 AND IMPACT BUILDING SITE
- CONTRACTOR MOBILIZATION
 - STRIP TOPSOIL, PREP AND LEVEL MOBILIZATION AREA
 - CONNECT TEMP. UTILITIES
 - DELIVER JOB TRAILER TO SITE - COORD. LOCATION W/ VAMC
 - BEGIN PROJECT MATERIAL DELIVERY AND STAGING
- GC TO SUBMIT WORKING/PHASING PLAN TO VA FOR ALL PHASE I AND EXTERIOR WORK.

PHASE 1B NOTES

- IMPACT SITE PREPARATION/LEVELING
- IMPACT BLDG. UTILITY INSTALLATION
- IMPACT BUILDING DELIVERY AND INSTALLATION
- INSTALL IMPACT BUILDING SITE AMENITIES
- INSTALL RECEPTION AREA ON WEST END OF B28 - SEE 1&2/AS107.

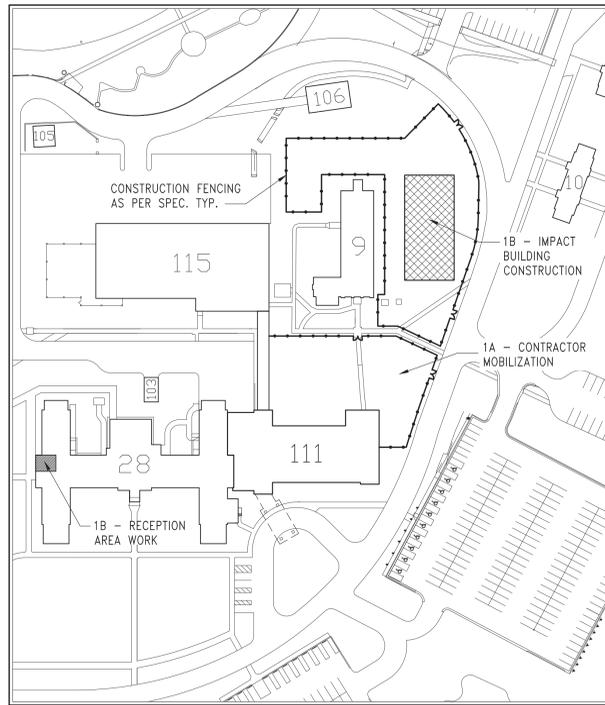


1 SITE PLAN - PHASE 1A/1B
G1104 1" = 80'-0"

PHASE 1C NOTES

- VA ACCEPTANCE OF IMPACT BUILDING
- REMOVE FENCING AROUND IMPACT BUILDING SITE
- VA TO RELOCATE B111 PERSONNEL TO B11 TEMP. AREAS IN B28, AND B28 PERSONNEL TO IMPACT BUILDING
- VA INSTALL TEMP. SIGNAGE
- GC TO SUBMIT WORKING/PHASING PLAN TO VA FOR ALL PHASE II AND III WORK

PHASE 1D NOTES

- INSTALL SITE UTILITIES - SEE CIVIL
- ERECT INTERIOR CONSTRUCTION BARRIER
- INSTALL TEMPORARY HVAC AND ELEC. SERVICES IN B111

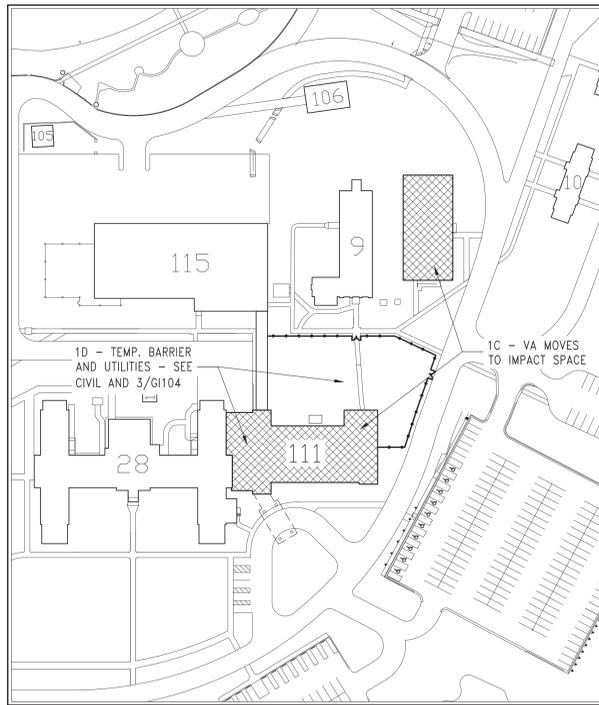


2 SITE PLAN - PHASE 1C/1D
G1104 1" = 80'-0"

PHASE 1D INTERIOR NOTES

- INSTALL TEMP CONSTRUCTION BARRIER - SEE 1/AD101 & 3/AS301
- INSTALL AND CONNECT TEMP DUCTWORK TO TEMPORARY EXTERNAL HVAC UNIT - SEE MECH.
- CONNECT TEMP POWER FROM BLDG. 28 - SEE ELEC.

G.C. TO COORDINATE AND GAIN PRIOR APPROVAL FROM VA FOR ALL INTERIOR WORK PERFORMED OUTSIDE OF CONSTRUCTION BARRIER

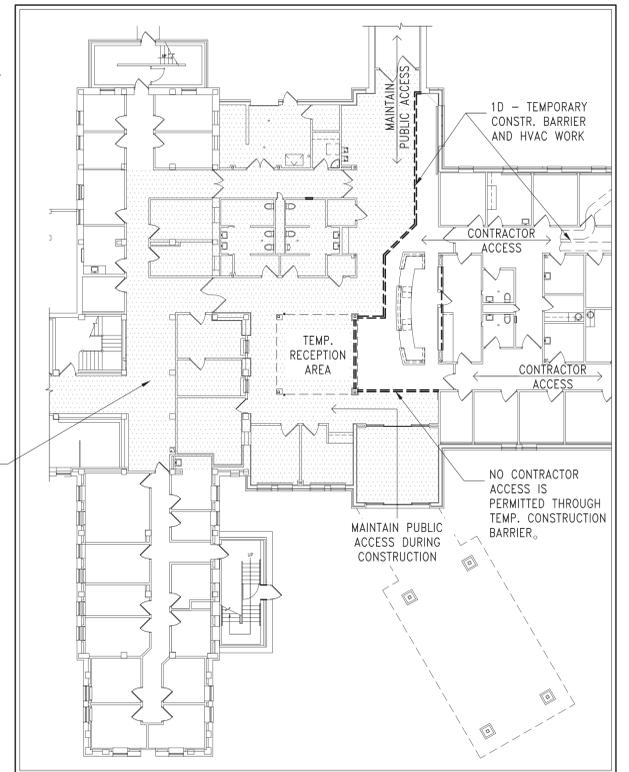

3 INTERIOR PLAN - PHASE 1D
G1104 1/16" = 1'-0"

GENERAL PHASING PLAN NOTES


- ANTICIPATED PHASING PLANS THIS SHEET ARE FOR INFORMATIONAL PURPOSES ONLY. PROJECT CONSTRUCTION SCHEDULE, SEQUENCING AND TIMING OF ALL WORK IS THE CONTRACTOR'S RESPONSIBILITY AND SHALL BE COORDINATED WITH ALL CONTRACTORS AND THE VA.
- PRIOR APPROVAL IS REQUIRED BY THE VA BEFORE COMMENCEMENT OF ANY ACTIVITIES OUTSIDE ESTABLISHED CONSTRUCTION PHASE BOUNDARIES.
- ALL CONSTRUCTION MATERIAL STAGING, CONTRACTOR PARKING, AND WORK SHALL BE ACCOMPLISHED WITHIN THE BOUNDARIES OF THE CONSTRUCTION FENCING.
- ALL EXISTING BUILDING AND SITE ELEMENTS SHALL BE PROTECTED THROUGHOUT THE CONSTRUCTION PERIOD. CONTRACTOR SHALL BE RESPONSIBLE FOR REPAIR OR REPLACEMENT OF DAMAGED ITEMS.
- MAINTAIN ESTABLISHED ACCESS TO BUILDINGS B111, B28, B115, AND B9 AT ALL TIMES.
- MAINTAIN EGRESS PATHS FROM CONSTRUCTION AREA AND ADJACENT BUILDINGS. DO NOT BLOCK SIDEWALKS.
- NO CONTRACTOR ACCESS TO OCCUR THROUGH INTERIOR CONSTRUCTION PARTITION - SEE INFECTION CONTROL PORTION OF SPECIFICATIONS.

PHASE 2A NOTES

- CONTRACTOR SHALL PROTECT ALL EXISTING BUILDING ELEMENTS FROM DAMAGE THROUGHOUT PROJECT
- INSTALL TEMPORARY SIDEWALK AND CONSTR. FENCING SOUTH OF BLDG. 111
- BLDG 111 SHELL REMODELING
 - INSTALL TEMP. WEATHERPROOF ROOF BARRIERS IN BLDG. 111 AS REQ'D
 - REMOVE EXIST. ROOF AND INSTALL NEW STRUCTURE, UPPER FLOOR, EXTERIOR WALLS AND NEW ROOF
 - RELOCATE OR INSTALL ADDITIONAL SITE FENCING AS REQ'D

PHASE 2B NOTES

- CONTRACTOR SHALL PROTECT ALL EXISTING BUILDING ELEMENTS FROM DAMAGE THROUGHOUT PROJECT.
- REMODEL GROUND FLOOR, PERFORM NEW UPPER FLOOR WORK.
- RELOCATE OR INSTALL ADDITIONAL CONSTRUCTION BARRIERS AS REQ'D.
- DISCONNECT TEMP HVAC/POWER AND FINISH INTERIOR REMODELING.
- FINAL CLEANING OF B111 REMODELING.
- PERFORM OWNER INSPECTION OF B111 INTERIOR REMODELING.

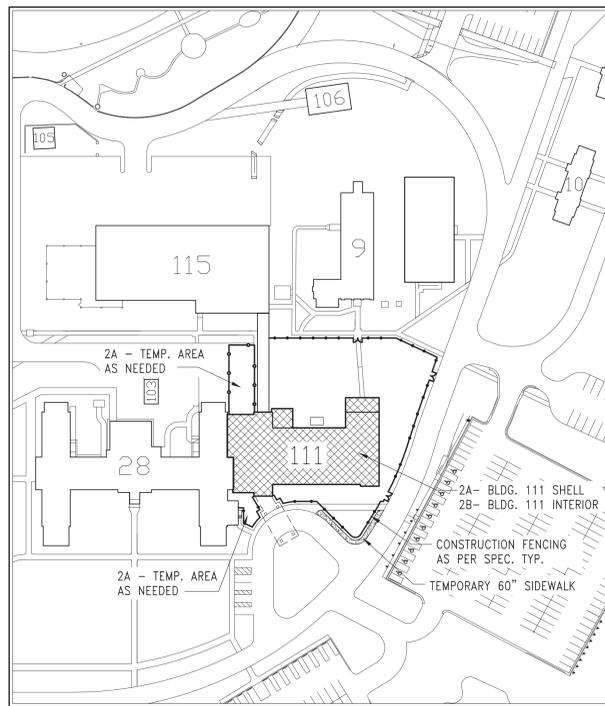


4 SITE PLAN - PHASE 2A/2B
G1104 1" = 80'-0"

PHASE 3A NOTES

- REMOVE TEMP. RTU, PAD, AND TEMP. CONNECTIONS.
- INSTALL ADDITIONAL SITE FENCING SOUTH OF B111 AS REQ'D
- FINISH B111 EXTERIOR REMODELING
- REMOVE SITE FENCING SOUTH OF B111
- RESTORE SITE SOUTH OF B111

PHASE 3B NOTES

- REMOVE ALL B111 TEMP. SITE UTILITIES
- INSTALL SIDEWALKS SOUTH OF B111
- FINISH B111 EXTERIOR REMODELING
- OWNER TAKES OCCUPANCY OF BUILDING 111 INTERIOR REMODELING AND RETURNS B28 PERSONNEL TO B111 AND IMPACT BUILDING PERSONNEL TO B28
- CONTRACTOR REMOVES TEMP. JOB TRAILER AND ALL EXCESS MATERIALS FROM SITE

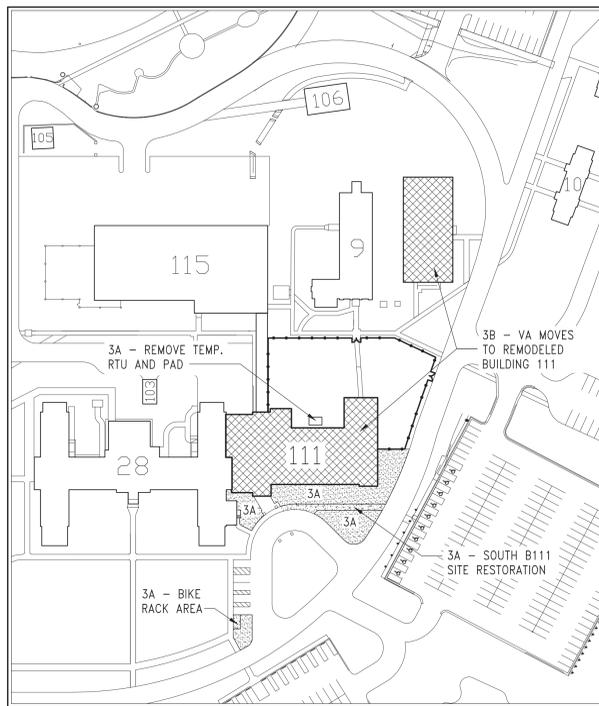


5 SITE PLAN - PHASE 3A/3B
G1104 1" = 80'-0"

PHASE 3C NOTES

- REINSTALL IMPACT SITE FENCING
- DISCONNECT OF TEMP. IMPACT BLDG. UTILITIES
- DISASSEMBLY AND REMOVAL OF IMPACT BUILDING FROM SITE
- REMOVAL OF TEMP. IMPACT BLDG. SITE UTILITY SYSTEMS.
- REMOVE IMPACT BLDG. SITE FENCING
- IMPACT SITE RESTORATION
 - RESTORE SUBGRADE
 - RESTORE LANDSCAPING/GRASS
 - IMPACT SITE CLEANING

PHASE 3D NOTES

- INSTALL ADDITIONAL SITE FENCING AS REQ'D
- INSTALL SIDEWALKS AND RESTORE SITE EAST AND NORTH OF B111.
- REMOVE ALL SITE FENCING AND CONTRACTOR MATERIALS FROM SITE
- FINAL SITE RESTORATION, CLEANING AND INSPECTION
- PROJECT COMPLETION AND CLOSEOUT

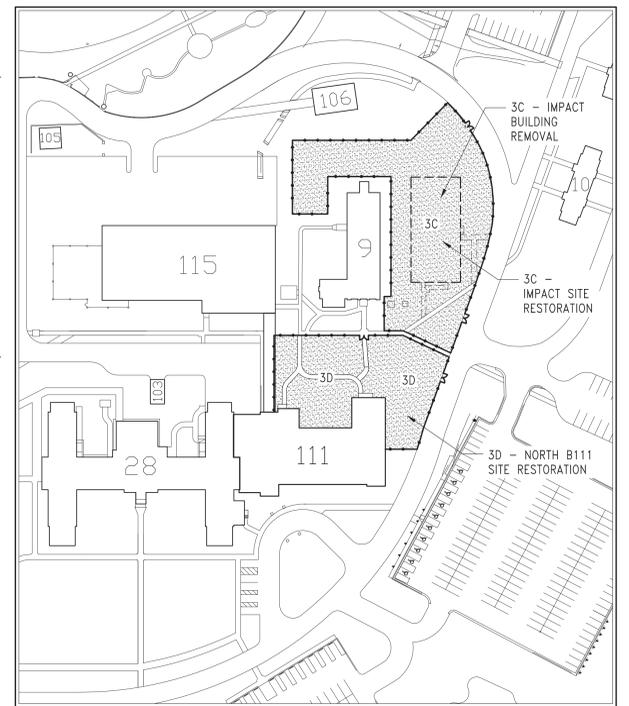

6 SITE PLAN - PHASE 3B/3D
G1104 1" = 80'-0"

CONSTRUCTION DOCUMENTS SUBMISSION

FOSS 810 First Avenue North Fargo, North Dakota 58102 Phone: 701-266-0506 Fax: 701-228-0338 info@foss.com	STRUCTURAL HEYER ENGINEERING 1400 NORTH SIEMENS DRIVE FARGO, NORTH DAKOTA 58104	MECHANICAL, FIRE PROTECTION & ELECTRICAL OBERMILLER-NELSON ENGINEERING, INC 2001 WEST STEVENSON AVENUE, #2 FARGO, NORTH DAKOTA 58104	CIVIL HANSEN THORP FELLEMAN OLSON, INC 7015 MARKET PLACE DRIVE FARGO, NORTH DAKOTA 58104	LEED GOLDER ASSOCIATES 2140 ROBERTSON AVE SAINT PAUL, MN 55106	BUILDING COMMISSIONING COMMISSIONING SOLUTIONS 2001 WEST STEVENSON AVENUE, #2 FARGO, NORTH DAKOTA 58104	INDUSTRIAL HYGIENIST LEIBNIZ TECHNICAL SERVICES, INC. 1108 NORTON AVENUE FARGO, ND 58103	I HEREBY CERTIFY THAT THIS PLAN, SPECIFICATION OR REPORT WAS PREPARED BY ME OR UNDER MY DIRECT SUPERVISION AND THAT I AM A DULY REGISTERED ARCHITECT UNDER THE LAWS OF THE STATE OF MINNESOTA. <i>Robert Corp</i> ROCHELLE CONZEMUS DATE: 12/16/2014 REG. NO: 46294	APPROVED: SERVICE LINE DIRECTOR APPROVED: GANG COORDINATOR APPROVED: PROJECTS SECTION MANAGER APPROVED: DIRECTOR PMO	APPROVED: INFECTION CONTROL NURSE APPROVED: PATIENT SAFETY APPROVED: CHIEF OF POLICE APPROVED: SAFETY MANAGER	DRAWING TITLE PROJECT PHASING PLANS	PROJECT FILE # EXPAND / CONSTRUCT OUTPATIENT MENTAL HEALTH CLINIC	SUBMISSION DATE 12/16/14 PROJECT NO. 656-341 DATE PLOTTED: 12/16/14	BUILDING NO. 111 CHECKED BY RDC DRAWING NO. 111-G1104	LOCATION V.A. MEDICAL CENTER ST. CLOUD, MN 56303	St. Cloud VA Health Care System Brainerd Montevideo Alexandria
	SUBMISSION DATE: 12/16/14 PROJECT NO.: 656-341 DATE PLOTTED: 12/16/14														
	DRAWING NO.: 111-G1104 SHEET NO.: 4 OF 120														
	DATE: 12/16/2014														

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