


- SHEET KEYNOTES**
- INFILL HOLES IN EXISTING SLAB.
 - SAWCUTS FOR PIPE AND DUCT PENETRATIONS. COORDINATE WITH MECHANICAL, PLUMBING AND ELECTRICAL DRAWINGS FOR ADDITIONAL INFORMATION.
 - REMOVE EXISTING BRICK INFILL IN EXISTING MASONRY OPENINGS.
 - REMOVE EXISTING LAUNDRY CHUTE.
 - REMOVE EXISTING BRICK INFILL AND WINDOW IN EXISTING MASONRY OPENING.
 - REMOVE EXISTING CANOPY AND RAMP STRUCTURE IN ITS ENTIRETY, INCLUDING ANY BELOW-GRADE CONCRETE OR OTHER ITEMS ASSOCIATED TO LEAVE AREA CLEAR AND FREE OF ANY DEBRIS, READY TO RECEIVE NEW CONSTRUCTION.
 - REMOVE ALL EXISTING CEILING FINISHES.
 - EXISTING CEILING TO REMAIN.

- GENERAL SHEET NOTES**
- DEMOLITION DRAWINGS ARE DIAGRAMMATIC AND DO NOT INTEND TO SHOW THE FULL EXTENT OF ALL AREAS EFFECTED BY UTILITY REMOVAL AND RECONSTRUCTION. REMOVAL SHALL INCLUDE ALL ITEMS INDICATED ON THE DEMOLITION PLANS AND ALL OTHER ITEMS REQUIRED TO BE REMOVED TO ACCOMPLISH NEW CONSTRUCTION.
 - REMOVE ALL COMPONENTS BACK TO STRUCTURE, INCLUDING HANGERS, BRACKETS, WIRES, ETC.
 - CONTRACTOR SHALL BE RESPONSIBLE FOR CUTTING, PATCHING, AND REPAIR OF ALL EXISTING CONSTRUCTION AND FINISHES REQUIRED FOR THE REMOVAL AND RECONSTRUCTION OF UTILITIES.
 - SEE ALL DRAWINGS FOR ADDITIONAL REMOVAL, RECONSTRUCTION, AND PROTECTION INFORMATION.
 - VERIFY ALL DIMENSIONS AND CONDITIONS AT JOB SITE. PORTIONS OF EXISTING WALLS, CEILINGS, ETC., MAY HAVE BEEN REMOVED BY MEDICAL CENTER.
 - CONTRACTOR TO VERIFY EXACT COMPOSITION OF EXISTING WALLS.
 - CONTRACTOR TO PROVIDE TEMPORARY DUST PARTITIONS TIGHTLY SEALED TO STRUCTURE TO SEPARATE CONSTRUCTION WORK FROM I.T./TELEPHONE CLOSETS.
 - CONTRACTOR SHALL COORDINATE WITH THE COR AN ACCEPTABLE SCHEDULE FOR DISCONNECTING UTILITIES.
 - CONTRACTOR SHALL COORDINATE WITH THE COR THE SCHEDULING OF NOISY OR OTHERWISE INTERRUPTIVE OPERATIONS TO MINIMIZE IMPACT ON MEDICAL CENTER FUNCTIONS.
 - REPAIR AND/OR REPLACE ADJACENT FINISHES TO PROVIDE A SMOOTH AND CONTINUOUS FINISH.
 - CONTRACTOR SHALL FILL ALL HOLES IN CONCRETE INCLUDING MECHANICAL AND PLUMBING PIPING IN FIRST FLOOR THRU THIRD FLOOR WITH CONCRETE. CONTRACTOR SHALL REPAIR OR REPLACE ALL FINISHES TO LIKE-NEW CONDITION.
 - WHERE EXISTING MASONRY WALLS ARE REMOVED OR NEW OPENINGS PROVIDED WITHIN EXISTING MASONRY WALLS TO REMAIN: STRAIGHT AND CLEAN SAWCUTS SHALL BE USED FOR REMOVAL BETWEEN WALL PORTIONS TO BE REMOVED.
 - UNLESS NOTED OTHERWISE, ALL REMOVED MATERIALS BECOME THE PROPERTY OF THE CONTRACTOR AND MUST BE PROPERLY DISPOSED OFF-SITE.
 - REPAIR, LEVEL AND RE-FINISH EXISTING CONCRETE SLABS WHERE NECESSARY FOR INSTALLATION OF SCHEDULED FLOOR FINISHES.
 - REMOVE ALL WALLS, DOORS, WINDOWS, MILLWORK, PLUMBING FIXTURES, ETC., AS INDICATED BY DASHED LINES.
 - CONTRACTOR SHALL PROVIDE TEMPORARY PROTECTION FOR EXISTING CONSTRUCTION TO REMAIN. (SEE GENERAL REQUIREMENTS)
 - CONTRACTOR TO COORDINATE REMOVAL WITH FIRE PROTECTION/PLUMBING/MECHANICAL/ELECTRICAL CONTRACTORS AND PATCH WALLS, FLOORS AND CEILINGS AS NECESSARY.
 - SAWCUT AND REMOVE CONCRETE TO 2 INCHES BELOW FLOOR SLAB AT PLUMBING FIXTURES TO ABANDON AND CAP OFF EXISTING UNDER SLAB PIPING. CAP PIPE WITH CONCRETE OR GROUT. REPAIR AND PATCH FLOOR SLAB WITH NEW CONCRETE AS NECESSARY TO RECEIVE SCHEDULED FLOOR FINISHES.
 - CONTRACTOR TO REMOVE ALL WALL BASE AND FLOOR FINISHES TO CONCRETE SLAB. CONTRACTOR TO PATCH AND REPAIR CONCRETE SLAB FOR INSTALLATION OF NEW FLOOR FINISHES AND WALL BASE.

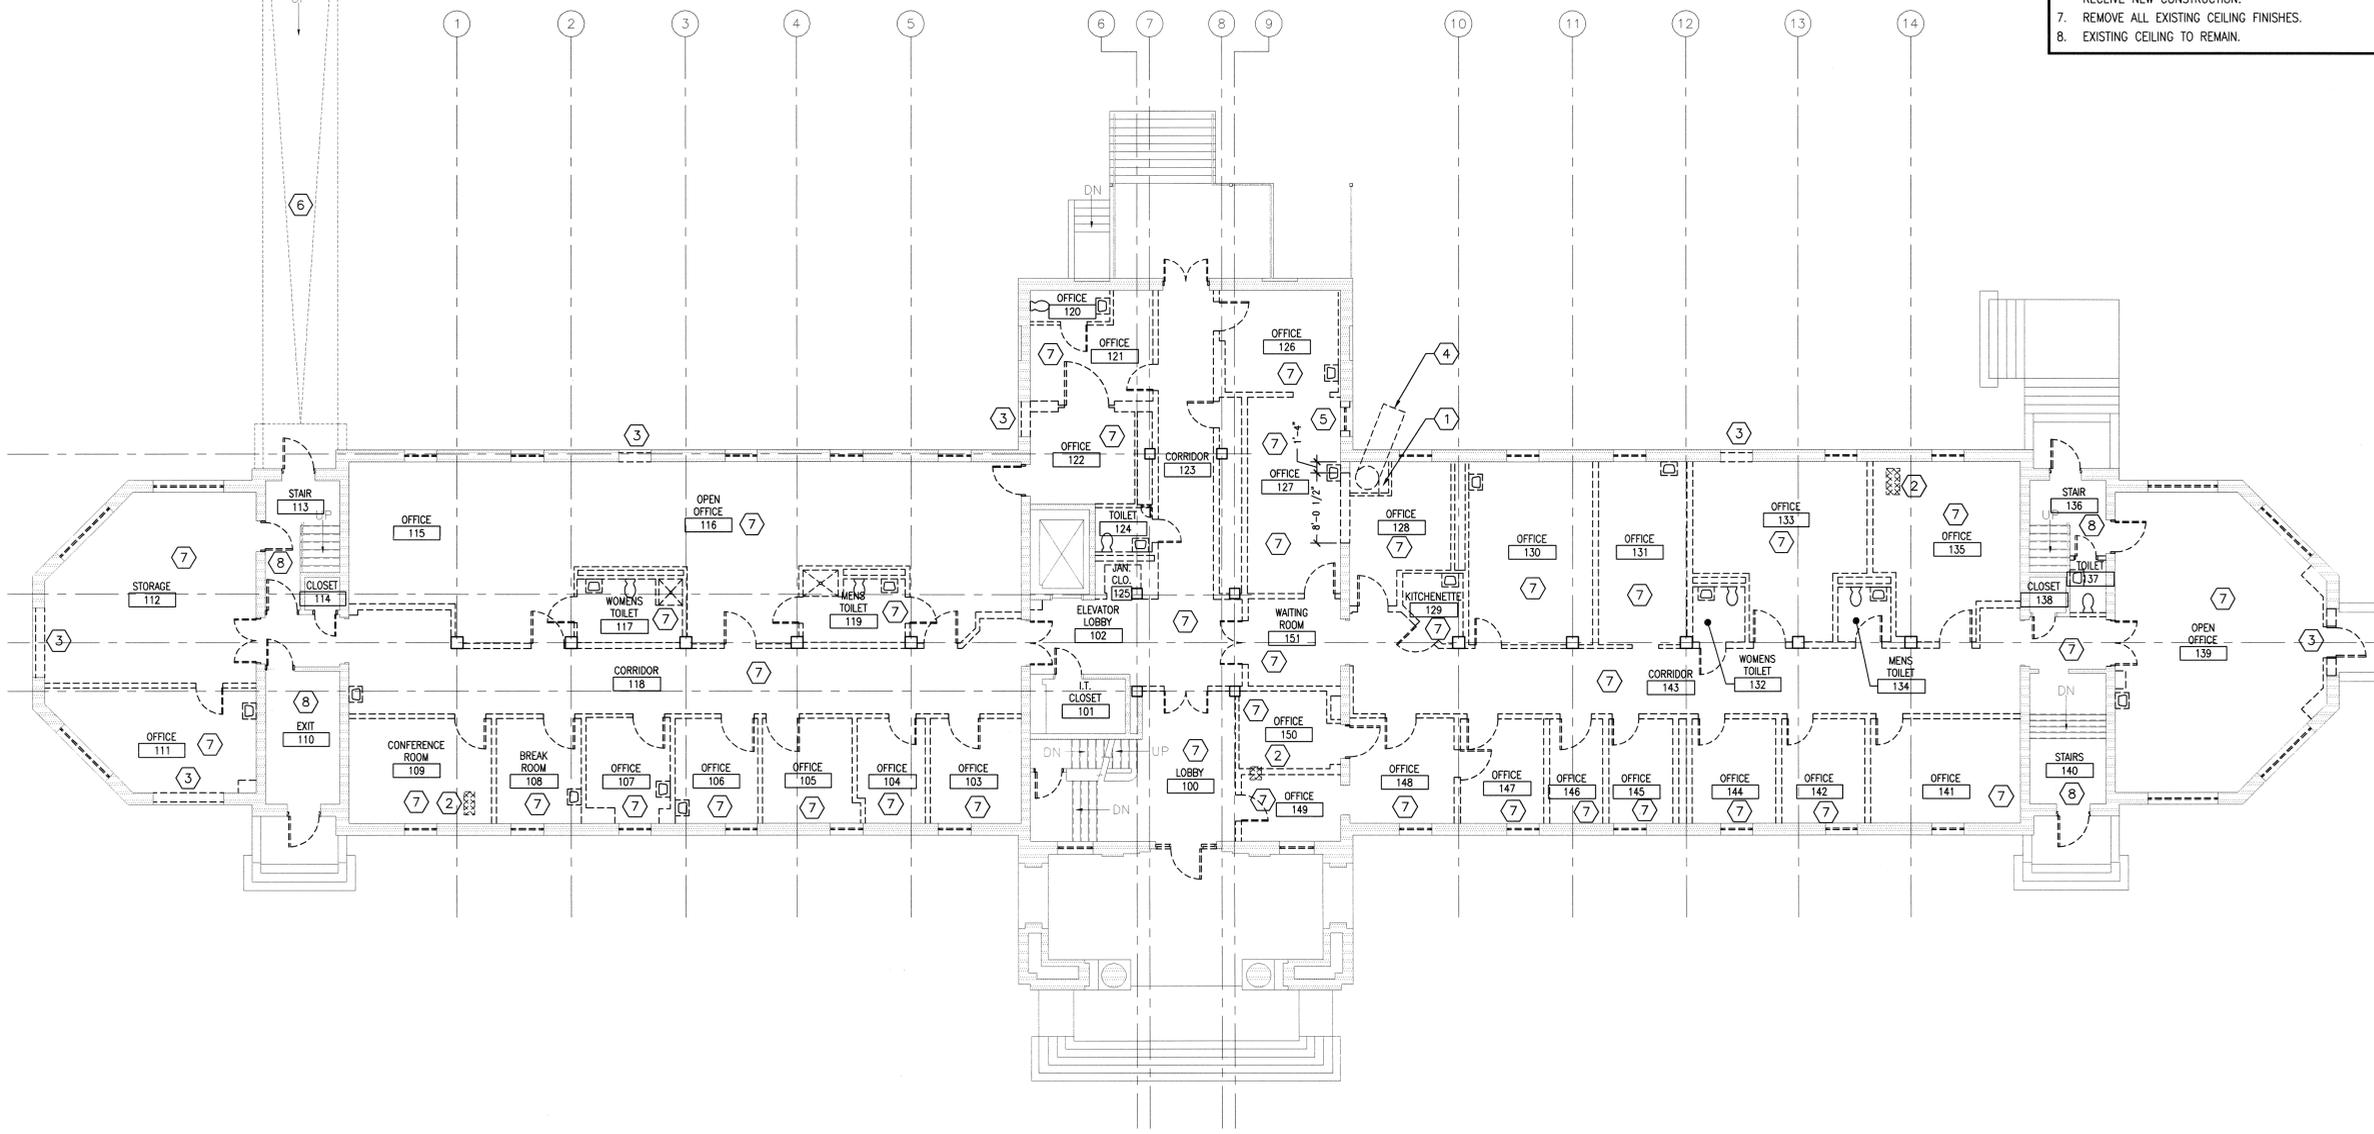

E1 FIRST FLOOR PLAN - DEMOLITION
SCALE: 1/8" = 1'-0"

SYMBOLS LEGEND

	EXISTING WALL, DOOR, WINDOW, MILLWORK, FIXTURE OR OTHER FIXTURE OR ASSEMBLY TO BE REMOVED.
	EXISTING WALL, DOOR, WINDOW, MILLWORK, FIXTURE OR OTHER FIXTURE OR ASSEMBLY TO REMAIN.
	NEW WALL
	2 HOUR RATED FIRE BARRIER
	1 HOUR RATED FIRE BARRIER
	PROJECT LIMITS OF WORK
	NO PIPING OR DUCTWORK SHALL BE ROUTED THROUGH ELECTRICAL AND/OR DATA ROOMS.
	NEW CONCRETE
	EXISTING AREAS OF RAISED CONCRETE TO REMAIN
	EXISTING CONCRETE TO BE REMOVED AND REPAIRED



REVISION NO.	REVISION DESCRIPTION	By	Date

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James H Quillen
VA Medical Center
Dogwood Ave.
Mountain Home, TN 37684

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51683
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HDG PROJECT # 14009

Recommended Approvals:

1. MEDICAL DIRECTOR	6. OPERATIONS SERVICE LINE MANAGER
2. ASSOCIATE DIRECTOR	7. INFECTION CONTROL MANAGER
3. CHIEF OF STAFF	8. SAFETY MANAGER
4. ASSOC. DIRECTOR	9. GENERAL ENGINEER
5. SERVICE LINE MGRS.	10. COR

Drawing Title
FIRST FLOOR PLAN - DEMOLITION
CONSTRUCTION DOCUMENTS
FULLY SPRINKLERED

Project Title
RENOVATE BUILDING 8 FOR ENVIRONMENT AND CONDITION DEFICIENCIES


Drawn	GG	Building Number	8	AutoCAD File Name	
Checked		Reviewed		Const. Contract No.	

Date
OCTOBER 26, 2015
Project Number
621-14-135
DRAWING No.
AD101
DWG 24 of 208




- SHEET KEYNOTES**
- INFILL HOLE IN EXISTING SLAB, SEE F1/AD101.
 - SAWCUT FOR PIPE AND DUCT PENETRATIONS, SEE F3/AD101. COORDINATE WITH MECHANICAL, PLUMBING AND ELECTRICAL DRAWINGS FOR ADDITIONAL INFORMATION.
 - REMOVE EXISTING BRICK INFILL IN EXISTING MASONRY OPENING.
 - REMOVE EXISTING LAUNDRY CHUTE.
 - REMOVE EXISTING BRICK INFILL AND WINDOW IN EXISTING MASONRY OPENING.
 - REMOVE ALL EXISTING CEILING FINISHES.
 - EXISTING CEILING FINISH TO REMAIN.

- GENERAL SHEET NOTES**
- DEMOLITION DRAWINGS ARE DIAGRAMMATIC AND DO NOT INTEND TO SHOW THE FULL EXTENT OF ALL AREAS EFFECTED BY UTILITY REMOVAL AND RECONSTRUCTION. REMOVAL SHALL INCLUDE ALL ITEMS INDICATED ON THE DEMOLITION PLANS AND ALL OTHER ITEMS REQUIRED TO BE REMOVED TO ACCOMPLISH NEW CONSTRUCTION.
 - REMOVE ALL COMPONENTS BACK TO STRUCTURE, INCLUDING HANGERS, BRACKETS, WIRES, ETC.
 - CONTRACTOR SHALL BE RESPONSIBLE FOR CUTTING, PATCHING, AND REPAIR OF ALL EXISTING CONSTRUCTION AND FINISHES REQUIRED FOR THE REMOVAL AND RECONSTRUCTION OF UTILITIES.
 - SEE ALL DRAWINGS FOR ADDITIONAL REMOVAL, RECONSTRUCTION, AND PROTECTION INFORMATION.
 - VERIFY ALL DIMENSIONS AND CONDITIONS AT JOB SITE. PORTIONS OF EXISTING WALLS, CEILINGS, ETC., MAY HAVE BEEN REMOVED BY MEDICAL CENTER.
 - CONTRACTOR TO VERIFY EXACT COMPOSITION OF EXISTING WALLS.
 - CONTRACTOR TO PROVIDE TEMPORARY DUST PARTITIONS TIGHTLY SEALED TO STRUCTURE TO SEPARATE CONSTRUCTION WORK FROM I.T./TELEPHONE CLOSETS.
 - CONTRACTOR SHALL COORDINATE WITH THE COR AN ACCEPTABLE SCHEDULE FOR DISCONNECTING UTILITIES.
 - CONTRACTOR SHALL COORDINATE WITH THE COR THE SCHEDULING OF NOISY OR OTHERWISE INTERRUPTIVE OPERATIONS TO MINIMIZE IMPACT ON MEDICAL CENTER FUNCTIONS.
 - REPAIR AND/OR REPLACE ADJACENT FINISHES TO PROVIDE A SMOOTH AND CONTINUOUS FINISH.
 - CONTRACTOR SHALL FILL ALL HOLES IN CONCRETE INCLUDING MECHANICAL AND PLUMBING PIPING IN FIRST FLOOR THRU THIRD FLOOR WITH CONCRETE. CONTRACTOR SHALL REPAIR OR REPLACE ALL FINISHES TO LIKE-NEW CONDITION.
 - WHERE EXISTING MASONRY WALLS ARE REMOVED OR NEW OPENINGS PROVIDED WITHIN EXISTING MASONRY WALLS TO REMAIN: STRAIGHT AND CLEAN SAWCUTS SHALL BE USED FOR REMOVAL BETWEEN WALL PORTIONS TO BE REMOVED.
 - UNLESS NOTED OTHERWISE, ALL REMOVED MATERIALS BECOME THE PROPERTY OF THE CONTRACTOR AND MUST BE PROPERLY DISPOSED OFF-SITE.
 - REPAIR, LEVEL AND RE-FINISH EXISTING CONCRETE SLABS WHERE NECESSARY FOR INSTALLATION OF SCHEDULED FLOOR FINISHES.
 - REMOVE ALL WALLS, DOORS, WINDOWS, MILLWORK, PLUMBING FIXTURES, ETC., AS INDICATED BY DASHED LINES.
 - CONTRACTOR SHALL PROVIDE TEMPORARY PROTECTION FOR EXISTING CONSTRUCTION TO REMAIN. (SEE GENERAL REQUIREMENTS)
 - CONTRACTOR TO COORDINATE REMOVAL WITH FIRE PROTECTION/PLUMBING/MECHANICAL/ELECTRICAL CONTRACTORS AND PATCH WALLS, FLOORS AND CEILINGS AS NECESSARY.
 - SAWCUT AND REMOVE CONCRETE TO 2 INCHES BELOW FLOOR SLAB AT PLUMBING FIXTURES TO ABANDON AND CAP OFF EXISTING UNDER SLAB PIPING. CAP PIPE WITH CONCRETE OR GROUT. REPAIR AND PATCH FLOOR SLAB WITH NEW CONCRETE AS NECESSARY TO RECEIVE SCHEDULED FLOOR FINISHES.
 - CONTRACTOR TO REMOVE ALL WALL BASE AND FLOOR FINISHES TO CONCRETE SLAB. CONTRACTOR TO PATCH AND REPAIR CONCRETE SLAB FOR INSTALLATION OF NEW FLOOR FINISHES AND WALL BASE.

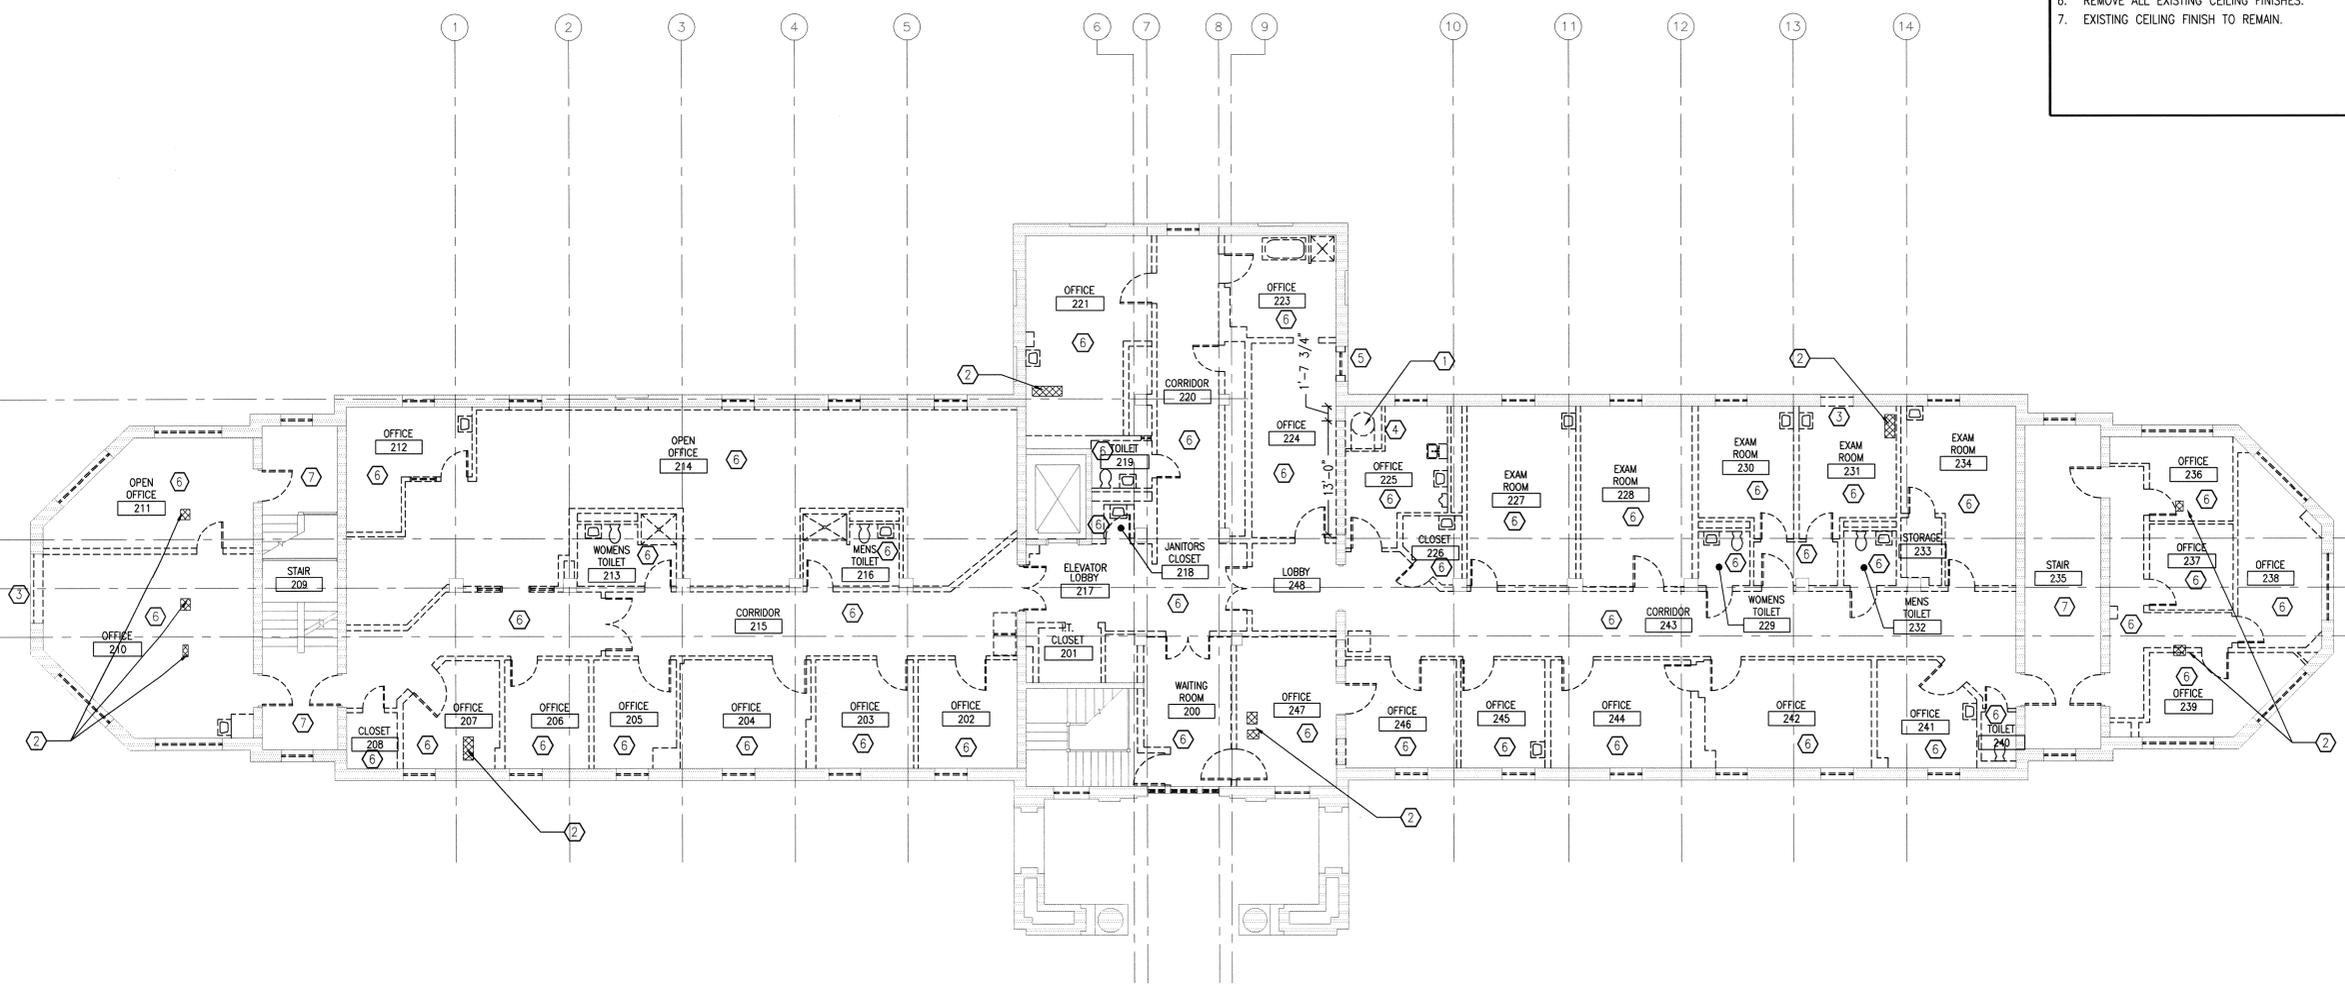

E1 SECOND FLOOR PLAN - DEMOLITION
SCALE: 1/8" = 1'-0"

- SYMBOLS LEGEND**
- EXISTING WALL, DOOR, WINDOW, MILLWORK, FIXTURE OR OTHER FIXTURE OR ASSEMBLY TO BE REMOVED.
 - EXISTING WALL, DOOR, WINDOW, MILLWORK, FIXTURE OR OTHER FIXTURE OR ASSEMBLY TO REMAIN.
 - NEW WALL
 - 2 HOUR RATED FIRE BARRIER
 - 1 HOUR RATED FIRE BARRIER
 - PROJECT LIMITS OF WORK
 - NO PIPING OR DUCTWORK SHALL BE ROUTED THROUGH ELECTRICAL AND/OR DATA ROOMS.
 - NEW CONCRETE
 - EXISTING AREAS OF RAISED CONCRETE TO REMAIN
 - EXISTING CONCRETE TO BE REMOVED AND REPAIRED

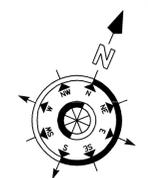

REVISION NO.	REVISION DESCRIPTION	By	Date

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James H Quillen
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Architect/Engineer Address

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 100 PROJECT # 14009

Recommended Approvals:

1. MEDICAL DIRECTOR	6. OPERATIONS SERVICE LINE MANAGER
2. ASSOCIATE DIRECTOR	7. INFECTION CONTROL MANAGER
3. CHIEF OF STAFF	8. SAFETY MANAGER
4. ASSOC. DIRECTOR	9. GENERAL ENGINEER
5. SERVICE LINE MGRS.	10. COR

Drawing Title
SECOND FLOOR PLAN - DEMOLITION

CONSTRUCTION DOCUMENTS

FULLY SPRINKLERED

Project Title
RENOVATE BUILDING 8 FOR ENVIRONMENT AND CONDITION DEFICIENCIES

Drawn GG	Building Number 8	AutoCAD File Name
Checked	Reviewed	Const. Contract No.

Date
OCTOBER 26, 2015

Project Number
621-14-135

DRAWING No.
AD102

DWG **25 of 208**


Veterans Affairs

SHEET KEYNOTES

1. INFILL HOLE IN EXISTING SLAB, SEE F1/AD101.
2. SAWCUT FOR PIPE AND DUCT PENETRATIONS, SEE F3/AD101. COORDINATE WITH MECHANICAL, PLUMBING AND ELECTRICAL DRAWINGS FOR ADDITIONAL INFORMATION.
3. REMOVE EXISTING LAUNDRY CHUTE.
4. REMOVE ALL EXISTING CEILING FINISHES.

GENERAL SHEET NOTES

- A. DEMOLITION DRAWINGS ARE DIAGRAMMATIC AND DO NOT INTEND TO SHOW THE FULL EXTENT OF ALL AREAS EFFECTED BY UTILITY REMOVAL AND RECONSTRUCTION. REMOVAL SHALL INCLUDE ALL ITEMS INDICATED ON THE DEMOLITION PLANS AND ALL OTHER ITEMS REQUIRED TO BE REMOVED TO ACCOMPLISH NEW CONSTRUCTION.
- B. REMOVE ALL COMPONENTS BACK TO STRUCTURE, INCLUDING HANGERS, BRACKETS, WIRES, ETC.
- C. CONTRACTOR SHALL BE RESPONSIBLE FOR CUTTING, PATCHING, AND REPAIR OF ALL EXISTING CONSTRUCTION AND FINISHES REQUIRED FOR THE REMOVAL AND RECONSTRUCTION OF UTILITIES.
- D. SEE ALL DRAWINGS FOR ADDITIONAL REMOVAL, RECONSTRUCTION, AND PROTECTION INFORMATION.
- E. VERIFY ALL DIMENSIONS AND CONDITIONS AT JOB SITE. PORTIONS OF EXISTING WALLS, CEILINGS, ETC., MAY HAVE BEEN REMOVED BY MEDICAL CENTER.
- F. CONTRACTOR TO VERIFY EXACT COMPOSITION OF EXISTING WALLS.
- G. CONTRACTOR TO PROVIDE TEMPORARY DUST PARTITIONS TIGHTLY SEALED TO STRUCTURE TO SEPARATE CONSTRUCTION WORK FROM I.T./TELEPHONE CLOSETS.
- H. CONTRACTOR SHALL COORDINATE WITH THE COR AN ACCEPTABLE SCHEDULE FOR DISCONNECTING UTILITIES.
- I. CONTRACTOR SHALL COORDINATE WITH THE COR THE SCHEDULING OF NOISY OR OTHERWISE INTERRUPTIVE OPERATIONS TO MINIMIZE IMPACT ON MEDICAL CENTER FUNCTIONS.
- J. REPAIR AND/OR REPLACE ADJACENT FINISHES TO PROVIDE A SMOOTH AND CONTINUOUS FINISH.
- K. CONTRACTOR SHALL FILL ALL HOLES IN CONCRETE INCLUDING MECHANICAL AND PLUMBING PIPING IN FIRST FLOOR THRU THIRD FLOOR WITH CONCRETE. CONTRACTOR SHALL REPAIR OR REPLACE ALL FINISHES TO LIKE-NEW CONDITION.
- L. WHERE EXISTING MASONRY WALLS ARE REMOVED OR NEW OPENINGS PROVIDED WITHIN EXISTING MASONRY WALLS TO REMAIN, STRAIGHT AND CLEAN SAWCUTS SHALL BE USED FOR REMOVAL BETWEEN WALL PORTIONS TO BE REMOVED.
- M. UNLESS NOTED OTHERWISE, ALL REMOVED MATERIALS BECOME THE PROPERTY OF THE CONTRACTOR AND MUST BE PROPERLY DISPOSED OFF-SITE.
- N. REPAIR, LEVEL AND RE-FINISH EXISTING CONCRETE SLABS WHERE NECESSARY FOR INSTALLATION OF SCHEDULED FLOOR FINISHES.
- O. REMOVE ALL WALLS, DOORS, WINDOWS, MILLWORK, PLUMBING FIXTURES, ETC., AS INDICATED BY DASHED LINES.
- P. CONTRACTOR SHALL PROVIDE TEMPORARY PROTECTION FOR EXISTING CONSTRUCTION TO REMAIN. (SEE GENERAL REQUIREMENTS)
- Q. CONTRACTOR TO COORDINATE REMOVAL WITH FIRE PROTECTION/PLUMBING/MECHANICAL/ELECTRICAL CONTRACTORS AND PATCH WALLS, FLOORS AND CEILINGS AS NECESSARY.
- R. SAWCUT AND REMOVE CONCRETE TO 2 INCHES BELOW FLOOR SLAB AT PLUMBING FIXTURES TO ABANDON AND CAP OFF EXISTING UNDER SLAB PIPING. CAP PIPE WITH CONCRETE OR GROUT. REPAIR AND PATCH FLOOR SLAB WITH NEW CONCRETE AS NECESSARY TO RECEIVE SCHEDULED FLOOR FINISHES.
- S. CONTRACTOR TO REMOVE ALL WALL BASE AND FLOOR FINISHES TO CONCRETE SLAB. CONTRACTOR TO PATCH AND REPAIR CONCRETE SLAB FOR INSTALLATION OF NEW FLOOR FINISHES AND WALL BASE.

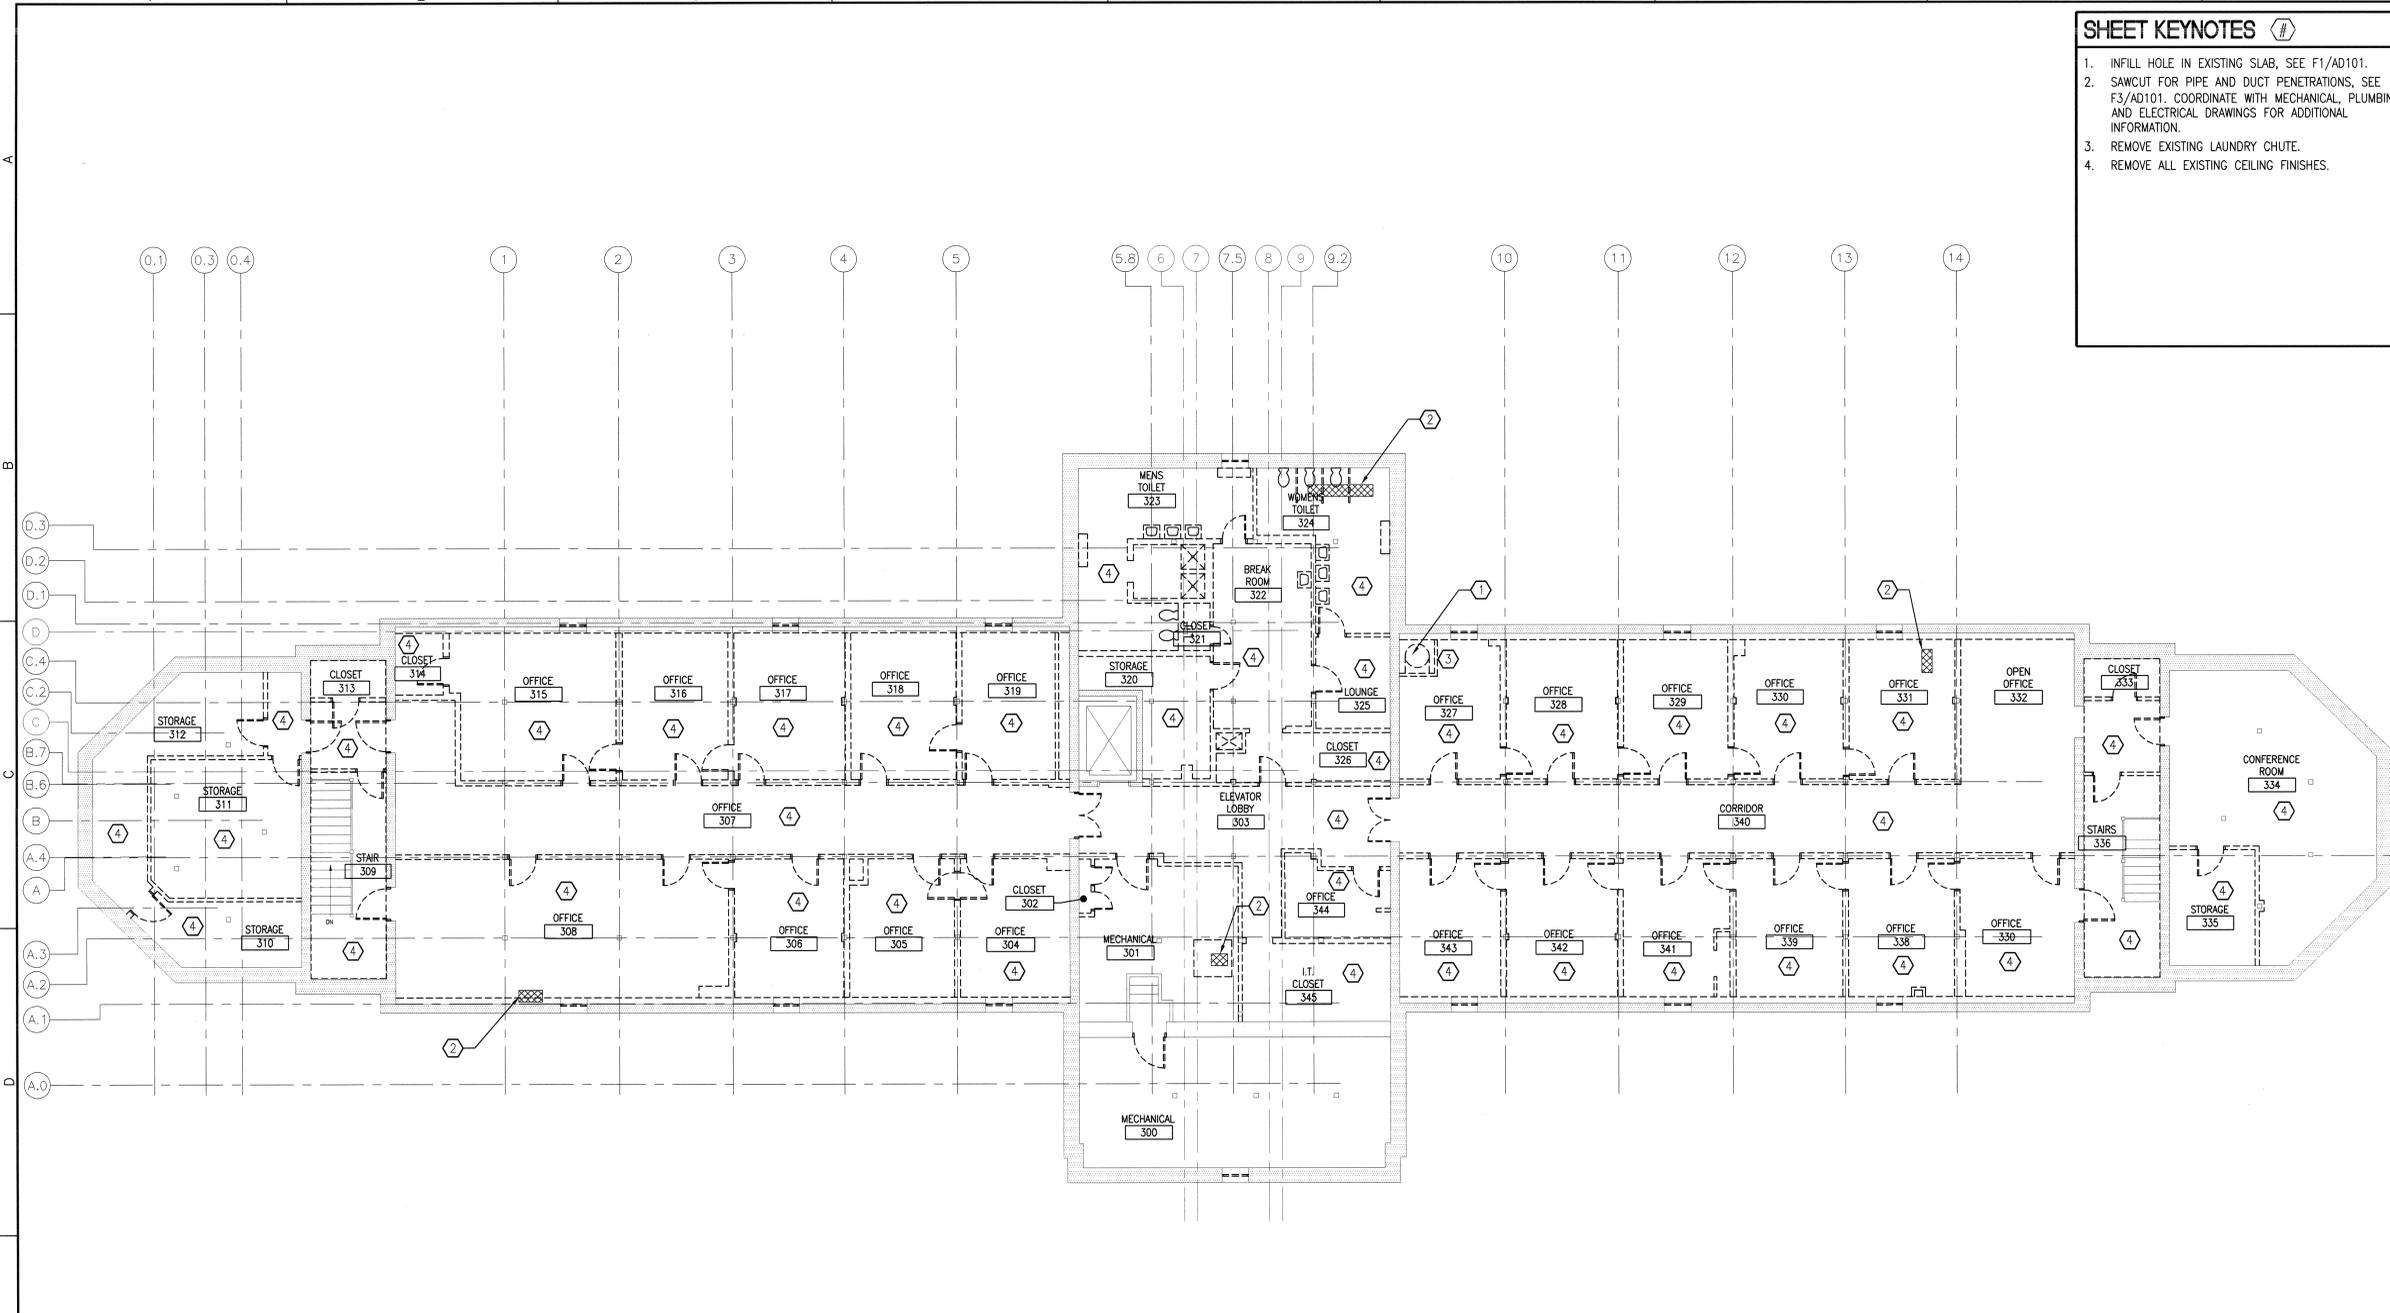

E1 THIRD FLOOR PLAN - DEMOLITION
SCALE: 1/8" = 1'-0"

SYMBOLS LEGEND

- EXISTING WALL, DOOR, WINDOW, MILLWORK, FIXTURE OR OTHER FIXTURE OR ASSEMBLY TO BE REMOVED.
- EXISTING WALL, DOOR, WINDOW, MILLWORK, FIXTURE OR OTHER FIXTURE OR ASSEMBLY TO REMAIN.
- NEW WALL
- 2 HOUR RATED FIRE BARRIER
- 1 HOUR RATED FIRE BARRIER
- PROJECT LIMITS OF WORK
- NO PIPING OR DUCTWORK SHALL BE ROUTED THROUGH ELECTRICAL AND/OR DATA ROOMS.
- NEW CONCRETE
- EXISTING AREAS OF RAISED CONCRETE TO REMAIN
- EXISTING CONCRETE TO BE REMOVED AND REPAIRED



REVISION NO.	REVISION DESCRIPTION	By	Date

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James H Quillen
 VA Medical Center
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 Mountain Home, TN 37684

Architect/Engineer Address

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 HDC PROJECT # 14009

Recommended Approvals:	
1. MEDICAL DIRECTOR	6. OPERATIONS SERVICE LINE MANAGER
2. ASSOCIATE DIRECTOR	7. INFECTION CONTROL MANAGER
3. CHIEF OF STAFF	8. SAFETY MANAGER
4. ASSOC. DIRECTOR	9. GENERAL ENGINEER
5. SERVICE LINE MGRS.	10. COR

Drawing Title
THIRD FLOOR PLAN - DEMOLITION

CONSTRUCTION DOCUMENTS

FULLY SPRINKLERED

Project Title		
RENOVATE BUILDING 8 FOR ENVIRONMENT AND CONDITION DEFICIENCIES		
Drawn	Building Number	AutoCAD File Name
GG	8	
Checked	Reviewed	Const. Contract No.

Date
OCTOBER 26, 2015

Project Number
621-14-135

DRAWING No.
AD103

DWG **26** of **208**



GENERAL SHEET NOTES

- A. CONTRACTOR TO PROTECT ALL BUILDING OPENINGS FROM INTRUSION AND WEATHER AS DOORS, WINDOWS, LOUVERS AND VENTS ARE REMOVED.
- B. COPPER GUTTERS, LEADERS AND DOWNSPOUTS ARE TO BE REMOVED, CLEANED, REPAIRED AND REINSTALLED IN ORIGINAL LOCATIONS.

SHEET KEYNOTES


- 1. EXISTING STAIRS TO REMAIN
- 2. SOFFIT ENCLOSURE AND WOOD TRIM TO BE REMOVED
- 3. ROOF BRACKETS TO BE REMOVED
- 4. WINDOW AND SCREEN TO BE REMOVED
- 5. BRICK INFILL TO REMAIN
- 6. BRICK INFILL, DOOR, FRAME AND THRESHOLD TO BE REMOVED
- 7. METAL ROOF TO REMAIN
- 8. DOOR, THRESHOLD AND FRAME TO BE REMOVED
- 9. LOUVER TO BE REMOVED
- 10. VENT TO BE REMOVED
- 11. RAMP AND CANOPY TO BE REMOVED
- 12. LOADING DOCK CANOPY TO REMAIN
- 13. SLATE SHINGLES TO REMAIN
- 14. EXISTING GUTTERS AND DOWNSPOUTS - SEE GENERAL NOTE B.
- 15. TUNNEL TO REMAIN
- 16. LOADING DOCK TO REMAIN
- 17. BRICK INFILL TO BE REMOVED
- 18. WINDOWS AND SCREEN TO REMAIN
- 19. REMOVE WINDOW A/C UNIT
- 20. REMOVE PORTION OF BRICK INFILL FOR NEW LOUVER
- 21. EXISTING CANOPY TO REMAIN

SYMBOLS LEGEND

-  REMOVE
-  REMOVE



SOUTH ELEVATION - DEMOLITION
 (C3) SCALE: 3/32" = 1'-0" 0 5' 10' 20'

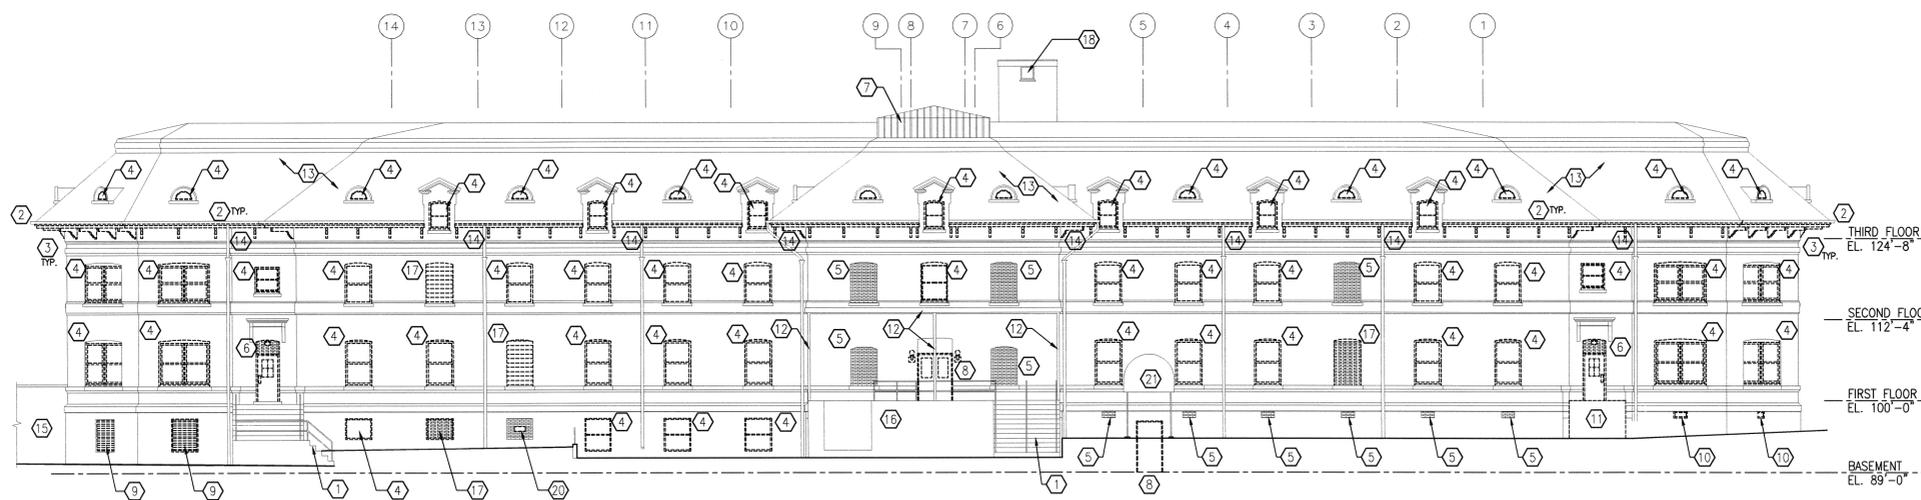

NORTH ELEVATION - DEMOLITION
 (F3) SCALE: 3/32" = 1'-0" 0 5' 10' 20'

REVISION NO.	REVISION DESCRIPTION	By	Date



Department of Veterans Affairs
 James H Quillen
 VA Medical Center
 Dogwood Ave.
 Mountain Home, TN 37684



Architect/Engineer Address
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 HDG PROJECT # 14009

Recommended Approvals:	
1. MEDICAL DIRECTOR	6. OPERATIONS SERVICE LINE MANAGER
2. ASSOCIATE DIRECTOR	7. INFECTION CONTROL MANAGER
3. CHIEF OF STAFF	8. SAFETY MANAGER
4. ASSOC. DIRECTOR	9. GENERAL ENGINEER
5. SERVICE LINE MGRS.	10. COR

Drawing Title
EXTERIOR ELEVATIONS - DEMOLITION
 CONSTRUCTION DOCUMENTS
 FULLY SPRINKLERED


Project Title
RENOVATE BUILDING 8 FOR ENVIRONMENT AND CONDITION DEFICIENCIES
 Drawn GG Building Number 8 AutoCAD File Name
 Checked Reviewed Const. Contract No.

Date
 OCTOBER 26, 2015
 Project Number
 621-14-135
 DRAWING No.
AD105
 DWG 20 of 205



GENERAL SHEET NOTES

- A. AN ASBESTOS INSPECTION WAS PERFORMED BY EFI GLOBAL, INC. DATED JANUARY 2010. ASBESTOS-CONTAINING MATERIALS WERE GENERALLY FOUND IN THE AREAS INDICATED. THE ASBESTOS SURVEY/INSPECTION REPORT IS AVAILABLE TO THE CONTRACTOR(S) FOR THEIR INFORMATION. THE ASBESTOS-CONTAINING MATERIALS (ACM) SHALL BE REMOVED PRIOR TO ANY OTHER WORK BEING PERFORMED IN THE AREAS.
- B. IF AT ANY TIME A MATERIAL IS ENCOUNTERED THAT IS SUSPECTED OF BEING A HAZARDOUS SUBSTANCE THAT HAS NOT BEEN PREVIOUSLY IDENTIFIED, STOP WORK IMMEDIATELY AND NOTIFY THE COR FOR FURTHER INSTRUCTIONS.
- C. LOCATIONS OF ACM SHOWN ON THIS DRAWING ARE APPROXIMATE. USE THESE DRAWINGS IN CONJUNCTION WITH THE ASBESTOS SURVEY REPORT. CONTRACTOR SHALL VERIFY ALL FIELD CONDITIONS PRIOR TO BEGINNING WORK.

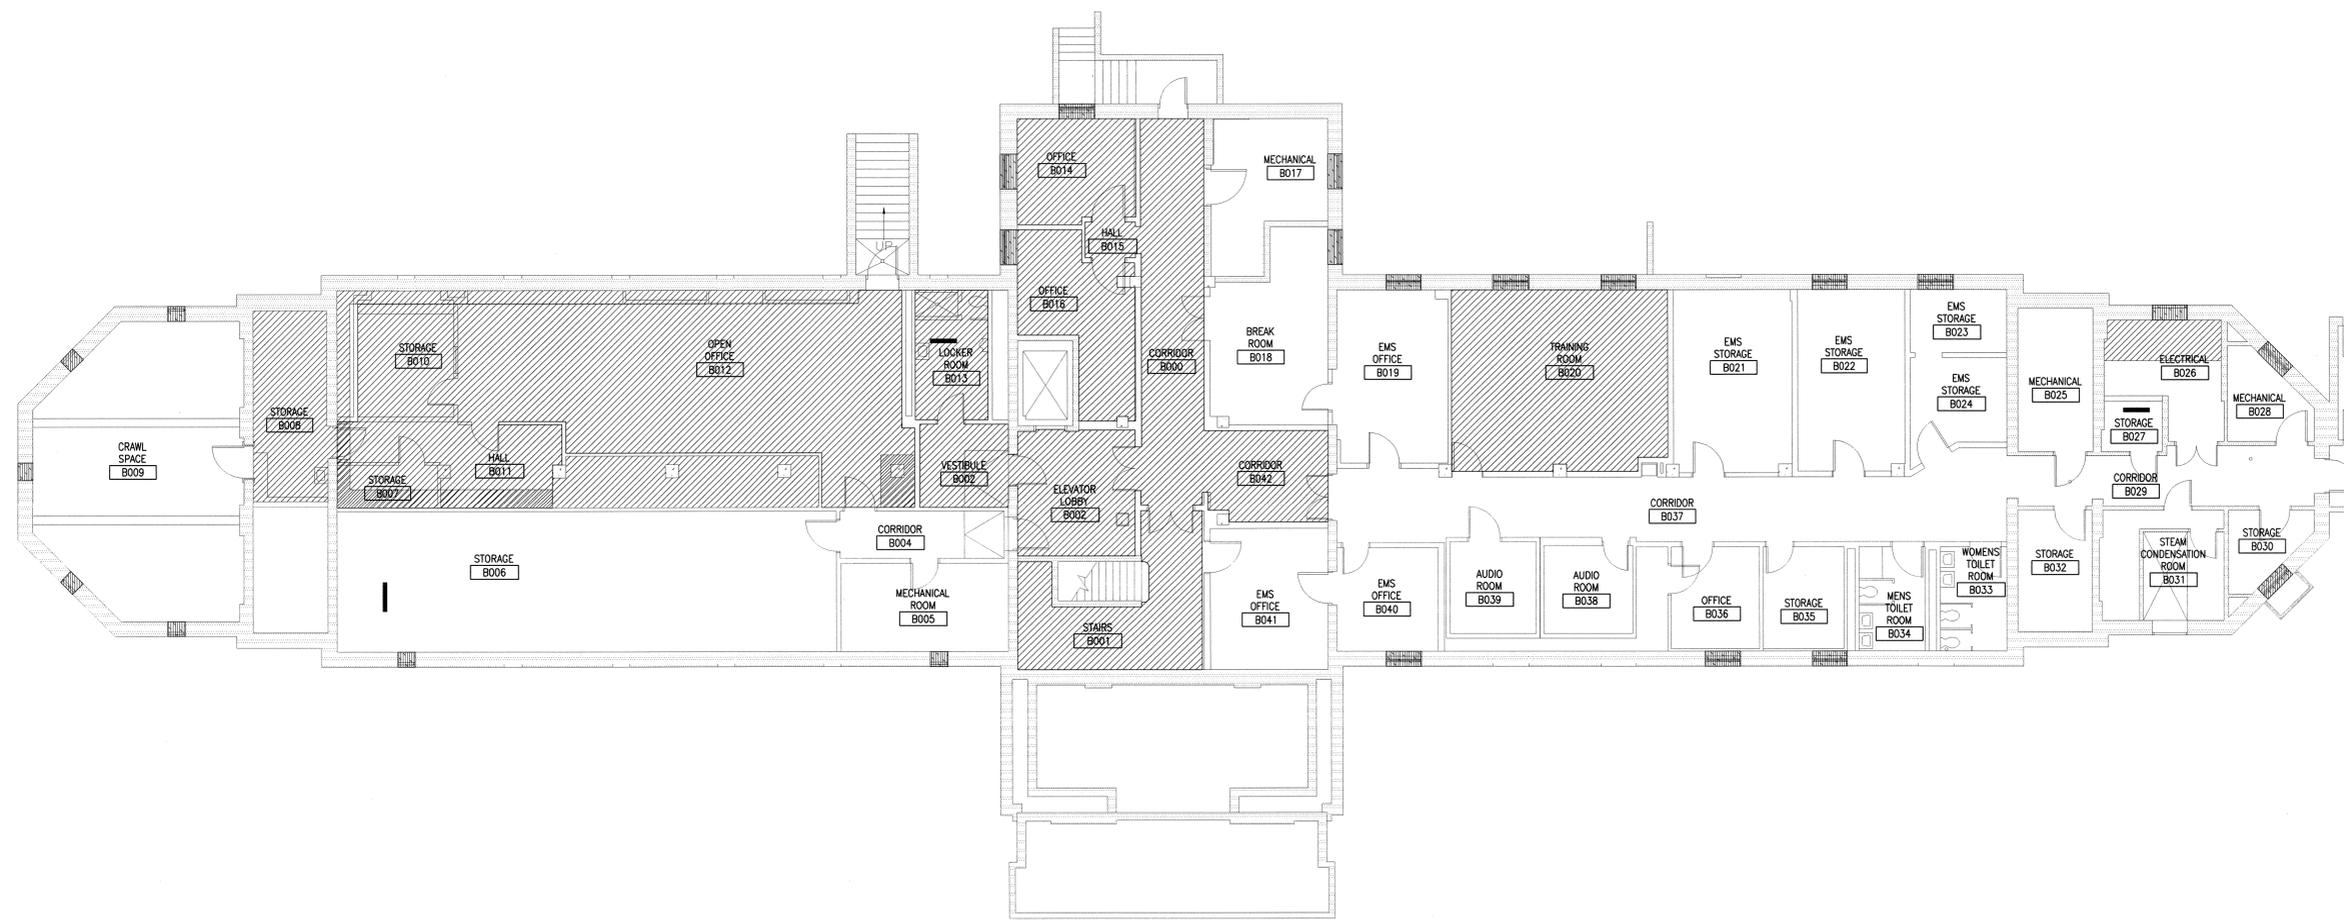

E1 BASEMENT FLOOR PLAN
ASBESTOS ABATEMENT
 SCALE: 1/8" = 1'-0"

SYMBOLS LEGEND

- FLOORING
 - PIPE INSULATION
 - EXTERIOR WINDOW SEALANT
- ASBESTOS CONTAINING MATERIALS (ACM)**
- 7 FIRE DOORS
 - 2 ELEVATOR DOORS
 - 3250 SF FLOORING
 - 50 LF PIPE INSULATION - WHITE, HOMOGENEOUS, AMOSITE
 - 80 LF EXTERIOR WINDOW SEALANT - CREAM, HOMOGENEOUS, CHRYSOTILE



three inches = one foot
 one and one half inches = one foot
 one inch = one foot
 three quarters inch = one foot
 one half inch = one foot
 three eighths inch = one foot
 one quarter inch = one foot
 one eighth inch = one foot

REVISION NO.	REVISION DESCRIPTION	By	Date

Department of Veterans Affairs
James H Quillen
VA Medical Center
Dogwood Ave.
Mountain Home, TN 37684

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 www.harrellgroup.com
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 HDG PROJECT # 14009

Recommended Approvals:	
1. MEDICAL DIRECTOR	6. OPERATIONS SERVICE LINE MANAGER
2. ASSOCIATE DIRECTOR	7. INFECTION CONTROL MANAGER
3. CHIEF OF STAFF	8. SAFETY MANAGER
4. ASSOC. DIRECTOR	9. GENERAL ENGINEER
5. SERVICE LINE MGRS.	10. COR

Drawing Title
BASEMENT FLOOR PLAN - ASBESTOS ABATEMENT
CONSTRUCTION DOCUMENTS
FULLY SPRINKLERED

Project Title
RENOVATE BUILDING 8 FOR ENVIRONMENT AND CONDITION DEFICIENCIES
Drawn MW
Building Number 8
Checked
Reviewed
Const. Contract No.

Date OCTOBER 26, 2015
Project Number 621-14-135
DRAWING No. AD110
DWG 21 of 208



GENERAL SHEET NOTES


- A. A LEAD-BASED PAINT SURVEY WAS PERFORMED BY E. ROBERTS ALLEY & ASSOCIATES, INC. DATED DECEMBER 2005. LEAD-BASED PAINT (LBP) WAS GENERALLY FOUND IN THE AREAS INDICATED. THE LEAD-BASED PAINT SURVEY IS AVAILABLE TO THE CONTRACTOR(S) FOR THEIR INFORMATION. LEAD-BASED PAINT SHALL BE REMOVED PRIOR TO ANY OTHER WORK BEING PERFORMED IN THE AREAS.
- B. IF AT ANY TIME A MATERIAL IS ENCOUNTERED THAT IS SUSPECTED OF BEING LEAD-BASED PAINT THAT HAS NOT BEEN PREVIOUSLY IDENTIFIED, STOP WORK IMMEDIATELY AND NOTIFY THE COR FOR FURTHER INSTRUCTIONS.
- C. LOCATIONS OF LEAD-BASED PAINT SHOWN ON THIS DRAWING ARE APPROXIMATE. USE THESE DRAWINGS IN CONJUNCTION WITH THE LEAD-BASED PAINT SURVEY. CONTRACTOR SHALL VERIFY ALL FIELD CONDITIONS PRIOR TO BEGINNING WORK.

SHEET KEYNOTES #

- 1. DOOR WITH LBP
- 2. DOOR CASING WITH LBP
- 3. CHAIR RAIL WITH LBP
- 4. EXTERIOR VENTS WITH LBP
- 5. CONCRETE CEILING WITH LBP

SYMBOLS LEGEND

- LEAD-BASED PAINT ON WALLS
- ▨ LEAD-BASED PAINT ON STAIR STRINGERS, RISERS, POSTS AND BALUSTERS

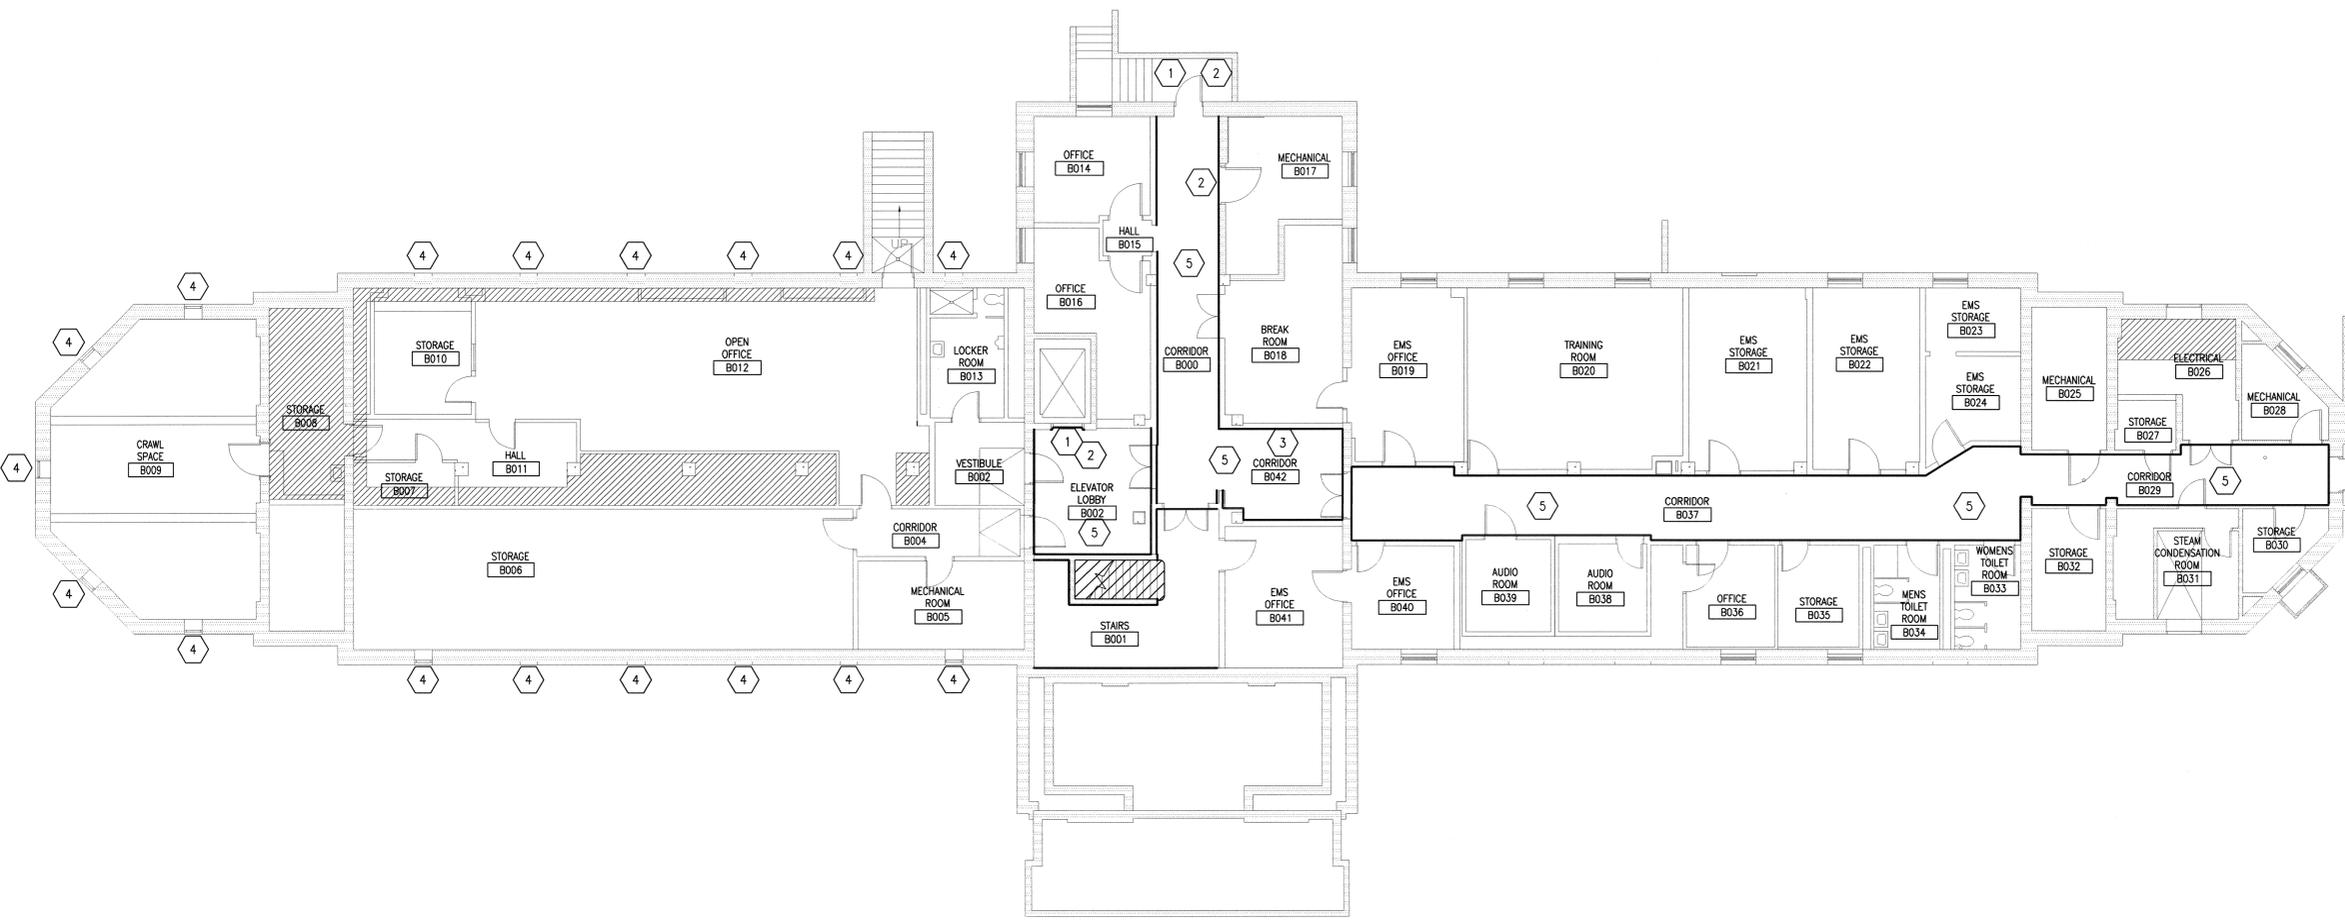

**BASEMENT PLAN
LEAD-BASED PAINT ABATEMENT**
SCALE: 1/8" = 1'-0"
E1

REVISION NO.	REVISION DESCRIPTION	By	Date

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Recommended Approvals:	
1. MEDICAL DIRECTOR	6. OPERATIONS SERVICE LINE MANAGER
2. ASSOCIATE DIRECTOR	7. INFECTION CONTROL MANAGER
3. CHIEF OF STAFF	8. SAFETY MANAGER
4. ASSOC. DIRECTOR	9. GENERAL ENGINEER
5. SERVICE LINE MGRS.	10. COR

Drawing Title BASEMENT PLAN - LEAD-BASED PAINT ABATEMENT		Project Title RENOVATE BUILDING 8 FOR ENVIRONMENT AND CONDITION DEFICIENCIES		Date OCTOBER 26, 2015
CONSTRUCTION DOCUMENTS		Building Number 8	AutoCAD File Name	Project Number 621-14-135
FULLY SPRINKLERED		Checked	Reviewed	DRAWING No. AD111
		Const. Contract No.		DWG 30 of 208

