


three inches = one foot  
 one and one-half inches = one foot  
 one inch = one foot  
 three-quarters inch = one foot  
 one-half inch = one foot  
 three-eighths inch = one foot  
 one-quarter inch = one foot  
 one-eighth inch = one foot

**GENERAL NOTES**

- A. FIELD VERIFY ALL DIMENSIONS.
- B. COORDINATE ALL WORK AND PROJECT SCHEDULING WITH VA SAFETY, INFECTION CONTROL AND POLICE DEPARTMENTS.
- C. PROJECT CONSISTS OF FACILITY WIDE PNEUMATIC TUBE SYSTEM (PTS) INSTALLATION TO THE VA SAN ANTONIO AUDIE L. MURPHY VA HOSPITAL. AFFECTED BUILDINGS ARE AS FOLLOWS:  
 BUILDING CC, HOSPITAL & ADMINISTRATION, SEVEN FLOORS  
 BUILDING CLC, COMMUNITY LIVING CENTER, TWO FLOORS  
 BUILDING PRC, POLYTRAUMA REHABILITATION CENTER, THREE FLOORS
- D. PROJECT SCOPE OF WORK (SOW) INCLUDES INSTALLATION OF A NEW PNEUMATIC TUBE SYSTEM THROUGHOUT THE HOSPITAL FACILITY. SCOPE SHALL INCLUDE THE FOLLOWING:  
 1. INSTALLATION OF NEW GALVANIZED STEEL PNEUMATIC TUBING SUSPENDED FROM EXISTING STRUCTURE WITHIN INTERSTITIAL SPACES.  
 2. INSTALLATION OF PNEUMATIC BLOWER UNITS.  
 3. INSTALLATION OF PNEUMATIC TRANSFER UNITS.  
 4. INSTALLATION OF PNEUMATIC TERMINAL UNITS.  
 5. INSTALLATION OF PNEUMATIC ACCESSORIES SUCH AS CARRIER STORAGE UNITS AND ARRIVAL INDICATORS.  
 6. ELECTRICAL UPGRADES TO ACCOMMODATE NEW EQUIPMENT.  
 7. SELECT DEMOLITION.  
 8. NEW FRAMING AND PARTITIONS FOR TERMINAL UNITS.  
 9. NEW ARCHITECTURAL FINISHES.
- E. THE INTERSTITIAL EQUIPMENT CONFIGURATION LAYOUT IS FOR REFERENCE PURPOSES ONLY. SPECIFIC PLACEMENT OF PNEUMATIC PIPING, TRANSFER UNITS, BLOWERS, VALVES HANGERS AND ASSOCIATED EQUIPMENT IS DEPENDANT UPON SPECIFIC MANUFACTURER'S REQUIREMENTS. COORDINATE EQUIPMENT PLACEMENT AND PNEUMATIC PIPING LAYOUT WITH SELECTED PNEUMATIC EQUIPMENT MANUFACTURER.


NOTE: INTERSTITIAL PLANS ARE SHOWN FOR GENERAL REFERENCE PURPOSES FOR PNEUMATIC TUBE SYSTEM PIPING CONFIGURATION WITHIN BUILDING CC. FIELD VERIFY EXISTING CONDITIONS AND AVAILABLE SPACE FOR NEW EQUIPMENT. NEW PNEUMATIC PIPING SHALL NOT INTERFERE WITH EXISTING CAT-WALK AND ACCESS AREAS OR EXISTING EQUIPMENT AND DUCTWORK. NEW EQUIPMENT CONFIGURATION SHALL BE DESIGNED FOR EASE OF ACCESS TO EQUIPMENT PANELS, CONTROLS AND EASE OF MAINTENANCE.

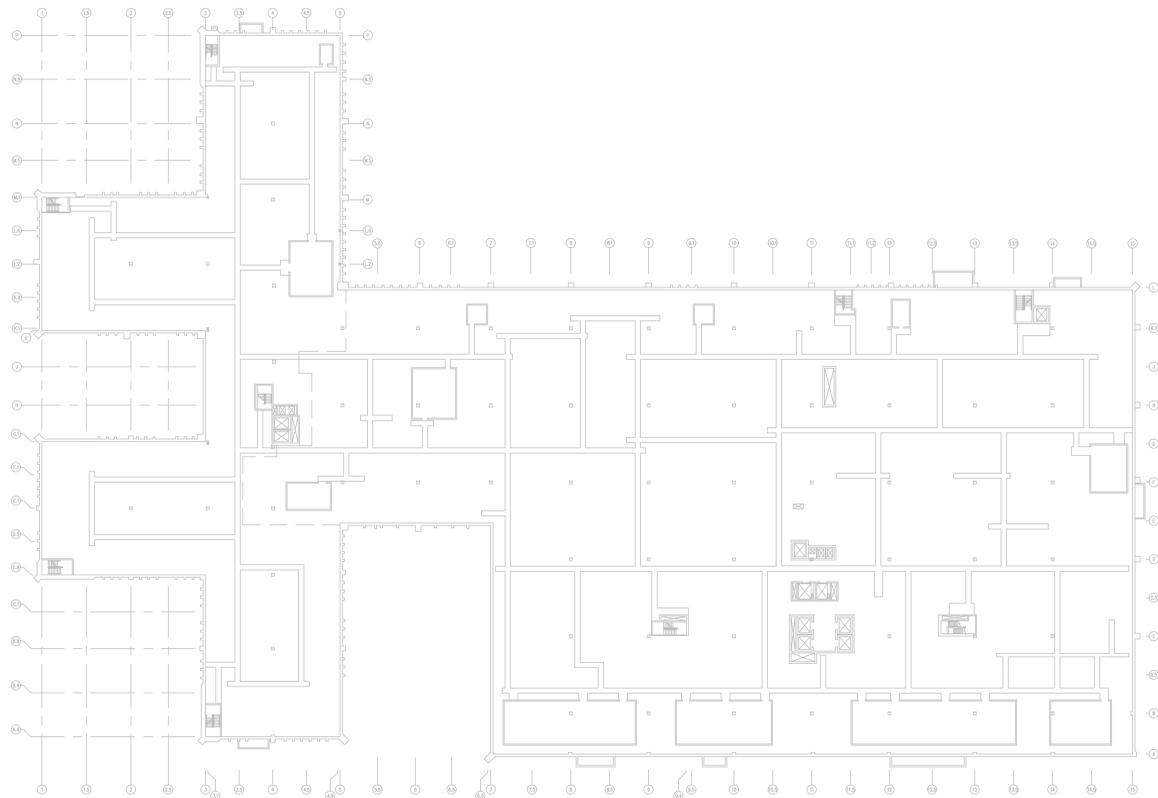


**F1** GROUND FLOOR INTERSTITIAL PLAN, BLDG. CC  
 SCALE: 1" = 40'-0"



**BUILDING KEY PLAN** SCALE: NONE

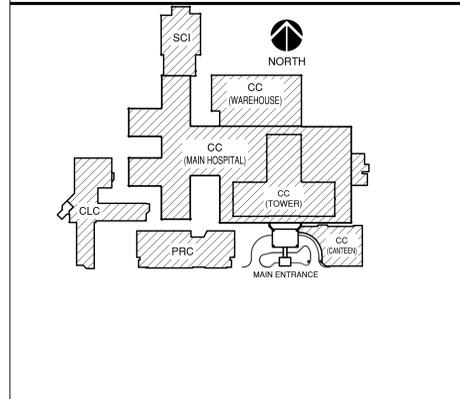

**BUILDING FLOOR ELEVATION DIAGRAM** SCALE: NONE

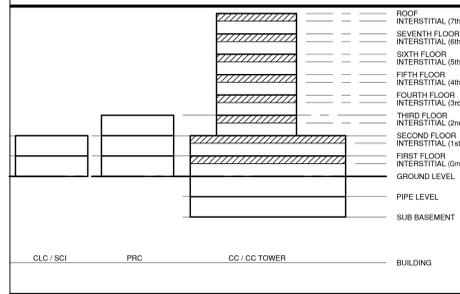

**BUILDING LEGEND**

- BUILDING CC: MAIN HOSPITAL
- BUILDING PRC: POLYTRAUMA REHABILITATION CENTER
- BUILDING CLC: COMMUNITY LIVING CENTER
- BUILDING SCI: SPINAL CORD INJURY

**100% CONSTRUCTION ISSUE**

Revisions Date		 2201 N. Colony, Suite 205 Arlington, Texas 76010-2055 (817) 461-5337 Fax: (817) 461-1103 MECHANICAL • ELECTRICAL • PLUMBING FEI Project No.: 13069	 Architecture • Planning • Interior Design 4949 Addison Circle • Addison, Texas 75001 MPI Project No.: 8130707			Drawing Title <b>BUILDING CC          GROUND FLOOR          INTERSTITIAL PLAN</b>	Project Title <b>AUDIE L. MURPHY VA HOSPITAL          PNEUMATIC TUBE SYSTEM          UPGRADE</b>	Date 4/24/15	Project No. 671-13-104	Drawing No. <b>A109</b>	Dwg. of	 STVHCS San Antonio, Texas
Approved: Area Project Manager						Building Number <b>CC</b>	Checked <b>DJD</b>	Drawn <b>AR/DC</b>	Location <b>7400 Merton Minter          San Antonio, TX 78229</b>			