




three inches = one foot
one and one-half inches=one foot
one inch=one foot
three-quarters inch = one foot
one-half inch = one foot
three-eighths inch = one foot
one-quarter inch = one foot
one-eighth inch = one foot

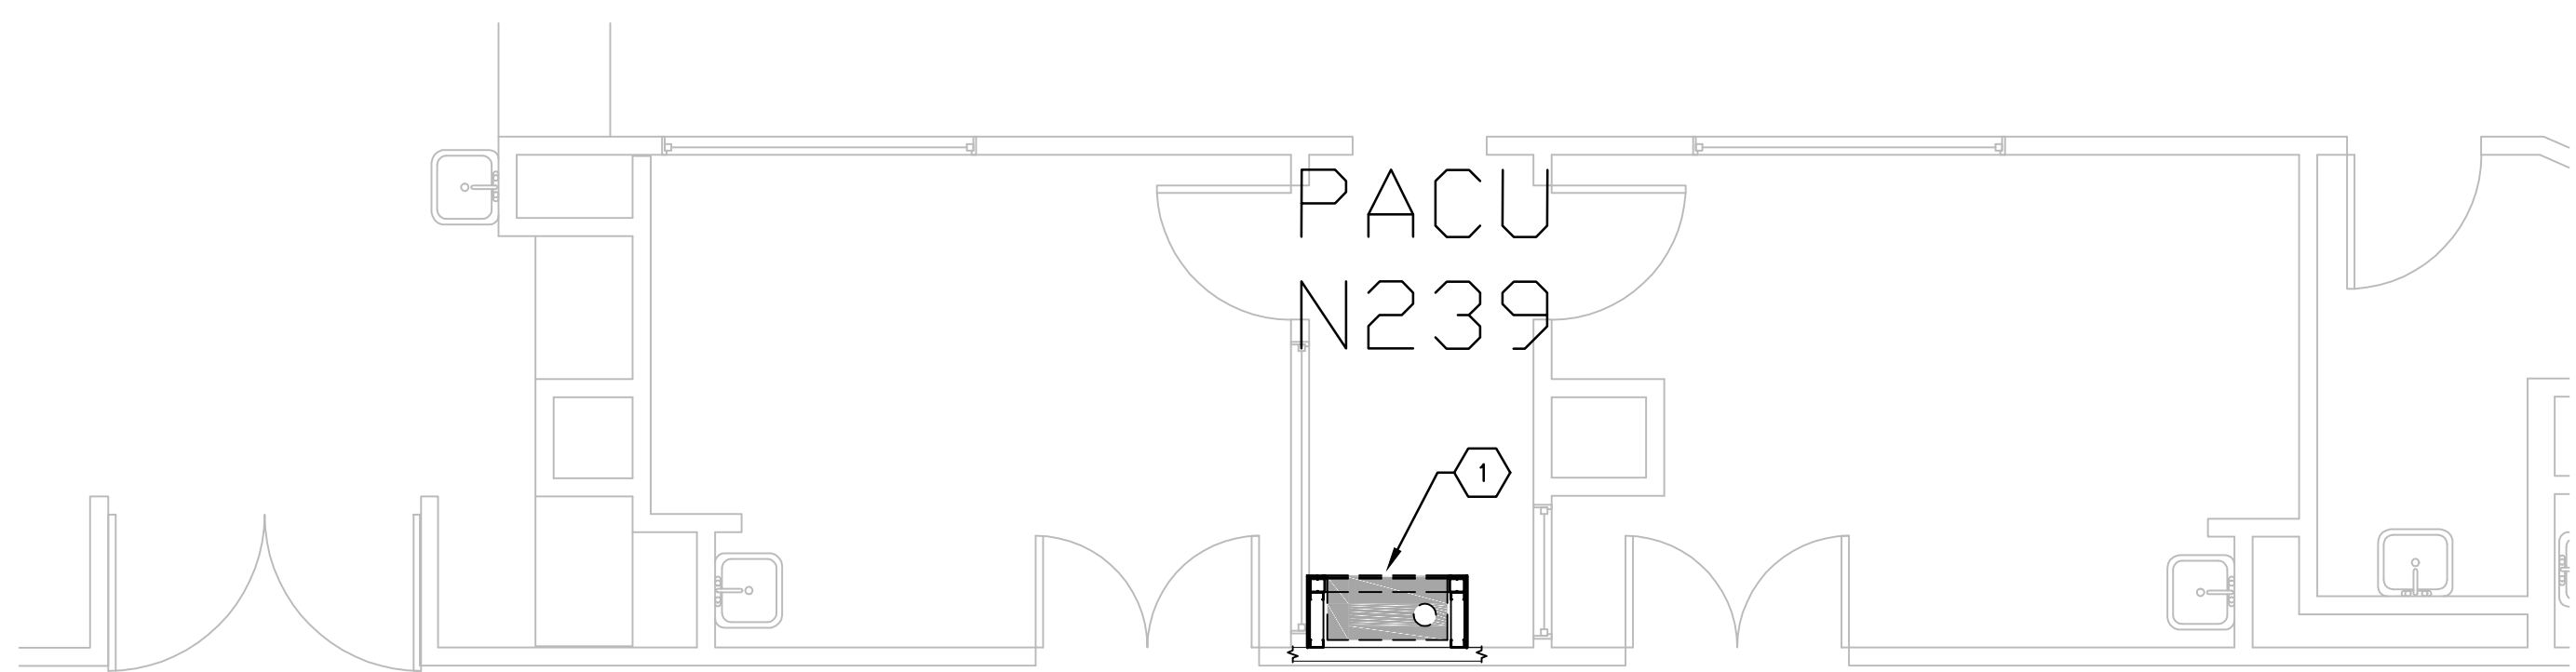


B1 SECOND FLOOR PLAN, BLDG. CC; PACU N239
SCALE: 1/4" = 1'-0"
(STATION 17)

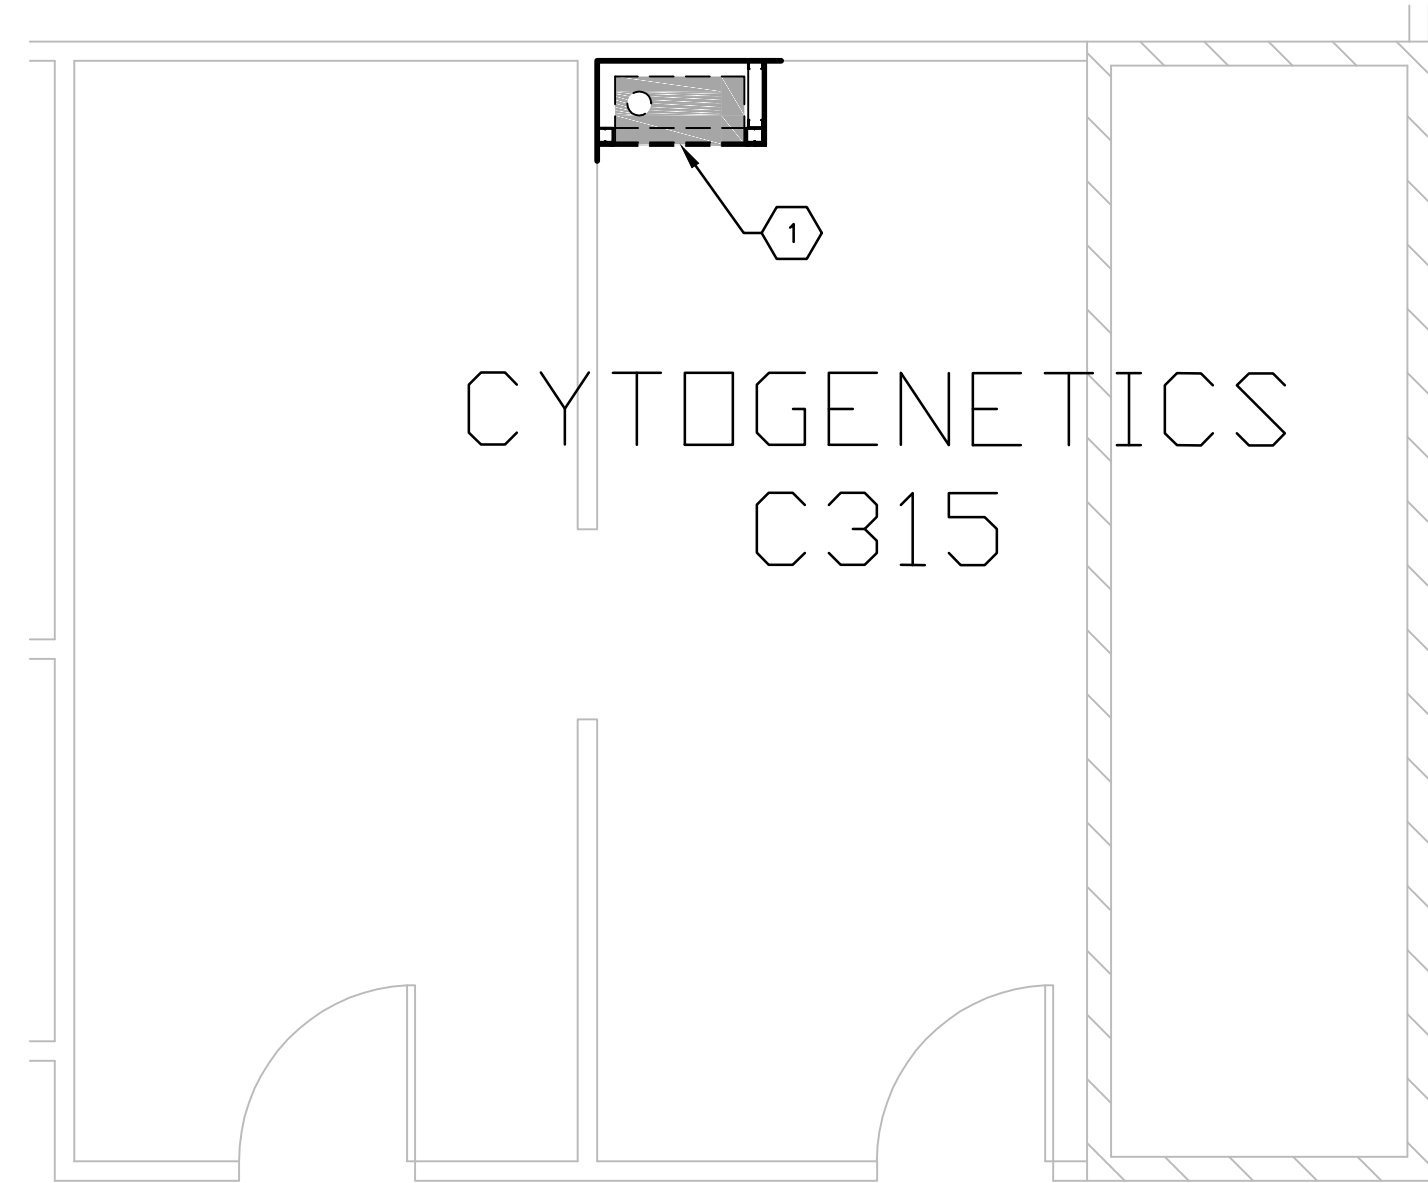



D1 THIRD FLOOR PLAN, BLDG. CC; CYTOGENETICS C315
SCALE: 1/4" = 1'-0"
(STATION 22)

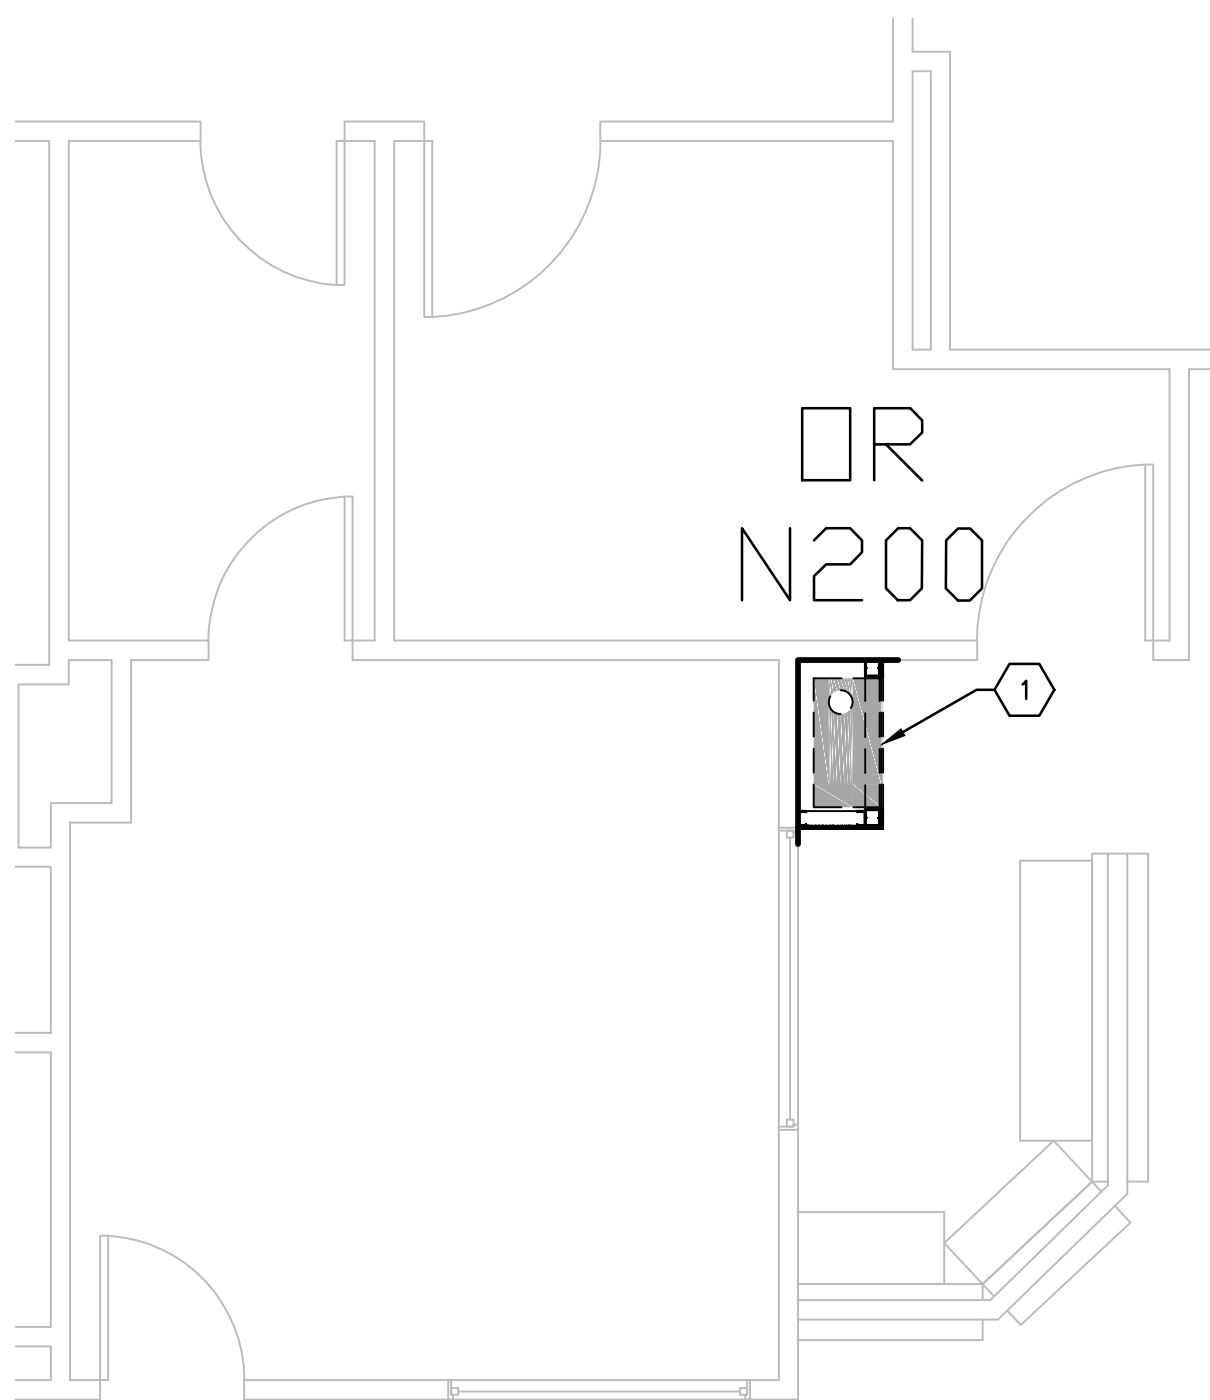


F1 SECOND FLOOR PLAN, BLDG. CC; O.R. RECEPTION N204
SCALE: 1/4" = 1'-0"
(STATION 16)

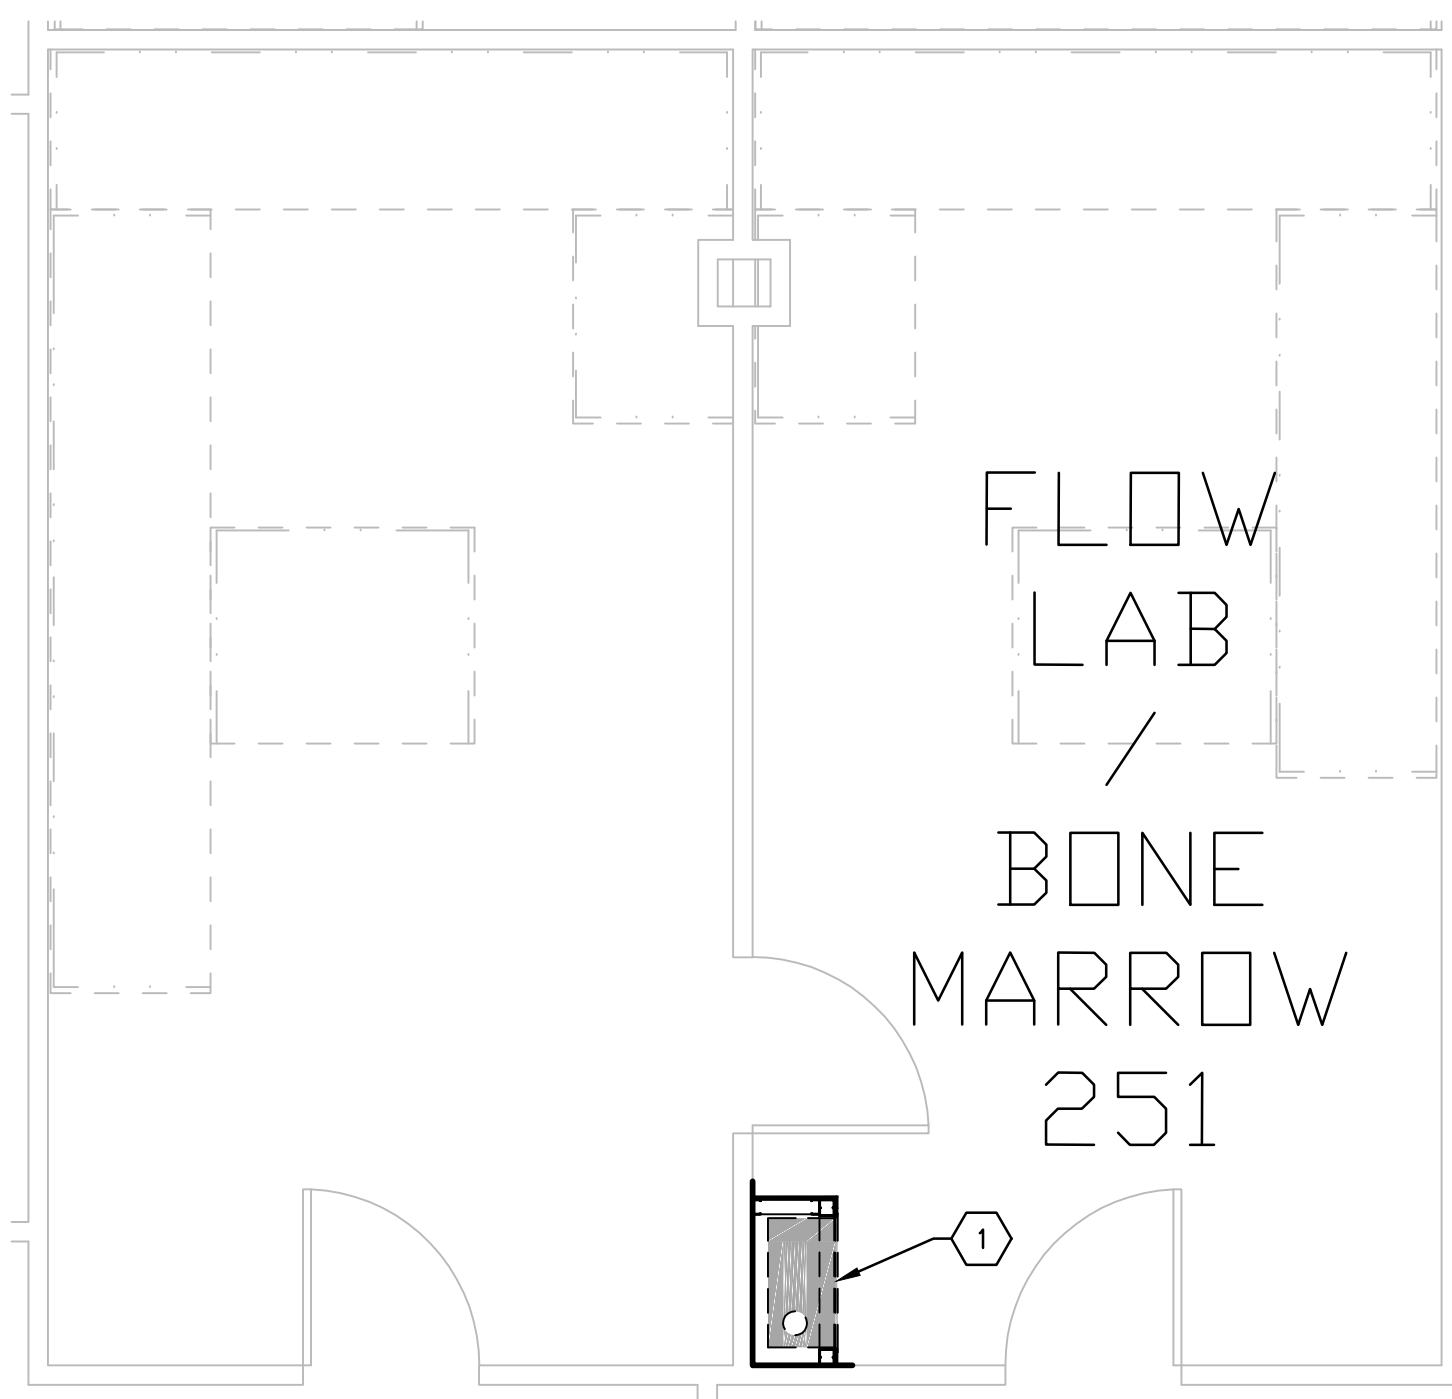


F4 SECOND FLOOR PLAN, BLDG. CC; BONE MARROW LAB 251
SCALE: 1/4" = 1'-0"
(STATION 13)

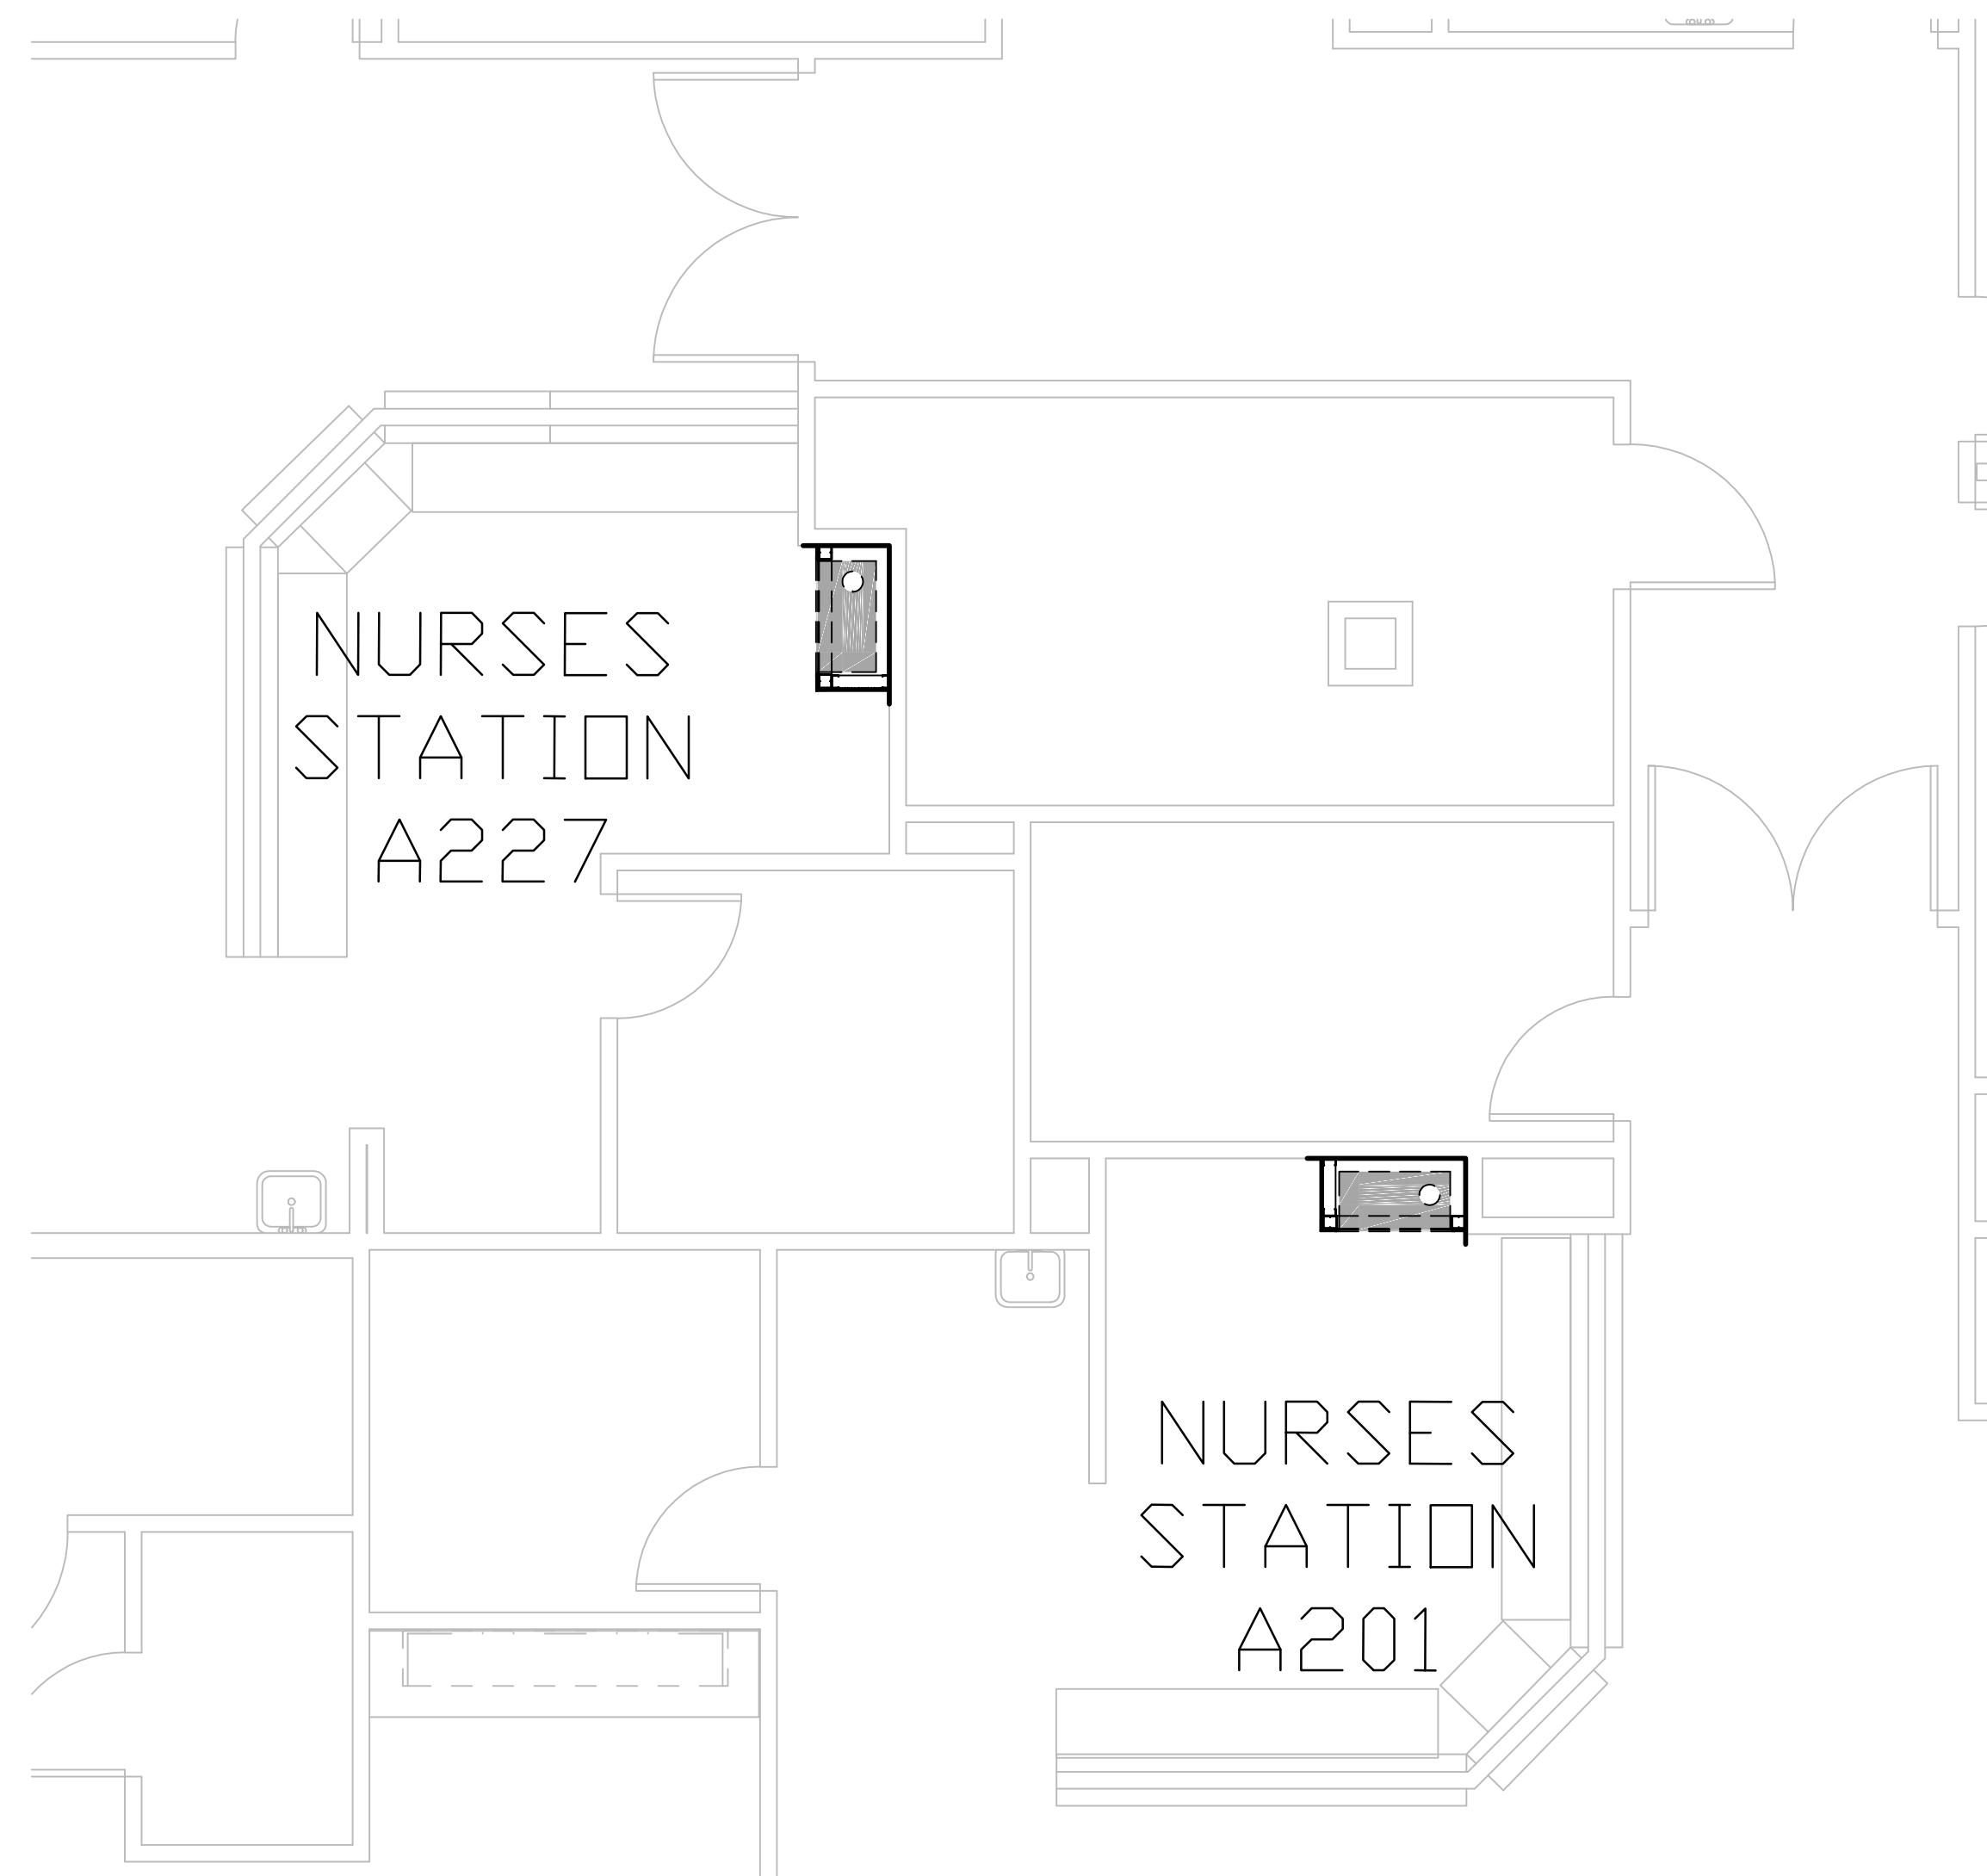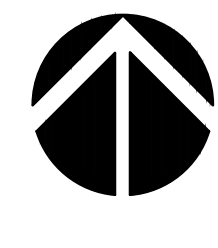

D6 SECOND FLOOR PLAN, BLDG. CC; 2 SURGERY INPATIENT UNIT
SCALE: 1/4" = 1'-0"
(STATION 36 & 37)

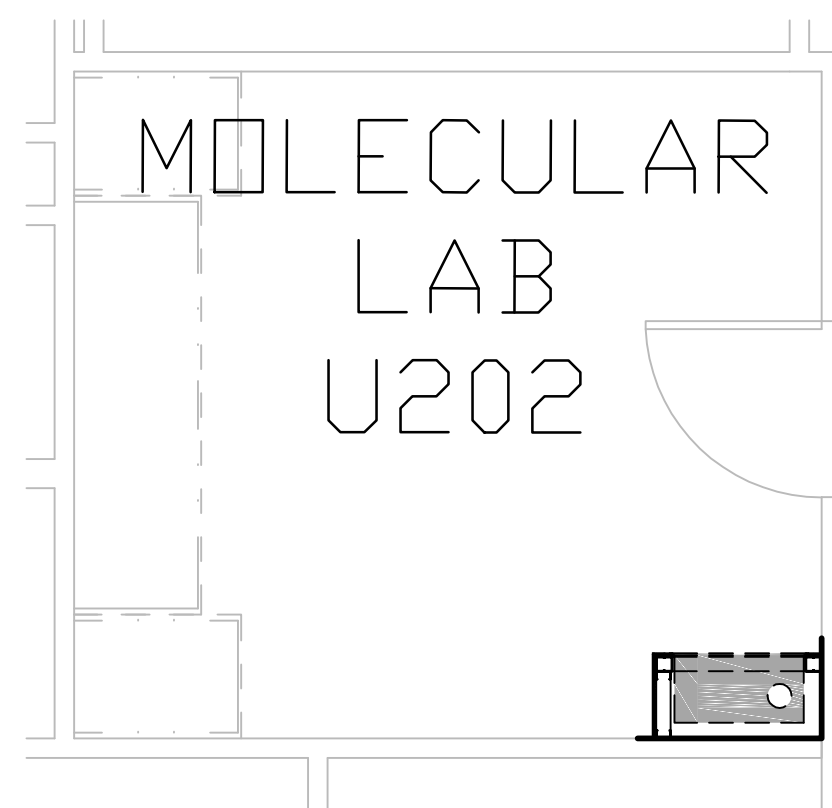

F7 SECOND FLOOR PLAN, BLDG. CC; MOLECULAR LAB U202
SCALE: 1/4" = 1'-0"
(STATION 14)

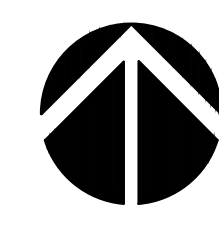




GENERAL NOTES

- FIELD VERIFY ALL DIMENSIONS AND AVAILABLE CLEARANCES.
- COORDINATE ALL WORK AND PROJECT SCHEDULING WITH VA SAFETY, INFECTION CONTROL AND POLICE DEPARTMENTS.
- PROJECT CONSISTS OF FACILITY WIDE PNEUMATIC TUBE SYSTEM (PTS) INSTALLATION TO THE VA SAN ANTONIO AUDIE L. MURPHY VA HOSPITAL. AFFECTED BUILDINGS ARE AS FOLLOWS:
BUILDING CC, HOSPITAL & ADMINISTRATION, SEVEN FLOORS
BUILDING CLC, COMMUNITY LIVING CENTER, TWO FLOORS
BUILDING PRG, POLYTRAUMA REHABILITATION CENTER, THREE FLOORS
- PROJECT SCOPE OF WORK (SOW) INCLUDES INSTALLATION OF A NEW PNEUMATIC TUBE SYSTEM THROUGHOUT THE HOSPITAL FACILITY. SCOPE SHALL INCLUDE THE FOLLOWING:
 - INSTALLATION OF NEW GALVANIZED STEEL PNEUMATIC TUBING SUSPENDED FROM EXISTING STRUCTURE WITHIN INTERSTITIAL SPACES.
 - INSTALLATION OF PNEUMATIC BLOWER UNITS.
 - INSTALLATION OF PNEUMATIC TRANSFER UNITS.
 - INSTALLATION OF PNEUMATIC TERMINAL UNITS.
 - INSTALLATION OF PNEUMATIC ACCESSORIES SUCH AS CARRIER STORAGE UNITS AND ARRIVAL INDICATORS.
 - ELECTRICAL UPGRADES TO ACCOMMODATE NEW EQUIPMENT.
 - SELECT DEMOLITION.
 - NEW FRAMING AND PARTITIONS FOR TERMINAL UNITS.
 - NEW ARCHITECTURAL FINISHES.
- PTS ENCLOSURES SHALL BE CONSTRUCTED AS FOLLOWS:
 - 3-5/8" X 20 GA GALVANIZED METAL STUDS AT 16" O.C. MAXIMUM.
 - REMOVE FLOOR FINISHES TO SLAB PRIOR TO INSTALLATION OF BOTTOM TRACK.
 - TOP TRACK SHALL EXTEND A MINIMUM OF 4" ABOVE FINISHED CEILING.
 - ONE LAYER TYPE X GYPSUM BOARD, EXTERIOR FACE.
 - PROTECT EXISTING ADJACENT FINISHES DURING CONSTRUCTION ACTIVITIES.
 - NEW FINISHES SHALL MATCH EXISTING ADJACENT FINISHES.
- ACTUAL ENCLOSURE DIMENSIONS WILL VARY SLIGHTLY DEPENDING ON PTS MANUFACTURER SELECTED. HOLD DIMENSIONS AS CLOSE AS POSSIBLE TO MINIMIZE DISTURBANCE OF EXISTING ADJACENT WORK AREAS, EQUIPMENT, MILLWORK AND CASEWORK.
- CONFIRM WITH SELECTED PTS MANUFACTURER OF RATED PARTITION / ENCLOSURE REQUIREMENTS.

KEY NOTES

- NEW SINGLE DROP PST STATION, FULLY ENCLOSED.

100% CONSTRUCTION ISSUE
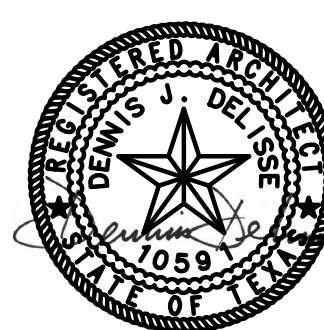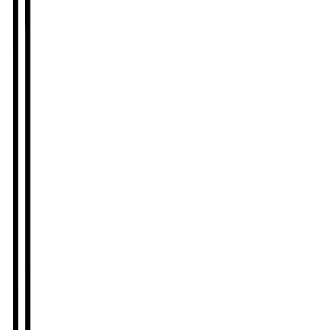
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|-----------|------|--|--|--|---|--|---|--|---|
| Revisions | Date |  2201 N Collins, Suite 295 Arlington, Texas 76011-2055 (817) 461-5337 Fax: (817) 461-1105 MECHANICAL • ELECTRICAL • PLUMBING FEI Project No.: 13069 |  Architecture • Planning • Interior Design 4949 Addison Circle • Addison, Texas 75001 MPI Project No.: 8130707 |  4/24/15 |  | Drawing Title BUILDING CC SECOND & THIRD FLOOR PLANS PTS STATION LOCATIONS Approved: Area Project Manager | Project Title AUDIE L. MURPHY VA HOSPITAL PNEUMATIC TUBE SYSTEM UPGRADE Building Number CC Location 7400 Merton Minter San Antonio, TX 78229 | Date 4/24/15 Project No. 671-13-104 Drawing No. A405 Dwg. of |  STVHCS San Antonio, Texas |
|-----------|------|--|--|--|---|--|---|--|---|