



three-eighths inch = one foot
one-half inch = one foot
three-quarters inch = one foot
one inch = one foot
one and one-half inches = one foot
two inches = one foot
two and one-half inches = one foot
three inches = one foot
three and one-half inches = one foot
four inches = one foot
four and one-half inches = one foot
five inches = one foot
five and one-half inches = one foot
six inches = one foot
six and one-half inches = one foot
seven inches = one foot
seven and one-half inches = one foot
eight inches = one foot
eight and one-half inches = one foot
nine inches = one foot
nine and one-half inches = one foot
ten inches = one foot
ten and one-half inches = one foot
eleven inches = one foot
eleven and one-half inches = one foot
twelve inches = one foot



C1 SEVENTH FLOOR PLAN, BLDG. CC; ONCOLOGY LAB / PHARMACY D707
SCALE: 1/4" = 1'-0"
(STATION 33)

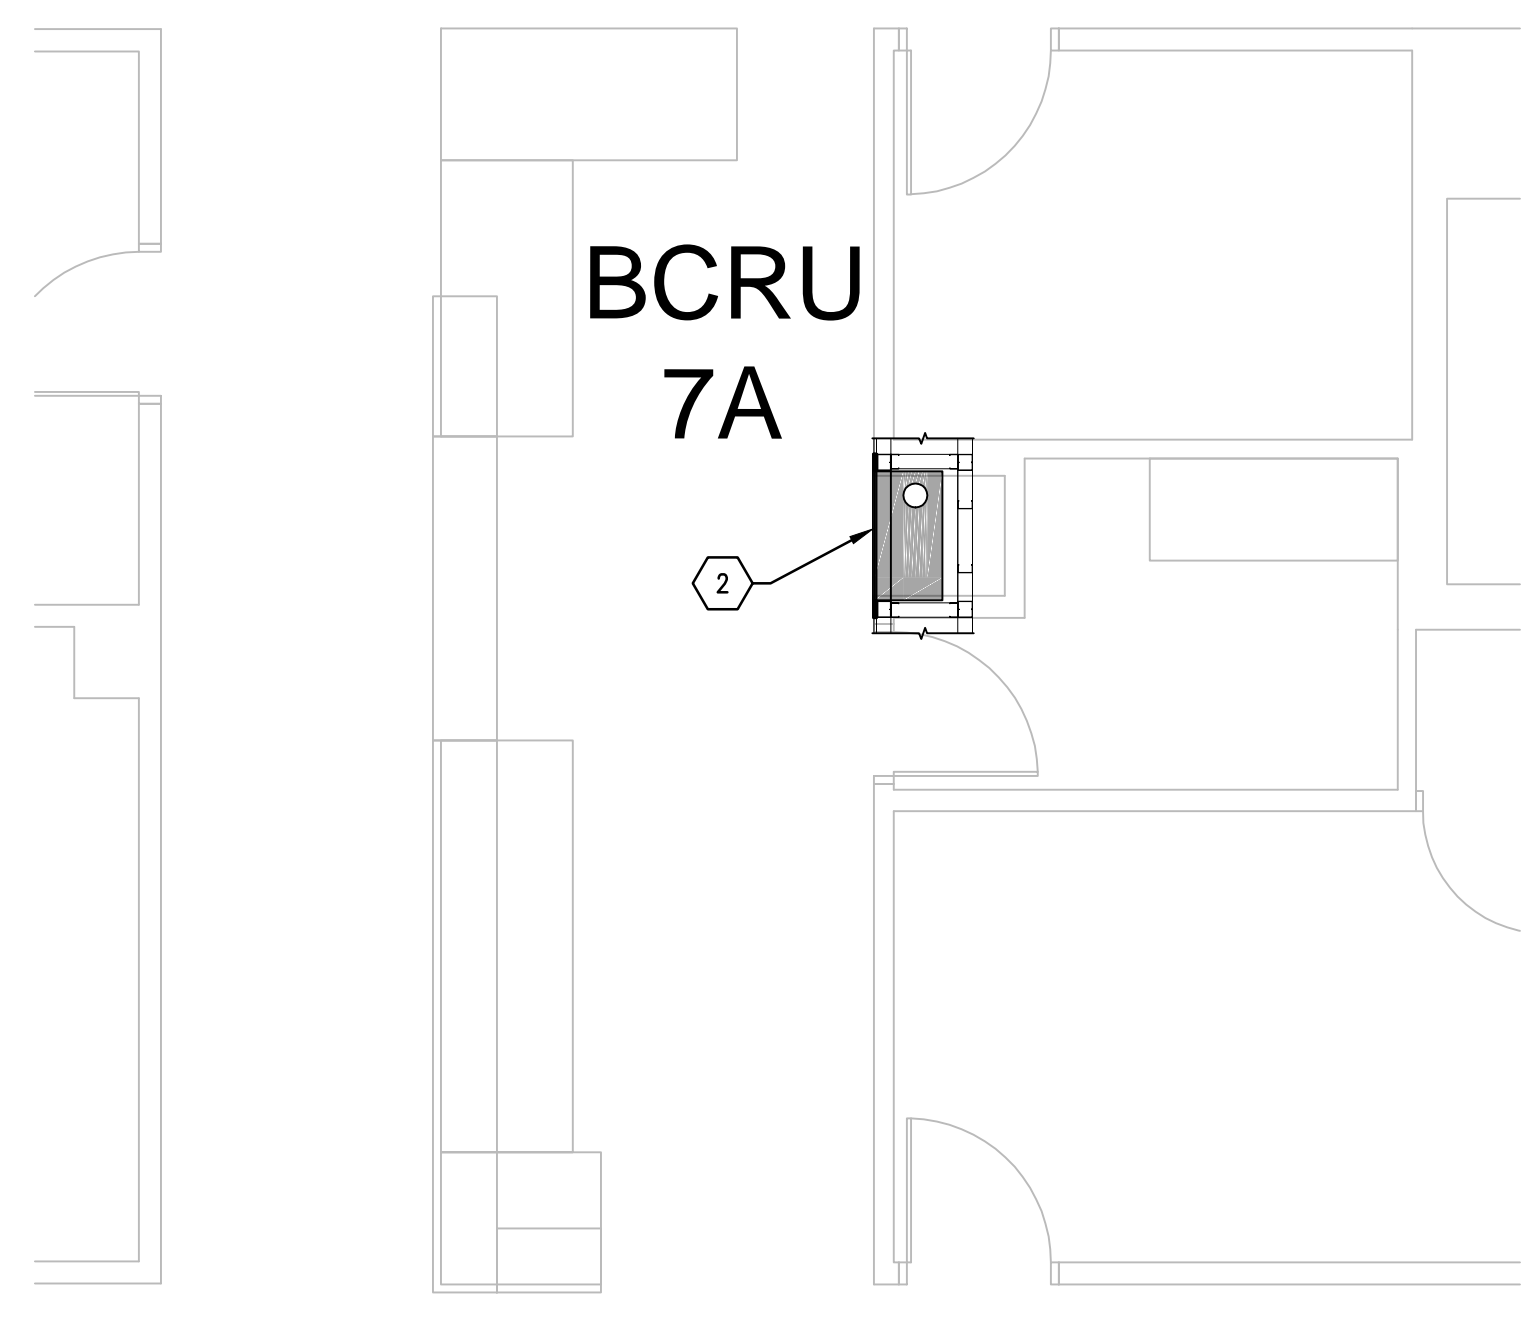

F1 SEVENTH FLOOR PLAN, BLDG. CC; BCRU NURSE STATION 7A
SCALE: 1/4" = 1'-0"
(STATION 34)

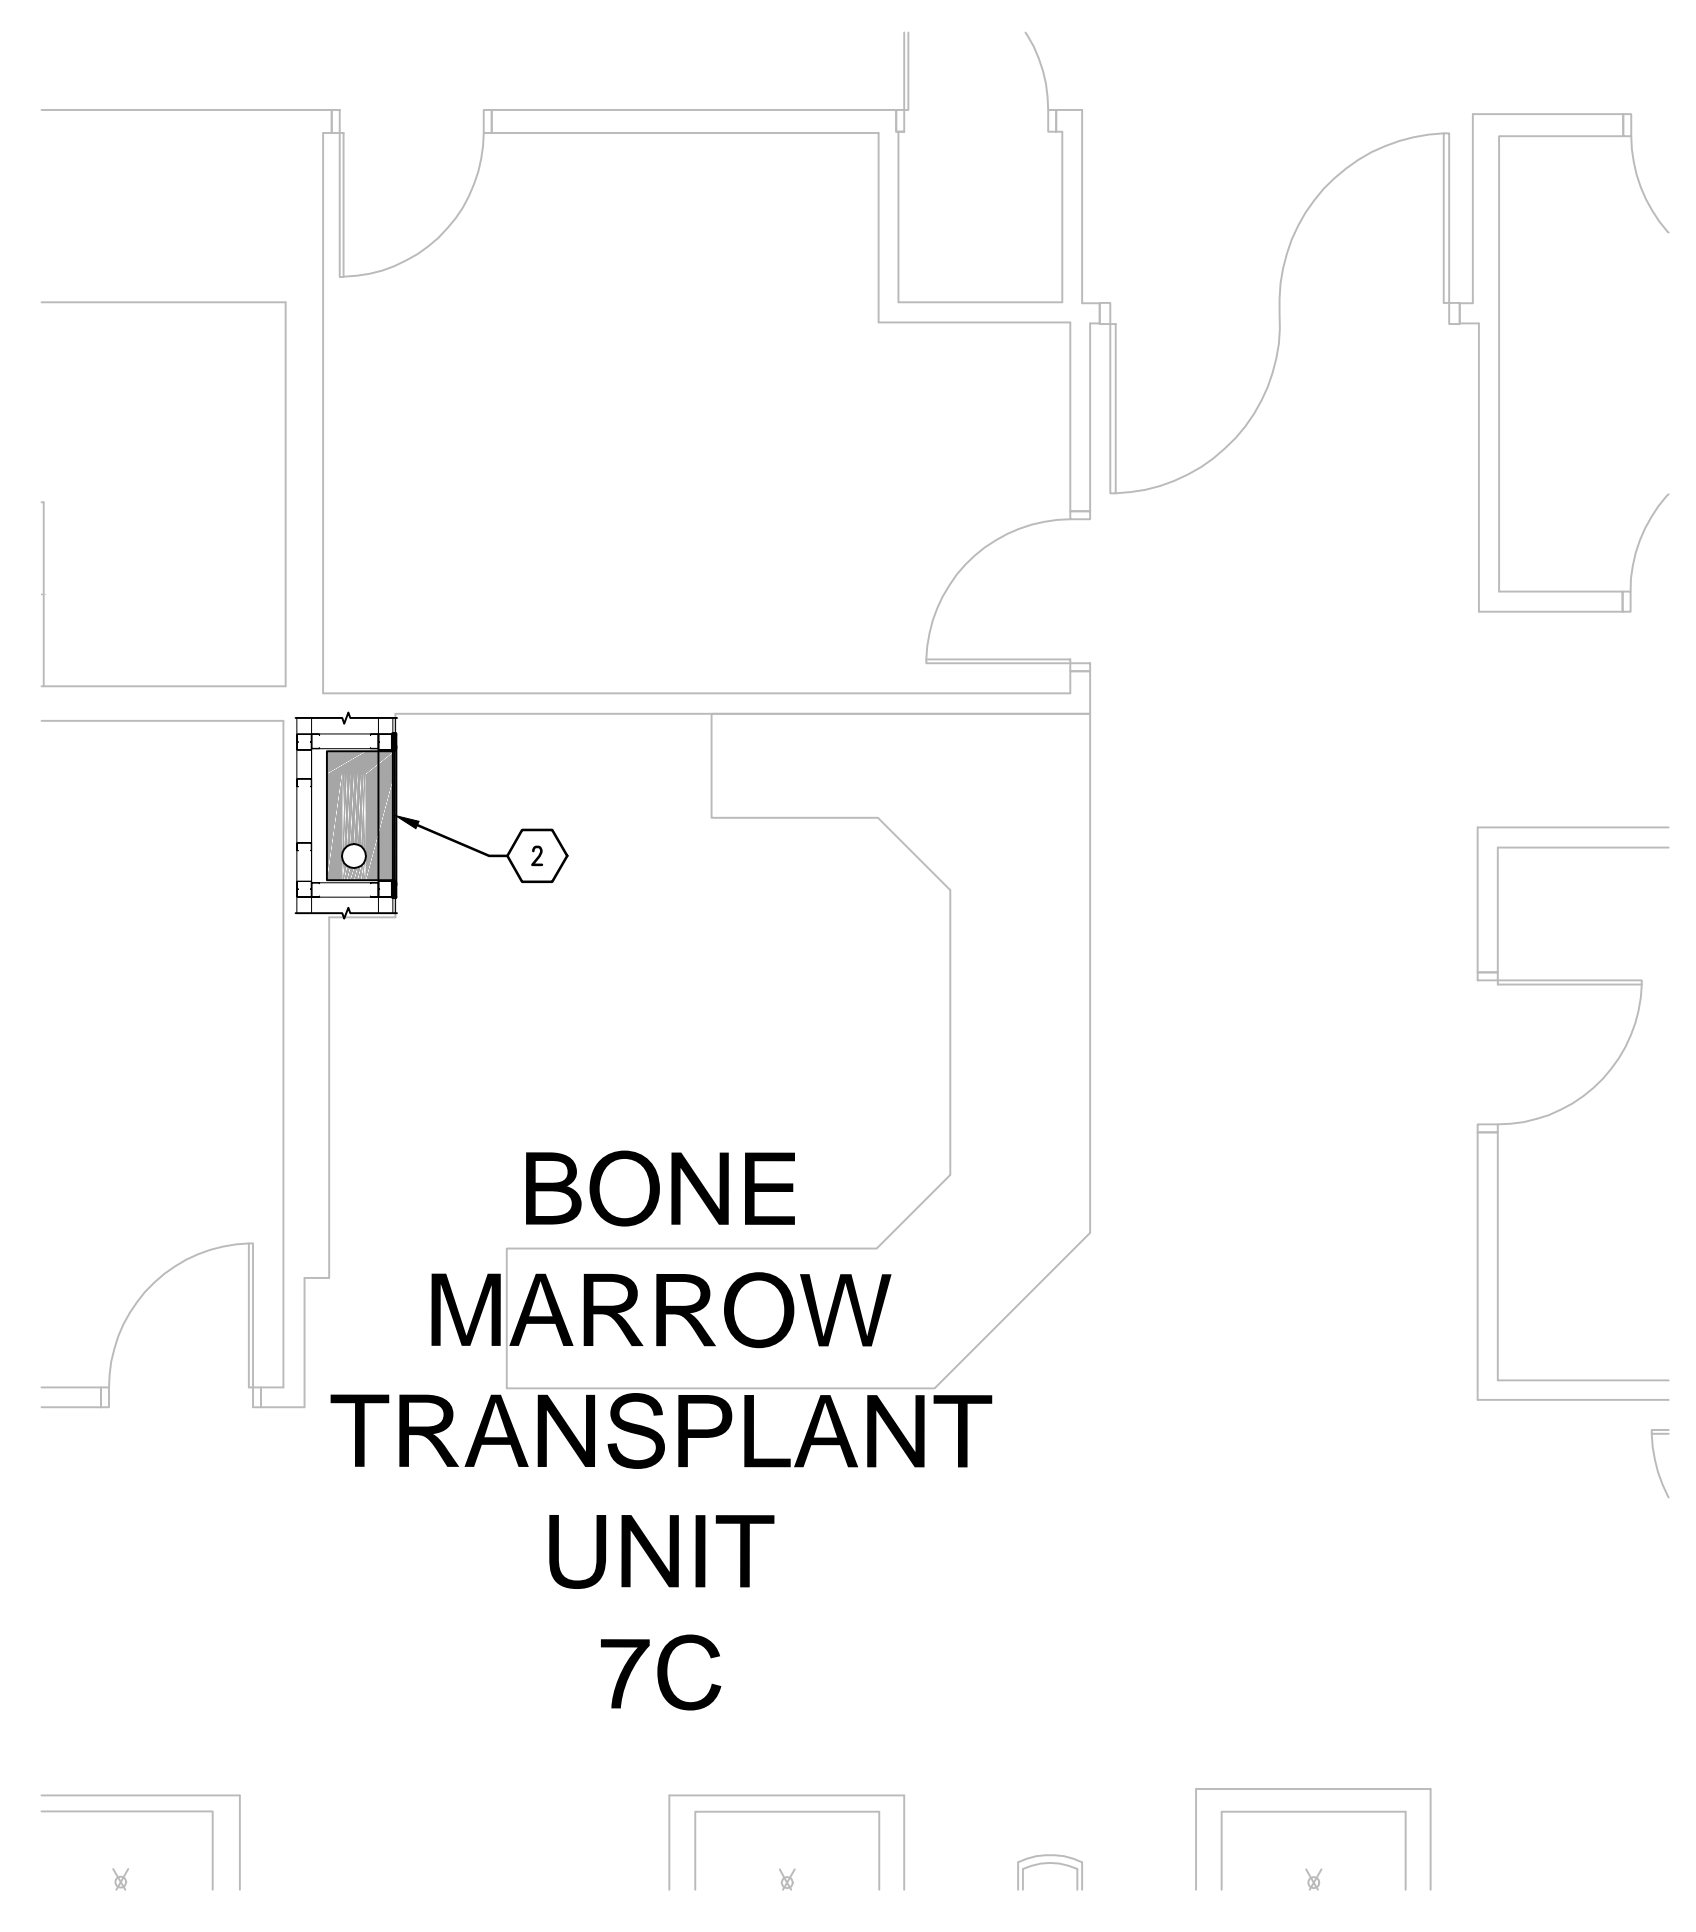

F4 SEVENTH FLOOR PLAN, BLDG. CC; BONE MARROW TRANSPLANT UNIT 7C / B701
SCALE: 1/4" = 1'-0"
(STATION 32)








GENERAL NOTES

- A. FIELD VERIFY ALL DIMENSIONS AND AVAILABLE CLEARANCES.
- B. COORDINATE ALL WORK AND PROJECT SCHEDULING WITH VA SAFETY, INFECTION CONTROL AND POLICE DEPARTMENTS.
- C. PROJECT CONSISTS OF FACILITY WIDE PNEUMATIC TUBE SYSTEM (PTS) INSTALLATION TO THE VA SAN ANTONIO AUDIE L. MURPHY VA HOSPITAL. AFFECTED BUILDINGS ARE AS FOLLOWS:
BUILDING CC, HOSPITAL & ADMINISTRATION, SEVEN FLOORS
BUILDING CLC, COMMUNITY LIVING CENTER, TWO FLOORS
BUILDING PRC, POLYTRAUMA REHABILITATION CENTER, THREE FLOORS
- D. PROJECT SCOPE OF WORK (SOW) INCLUDES INSTALLATION OF A NEW PNEUMATIC TUBE SYSTEM THROUGHOUT THE HOSPITAL FACILITY. SCOPE SHALL INCLUDE THE FOLLOWING:
1. INSTALLATION OF NEW GALVANIZED STEEL PNEUMATIC TUBING SUSPENDED FROM EXISTING STRUCTURE WITHIN INTERSTITIAL SPACES.
2. INSTALLATION OF PNEUMATIC BLOWER UNITS.
3. INSTALLATION OF PNEUMATIC TRANSFER UNITS.
4. INSTALLATION OF PNEUMATIC TERMINAL UNITS.
5. INSTALLATION OF PNEUMATIC ACCESSORIES SUCH AS CARRIER STORAGE UNITS AND ARRIVAL INDICATORS.
6. ELECTRICAL UPGRADES TO ACCOMMODATE NEW EQUIPMENT.
7. SELECT DEMOLITION.
8. NEW FRAMING AND PARTITIONS FOR TERMINAL UNITS.
9. NEW ARCHITECTURAL FINISHES.
- E. PTS ENCLOSURES SHALL BE CONSTRUCTED AS FOLLOWS:
1. 3-5/8" X 20 GA GALVANIZED METAL STUDS AT 16" O.C. MAXIMUM.
2. REMOVE FLOOR FINISHES TO SLAB PRIOR TO INSTALLATION OF BOTTOM TRACK.
3. TOP TRACK SHALL EXTEND A MINIMUM OF 4" ABOVE FINISHED CEILING.
4. ONE LAYER TYPE X GYPSUM BOARD, EXTERIOR FACE.
5. PROTECT EXISTING ADJACENT FINISHES DURING CONSTRUCTION ACTIVITIES.
6. NEW FINISHES SHALL MATCH EXISTING ADJACENT FINISHES.
- F. ACTUAL ENCLOSURE DIMENSIONS WILL VARY SLIGHTLY DEPENDING ON PTS MANUFACTURER SELECTED. HOLD DIMENSIONS AS CLOSE AS POSSIBLE TO MINIMIZE DISTURBANCE OF EXISTING ADJACENT WORK AREAS, EQUIPMENT, MILLWORK AND CASEWORK.
- G. CONFIRM WITH SELECTED PTS MANUFACTURER OF RATED PARTITION / ENCLOSURE REQUIREMENTS.

KEY NOTES

- 1. NEW SINGLE DROP PST STATION, FULLY ENCLOSED.
- 2. NEW SINGLE DROP PST STATION, UTILIZE EXISTING SPACE.; FIELD VERIFY CLEARANCE AVAILABILITY.

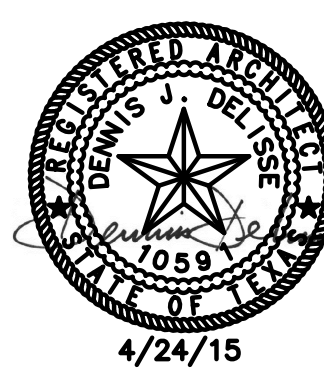100% CONSTRUCTION ISSUE

Revisions 	Date 	 2201 N Collins, Suite 205 Arlington, Texas 76011-2055 (817) 461-5337 Fax: (817) 461-1105 MECHANICAL • ELECTRICAL • PLUMBING Fratro Engineering Inc. FEI Project No.: 13069	 Architecture • Planning • Interior Design 4949 Addison Circle • Addison, Texas 75001 MPI Project No.: 8130707			Drawing Title BUILDING CC – TOWER SEVENTH FLOOR PLAN PTS STATION LOCATIONS		Project Title AUDIE L. MURPHY VA HOSPITAL PNEUMATIC TUBE SYSTEM UPGRADE		Date 4/24/15	 STVHCS San Antonio, Texas	
						Approved: Area Project Manager		Building Number CC	Checked DJD	Drawn AR/DC		Project No. 671-13-104
								Location 7400 Merton Minter San Antonio, TX 78229				Drawing No. A409
										Dwg. of		