


GENERAL NOTES:

1. REFER TO MEP000 FOR ADDITIONAL NOTES.
2. THE PNEUMATIC TUBE SYSTEM INFRASTRUCTURE DESIGN HEREIN BASED ON SWISSLOG HEALTHCARE SOLUTIONS EQUIPMENT. THE VA RESERVES THE RIGHT FOR APPROVAL OF ALTERNATE PNEUMATIC TUBE SYSTEMS MANUFACTURER.
3. CONTRACTOR SHALL RE-ROUTE ANY DUCTWORK, MECHANICAL OR PLUMBING PIPING, DAMPERS OR TERMINAL BOXES LOCATED IN THE CEILING PLENUM AS REQUIRED TO ACCOMMODATE NEW PNEUMATIC OR ASSOCIATED EQUIPMENT.

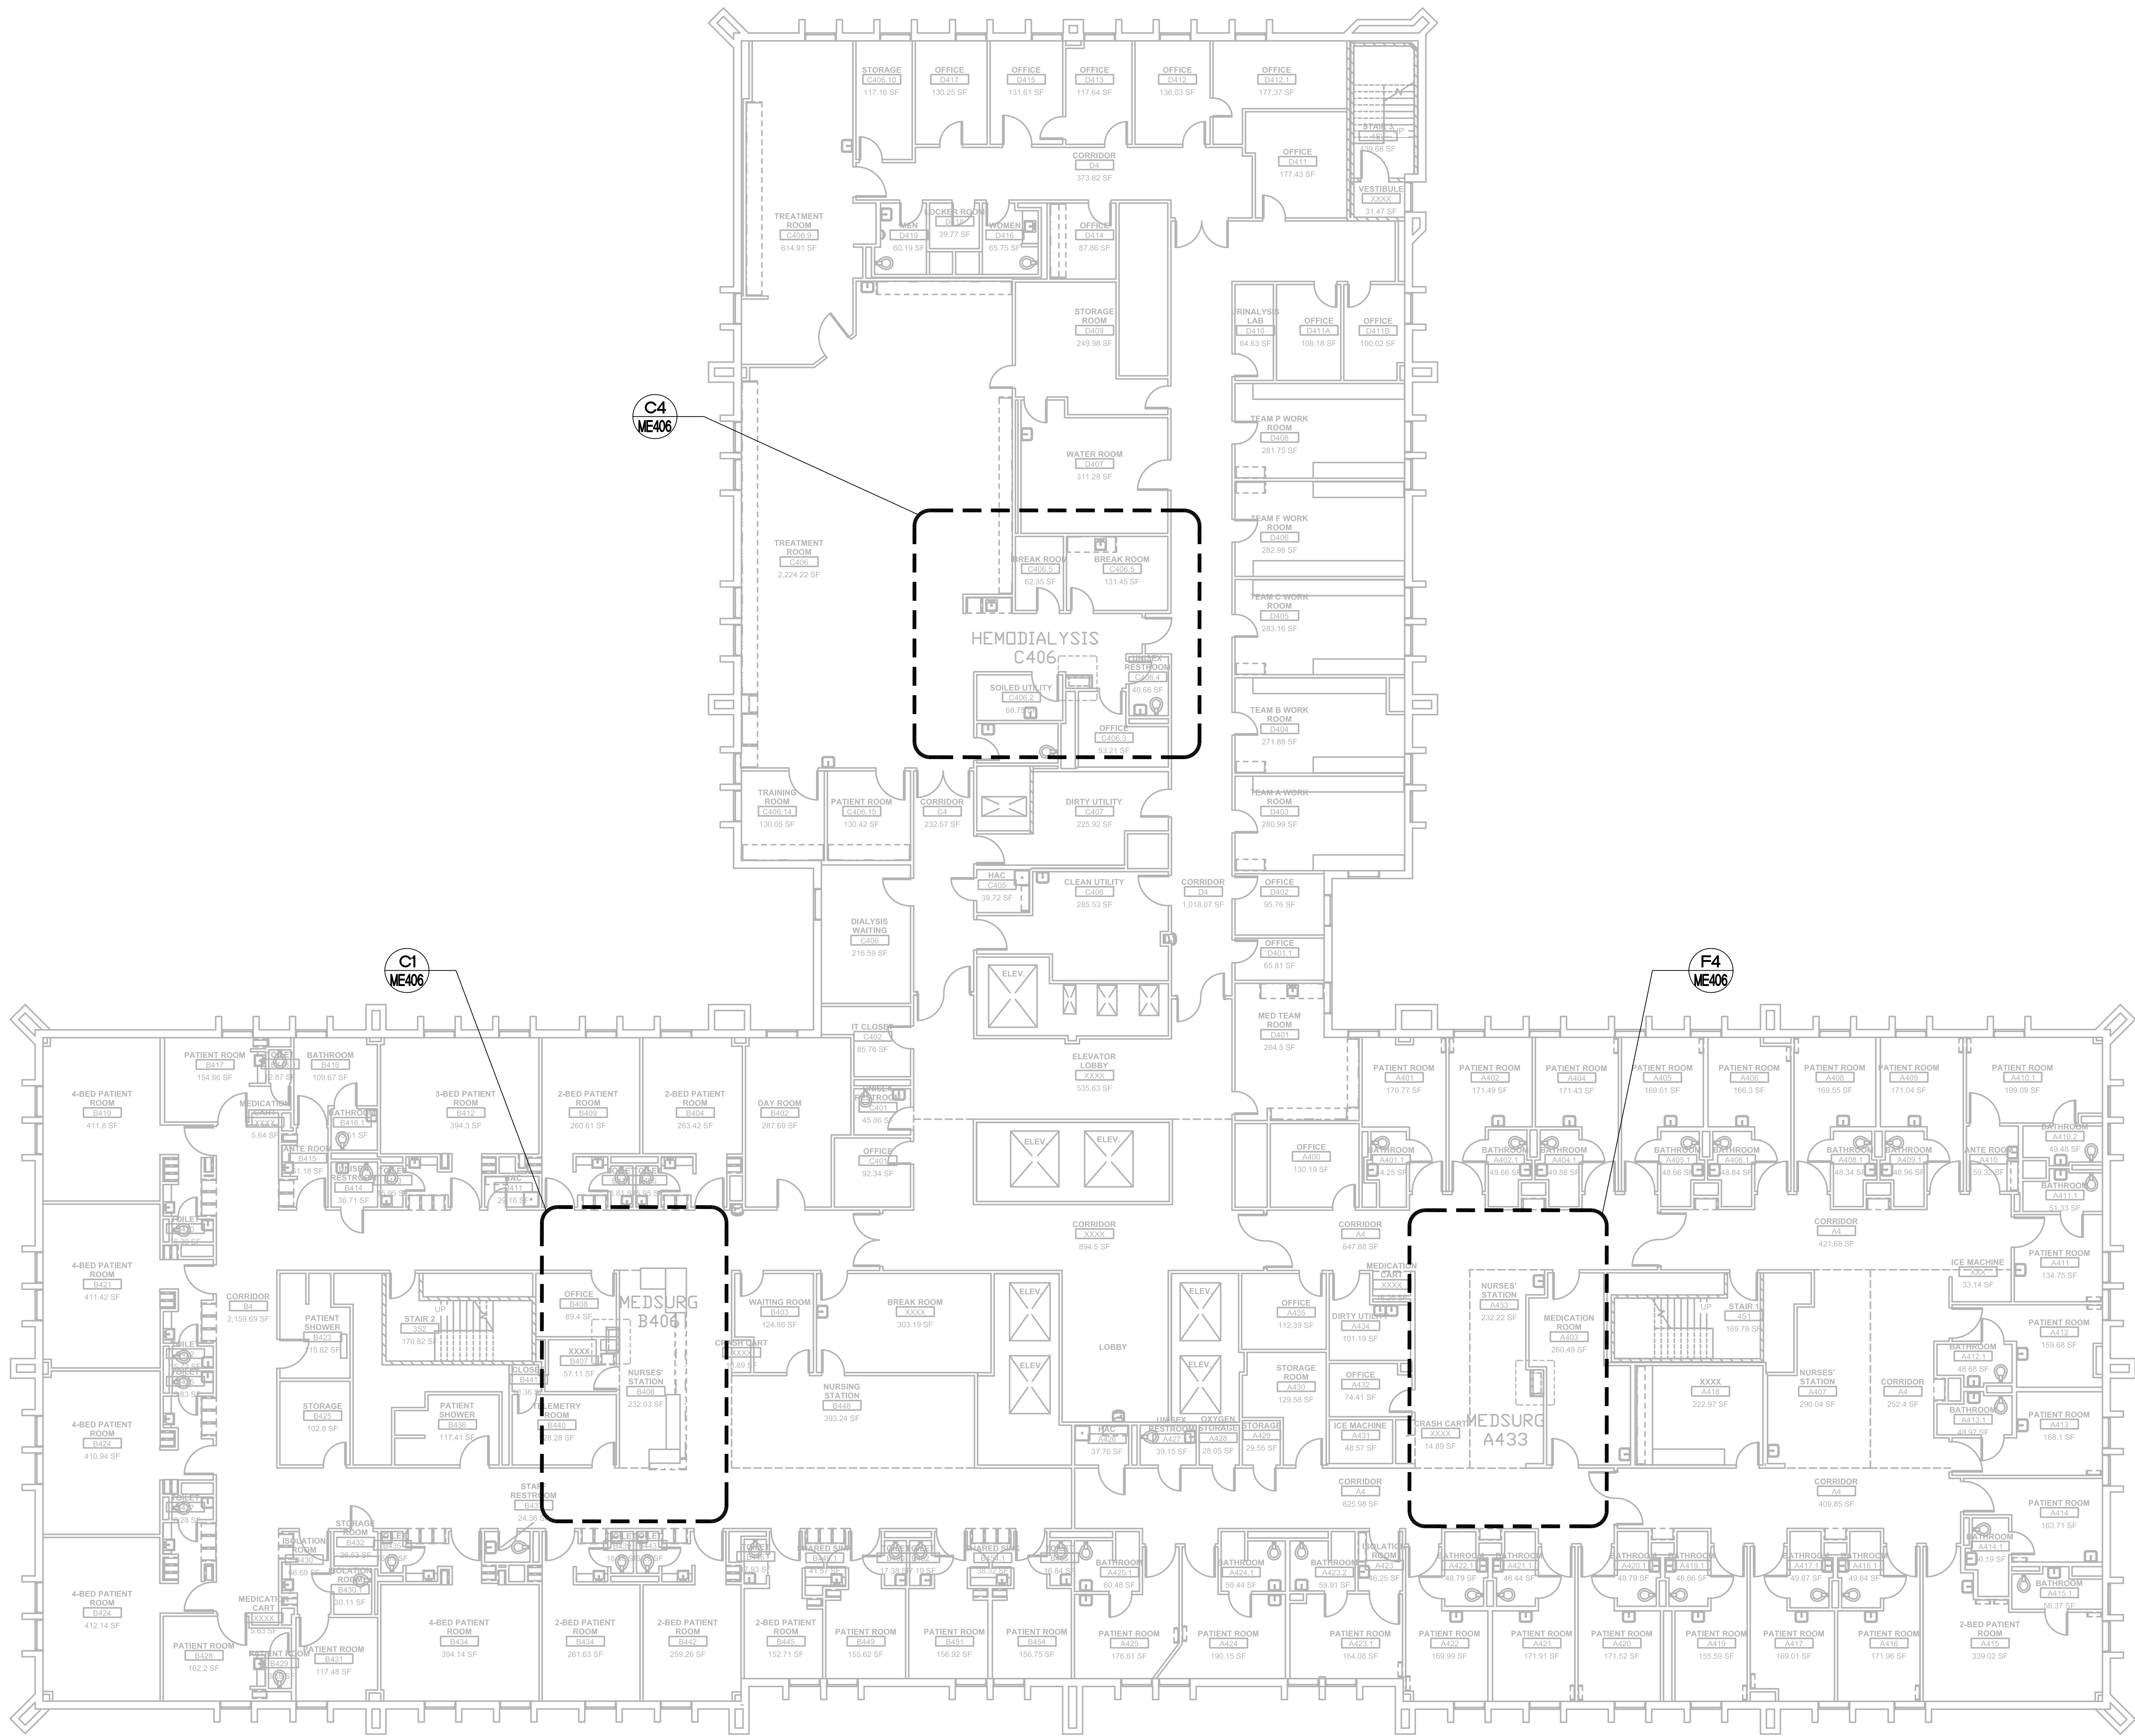


F1 FOURTH FLOOR PLAN, BLDG. CC
SCALE: 1" = 10'-0"



FOURTH FLOOR

Revisions	Date



2201 N. Collins, Suite 200
Arlington, Texas 76010-2600
(817) 461-0337 Fax: (817) 461-0025
E: info@fei-engineering.com
MECHANICAL • ELECTRICAL • PLUMBING
FBI PROJECT # 13069

FEI Project No.: 13069




Architecture ■ Planning ■ Interior Design
4949 Addison Circle ■ Addison, Texas 75001

MPI Project No.: 8130707

Seal

Seal



04/24/2015

Drawing Title
**BUILDING CC
FOURTH FLOOR PLAN**

Approved: Area Project Manager

Project Title
**AUDIE L. MURPHY VA HOSPITAL
PNEUMATIC TUBING SYSTEM**

Building Number
CC

Location
**7400 Merton Minter
San Antonio, TX 78229**

Date
04/24/15

Project No.
671-13-104

Drawing No.
E105

Dwg. of



STVHCS
San Antonio, Texas