

Department of Veterans Affairs

John J. Pershing VAMC Clinical & Urgent Care Addition

1500 N Westwood Blvd, Poplar Bluff, MO 63901

VA PROJECT NO. 657-351
CONSTRUCTION DOCUMENTS - FINAL BID DOCUMENTS
DECEMBER 14, 2015

CANNONDESIGN

BOSTON NEW YORK BALTIMORE WASHINGTON DC BUFFALO TORONTO MONTREAL CHICAGO
ST. LOUIS VANCOUVER SAN FRANCISCO LOS ANGELES PHOENIX SHANGHAI MUMBAI DELHI

Consultants:

Landmark Engineering Group, Inc. Civil Engineer 2834 104th Street Urbandale, IA 50322 515.221.1322	Gateway Geotechnical, LLC Geotechnical Engineer 17736 Edison Avenue Chesterfield, MO 63005 636.532.7747	SWT Design Landscape Architect 7722 Big Bend Boulevard St. Louis, MO 63119 314.644.5700	Hinman Consulting Engineers, Inc. Physical Security One Bush Street, Suite 510 San Francisco, CA 94104 415.621.4423	The Schachinger Group Elevator 4255 Stoney Creek Drive Fort Collins, CO 80525 703.608.2263	SidePlate Steel Frame 25909 Pala, Ste 200, 92691 Mission Viejo, CA 949.305.7889
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GENERAL

Table with 2 columns: SHEET #, SHEET NAME. Lists sheets GI-001 to GI-104 including Cover Sheet, Drawing Index, Symbols & Abbreviations, and various Level 01 Code Compliance Plans.

CIVIL


Table with 2 columns: SHEET #, SHEET NAME. Lists sheets VF-101 to CS-105 including Site Survey, Demolition Plans, Site Plans, and Grading/Drainage Plans.

LANDSCAPE


Table with 2 columns: SHEET #, SHEET NAME. Lists sheets LS-101 to LD-501 including Overall Site Plan, Court Yard Site Plan, Entry Site Plan, and various Planting Plans.

STRUCTURAL


Table with 2 columns: SHEET #, SHEET NAME. Lists sheets SS-001 to SS-606 including General Notes, Foundation Plans, Framing Plans, and various Typical Details for Foundations, Masonry, Steel, and Millwork.

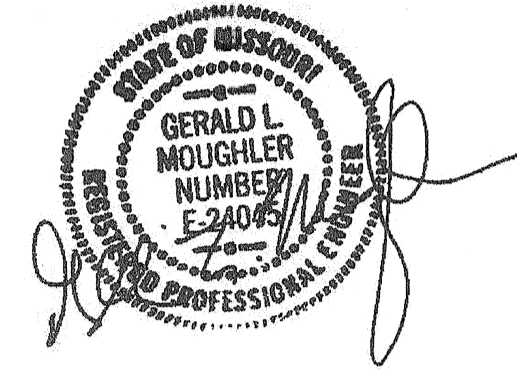

THIS STAMP IS FOR CIVIL DRAWINGS

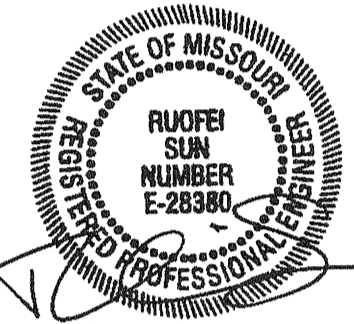


THIS STAMP IS FOR STRUCTURAL DRAWINGS SS-001 THRU SS-512

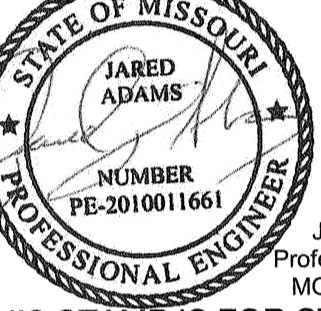

THIS STAMP IS FOR STRUCTURAL DRAWINGS SS-601 THRU SS-606

ARCHITECTURAL

Table with 2 columns: SHEET #, SHEET NAME. Lists sheets AD-101 to AF-101 including Demolition Plans, Floor Plans, Elevations, Sections, and various Details for Interiors, Partitions, and Finishes.

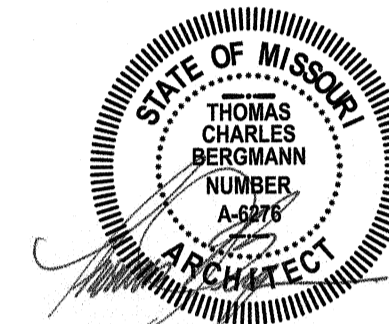

THIS STAMP IS FOR GENERAL AND ARCHITECTURAL DRAWINGS

EQUIPMENT

Table with 2 columns: SHEET #, SHEET NAME. Lists sheets QH-101 to QH-104 including Lower Level Equipment Plan, Ground Level Equipment Plan, and Lobby Equipment Plans.

FIRE PROTECTION

Table with 2 columns: SHEET #, SHEET NAME. Lists sheets FA-101 to FX-601 including Lower Level Fire Alarm Plan, Ground Level Alarm Plan, and various Fire Suppression Plans.

PLUMBING

Table with 2 columns: SHEET #, SHEET NAME. Lists sheets PL-001 to DP-103A including Plumbing Abbreviations, Underground Piping Plan, and various Piping Level Plans.

MECHANICAL

Table with 2 columns: SHEET #, SHEET NAME. Lists sheets MH-001 to MH-703 including Symbols, Abbreviations, and General Notes, and various HVAC Ductwork and Piping Plans.



THIS STAMP IS FOR FIRE PROTECTION PLUMBING AND MECHANICAL DRAWINGS

ELECTRICAL

Table with 2 columns: SHEET #, SHEET NAME. Lists sheets EP-001 to EY-601 including Legends, Symbols, and Abbreviations, and various Site, Power, Lighting, and Equipment Connection Plans.



THIS STAMP IS FOR ELECTRICAL DRAWINGS

Vertical scale markings on the left margin: three eighths inch = one foot, one quarter inch = one foot, one eighth inch = one foot, one half inch = one foot, one quarter inch = one foot, one eighth inch = one foot.

Table for Revisions: 1 FINAL BID PACKAGE 12/14/15

Table for CONSULTANTS: Landmark Engineering Group, Inc., Gateway Geotechnical, LLC, SWT Design, Hiram Consulting Engineers, Inc., The Schachinger Group.


Table for ARCHITECT/ENGINEERS: CANNONDESIGN

Table for DRAWING INDEX: Approved: Project Director [Signature]


Table for Project Information: Project Title: John J. Pershing VAMC Clinical & Urgent Care Addition, Location: Poplar Bluff, Missouri, Drawing Number: GI-002

Office of Construction and Facilities Management, Department of Veterans Affairs


PLAN SYMBOLS

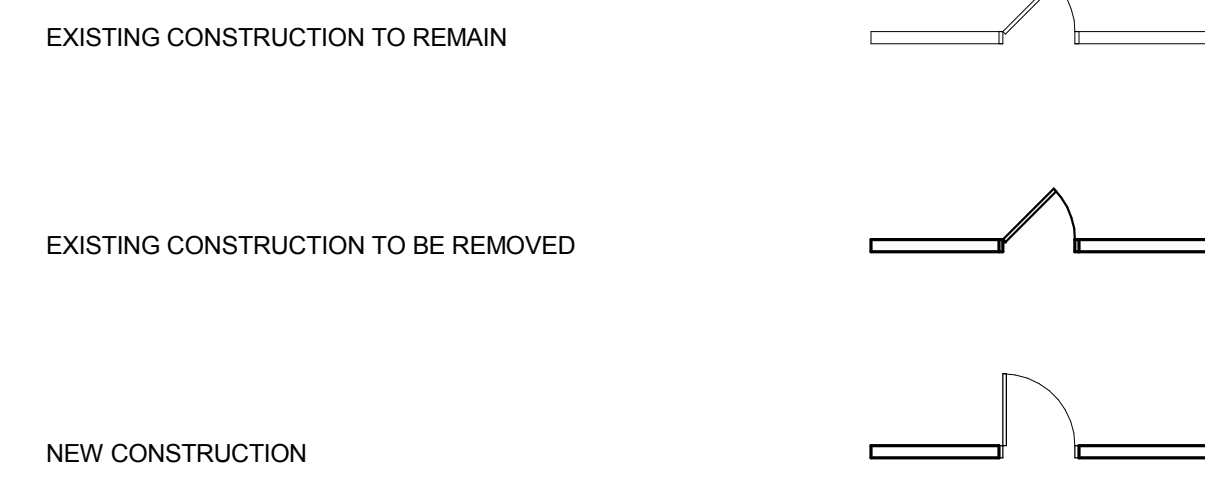


REFLECTED CEILING PLAN SYMBOLS

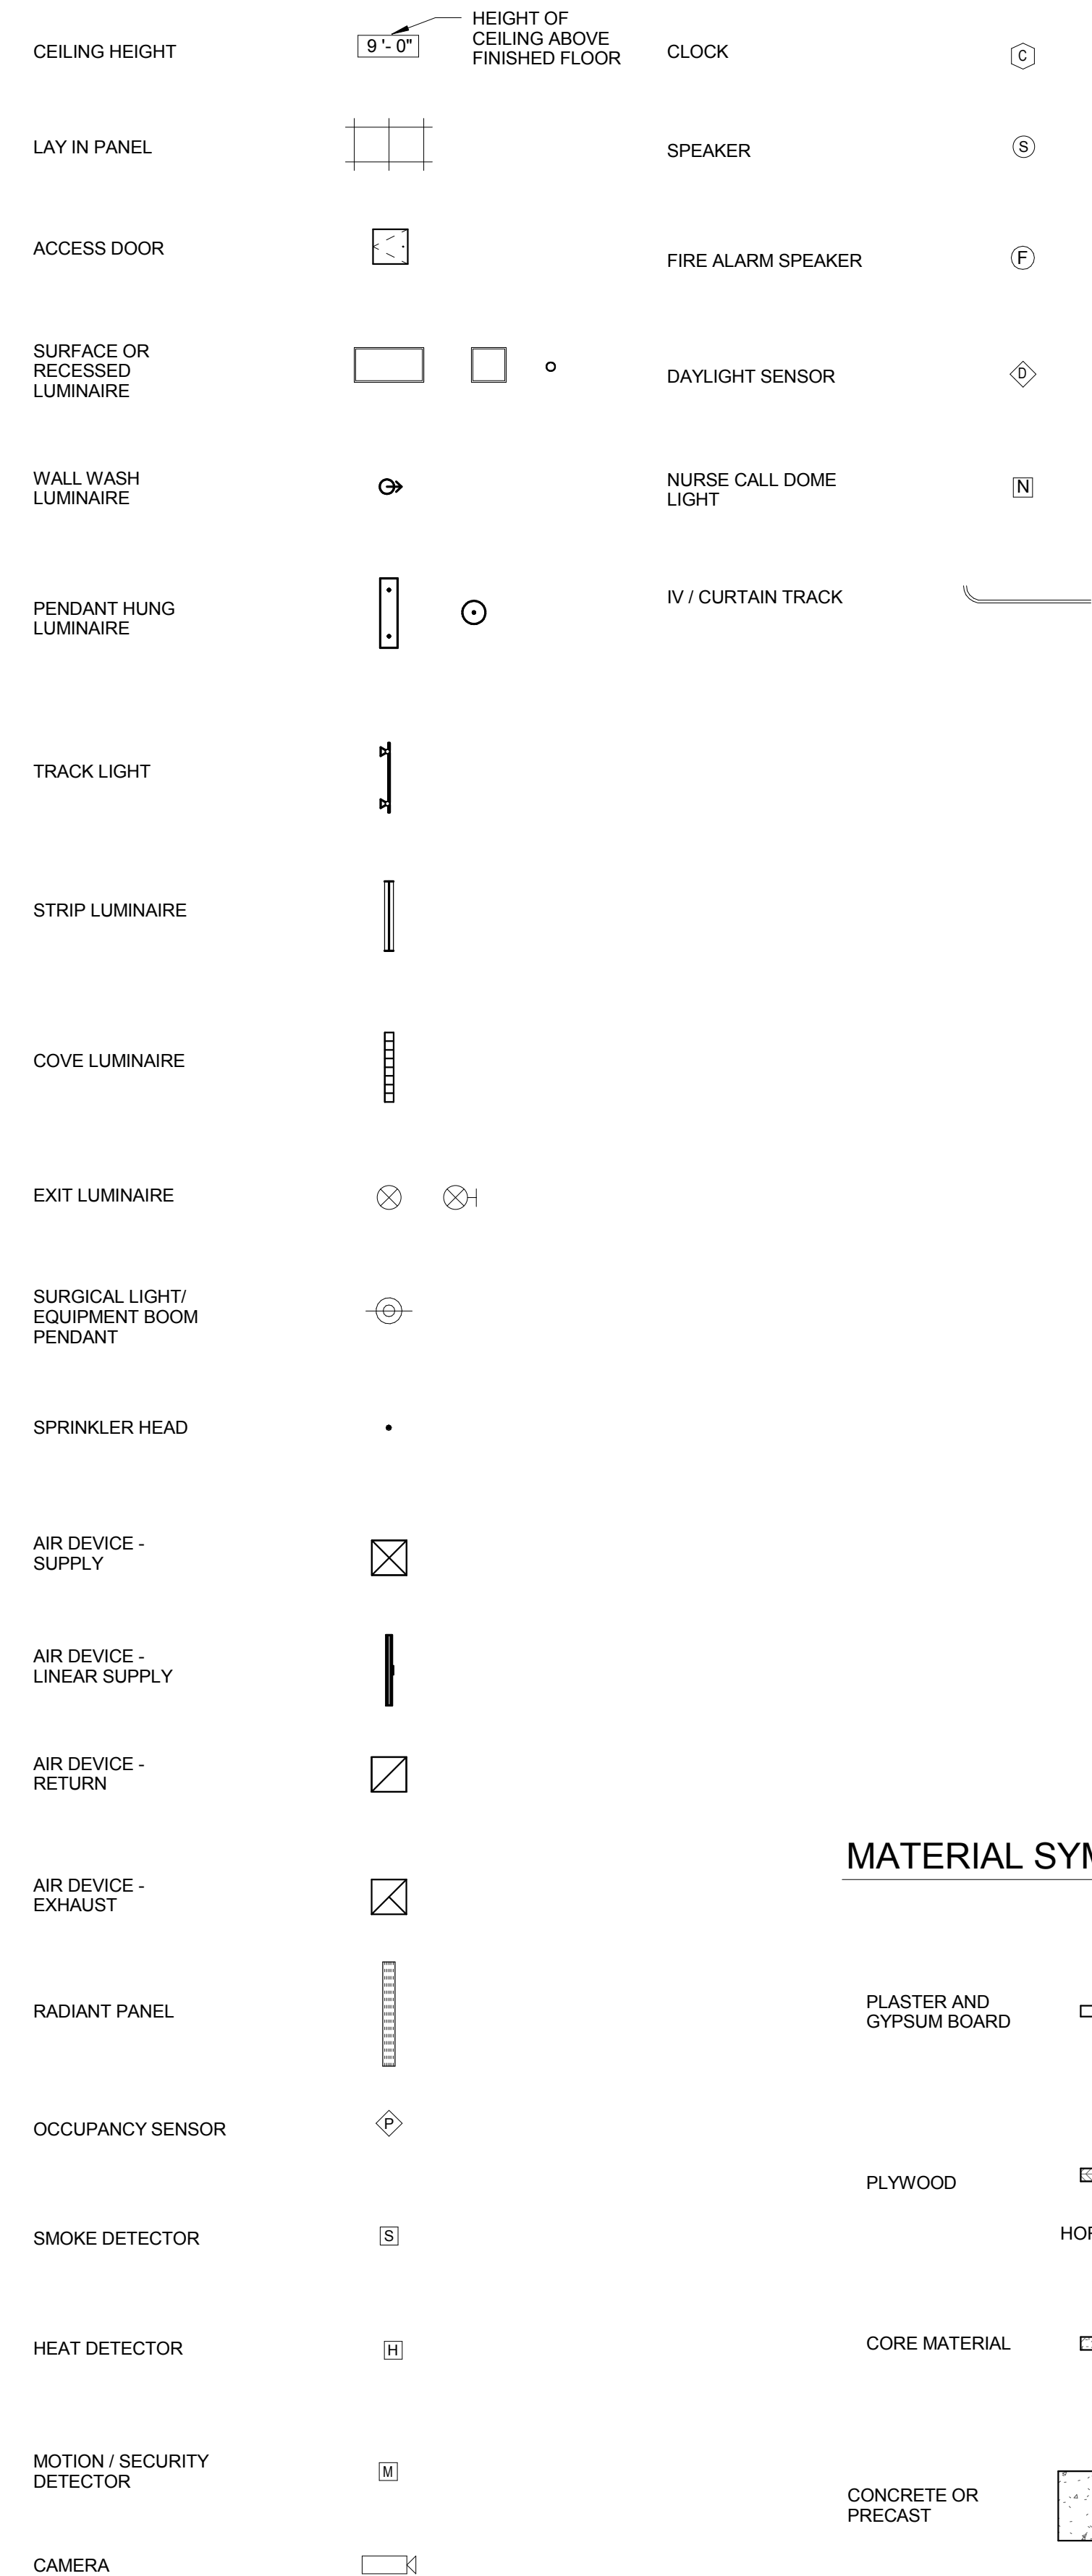


REFERENCE SYMBOLS (ARCHITECTURAL)

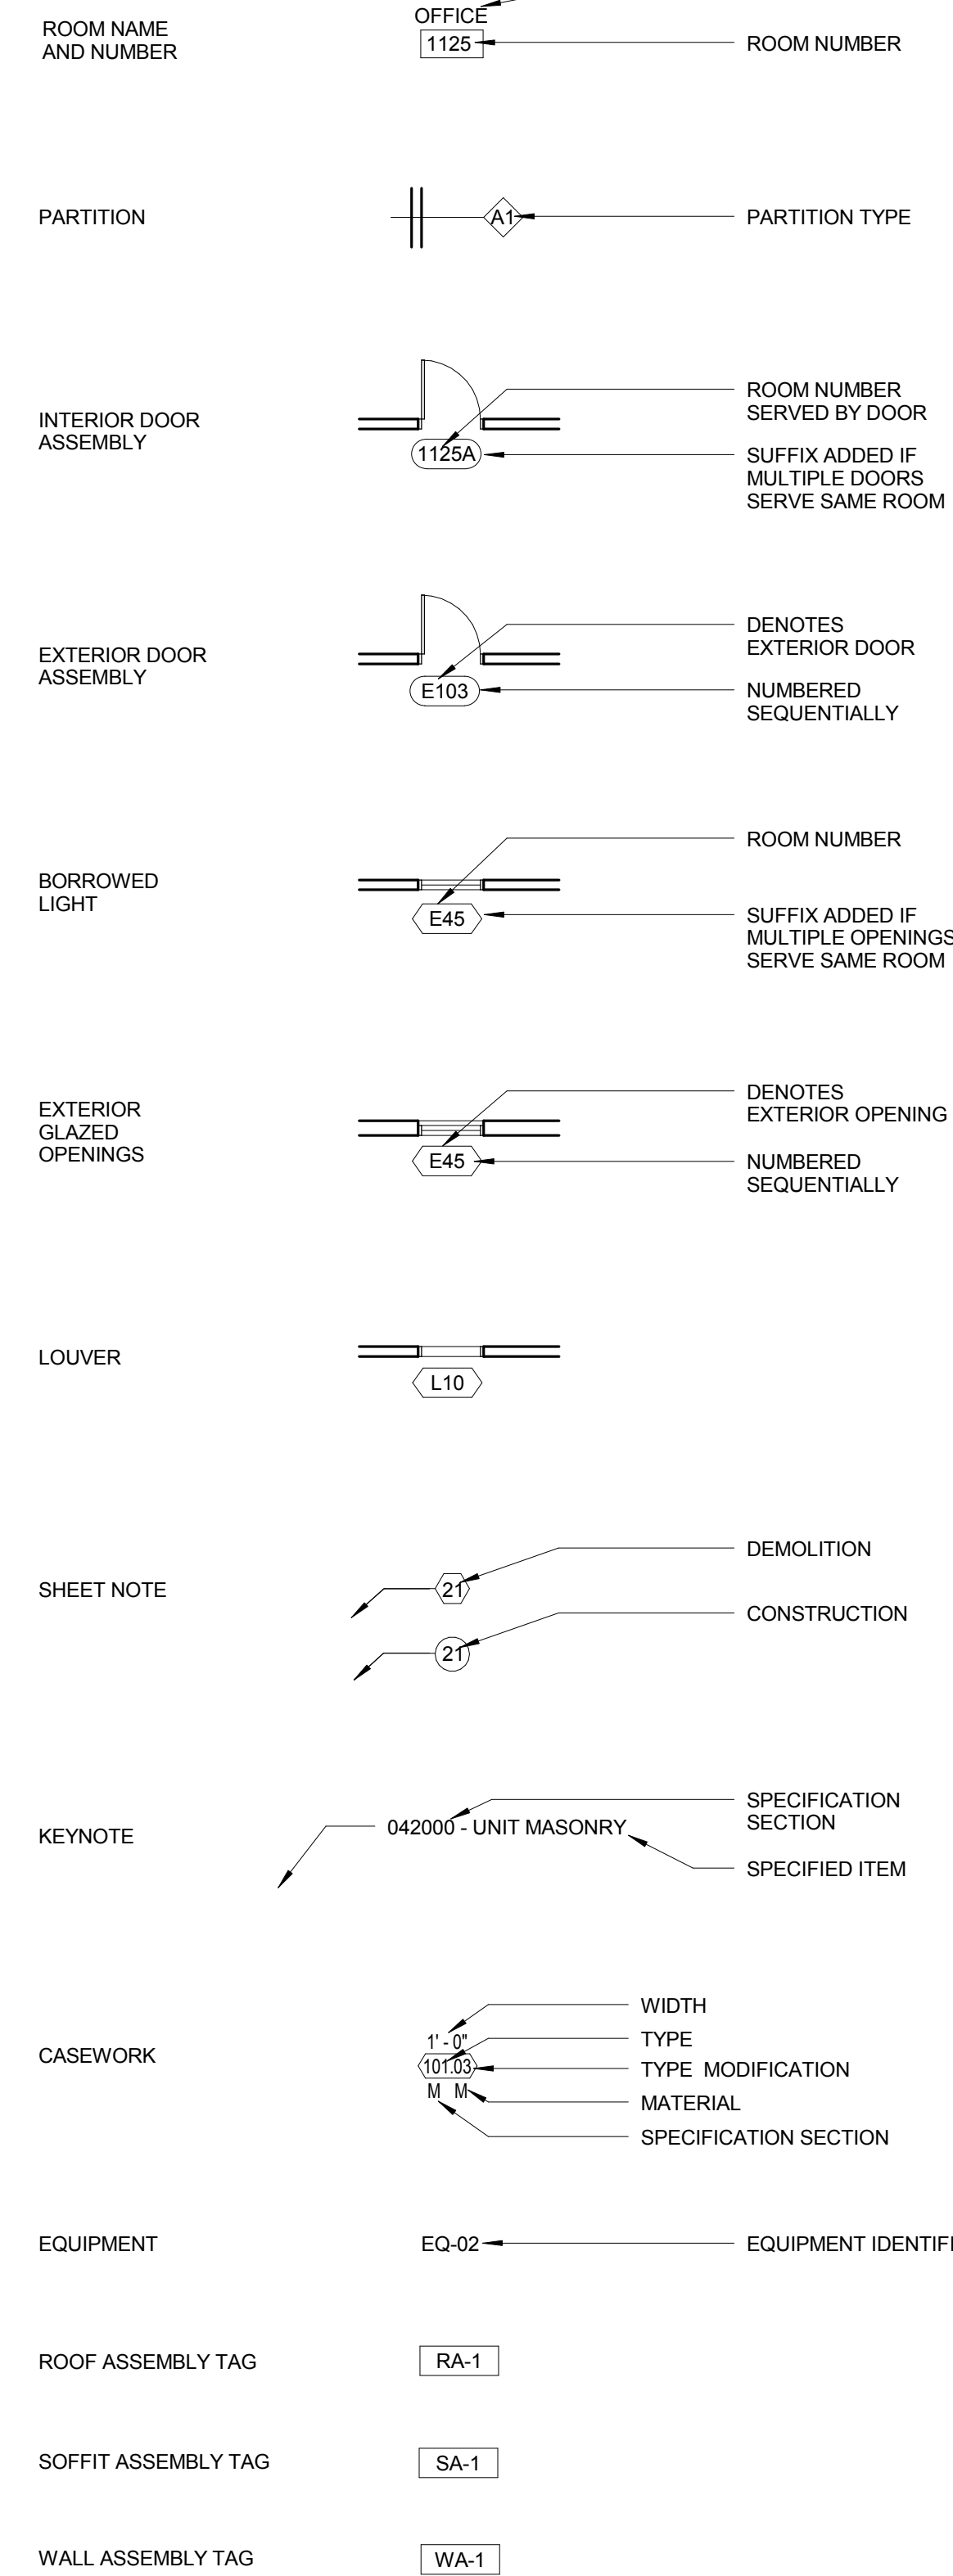

MATERIAL SYMBOLS

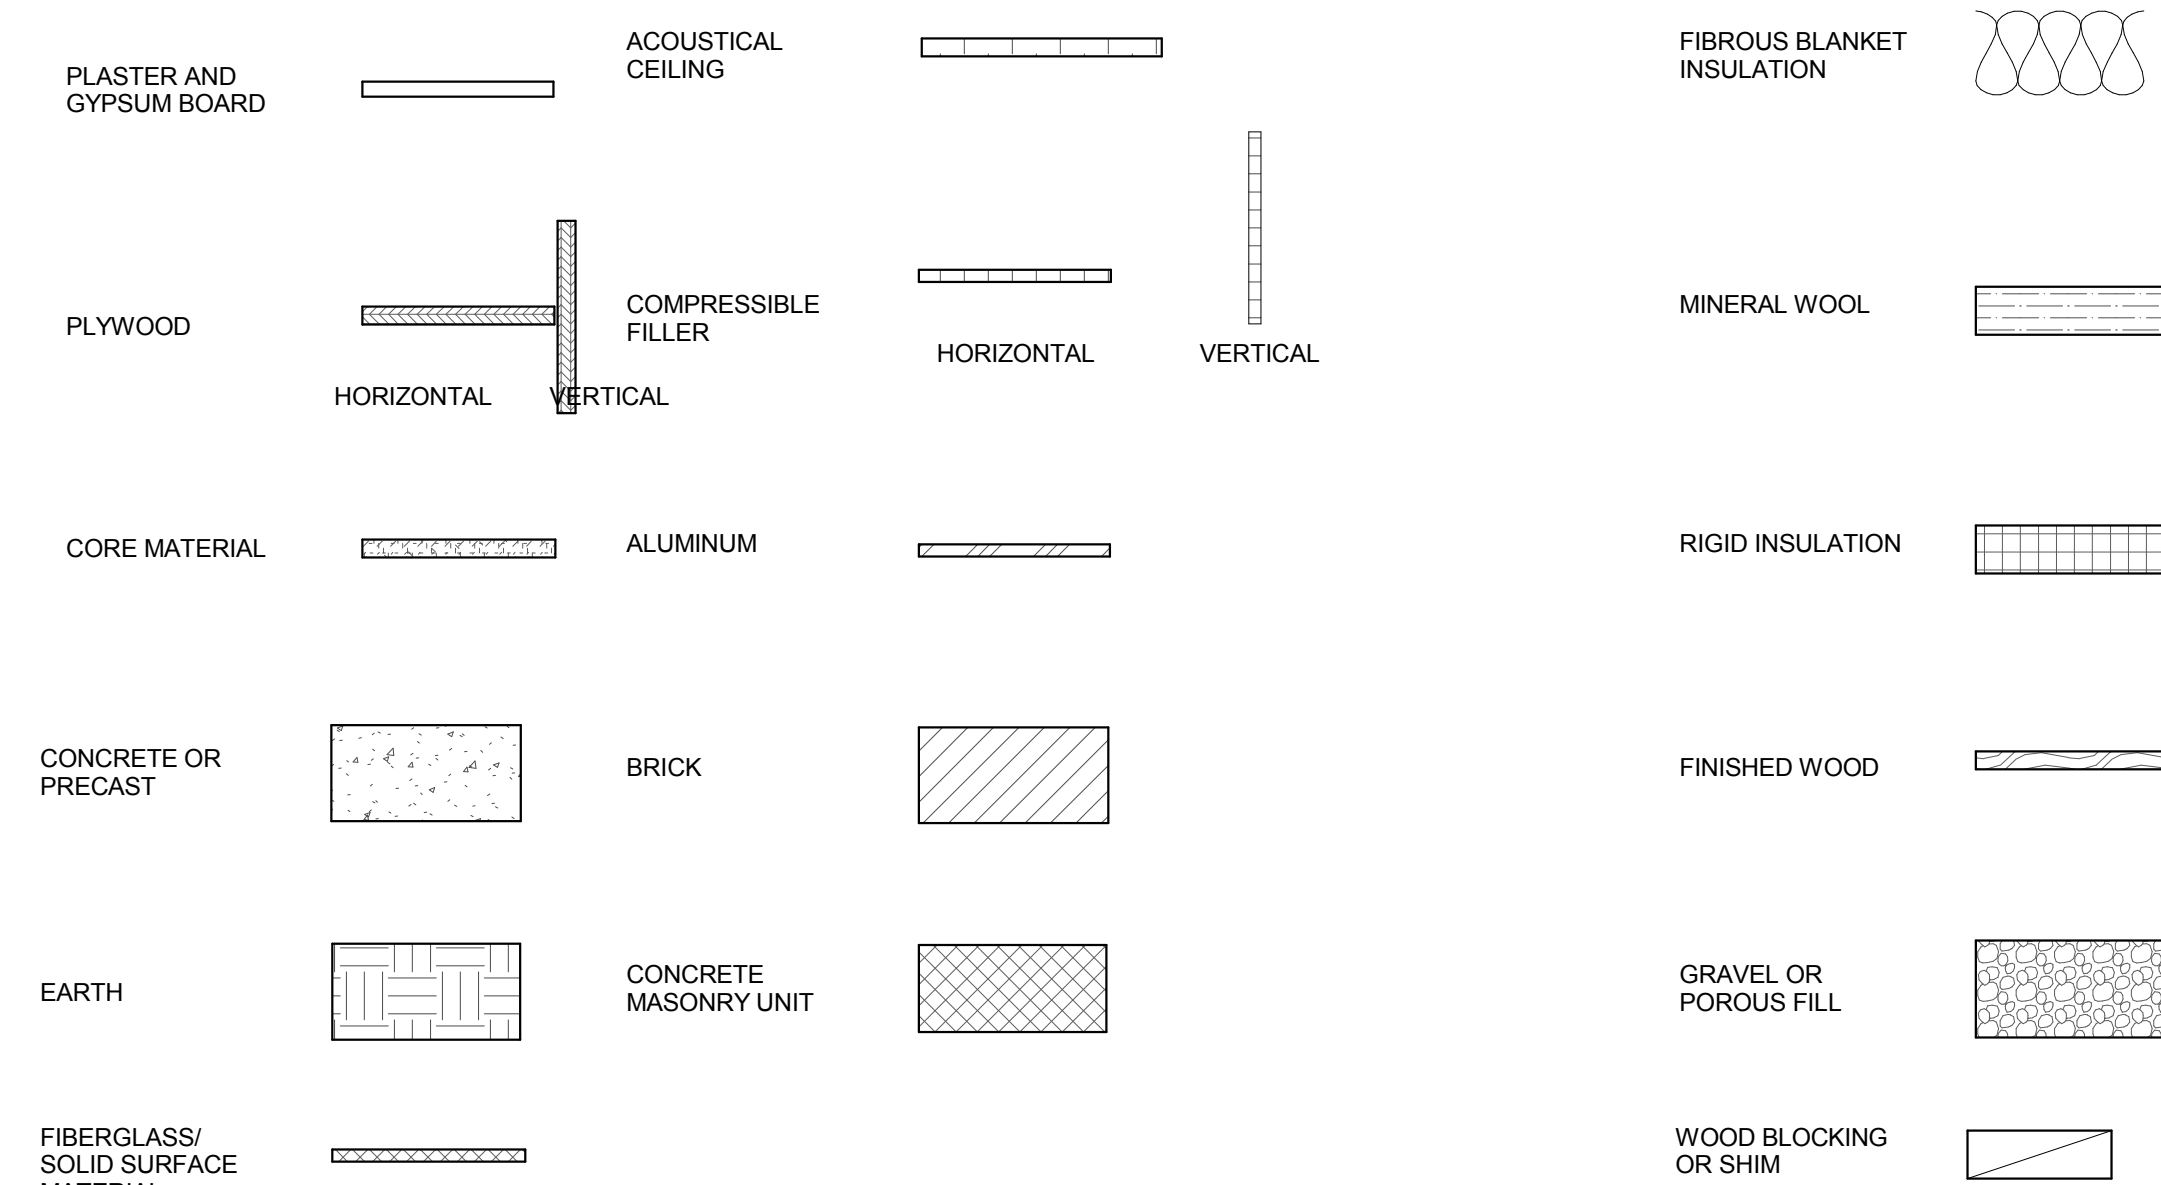

REFERENCE SYMBOLS (ALL DISCIPLINES)

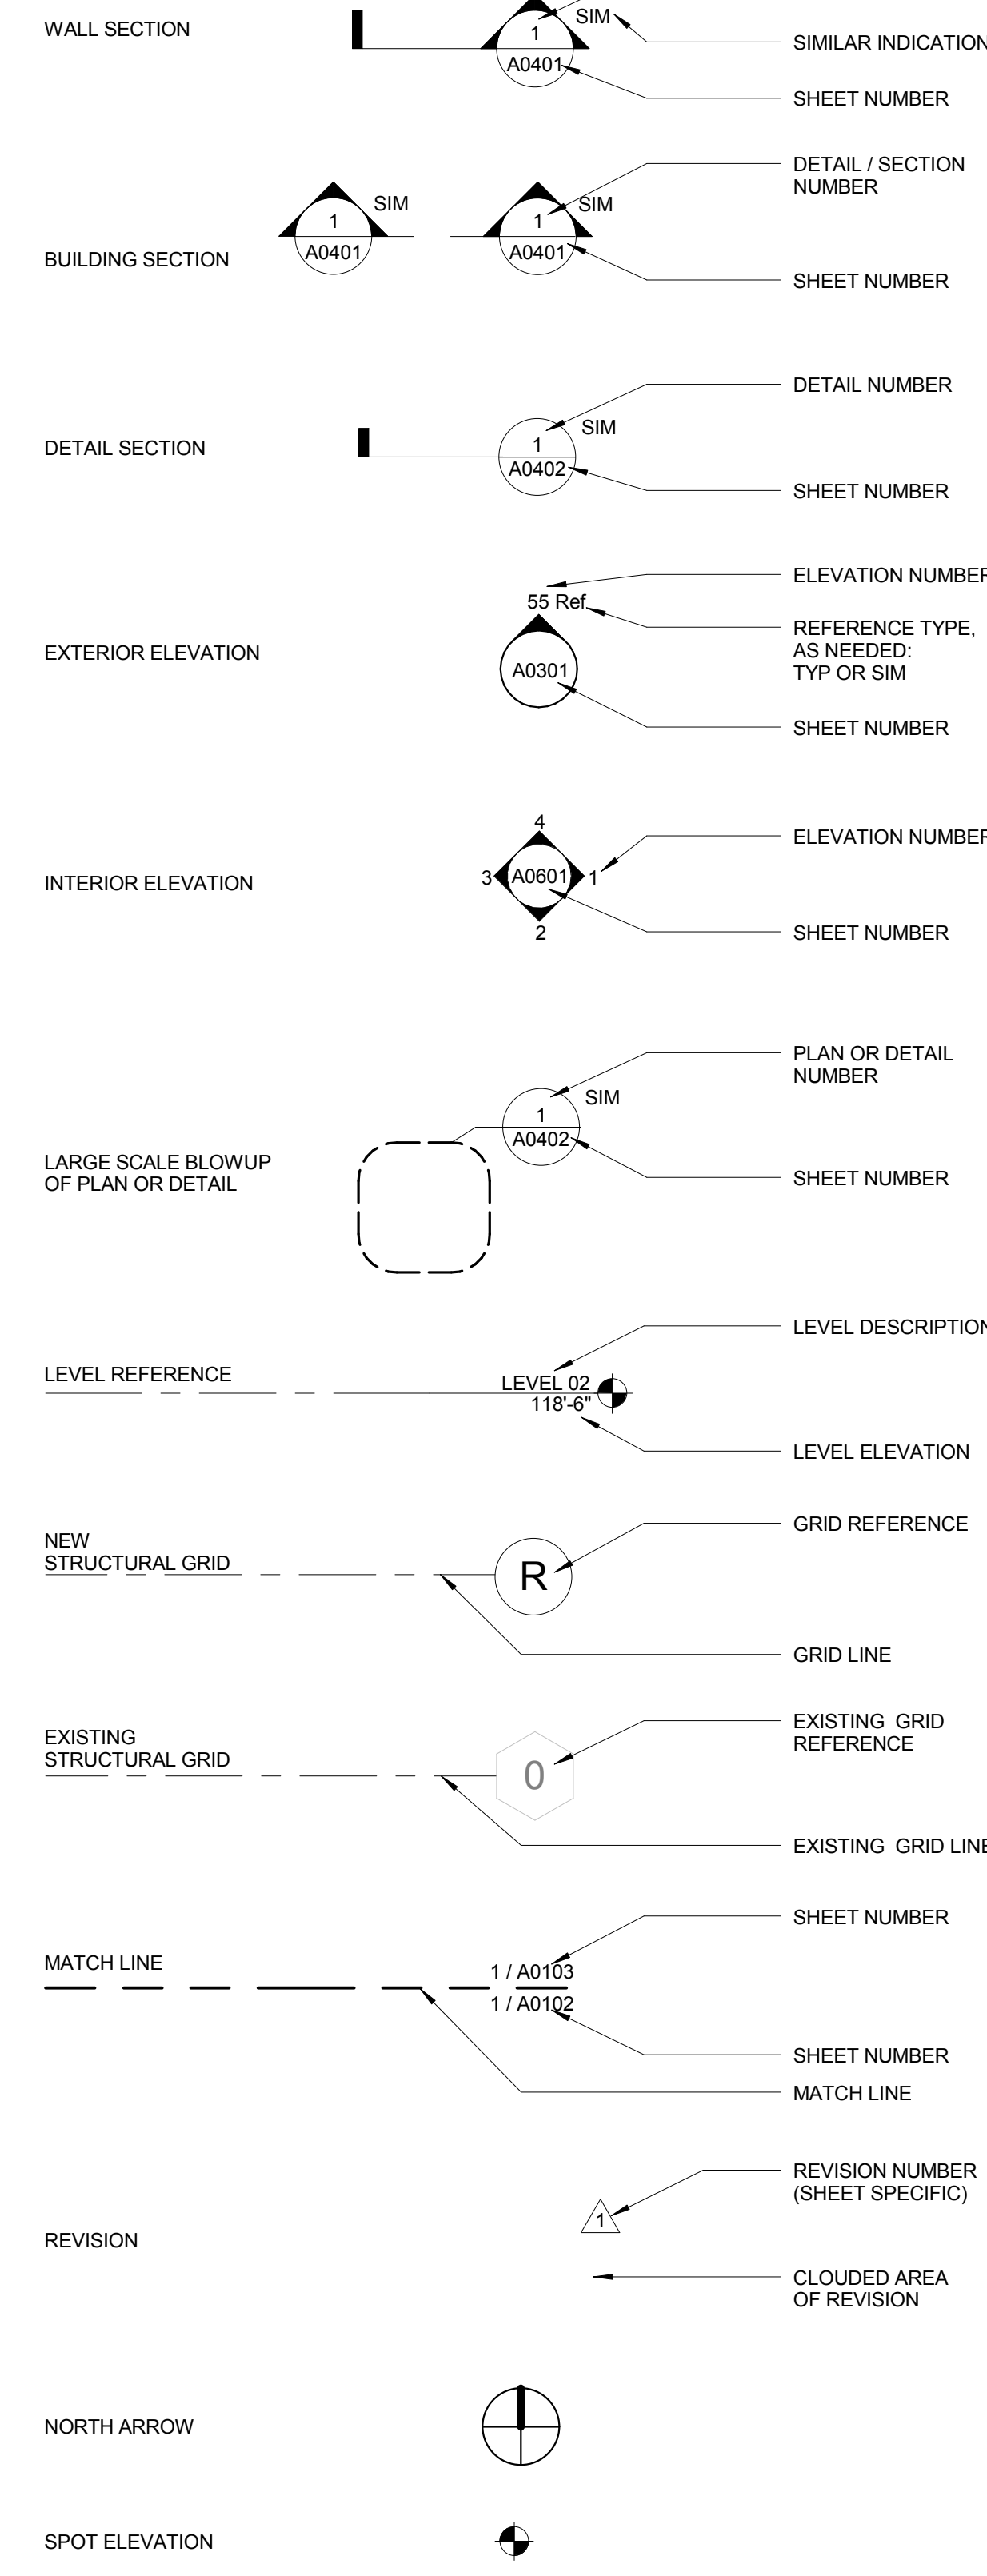

GENERAL NOTES

- ENCLOSE ALL EXPOSED DUCTS, PIPES, CONDUITS, ETC. IN FINISHED SPACE WITH CONSTRUCTION AND FINISH TO MATCH ADJACENT CONSTRUCTION UNO.
- PROVIDE ACCESS DOORS OF APPROPRIATE SIZE, TYPE AND FIRE RATING FOR ALL CONCEALED ITEMS THAT REQUIRE ADJUSTMENT, MAINTENANCE, MONITORING, ETC. COORDINATE LOCATIONS WITH ARCHITECT.
- DO NOT DETERMINE DIMENSIONS AND SIZE OF THE GRAPHIC REPRESENTATIONS SHOWN ON THE DRAWINGS BY USING MEASURING DEVICES (DO NOT "SCALE"). RELY ON THE NUMERIC DIMENSIONS SHOWN ON THE DRAWINGS FOR MEASUREMENT.
- DIMENSIONS ARE TAKEN FROM CENTERLINE OF STRUCTURE. FACE OF CONCRETE OR FINISHED FACE OF PARTITIONS UNO. SEE PARTITION TYPES SHEETS (A1000 SERIES) FOR PARTITION THICKNESS AND MATERIALS.
- CENTER ITEMS IN CEILING PANELS UNO.
- REFER TO FINISH LEGEND FOR FINISH PLAN SYMBOLS.
- ALL PRECAST CONCRETE PANEL JOINTS TO RECEIVE TWO (2) LINES OF BACKER ROD AND SEALANT.
- ALL WINDOW ROUGH OPENINGS TO HAVE AIR VAPOR BARRIER RETURNED INTO ROUGH OPENINGS.
- ALL COMPOSITE METAL PANEL DETAILS SHALL HAVE AIR VAPOR BARRIER TERMINATE ONTO THE PRECAST PANEL. THE TERMINATION POINT TO BE PLACED CLOSER TO INTERIOR FACE OF PRECAST FOR EASE OF DETAILING AT THESE CONDITIONS.


ABBREVIATIONS

AC	AIR CONDITIONING	ICRA	INFERENCE CONTROL RISK ASSESSMENT	S	SEALED
ACC	ACCESSIBLE	ILSM	INTERIM LIFE SAFETY MEASURE	SDF	STATIC DISSIPATIVE FLOORING
ACM	ASBESTOS CONTAINING MATERIAL	INST	INSTALLED	SECT	SECTION
ADJ	ADJACENT	INSUL	INSULATION / INSULATED	SHR	SHOWER
AFF	ABOVE FINISHED FLOOR	INT	INTERIOR	SHT	SHEET
AGF	ARCHITECTURAL GLASS FLOORING	JAN	JANITOR	SM	SPECIALIZED METAL
ALUM	ALUMINUM	JCAP	J CAP SPACE MOULDING	SOG	SLAB-ON-GRADE
ALT	ALTERNATE	JOINT	JOINT	SP	SPECIFY / SPECIFICATION
APC	ADJUSTICAL PANEL CEILING	KIT	KITCHEN	SPF	SPRAYED POLYURETHANE FOAM
ARCH	ARCHITECT (URAL)	LAB	LABORATORY	SQ	SQUARE
ASN	ABRASIVE STAIR NOSING	LAM	LAMINATE(D)	SS	SOLID SURFACE / SURFACING
ATC	ACOUSTICAL TILE CEILING	LAV	LAVATORY	SST	STAINLESS STEEL
AUTO	AUTOMATIC	LGT	LENGTH	ST	STONE
AWP	ADJUSTICAL WALL PANEL	LH	LEFT HAND	STC	SOUND TRANSMISSION CLASS
BLDG	BUILDING	LIN	LINE	STD	STANDARD
BLKG	BLOCKING	LP	LOW POINT	STL	STEEL
BRG	BEARING	LT	LIGHT	STOR	STORAGE
BSMT	BASEMENT	LTWT	LIGHTWEIGHT	STRUC	STRUCTURE / STRUCTURAL
C	COURSE	LVT	LUXURY VINYL TILE	SUSP	SUSPENDED
CFCI	CONTRACTOR FURNISHED - CONTRACTOR INSTALLED	MACH	MACHINE	SV	SHEET VINYL
CF	CONDUCTIVE FLOORING	MARB	MARBLE	SWC	SPECIAL WALL COATING
CFMF	COLD-FORMED METAL FRAMING	MATL	MATERIAL	T	TREAD
CG	CORNER GUARD	MAS	MASONRY	TBD	TO BE DETERMINED
CIP	CAST-IN-PLACE	MATL	MATERIAL	TEMP	TEMPORARY
CJ	CONTROL JOINT	MAY	MAXIMUM	TER	TERRAZZO
CLG	CLOSE	MB	MARKER BOARD	TERB	TERRAZZO BASE
CLO	CLOSET	MCM	METAL COMPOSITE MATERIAL	TEXT	TEXTURE
CLR	CLEAR(ANCE)	MES	METAL EDGE STRIP	THK	THICKNESS
CLRM	CLASSROOM	MECH	MECHANICAL	TLT	TOILET
CLT	CERAMIC TILE	MEZ	MEZZANINE	TOS	TOP OF STEEL
CMT	CERAMIC MOSAIC TILE	MFR	MANUFACTURER / MANUFACTURED	TOW	TOP OF WALL
CMTB	CERAMIC MOSAIC TILE BASE	MIN	MINIMUM	TP	TANGENT POINT
CMU	CONCRETE MASONRY UNIT	MO	MISCELLANEOUS	TS	TACKLE SURFACE
CO	COLUMN	MISC	MASONRY OPENING	TRSLT	TRANSLUCENT
COL	COMMUNICATION	MPC	METAL PANEL CEILING	TRUC	TYPICAL
COMM	COMMUNICATION	MSS	METAL SUSPENSION SYSTEM	T&G	TONGUE & GROOVE
CONC	CONCRETE	MW	MILLWORK	UC	UNDERCOUNTER
CONF	CONFERENCE	NIC	NOT IN CONTRACT	UPH	UPHOLSTERY
CONT	CONTINUOUS	NO	NUMBER	UNO	UNLESS NOTED OTHERWISE
CONTR	CONTRACT(OR)	NOM	NOMINAL	VAC	VACUUM
CORR	CORRIDOR	NTS	NOT TO SCALE	VAC	VACUUM
CPT	CARPET(ING)	OC	ON CENTER	VC	VINYL COMPOSITION TILE
CR	CRASH RAIL	OD	OUTSIDE DIAMETER	VCT	VINYL COMPOSITION TILE
CT	CERAMIC TILE	OF	OWNER FURNISHED - OWNER INSTALLED	VEST	VESTIBULE
CTB	CERAMIC TILE BASE	OFI	OWNER FURNISHED - OWNER INSTALLED	VET	VINYL ENHANCED TILE
CUH	CABINET UNIT HEATER	OH	OVERHEAD	VIF	VINYL IN FIELD
CW	CASEWORK	OP	OPENING	VNL	VENT THROUGH ROOF
DEMO	DEMOLISH / DEMOLITION	OPG	OPPOSITE	VVC	VINYL WALL COVERING
DEPT	DEPARTMENT	ORD	OVERFLOW ROOF DRAIN	WAF	WOOD ATHLETIC FLOORING
DIA	DIAMETER	PBD	PARTICLE BOARD	WC	WATER CLOSET
DIAG	DIAGONAL	PCC	PRECAST CONCRETE	WCV	WALL COVERING
DN	DOWN	PCF	POUNDS PER CUBIC FOOT	WDB	WOOD
DS	DOWNSPOUT	PCNC	POLISHED CONCRETE	WDWTR	WINDOW TREATMENT
EA	EACH	PERF	PERFORATE(D)	WP	WORK POINT
EAS	EXTERIOR INSULATION FINISH SYSTEM	PL	PLATE	WPC	WOOD PANEL CEILING
EJ	EXPANSION JOINT	PLP	PLASTIC PANEL	WT	WEIGHT
ELEC	ELECTRICAL	PLYWD	PLYWOOD		
ELEV	ELEVATOR	PREFAB	PREFABRICATED		
EM	ENTRANCE MATS	PREFIN	PREFINISHED		
EMB	ELECTRONIC MARKER BOARD	PRT	POLY RESIN TILE		
EMER	EMERGENCY	PSF	POUNDS PER SQUARE FOOT		
EOS	EDGE OF SLAB	PSI	POUNDS PER SQUARE INCH		
EQ	EQUAL	PLSHD	POLISHED		
EQUIP	EQUIPMENT	PMT	PORCELAIN MOSAIC TILE		
ER	EPoxy RESIN	PNT	PAINTED		
EST	ESTIMATE(D)	PT	PORCELAIN TILE		
EXH	EXHAUST	PTB	PORCELAIN TILE BASE		
EXIST	EXISTING				
EXP	EXPANSION	QT	QUARRY TILE		
EXPD	EXPOSED	QTB	QUARRY TILE BASE		
EXT	EXTERIOR	QTY	QUANTITY		
EWC	ELECTRIC WATER COOLER	R	RISER		
FD	FLOOR DRAIN	RAD	RADIUS		
FDTN	FOUNDATION	RAF	RESILIENT ATHLETIC FLOORING		
FE	FIRE EXTINGUISHER	RB	RUBBER FLOORING		
FEC	FIRE EXTINGUISHER CABINET	RBFB	RUBBER FLOORING		
FG	FOOT GRILLE	RCPT	REFLECTED CEILING PLAN		
FHC	FIRE HOSE CABINET	RD	REFER TO / REFERENCE TO		
FIN	FINISH(ED)	REF	REFER TO / REFERENCE TO		
FLR	FLOOR	REFG	REFRIGERATOR		
FRT	FIRE RETARDANT TREATED	RENF	REINFORCED / REINFORCING		
FT	FOOT/FEET	REQD	REQUIRED		
FTG	FOOTING	RES	RESILIENT		
FURN	FURNISHED / FURNISHINGS	RESB	RESILIENT BASE		
FWP	FABRIC WRAPPED PANEL	REV	REVISE / REVISION		
GA	GAUZE / GAGE	RF	RESINIOUS FLOORING		
GALV	GALVANIZED	RFG	RIGHT HAND		
GFRFC	GLASS FIBER REINF CONCRETE	RM	ROOM		
GFRG	GLASS FIBER REINF GYPSUM	RO	ROUGH OPENING		
GL	GLASS	ROW	RIGHT OF WAY		
GLMT	GLASS MOSAIC TILE	RSN	RESILIENT STAIR NOSING		
GLMU	GLASS MASONRY UNIT	RST	RESILIENT STAIR TREAD		
GLT	GLASS TILE	RT	RESILIENT TILE		
GST	GLASS STAIR TREAD	RTU	ROOF TOP UNIT		
GWB	GYPSUM WALL BOARD	RV	RIGID VINYL		
GYP	GYPSUM				
HDW	HARDWARE				
HM	HOLLOW METAL				
HORIZ	HORIZONTAL				
HOSP	HOSPITAL				
HP	HIGH POINT				
HPC	HIGH PERFORMANCE COATING				
HPOL	HIGH PRESSURE DECORATIVE LAMINATE				
HR	HANDRAIL				
HSS	HOLLOW STRUCTURAL SECTION				
HGT	HEIGHT				
HVAC	HEATING-VENTILATING-AIR CONDITIONING				
HWB	HEAT WELDING BEAD				

CONSTRUCTION DOCUMENTS - FINAL BID DOCUMENTS

<p>Revisions:</p>	<p>Date</p>	<p>CONSULTANTS:</p> <p> Landmark Engineering Group, Inc. Civil Engineer 2834 104th Street Urbandale, IA 50322 515.221.1322 SidePlate Steel Frame 25909 Pala, Ste 200, 92691 Mission Viejo, CA 949.305.7889 </p>				<p> Gateway Geotechnical, LLC Geotechnical Engineer 1738 Edison Avenue Chesterfield, MO 63005 636.532.7747 </p>				<p> SWT Design Landscape Architect 7722 Big Bend Boulevard St. Louis, MO 63119 314.644.5700 </p>				<p> Himman Consulting Engineers, Inc. Physical Security One Bush Street, Suite 510 San Francisco, CA 94104 415.621.4423 </p>				<p> The Schachinger Group Elevator 4255 Stonery Creek Drive Fort Collins, CO 80525 970.698.2253 </p>			
		<p>ARCHITECT/ENGINEERS:</p> <p align="center">CANNONDESIGN</p> <p>© CannonDesign 2014 All rights reserved. No part of this document may be reproduced or utilized in any form, without prior written authorization by The Cannon Corporation.</p>		<p>Drawing Title</p> <p align="center">SYMBOLS & ABBREVIATIONS</p> <p>Approved: Project Director</p>				<p>Project Title</p> <p align="center">John J. Pershing VAMC Clinical & Urgent Care Addition</p> <p>Location Poplar Bluff, Missouri</p> <p>Date DEC 14, 2015</p>				<p>Project Number 657-351 <small>CANNON DESIGN PROJECT NO. 0385.05</small></p> <p>Building Number</p> <p>Drawing Number GI-003</p> <p>Dwg. of</p>				<p align="center">Office of Construction and Facilities Management</p> <p align="center">Department of Veterans Affairs</p>					

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 one and one half inches = one foot
 one inch = one foot
 three quarters inch = one foot
 one half inch = one foot
 three eighths inch = one foot
 one quarter inch = one foot
 one eighth inch = one foot
 one sixteenth inch = one foot

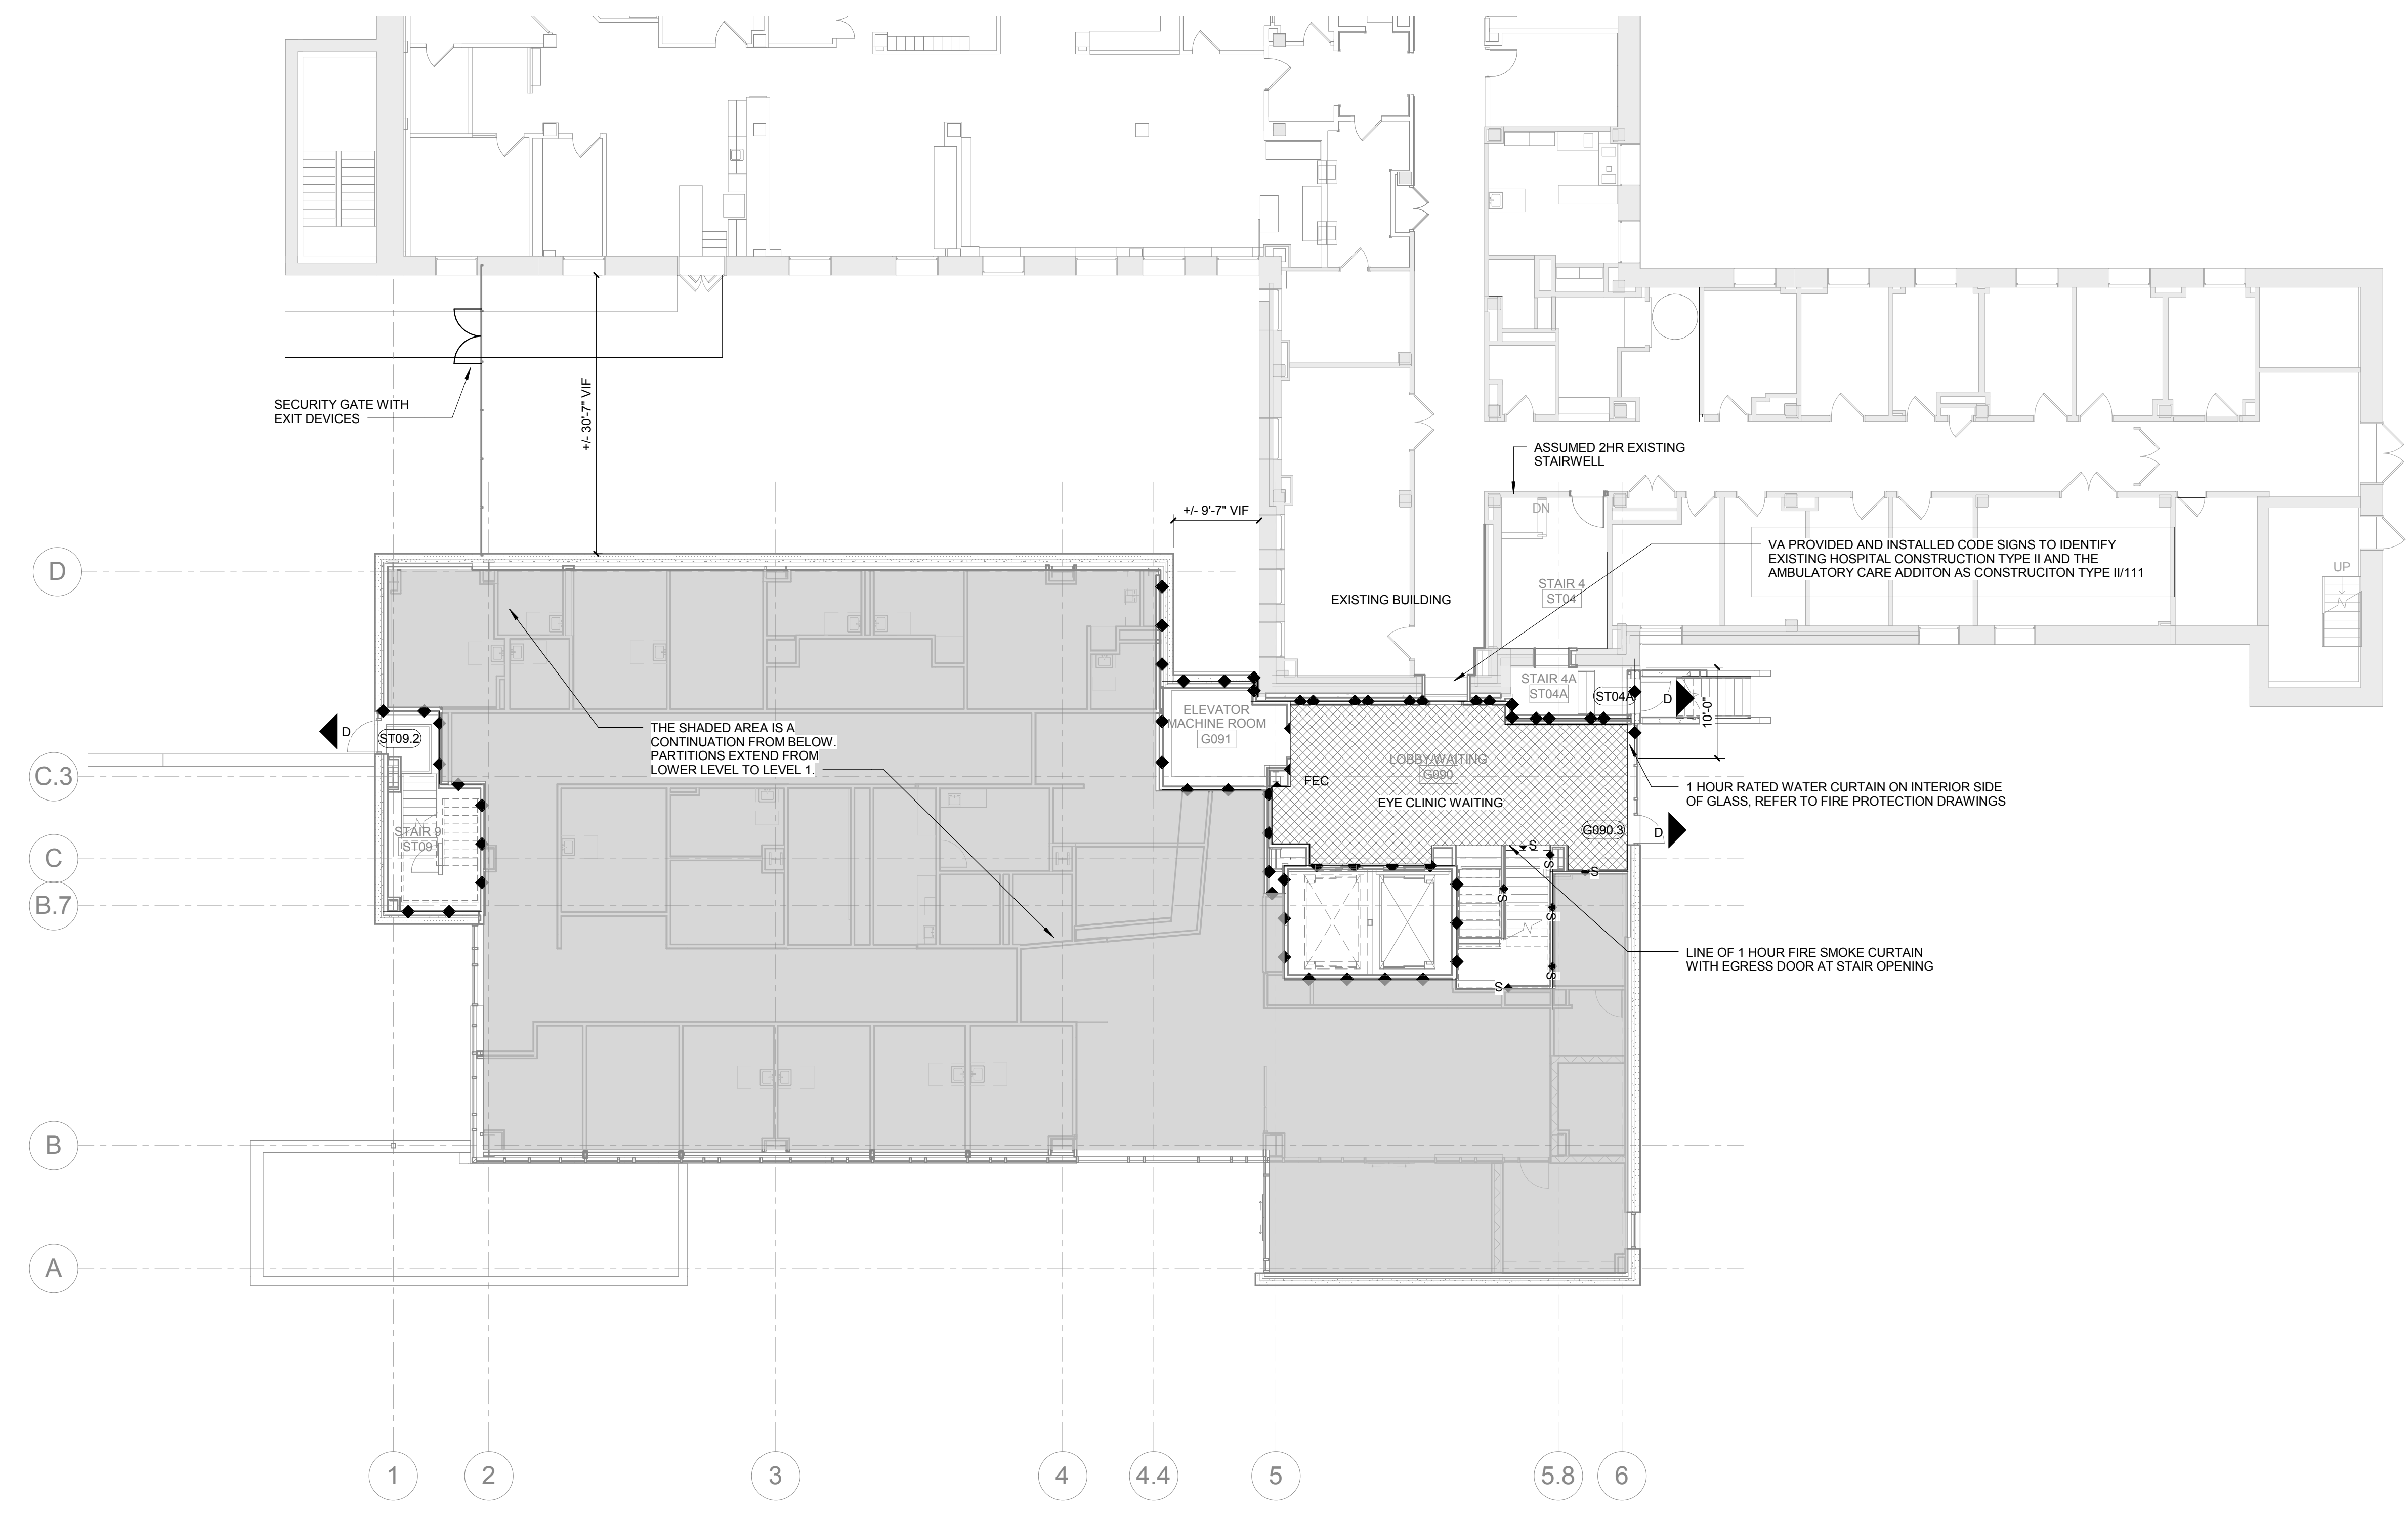

4F GROUND LEVEL FLOOR PLAN
 3/32" = 1'-0" REF 5C / AS-201

CONSTRUCTION DOCUMENTS - FINAL BID DOCUMENTS

1	FINAL BID PACKAGE	12/14/15
Revisions:		Date

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SidePlate
Steel Frame
25909 Pala, Ste 200, 92691
Mission Viejo, CA
949.305.7889

ARCHITECT/ENGINEERS:

CANNONDESIGN

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Drawing Title
GROUND LEVEL CODE COMPLIANCE PLAN

Approved: Project Director

Project Title
John J. Pershing VAMC Clinical & Urgent Care Addition

Location
Poplar Bluff, Missouri

Date
DEC 14, 2015

Checked
 Checker

Drawn
 Author

Project Number
657-351
CANNON DESIGN PROJECT NO. 0385.05

Building Number

Drawing Number
GC-102



Dwg. of

Office of Construction and Facilities Management


Department of Veterans Affairs

NOTES


- THE PURPOSE OF THE CONSTRUCTION PHASING NOTES IS TO PROVIDE THE GENERAL CONTRACTOR GUIDANCE FOR THE CONSTRUCTION SCHEDULE. THE GENERAL CONTRACTOR SHALL COORDINATE WITH THE CONTRACTING OFFICER REPRESENTATIVE AND THE RESIDENT ENGINEER TO DEVELOP A CPM SCHEDULE, SEQUENCING, COMPLETION DATES FOR NEW CONSTRUCTION, RENOVATION AND CONSTRUCTION ISSUES AFFECTING CONTINUAL OPERATIONS OF THE MEDICAL CENTER.
- THE SITE PLAN ON THIS SHEET IDENTIFIES ZONES OF WORK FOR EACH PHASE DESCRIBED BELOW. THIS DIAGRAM IS PROVIDED FOR THE SOLE PURPOSE OF ILLUSTRATING A SINGLE WAY TO CONSIDER PHASING THE PROJECT. IT IS THE RESPONSIBILITY OF THE CONTRACTOR TO PROPOSE A PHASING PLAN TO MEET THE REQUIREMENTS OF THE CONSTRUCTION CONTRACT. REFER TO THE REMAINDER OF THE CONSTRUCTION DOCUMENTS FOR THE SCOPE OF WORK IN THESE AREAS.
- PHASE A1: TEMPORARY CONSTRUCTION AREAS INSTALL CHAINLINK CONSTRUCTION FENCING TO ENCLOSE ENTIRE CONSTRUCTION SITE. INCLUDE FENCING TO SUBDIVIDE REQUIRED HOSPITAL ACCESS POINTS.
 - SET UP JOB TRAILERS AND RESIDENT ENGINEER FACILITIES.
 - PROVIDE LAY DOWN AND PARKING AREAS FOR CONSTRUCTION.
 - PROVIDE TEMPORARY UTILITIES TO CONSTRUCTION SITE AS REQUIRED.
- PHASE A2: BID ALTERNATE 2 IF ACCEPTED WILL TAKE PLACE FIRST
- PHASE B: SITE DEMOLITION, GRADING AND RELOCATION OF UTILITIES
- PHASE C: SITE FENCING, BUILDING ADDITION, PLAZA AREAS AND TIE-IN TO EXISTING HOSPITAL
- PHASE D: INTERIOR RENOVATIONS FOR EYE CLINIC
- PHASE E: FIRST PHASE OF PARKING AND DRIVEWAY RENOVATIONS
- PHASE F: PARKING EXPANSION AREA
- PHASE G: SECOND PHASE OF PARKING RENOVATIONS
- CONTRACTOR SHALL SEEK FINAL APPROVAL OF THE LOCATION OF CONSTRUCTION FENCING, TEMPORARY CONSTRUCTION BARRIERS, CONTRACTOR SITE ACCESS AND DEBRIS AND MATERIAL HAUL ROUTES WITH THE CONTRACTING OFFICER REPRESENTATIVE AND THE RESIDENT ENGINEER.
- DURING CONSTRUCTION, THE CONTRACTOR SHALL MAINTAIN ALL EXISTING ACCESS POINTS IDENTIFIED ON THE DRAWINGS. PROVIDE TEMPORARY PROVISIONS REQUIRED TO REROUTE THROUGH THE CONSTRUCTION SITE AS REQUIRED TO PROVIDE SAFE, SEPARATE CONTINUATION TO EXIT TO AREAS OUTSIDE THE CONSTRUCTION ACTIVITIES. PROVIDE REQUIRED CHAINLINK FENCING, GATES, ENCLOSURES, SIDEWALKS, ETC. TO PROTECT THESE AREAS.
- MAINTAIN ALL FIRE BARRIERS AND DUST PARTITIONS AS REQUIRED TO PROVIDE A DUST-FREE AND CLEAN ENVIRONMENT BETWEEN RENOVATED AREAS WITHIN THE HOSPITAL AND AREAS ADJACENT TO RENOVATED AND NEW CONSTRUCTION.
- COORDINATE ANY UTILITY SHUT DOWNS OR ANY CONSTRUCTION ACTIVITIES WHICH MAY POTENTIALLY AFFECT THE EXISTING OPERATIONS OF THE MEDICAL CENTER WITH THE CONTRACTING OFFICER REPRESENTATIVE AND RESIDENT ENGINEER. MAINTAIN UNINTERRUPTED OPERATION OF THE EXISTING FACILITIES, AND MINIMIZE DISRUPTION TO THE MEDICAL CENTER FOR ALL SWITCHOVER OF UTILITIES. SCHEDULE THESE EVENTS AFTER HOURS OR AS APPROVED BY THE CONTRACTING OFFICER REPRESENTATIVE AND THE RESIDENT ENGINEER.
- MAINTAIN ACCESS TO ALL EXISTING BUILDINGS, UTILITIES AND FACILITIES WITHIN THE CONSTRUCTION LIMITS TO ACCESS EQUIPMENT AND TO PROVIDE SERVICE OR MAINTENANCE OF EXISTING FACILITIES AND EQUIPMENT SERVING THE MEDICAL CENTER.
- ISOLATE HVAC SYSTEM IN AREA WHERE WORK IS BEING DONE TO PREVENT CONTAMINATION OF DUCT SYSTEM.
- COMPLETE ALL CRITICAL BARRIERS BEFORE CONSTRUCTION WORK BEGINS.
- MAINTAIN NEGATIVE PRESSURE WITHIN WORK SITE USING HEPA EQUIPPED AIR FILTRATION UNITS.
- SEAL HOLES, PIPES, CONDUITS AND PUNCTURES APPROPRIATELY.
- ALL PERSONNEL ENTERING WORK SITE ARE REQUIRED TO WEAR SHOE COVERS. SHOE COVERS MUST BE CHANGED EACH TIME THE WORKER EXITS THE WORK AREA.
- PROVIDE ADHESIVE WALK-OFF MATS AT ENTRANCE TO WORK AREA.
- IF THERE IS AN ANTEROOM, A MAT SHOULD BE WITHIN THIS AREA. REPLACE MATS DAILY OR WHEN THEY NO LONGER ARE ABLE TO CONTAIN DUST AND DIRT.
- WET MOP AND/OR VACUUM WORK AREA WITH HEPA FILTERED VACUUM BEFORE LEAVING WORK AREAS.
- CONTAIN CONSTRUCTION WASTE BEFORE TRANSPORT IN TIGHTLY COVERED CONTAINERS.
- DO NOT REMOVE BARRIERS FROM WORK AREA UNTIL COMPLETED PROJECT IS THOROUGHLY CLEANED BY THE ENVIRONMENTAL SERVICES.
- REMOVE BARRIER MATERIALS CAREFULLY TO MINIMIZE THE SPREADING OF DIRT AND DEBRIS ASSOCIATED WITH CONSTRUCTION.
- REMOVE HVAC ISOLATION FROM SYSTEM IN AREAS WHERE WORK IS BEING DONE.
- THE GENERAL CONTRACTOR SHALL COORDINATE WITH THE CONTRACTING OFFICER REPRESENTATIVE AND THE RESIDENT ENGINEER TO LOCATE THE SAFETY SIGN AND CONSTRUCTION SIGN.
- THE GENERAL CONTRACTOR SHALL PROVIDE ISOLATION BARRIERS PER DETAIL 6F.

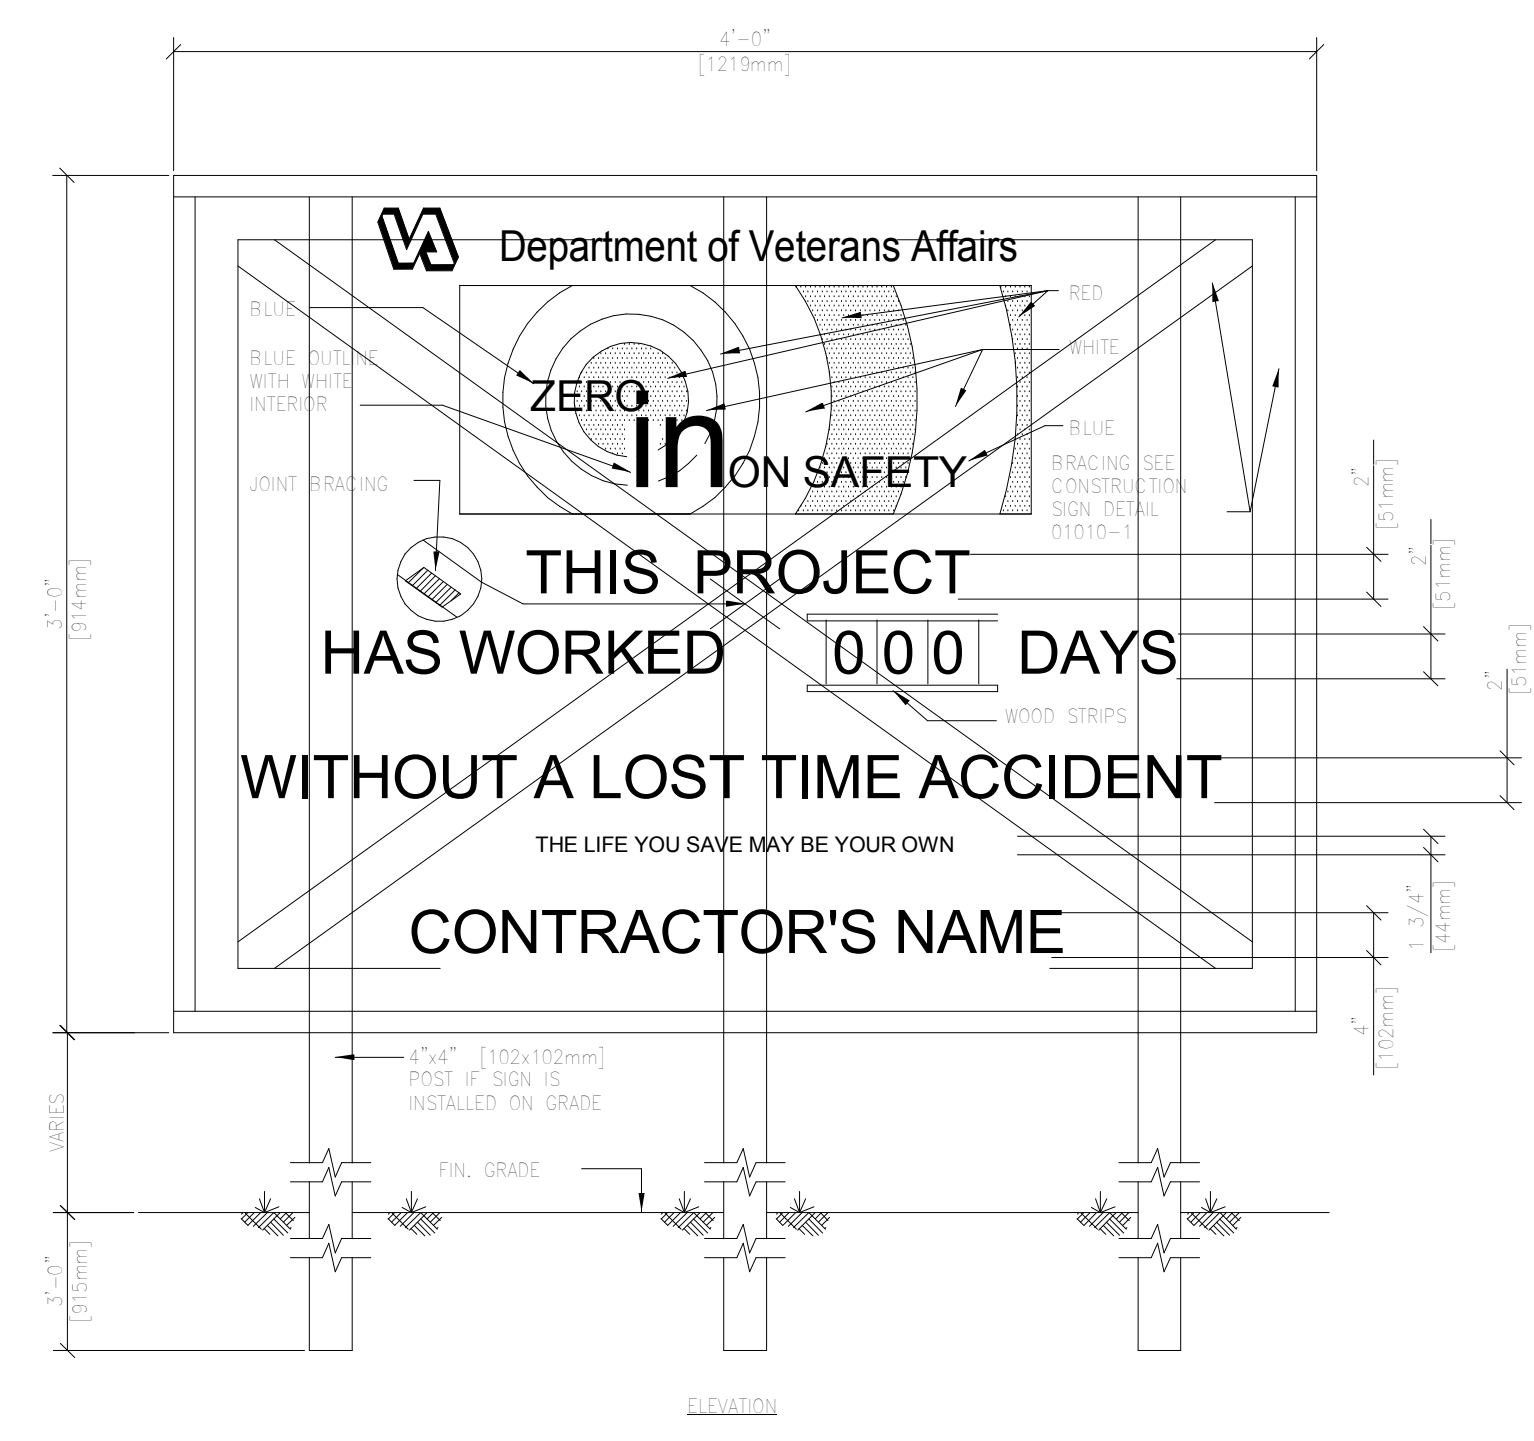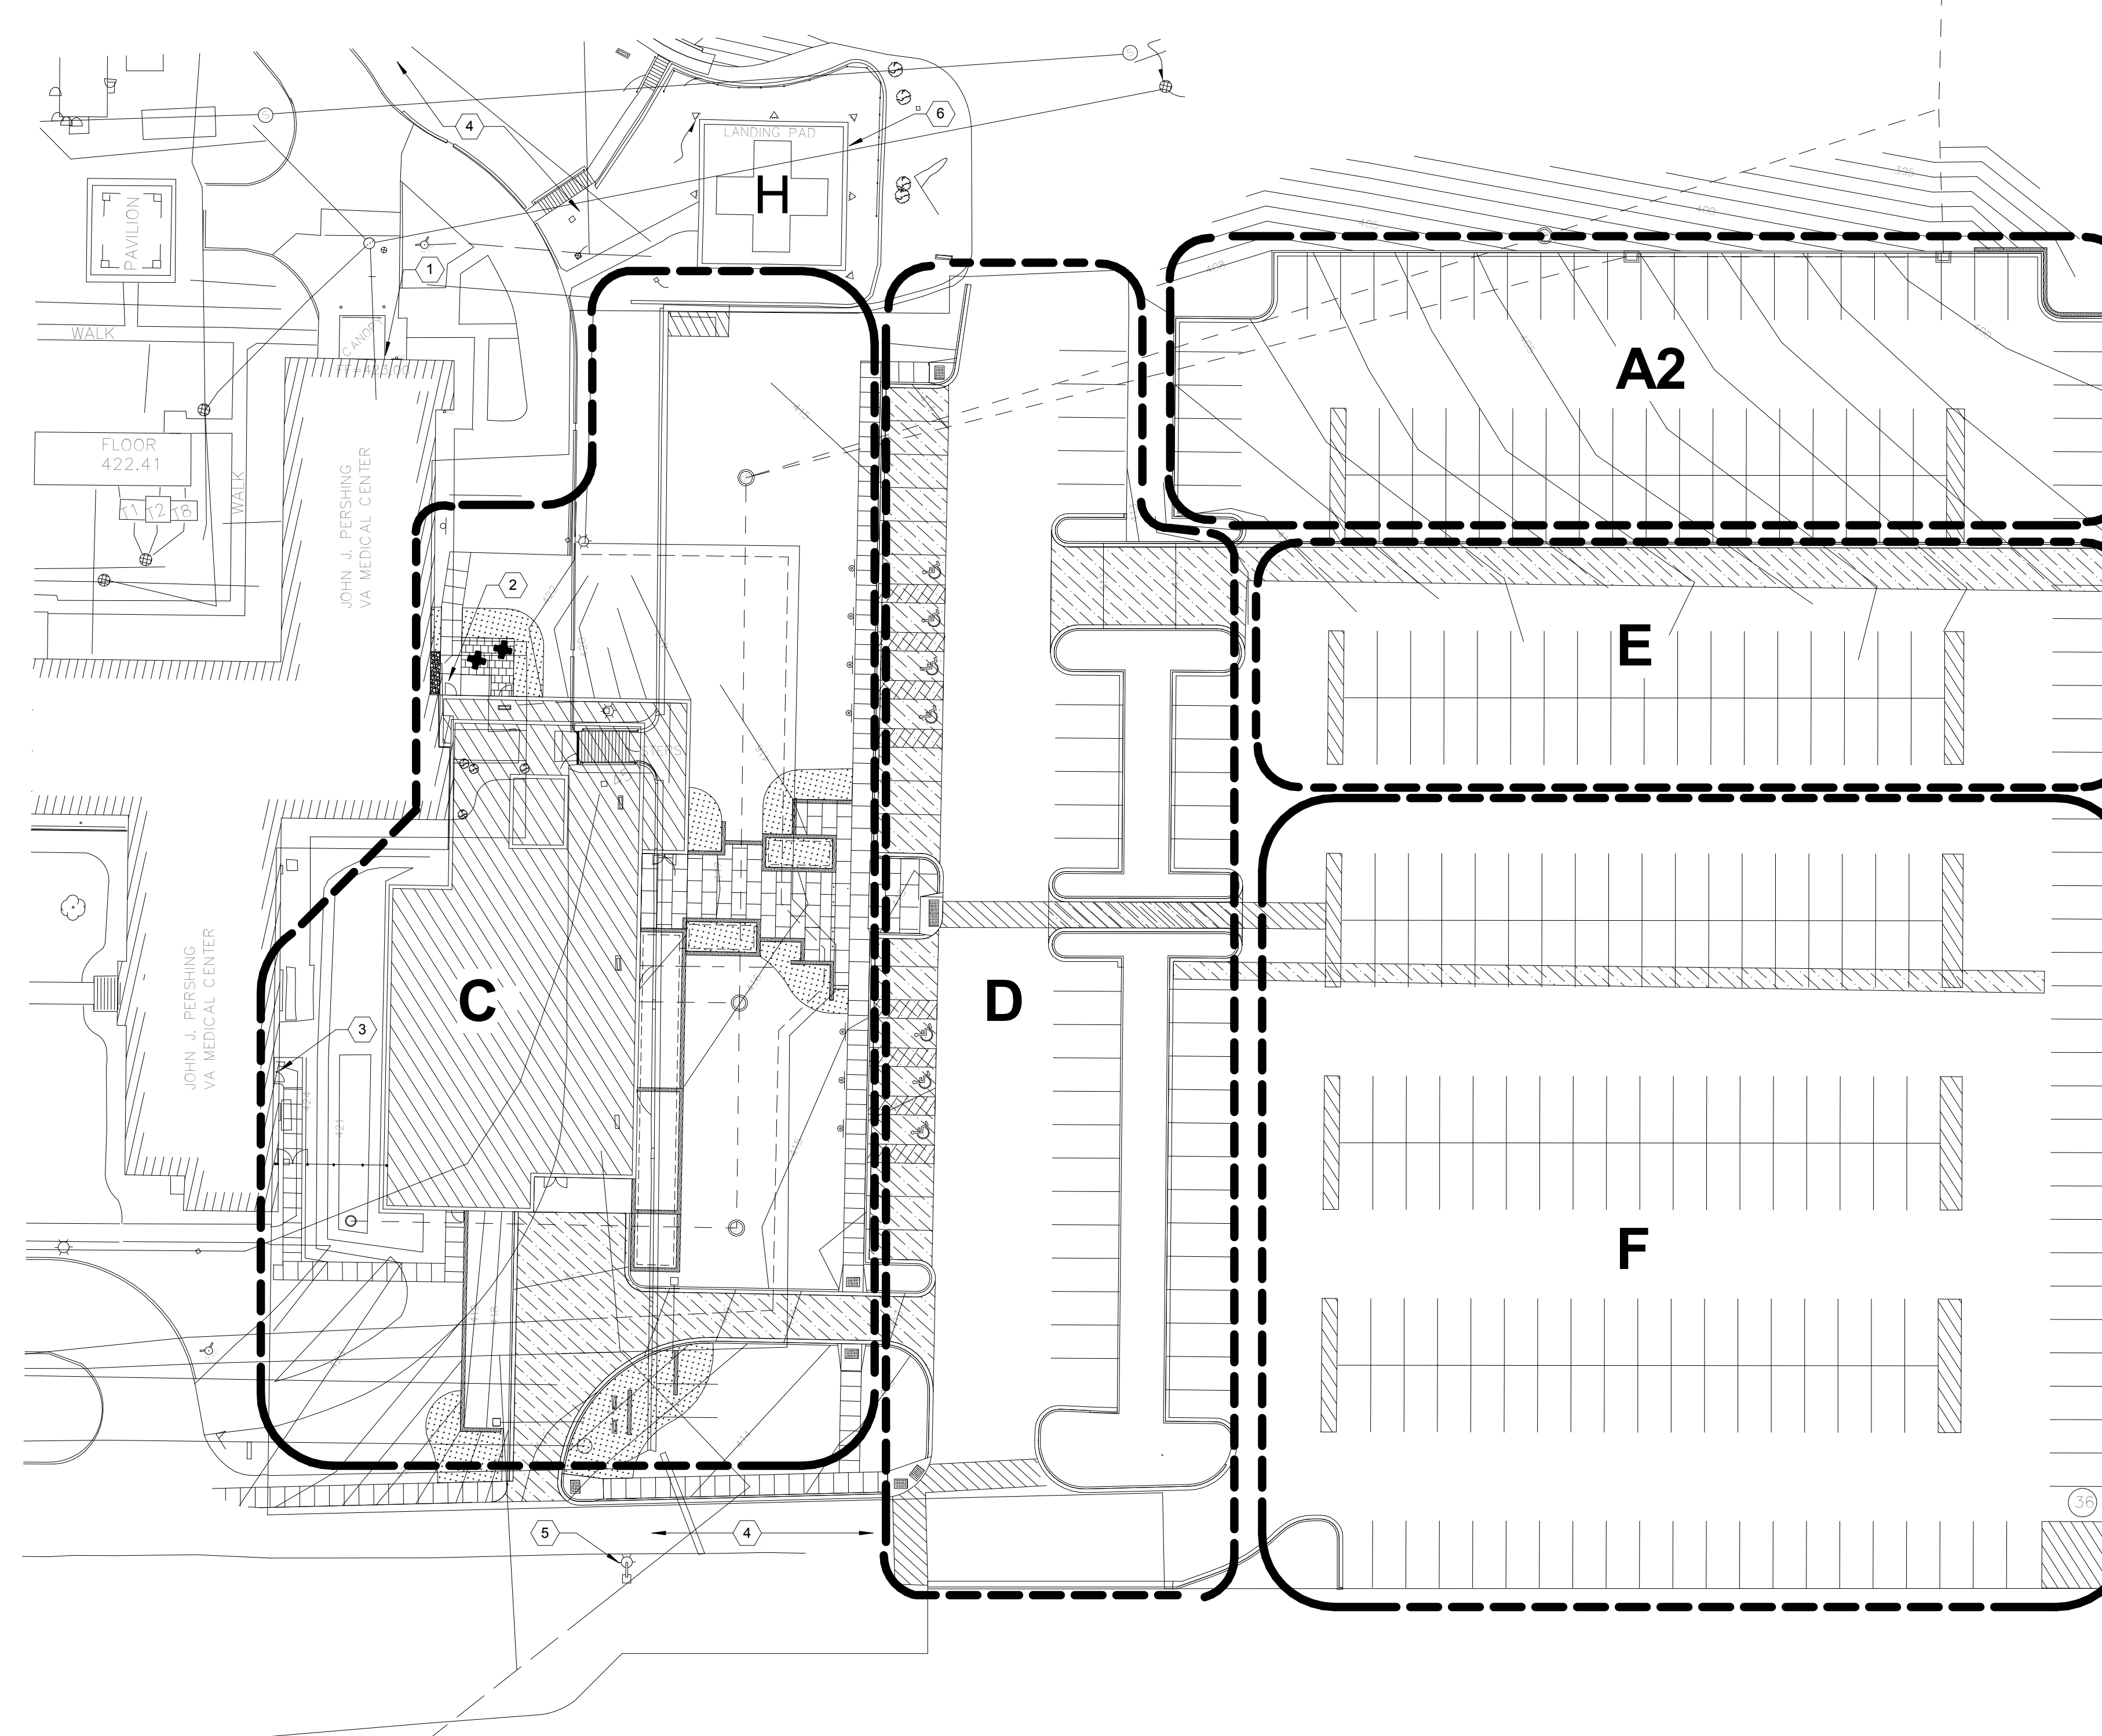

1F SAFETY SIGN
3/8" = 1'-0"

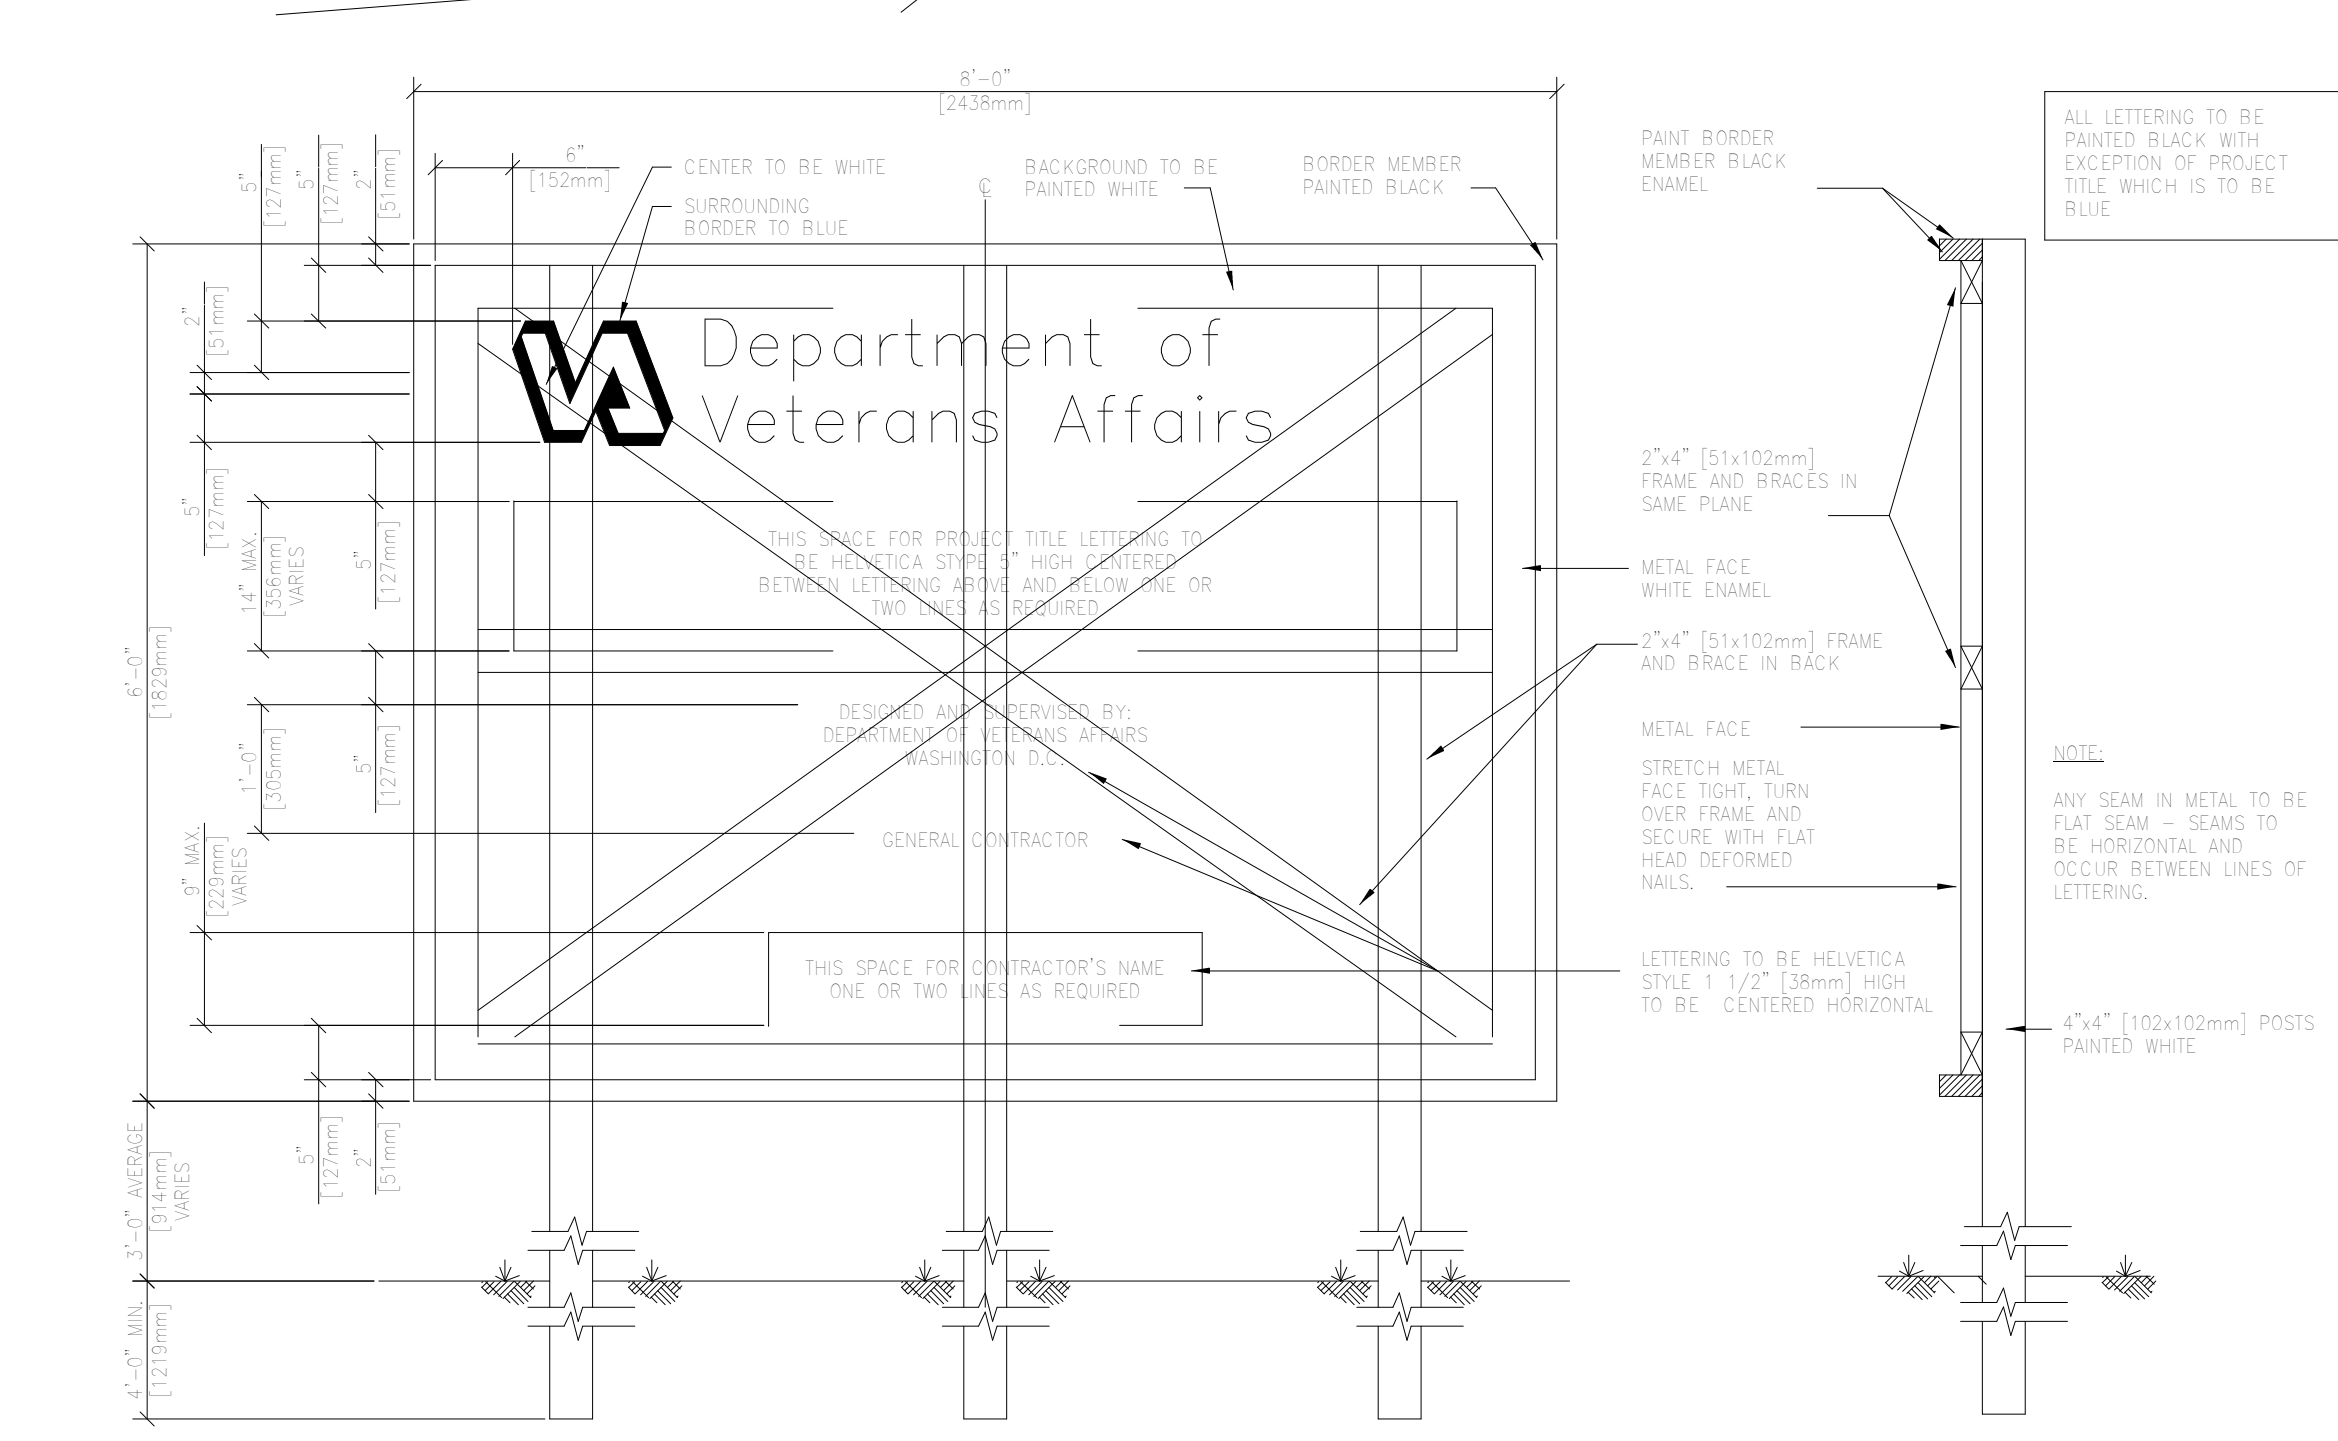

3F CONSTRUCTION SIGN
3/8" = 1'-0"

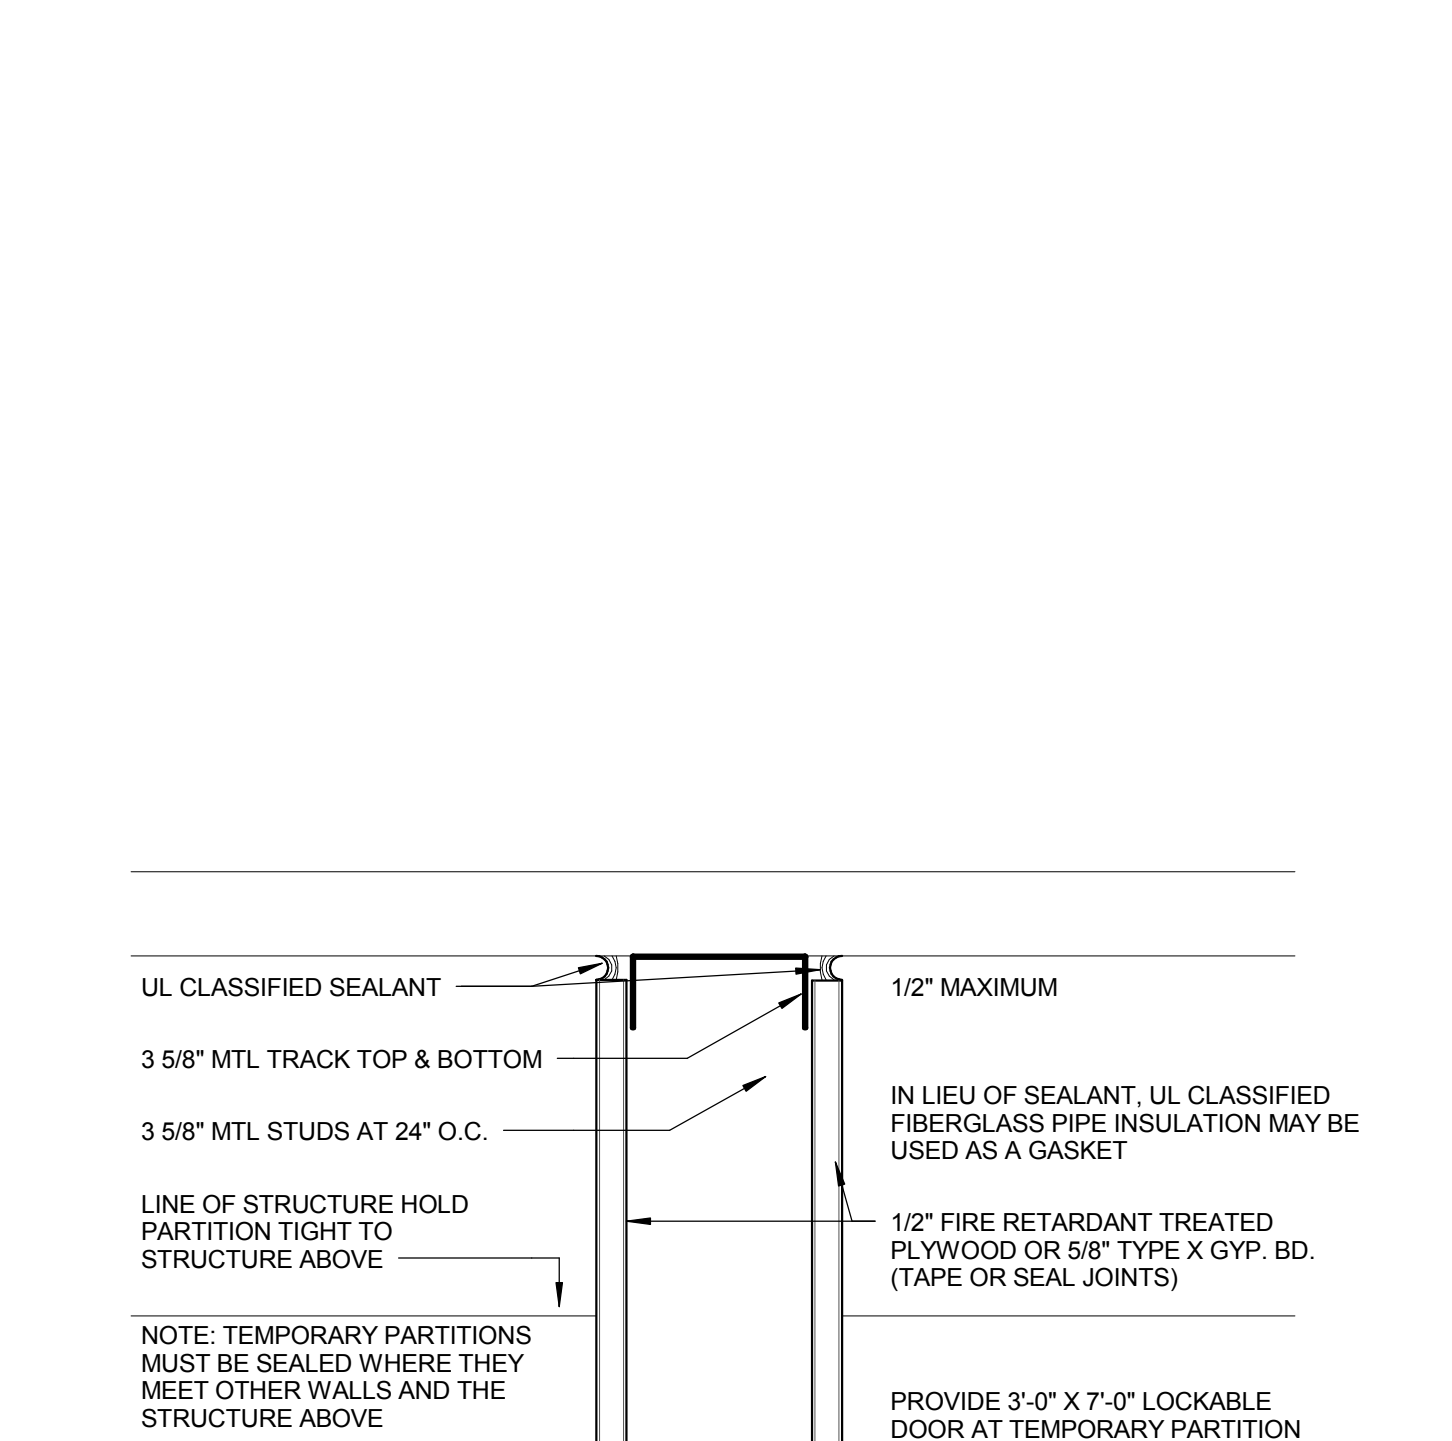

6F VA STANDARD ISOLATION BARRIER

KEYED NOTES

- MAINTAIN ACCESS AT ALL TIMES DURING CONSTRUCTION TO EXISTING HOSPITAL ENTRANCE AT THIS LOCATION.
- MAINTAIN EGRESS AT ALL TIMES DURING CONSTRUCTION FROM EXISTING HOSPITAL STAIR.
- MAINTAIN ACCESS AT ALL TIMES DURING CONSTRUCTION TO PHARMACY ENTRANCE AT THIS LOCATION.
- MAINTAIN ROADWAY ACCESS TO PARKING AT ALL TIMES DURING CONSTRUCTION.
- MAINTAIN ACCESS TO WALKING TRAIL AT ALL TIMES DURING CONSTRUCTION.
- MAINTAIN AT-GRADE AND FLIGHT PATH ACCESS TO HELIPAD AT ALL TIMES DURING CONSTRUCTION.

CONSTRUCTION DOCUMENTS - FINAL BID DOCUMENTS

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