


GENERAL NOTES:

1. REGARDING BATHROOM FAN COIL UNITS SERVING THE PATIENT BATHROOMS THAT ARE TO BE DEMOLISHED ON FLOORS 6, 7 AND 8: THE FOUR PIPE FAN COIL UNITS SERVING THE BATHROOMS IN QUESTION MAY BE LOCATED ABOVE THE CORRIDORS AS SHOWN OR THEY MAY BE LOCATED ABOVE THE BATHROOMS. ALSO THEY MAY SERVE ONLY THE PERIMETER BATHROOMS OR MAY SERVE THE PERIMETER BATHROOMS AND THE BATHROOMS ACROSS THE CORRIDOR. IF A FAN COIL UNIT ONLY SERVES THE BATHROOM TO BE DEMOLISHED THEN THE FAN COIL UNIT SHALL BE REMOVED IN ITS ENTIRETY AS INDICATED ON THE DRAWINGS REGARDLESS OF WHETHER IT IS LOCATED ABOVE THE BATH ROOMS OR ABOVE THE CORRIDOR CEILING. IF A FAN COIL UNIT SERVES THE DEMOLISHED BATHROOMS AND BATHROOMS ACROSS THE CORRIDOR THEN THE FAN COIL UNIT SHALL REMAIN IN PLACE AND IN OPERATION AND ONLY THE DUCTWORK SERVING THE DEMOLISHED BATHROOMS SHALL BE REMOVED.

- DEMOLITION NOTES:**
(THIS SHEET ONLY)
- 1) NO HVAC DEMOLITION WORK THIS FLOOR
 - 2) REMOVE EXISTING ABANDONED STEAM CONNECTOR IN ITS ENTIRETY, REMOVE ALL ASSOCIATED STEAM AND CONDENSATE PIPING; PIPING MUST BE REMOVED TO BELOW FINISH FLOOR LEVEL.
 - 3) FAN COIL UNIT TO REMAIN. SEE PLUMBING DRAWINGS AND ENSURE COOLING COIL CONDENSATE DRAIN MODIFICATIONS ARE COMPLETE AND TESTED PRIOR TO TURNING THIS UNIT BACK INTO SERVICE.
 - 4) CAREFULLY REMOVE EXISTING FAN COIL UNIT AND TURN OVER TO GOVERNMENT. REMOVE HWS/HMR AND CWS/CWR PIPING BACK TO MAINS AND PERMANENTLY CAP AT MAINS AND RENOVULATE. SEE GENERAL NOTES ON SHEET M601 FOR ADDITIONAL REQUIREMENTS. COORDINATE REMOVAL OF COOLING COIL CONDENSATE PIPE WITH PLUMBING WORK.
 - 5) CAREFULLY REMOVE EXISTING FAN COIL AND WALL MOUNTED THERMOSTAT AND RENOVULATE AS SHOWN IN NEW WORK PLAN. COORDINATE NEW COOLING COIL CONDENSATE DRAIN WITH CONDENSATE DRAIN PIPING MODIFICATIONS SHOWN ON PLUMBING DRAWINGS. ALL PIPE BRANCHES ON REMOVED UNITS MUST BE REMOVED, CAPPED AND MAINS RENOVULATED.
 - 6) EXISTING ABOVE CEILING FAN COIL UNIT TO REMAIN.
 - 7) REMOVE EXISTING ABOVE CEILING FAN COIL UNIT IN ITS ENTIRETY. REMOVE ALL ASSOCIATED CWS/CWR, HWS/HMR, AND CONDENSATE PIPING BACK TO MAINS. PERMANENTLY CAP AND RENOVULATE MAINS.

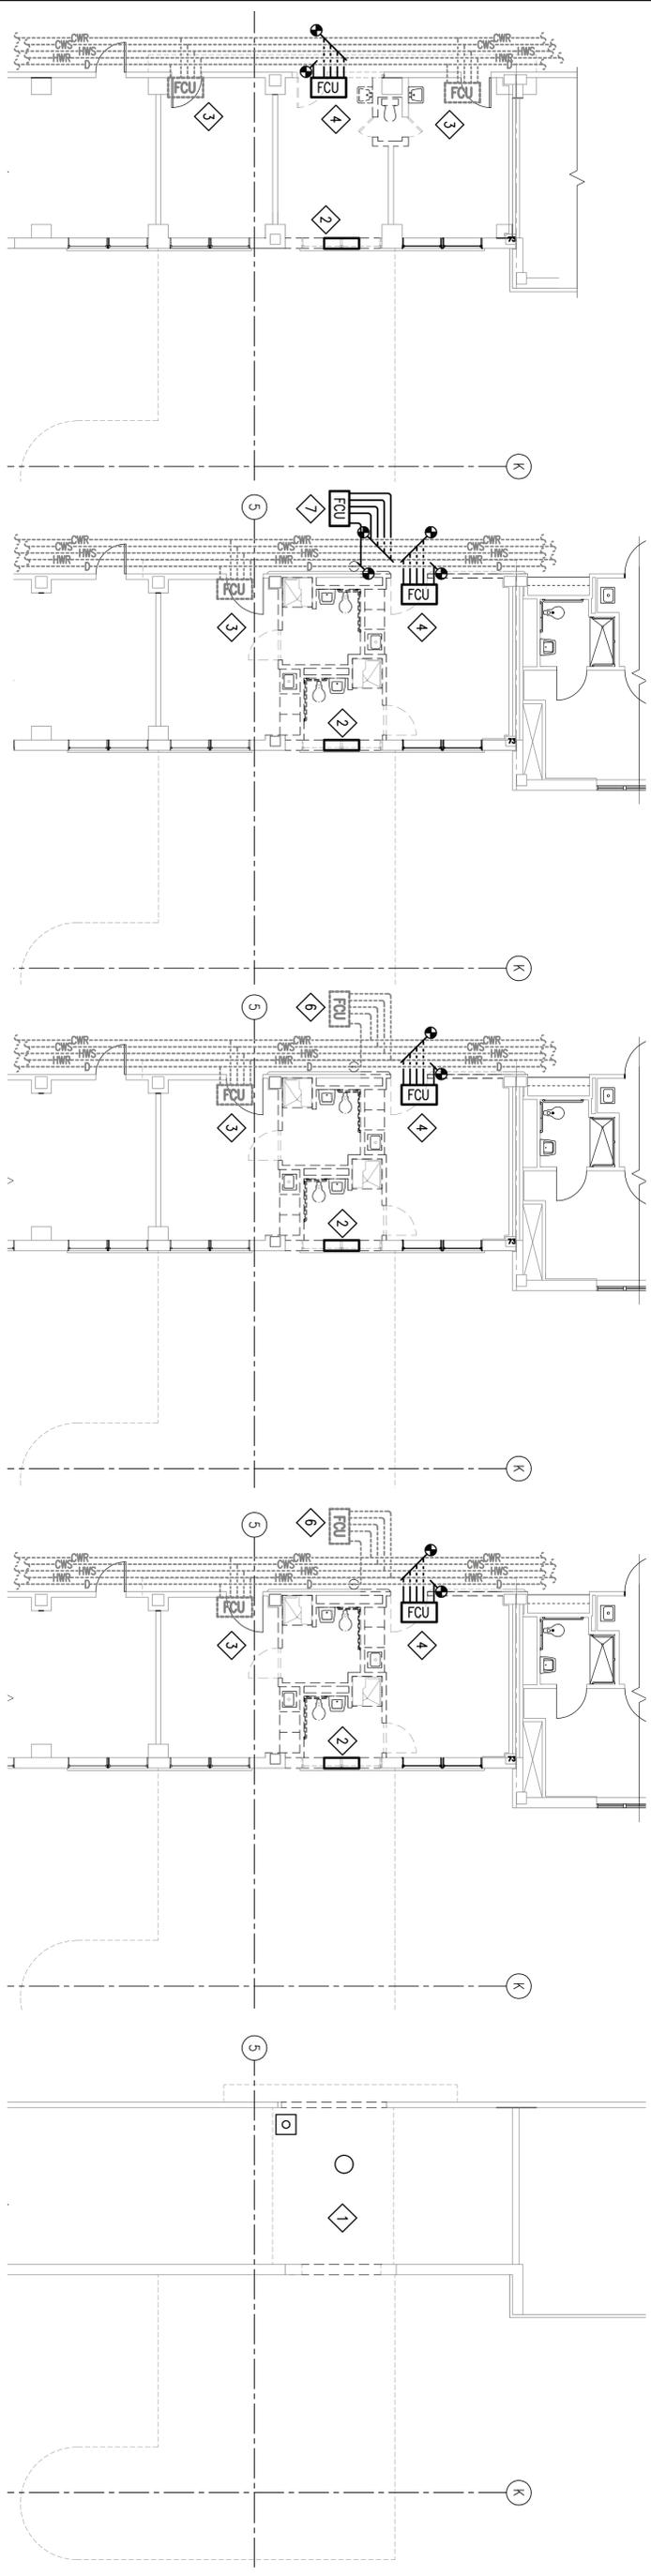

PIPING DEMOLITION
5TH FLOOR – MECHANICAL
SCALE: 1/8" = 1'-0"

PIPING DEMOLITION
6TH FLOOR – MECHANICAL
SCALE: 1/8" = 1'-0"

PIPING DEMOLITION
7TH FLOOR – MECHANICAL
SCALE: 1/8" = 1'-0"

PIPING DEMOLITION
8TH FLOOR – MECHANICAL
SCALE: 1/8" = 1'-0"

PIPING DEMOLITION
9TH FLOOR – MECHANICAL
SCALE: 1/8" = 1'-0"

Revisions	Date

Toland ♦ Mizell ♦ Molnar, LLC
590 MEANS STREET NW,
SUITE 200
ATLANTA, GA, 30318
404-214-9774

Drawing Title
**ENLARGED STAIR
PIPING DEMOLITION
FLOOR PLANS – MECHANICAL**

Approved Project Engineer

Project Title
**2ND FLOOR OUTPATIENT
MENTAL HEALTH**

Building Number
BLDG 1 SOUTH WING

Location
VA MEDICAL CENTER
SHREVEPORT, LOUISIANA

Date
05-25-2011

Project No.
VA256-C-1047

Drawing No.
MD102

100% REVIEW
SUBMITTAL

Veterans Administration