

		Α	IR HANDLI	NG UNIT	CHILLED V	VATER C	OIL DAT	Ā			AHL	J DATA	
	REQUIRED COOLING,		REQUIRED L COOLING, E			CFM	IN H2			LABLE CHILLED WATER ERENTIAL, PSI	FAN H.P.	VOLTS/ PHASE	
	33,000		26,000			808	.63			10	1	480/3	
	ELECTRIC HEAT DATA					EXHAUS	T FAN D	ΑΤΑ]			
	UNIT	REQUIRE HEAT, K		DLT/PH	UNIT	CFM	STATIC	VOLT/PH	HP				
	DH-1	17	48	0/3	EF-1 HU-1	80 1200	.25" .25"	110/1 110/1	.125	-			
						1200	.25	110/1		_			
		·								_			
	NOTES:												
	DH-1 SHALL E	BE 2 STAGE	MINIMUM WI	TH CORRES		AGED HEAT	THERMOS	STAT.					
	EF-1 AND HEF LOCAL HAND			E INTERLO	CKED TO RUN	WITH AHU	-1 IN ADD	ITION TO					
	HU-1 Shall e Exhaust rat Wall Mount	TE OF DECC	ON AREA TO B	BE INCREAS			URING DE	ECON EVENT,					
	INSTALL PERA	MANENT FL	OW METER O	N CWS PIP	ING								
	DUCT SHALL	HAVE A MI	NIMUM 1" PRE	SSURE CLA	SSIFICATION,	BASED ON	MAXIMUM	1500 FPM					
	ROUTE MAIN	CONDENSA	TE FROM AHU	J TO NEAR	EST DRAIN.								
	FLEX DUCT SHALL TRANSITION TO RIGID ELBOWS TO THE DIFFUSERS RECT ELBOWS SHALL BE RADIUS TYPE												
	SUPPLY DIFFU EXHAUST GRI							SS. LOSS.					
	TOP OF DOOI	R LOUVER S	SHALL BE INS	TALLED 12'	" FROM TOP O	F DOOR PA	NEL.						
	HANG HU-1 V STRUCTURAL				T TYPE CHAN	NELS. BOT	rom of						
	GABLE EXHAL	JST BACKD	RAFT DAMPE	rs basis of	F DESIGN GRE	ENHECK W	D300 SERI	ES.					
	CONTRACTOR SUPERVISION AUTOMATION TO BID.	OF THE DE	ECON BUILDIN	IG HVAC SY	YSTEM BY THE	VA COMPL	EX MAIN E	BUILDING					
							Consulta	ants:					
										BURK-	(FINPF'	TFF
								Bk		ENGINEERS, ARCHI	TECTS,	PLANNERS, EN	VIRONME
							•			4176 CANAL STRE PHONE (504)486			
Revisions					Date								

1 HVAC SUPPLY PLAN M201 SCALE: 3/8" = 1'-0"

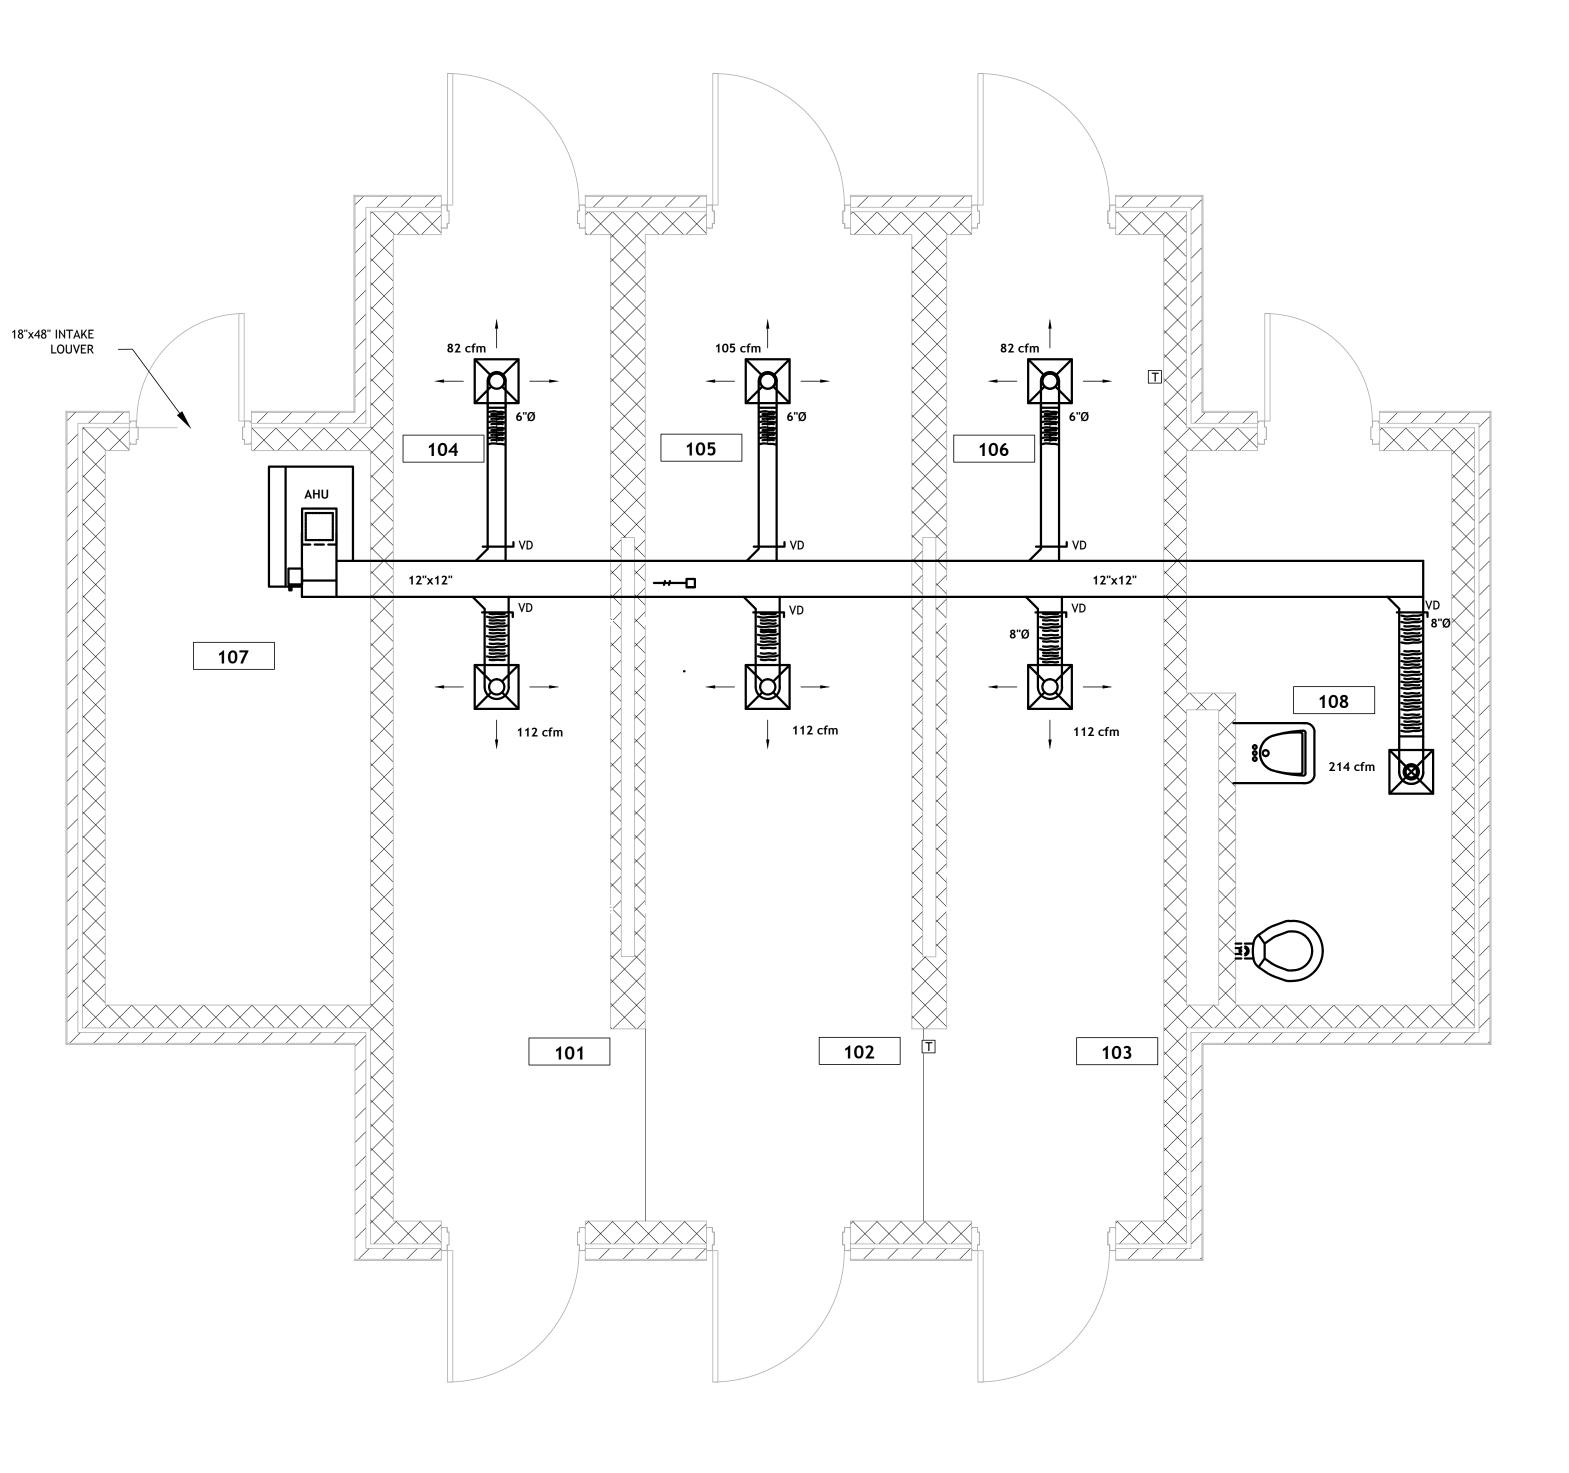


3



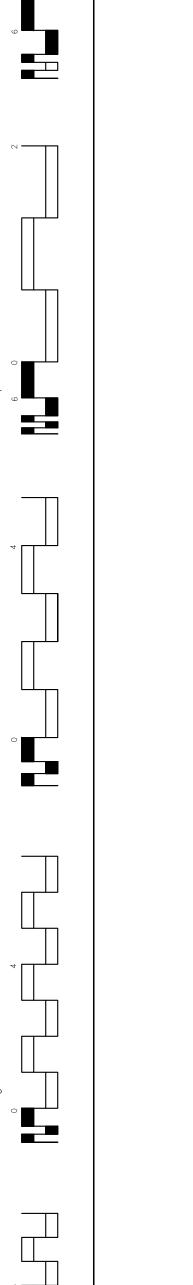


I

2

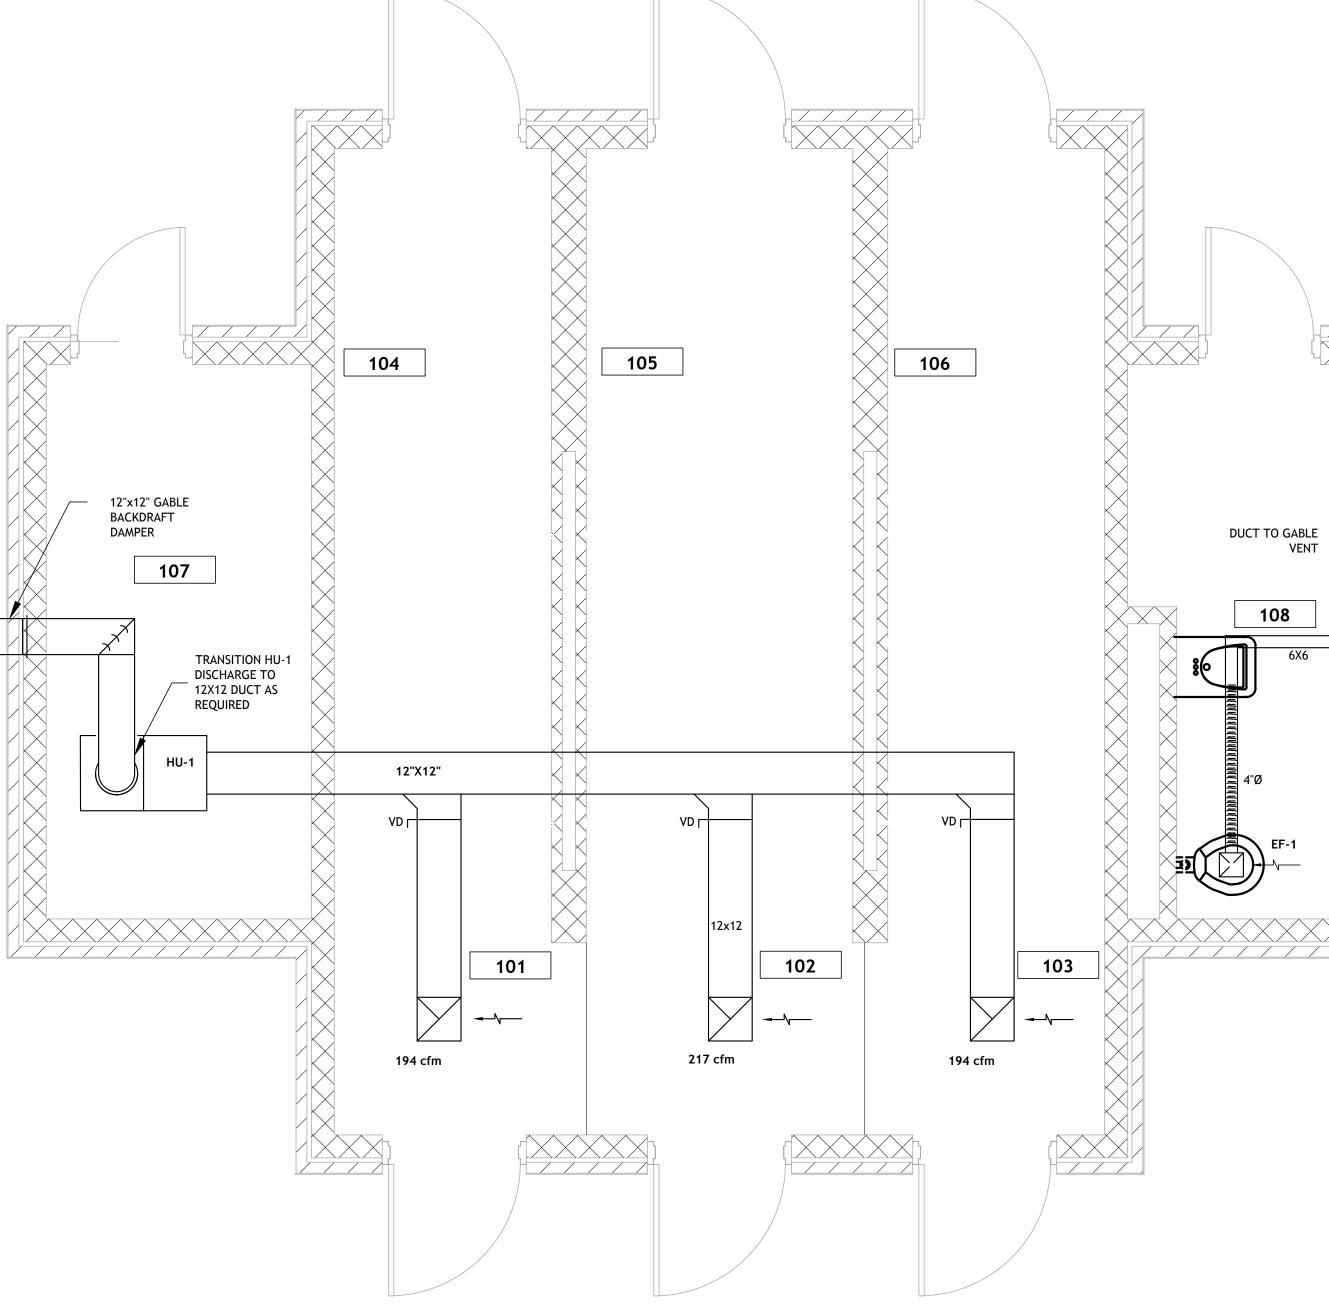


/

ō

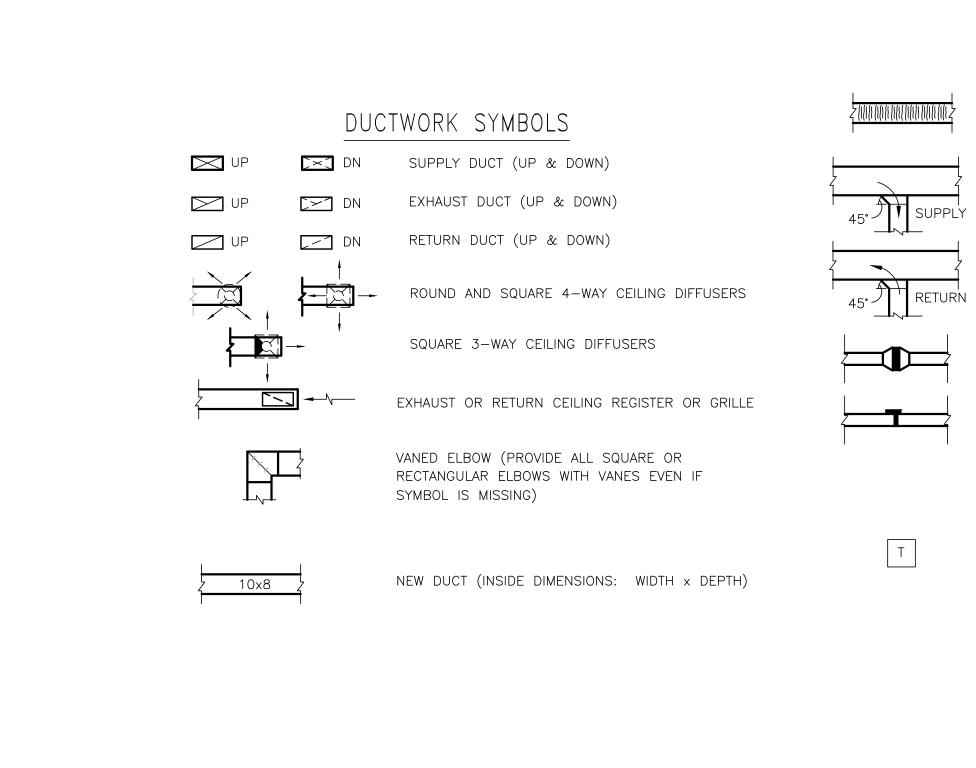



7

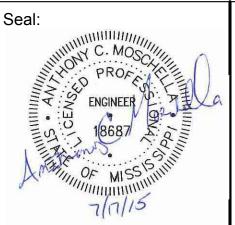



٨

4

C

Ö

ROYAL ENGINEERS & CONSULTANTS, LLC

4298 ELYSIAN FIELDS AVENUE NEW ORLEANS, LOUISIANA 70122 www.royalengineering.net

E

Approved:

PROGRAM MANAGER, PROJECTS SAFETY/INDUSTRIAL HYGIENE HEALTH SYSTEM SPECIALIST MAINTENANCE SUPERVISOR MAINTENANCE FOREMAN MAINTENANCE FOREMAN

	HVAC PLAN	Project Title VA Deconta	Date 7/17/2015 ⁷ roject No. 520-13-13		
	Approved: Service Engineer	Building Number XX	Checked MJ	Drawn ACM	drawing no.
	Approved: Service Director	Location VAMC BILOXI	Dwg. Of		
c	7		o		

OTHER SYMBOLS

THERMOSTAT


DUCT MOUNTED COIL (ELECTRIC)

STANDARD BRANCH SUPPLY OR RETURN, NO SPLITTER (45° TAP)


DUCT MOUNTED COIL (HOT WATER OR STEAM COIL)

FLEXIBLE DUCTWORK (INSULATED)

2 HVAC EXHAUST PLAN M201 SCALE: 3/8" = 1'-0"

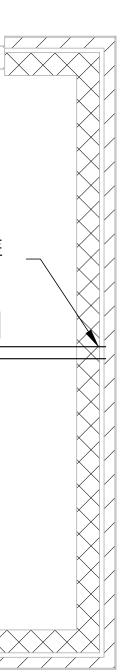

Э

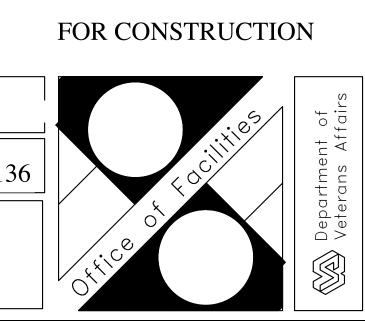

 \cap