

VA FORM 08-6231, DEC 1989

# VA GULF COAST VETERANS HEALTH CARE SYSTEM

**400 VETERANS AVENUE** BILOXI, MISSISSIPPI 39531

### FOR CONSTRUCTION

**VICINITY MAP** 



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### **GENERAL NOTES**

- BEFORE STARTING THE WORK, THE CONTRACTORS SHALL EXAMINE THE JOB SITE AND THE DRAWINGS AND BE THOROUGHLY FAMILIAR WITH THE ENTIRE CONSTRUCTION, THE FACILITIES AND DIFFICULTIES IN THE EXECUTION OF THE WORK, THE ACCURACY OF THE DRAWINGS AND DIAGRAMS RELATIVE TO THE CHARACTER, AND QUANTITY OF LABOR AND
- 2. IT IS THE INTENTION OF THE DESIGNER THAT THE DRAWINGS AND SPECIFICATIONS PROVIDE FOR A COMPLETELY FINISHED PRODUCT, AND ANYTHING SHOWN ON THE DRAWINGS OF DESCRIBED BY THE SPECIFICATIONS OR FAIRLY IMPLIED BY EITHER OR BOTH, SHALL BE CONSIDERED A PART OF THE WORK THE SAME AS IF NOTED, SHOWN, AND DESCRIBED. SHOULD THE MUST BE REDONE BECAUSE OF THEIR FAILURE TO COMPLY WITH THE PROCEEDINGS
- 3. FURTHER EXPLANATORY DRAWINGS OR DETAILS WILL ALSO BE CONSIDERED PART OF THE PROJECT AND WORK EXECUTED WITHOUT SUCH DETAILS SHALL BE AT THE
- THE CONTRACTORS SHALL VERIFY AND BE RESPONSIBLE FOR ALL DIMENSIONS AND MEASUREMENTS. ANY DISCREPANCIES BETWEEN THE DRAWINGS AND ACTUAL EXISTING CONDITIONS SHALL BE REPORTED TO THE GENERAL CONTRACTOR BEFORE PROCEEDING FURTHER. ANY CHANGES OR CORRECTIONS WILL BE WRITTEN, AND THE CONTRACTORS SHALL BE RESPONSIBLE FOR ANY WORK DONE BEFORE RECEIVING SAID CORRECTION.
- THE CONTRACTORS SHALL VERIFY ALL DIMENSIONS AND MAKE/OR PROVIDE ALL TEMPLATES FOR DRILLING OR FITTING FOR THEIR WORK WHICH MAY IN ANY MANNER CONNECT TO THE WORK OR APPARATUS FURNISHED OR BUILT BY OTHERS. ANY DISCREPANCIES IN DIMENSIONS OR DETAILS SHALL BE REPORTED TO THE GENERAL CONTRACTOR IMMEDIATELY, AND NO FURTHER WORK SHALL PROCEED UNTIL THE GENERAL CONTRACTOR APPROVES THE SAME.
- 6. THE GENERAL CONTRACTOR SHALL PROPERLY LAYOUT AND PRESERVE THE SITE FOR THE USE AND CONVENIENCE OF ALL TRADES EMPLOYED ON THE WORK AND BE RESPONSIBLE FOR THE ACCURATE MAINTENANCE OF SAID LINES. THE GENERAL CONTRACTOR SHALL ALSO ESTABLISH ALL WORKING GRADES AND LEVELS IN OR ABOUT THE BUILDING AND PREMISES AND PRESERVE THE SAME AGAINST DISTURBANCE. THESE LINES SHALL BE INDICATED ON PERMANENT BENCHES, PINS, OR OTHER MONUMENTS
- 7. SHOULD THE CONTRACTORS FIND, AT ANYTIME DURING THE PROGRESS OF THE WORK, THAT IN THEIR JUDGEMENT EXISTING CONDITIONS MAKE DESIRABLE A MODIFICATION IN
- 8. IT SHALL BE THE RESPONSIBILITY OF THE CONTRACTOR TO SEE THAT ALL WORK, FINISHED OR OTHERWISE, IRRESPECTIVE OF LOCATION IS COMPLETELY PROTECTED AFTER FINISHING FROM EXTRANEOUS MATERIALS AND FOR DAMAGE ARISING FROM ANY OTHER OCCURRENCE. FAILURE TO AFFORD SUCH PROTECTION MAY CONSTITUTE REJECTION OF ANY DAMAGED WORK WITH SUBSEQUENT REPLACEMENT AT NO ADDITIONAL COST
- 9. THE CONTRACTORS SHALL BE DIRECTLY RESPONSIBLE FOR ANY DAMAGE TO ADJOINING BUILDINGS, PRIVATE OR PUBLIC PROPERTY AND UTILITIES. THEY SHALL, THEREFORE, PROTECT ALL SUCH BUILDINGS, PROPERTY AND UTILITIES IN A SAFE, CLEAN AND SATISFACTORY MANNER AND SHALL REPAIR ANY DAMAGES TO MATCH ORIGINAL CONDITION
- 10. THE CONTRACTORS SHALL BE DIRECTLY RESPONSIBLE FOR THE SAFETY OF ALL PEOPLE WORKING ON OR NEAR THE JOB SITE ON THIS PROJECT AND FOR THE PROTECTION OF OTHERS IN THE VICINITY. CONTRACTOR TO MAINTAIN SECURE SITE AT ALL TIMES. NO CLAIMS OF THEFT OR VANDALISM SHALL BE MADE TO THE OWNER
- 11. ANY CUTTING OF THE STRUCTURE FOR NEW WORK SHALL BE THE FULL RESPONSIBILITY OF THE CONTRACTORS. IN THE EVENT THE TRADES INVOLVED DO THE ACTUAL CUTTING, THE WORK SHALL BE WITH THE KNOWLEDGE AND SUPERVISION OF THE CONTRACTOR WHO SHALL BE RESPONSIBLE FOR THAT OPERATION. ALL CUTTING WORK SHALL BE PATCHED OF COVERED TO A "LIKE NEW" CONDITION.
- WELL AS THOSE OF THE UTILITY COMPANIES AND OTHER INVOLVED AGENCIES. THE CONTRACTORS SHALL BE RESPONSIBLE FOR TAKING OUT ANY REQUIRED PERMITS AND PAYING AN' IS FOUND NOT TO COMPLY WITH THE ABOVE CODES AND REGULATIONS, BEFORE CONTINUING WITH THE WORK, BY FAILING TO DO SO, CONTRACTORS SHALL ASSUME FULL RESPONSIBILITY FOR COMPLIANCE.
- 13. MATERIAL AND WORKMANSHIP: IT IS THE INTENTION OF THE DRAWINGS AND SPECIFICATIONS TO PRODUCE WORK OF THE HIGHEST QUALITY. IF IN THE OPINION OF THE CONTRACTORS ANYTHING IS INCLUDED HEREIN THAT IS CONTRARY TO THIS, THEY SHALL REPORT IT TO THE GENERAL CONTRACTOR AND TAKE IMMEDIATE STEPS TO CORRECT IT. IF IN THE OPINION OF THE A/E OR GENERAL CONTRACTOR ANY PART OF THE CONSTRUCTION OF THIS WORK DOES NOT AGREE WITH THE ABOVE. THE CONTRACTORS WIL WRITING, AND THEY SHALL TAKE IMMEDIATE STEPS TOWARD CORRECTION. ALL NEW WORK, SPECIFIED OR IMPLIED, SHALL COMPLY WITH THE BEST RECOGNIZED STANDARDS OF THE CONSTRUCTION INDUSTRY, FOR THE INTENDED USE.


14. ALL WORK SHALL COMPLY WITH ALL LAWS, RULES, REGULATIONS, ORDIANCES AND CODES OF DEPARTMENT OF VETERAN AFFAIRS, THE FEDERAL GOVERNMENT, AND SHALL COMPLY WITH IBC 2012 FOR CONSTRUCTION

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**VA Gulf Coast** 

**Decontamination Unit** 

MP

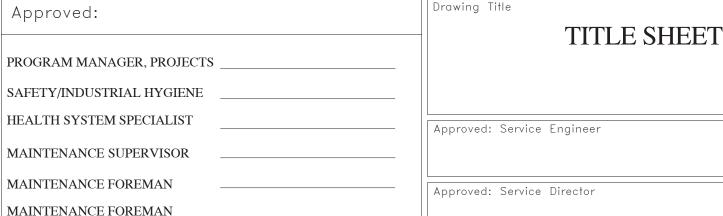


4298 ELYSIAN FIELDS AVENUE


NEW ORLEANS, LOUISIANA 70122 www.royalengineering.net


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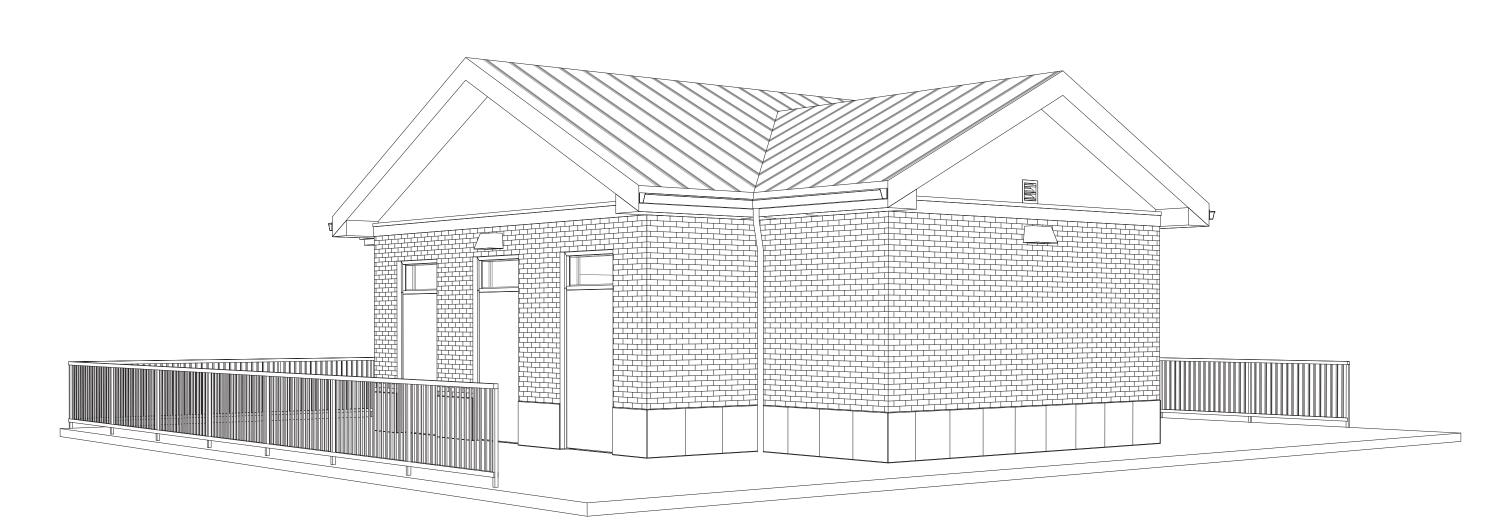





### 3-D VIEWS FOR DIAGRAMMATIC PURPOSES ONLY

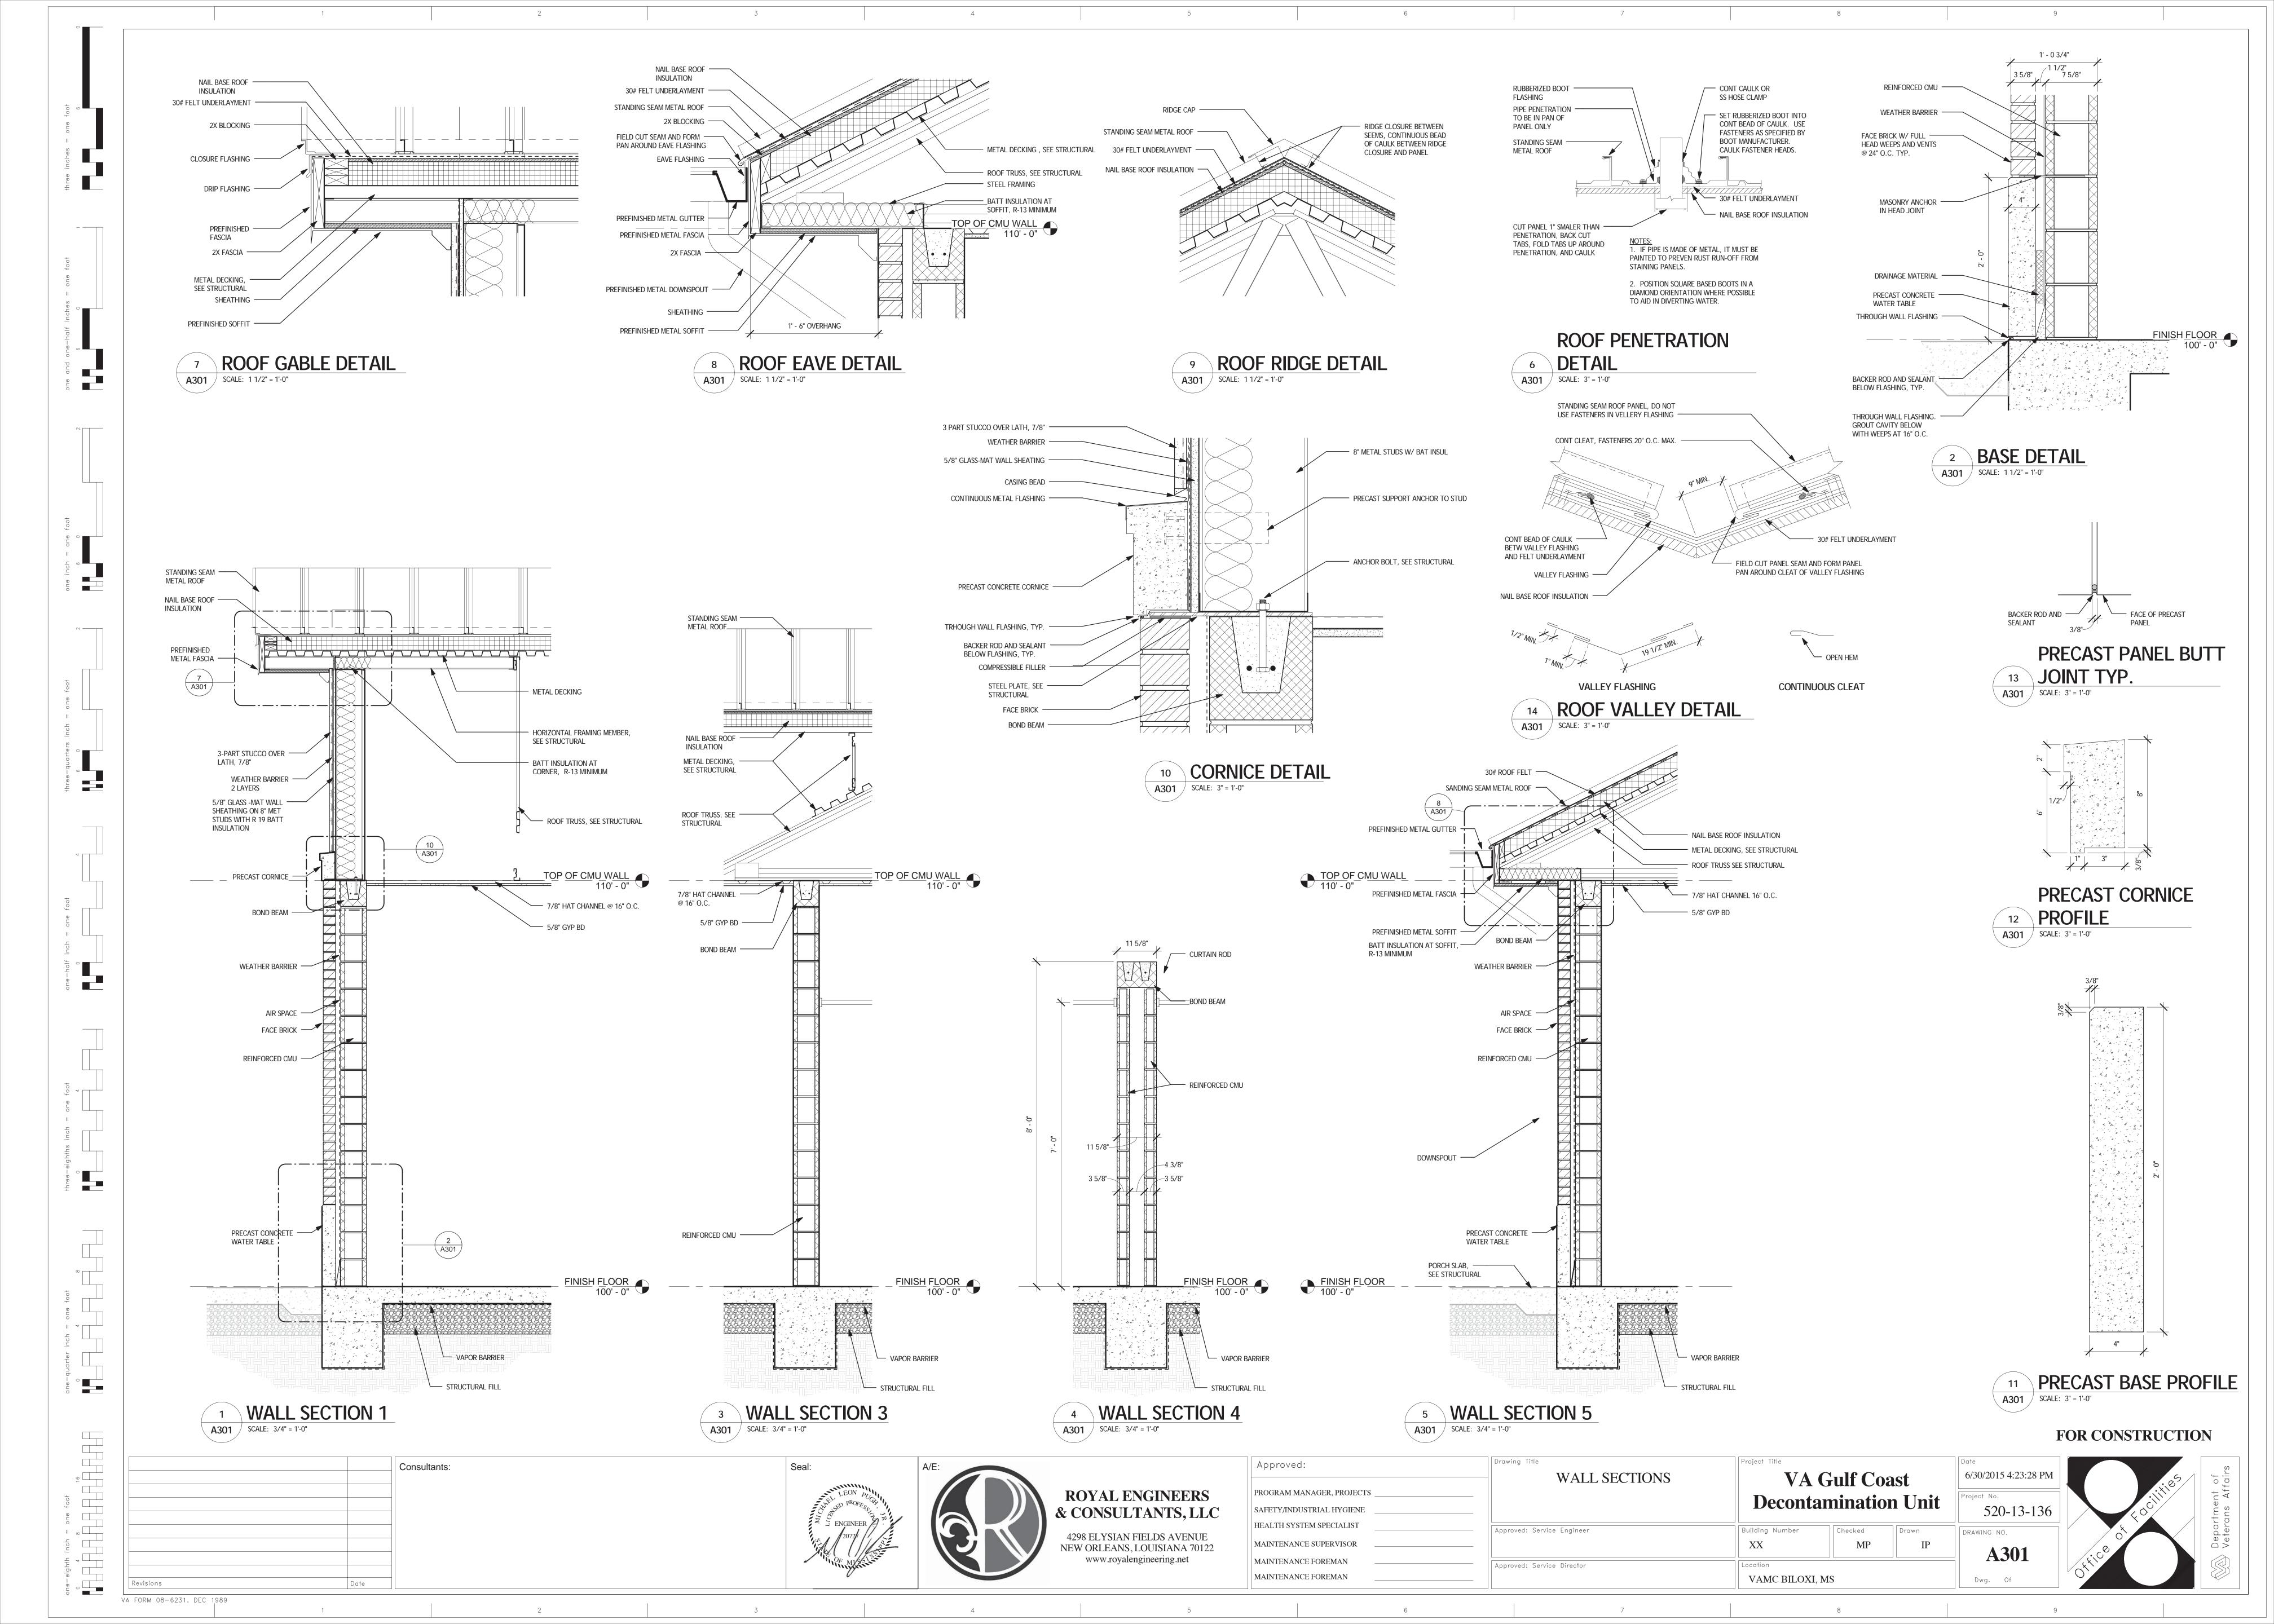


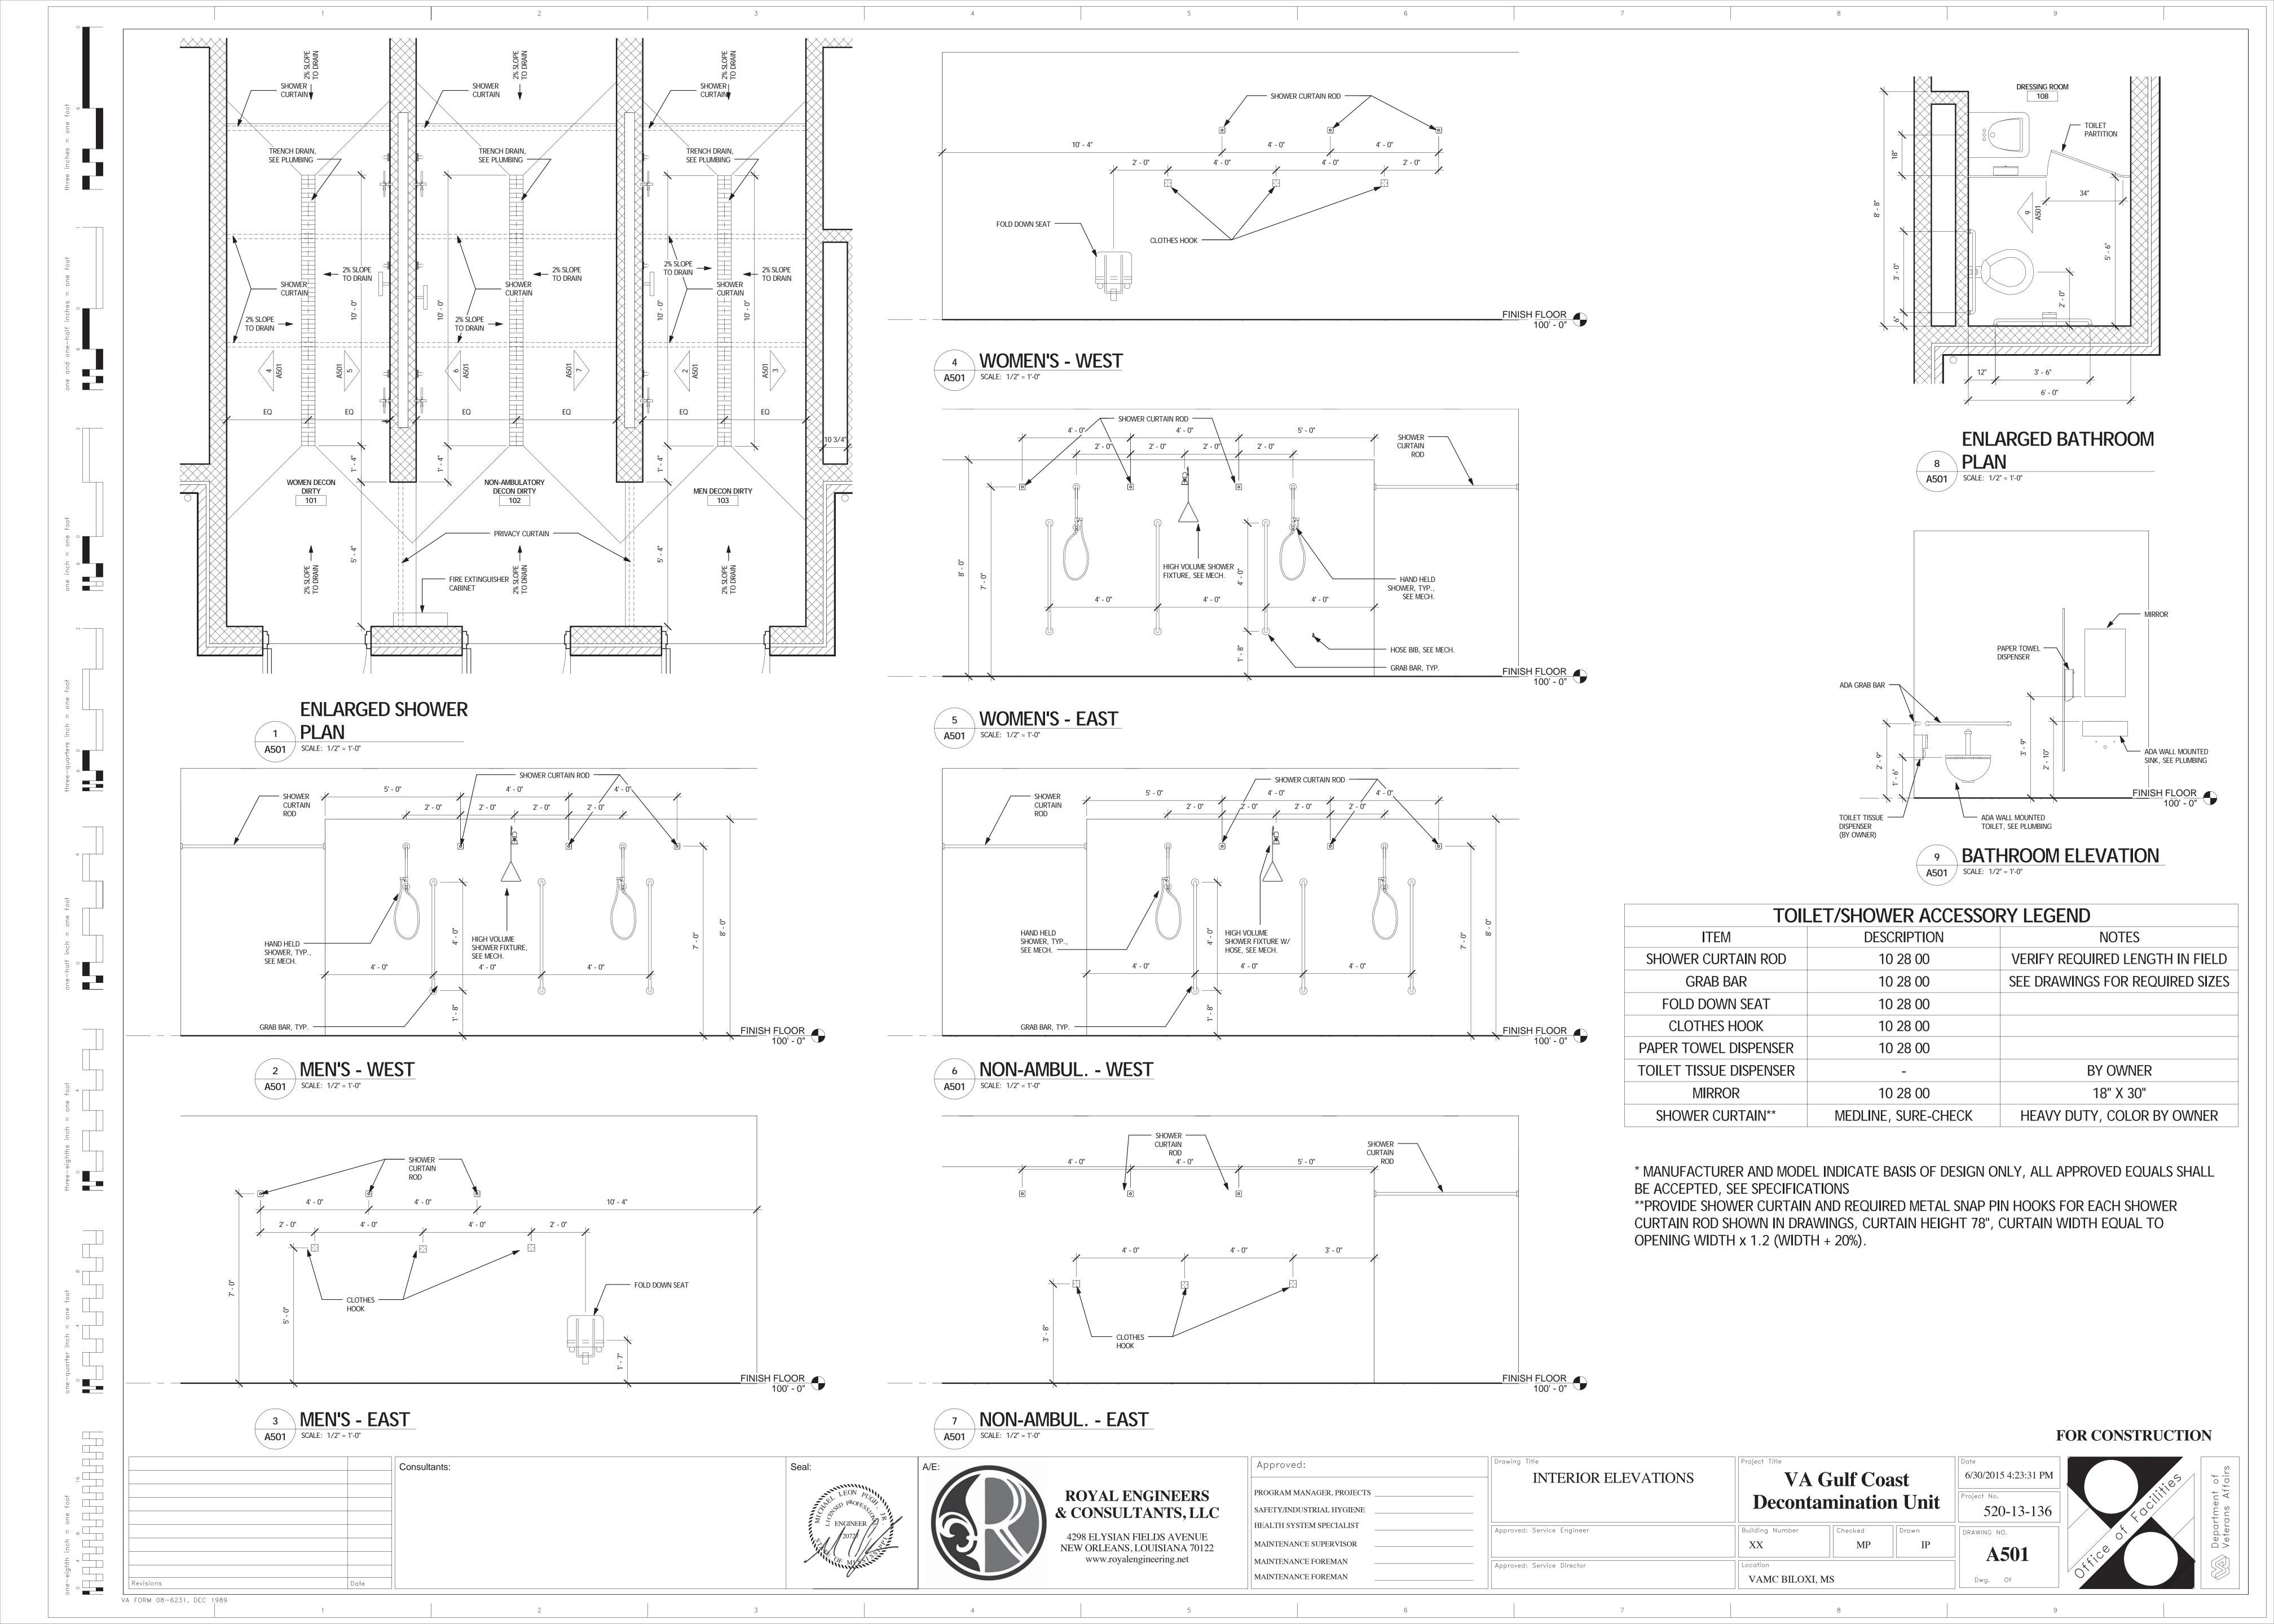1 3D View From South
A901 SCALE:

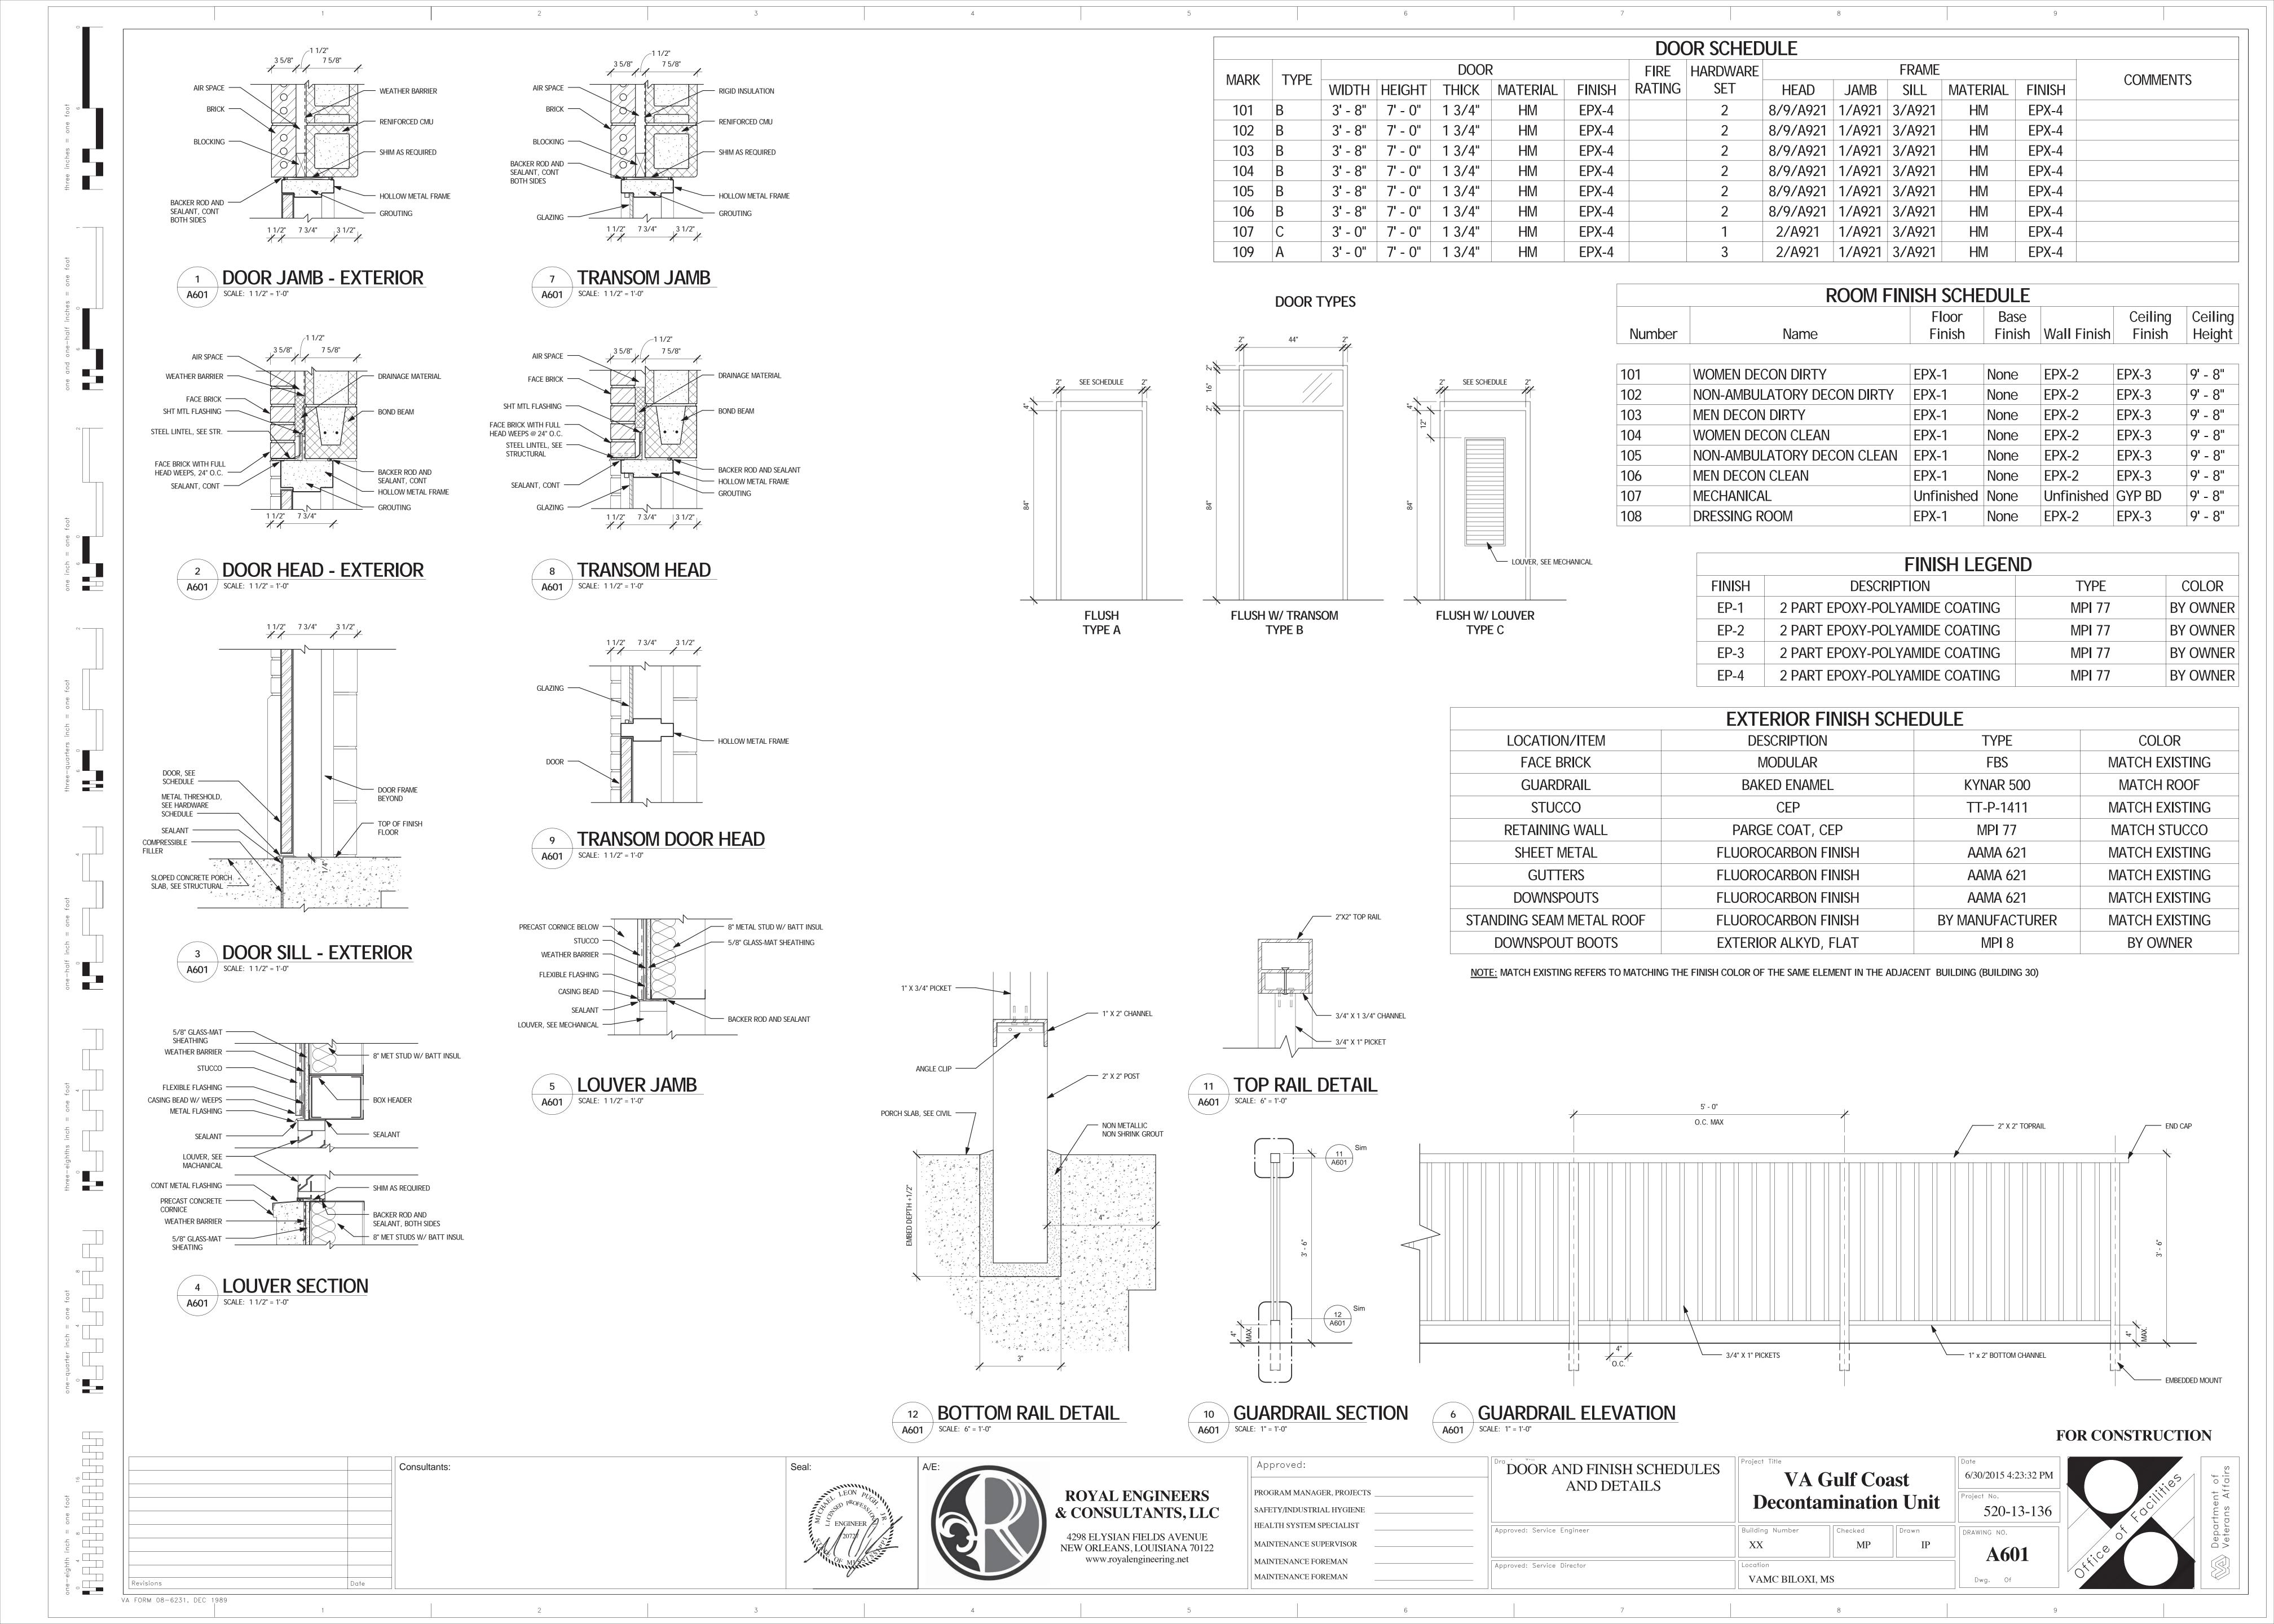


3D View from 2 Southeast SCALE:

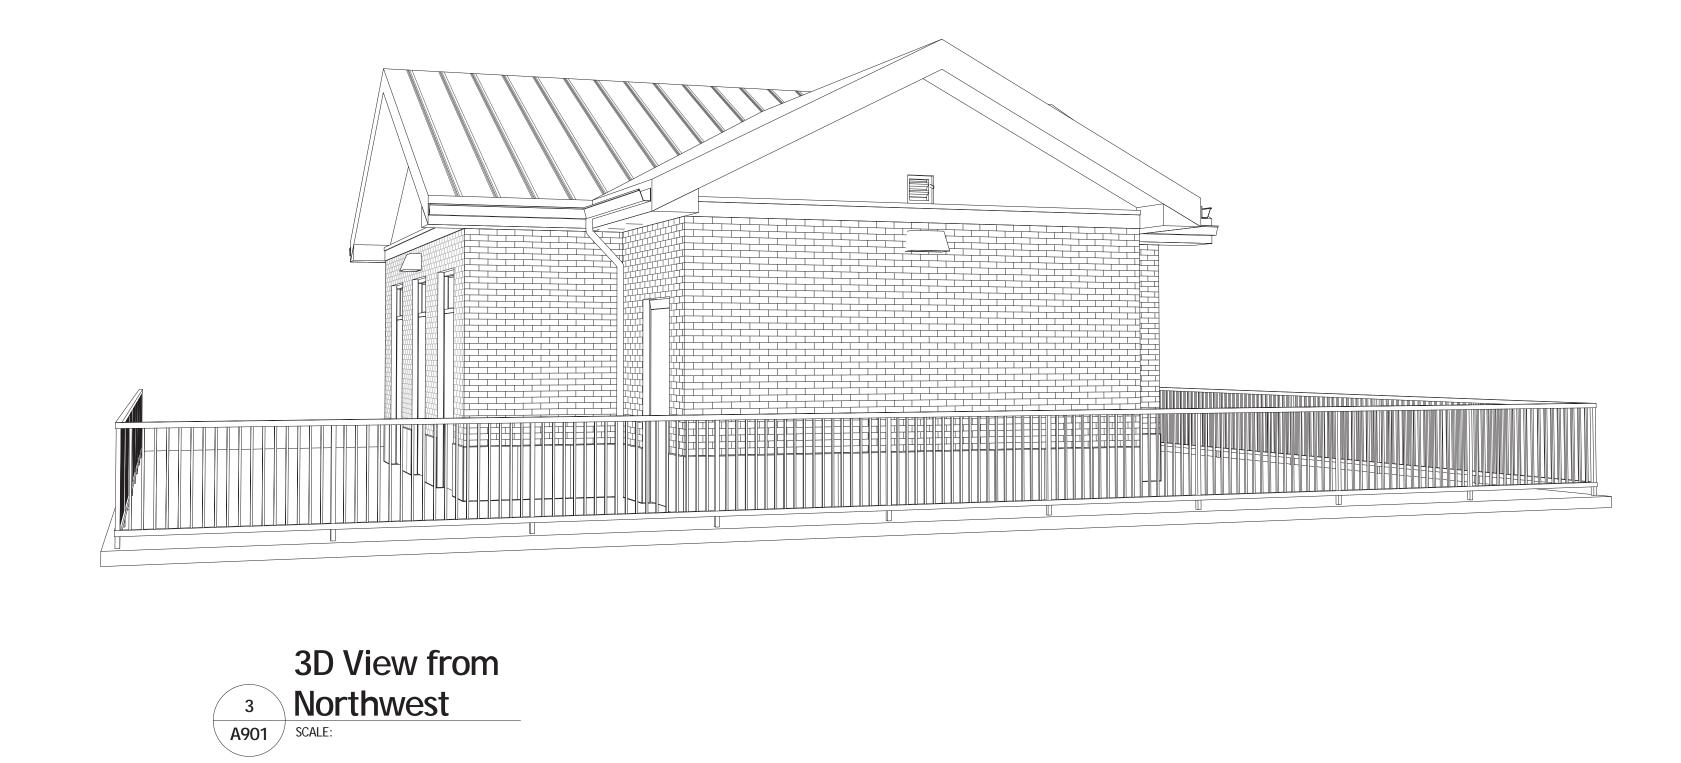

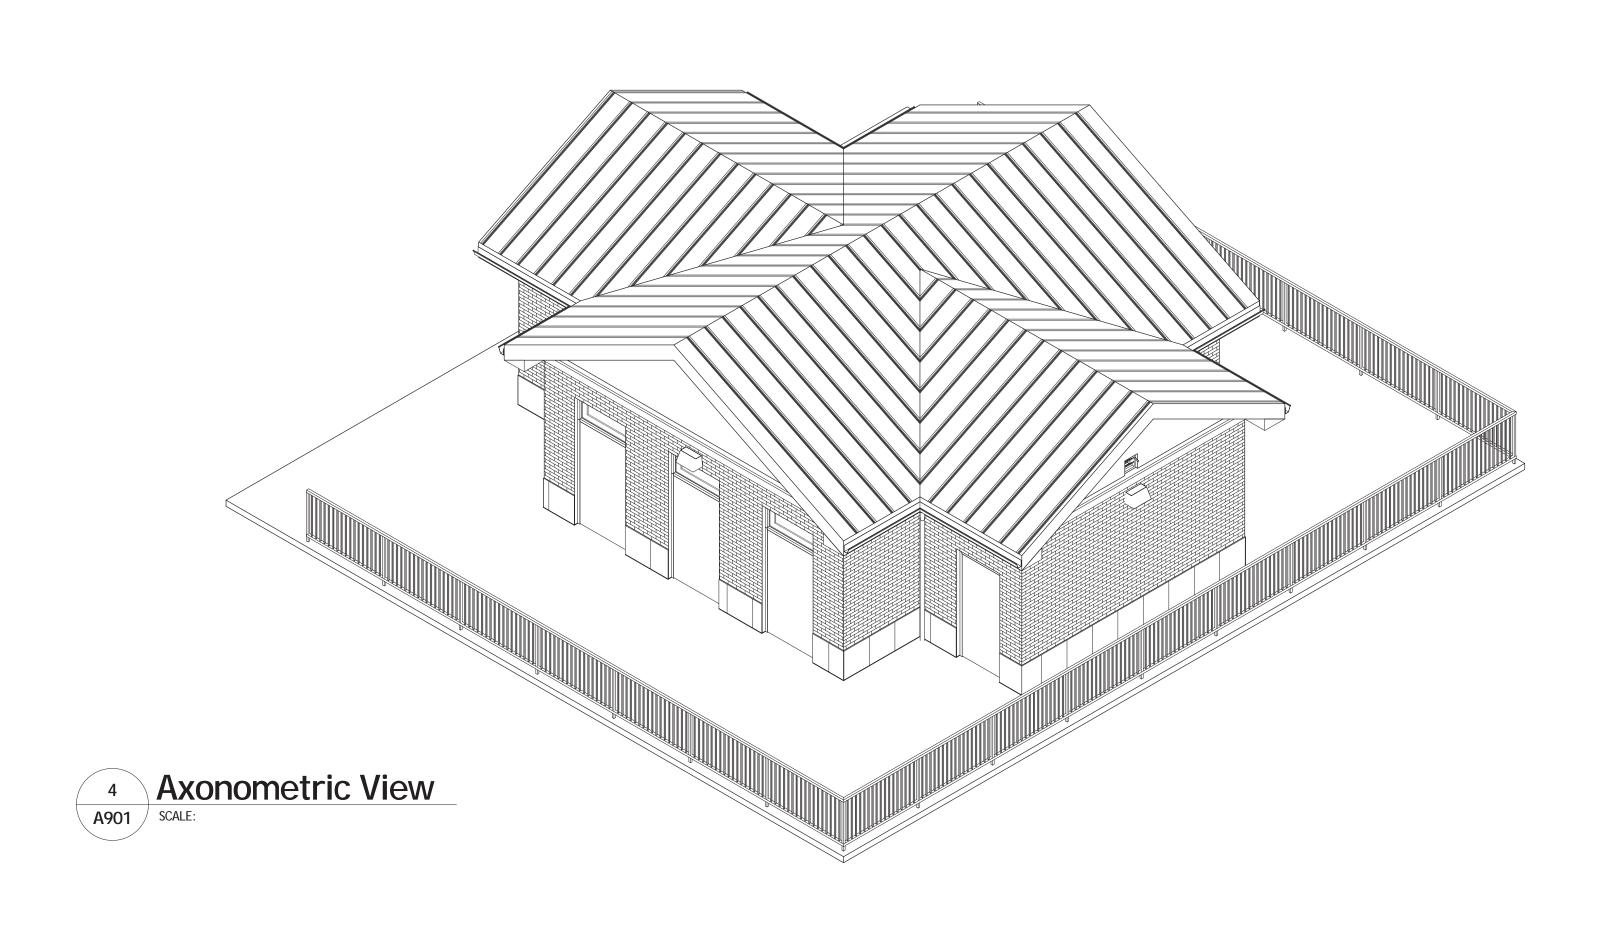

### FOR CONSTRUCTION



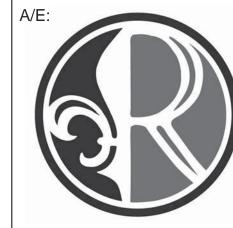

ROYAL ENGINEERS & CONSULTANTS, LLC 4298 ELYSIAN FIELDS AVENUE NEW ORLEANS, LOUISIANA 70122 www.royalengineering.net

	] [D
Approved:	Drawing Title
	3-D VIEWS
PROGRAM MANAGER, PROJECTS	3 D VILVO
SAFETY/INDUSTRIAL HYGIENE	
HEALTH SYSTEM SPECIALIST	Approved: Service Engineer
MAINTENANCE SUPERVISOR	
MAINTENANCE FOREMAN	Approved: Service Director

MAINTENANCE FOREMAN

**VA Gulf Coast Decontamination Unit** MP

VAMC BILOXI, MS


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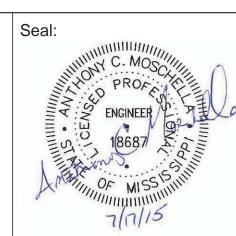
Consultants:



BURK-KLEINPETER, INC.

ENGINEERS, ARCHITECTS, PLANNERS, ENVIRONMENTAL SCIENTISTS
4176 CANAL STREET, NEW ORLEANS, LA 70119-5994
PHONE (504)486-5901 • FAX (504)488-1714

Consultants:

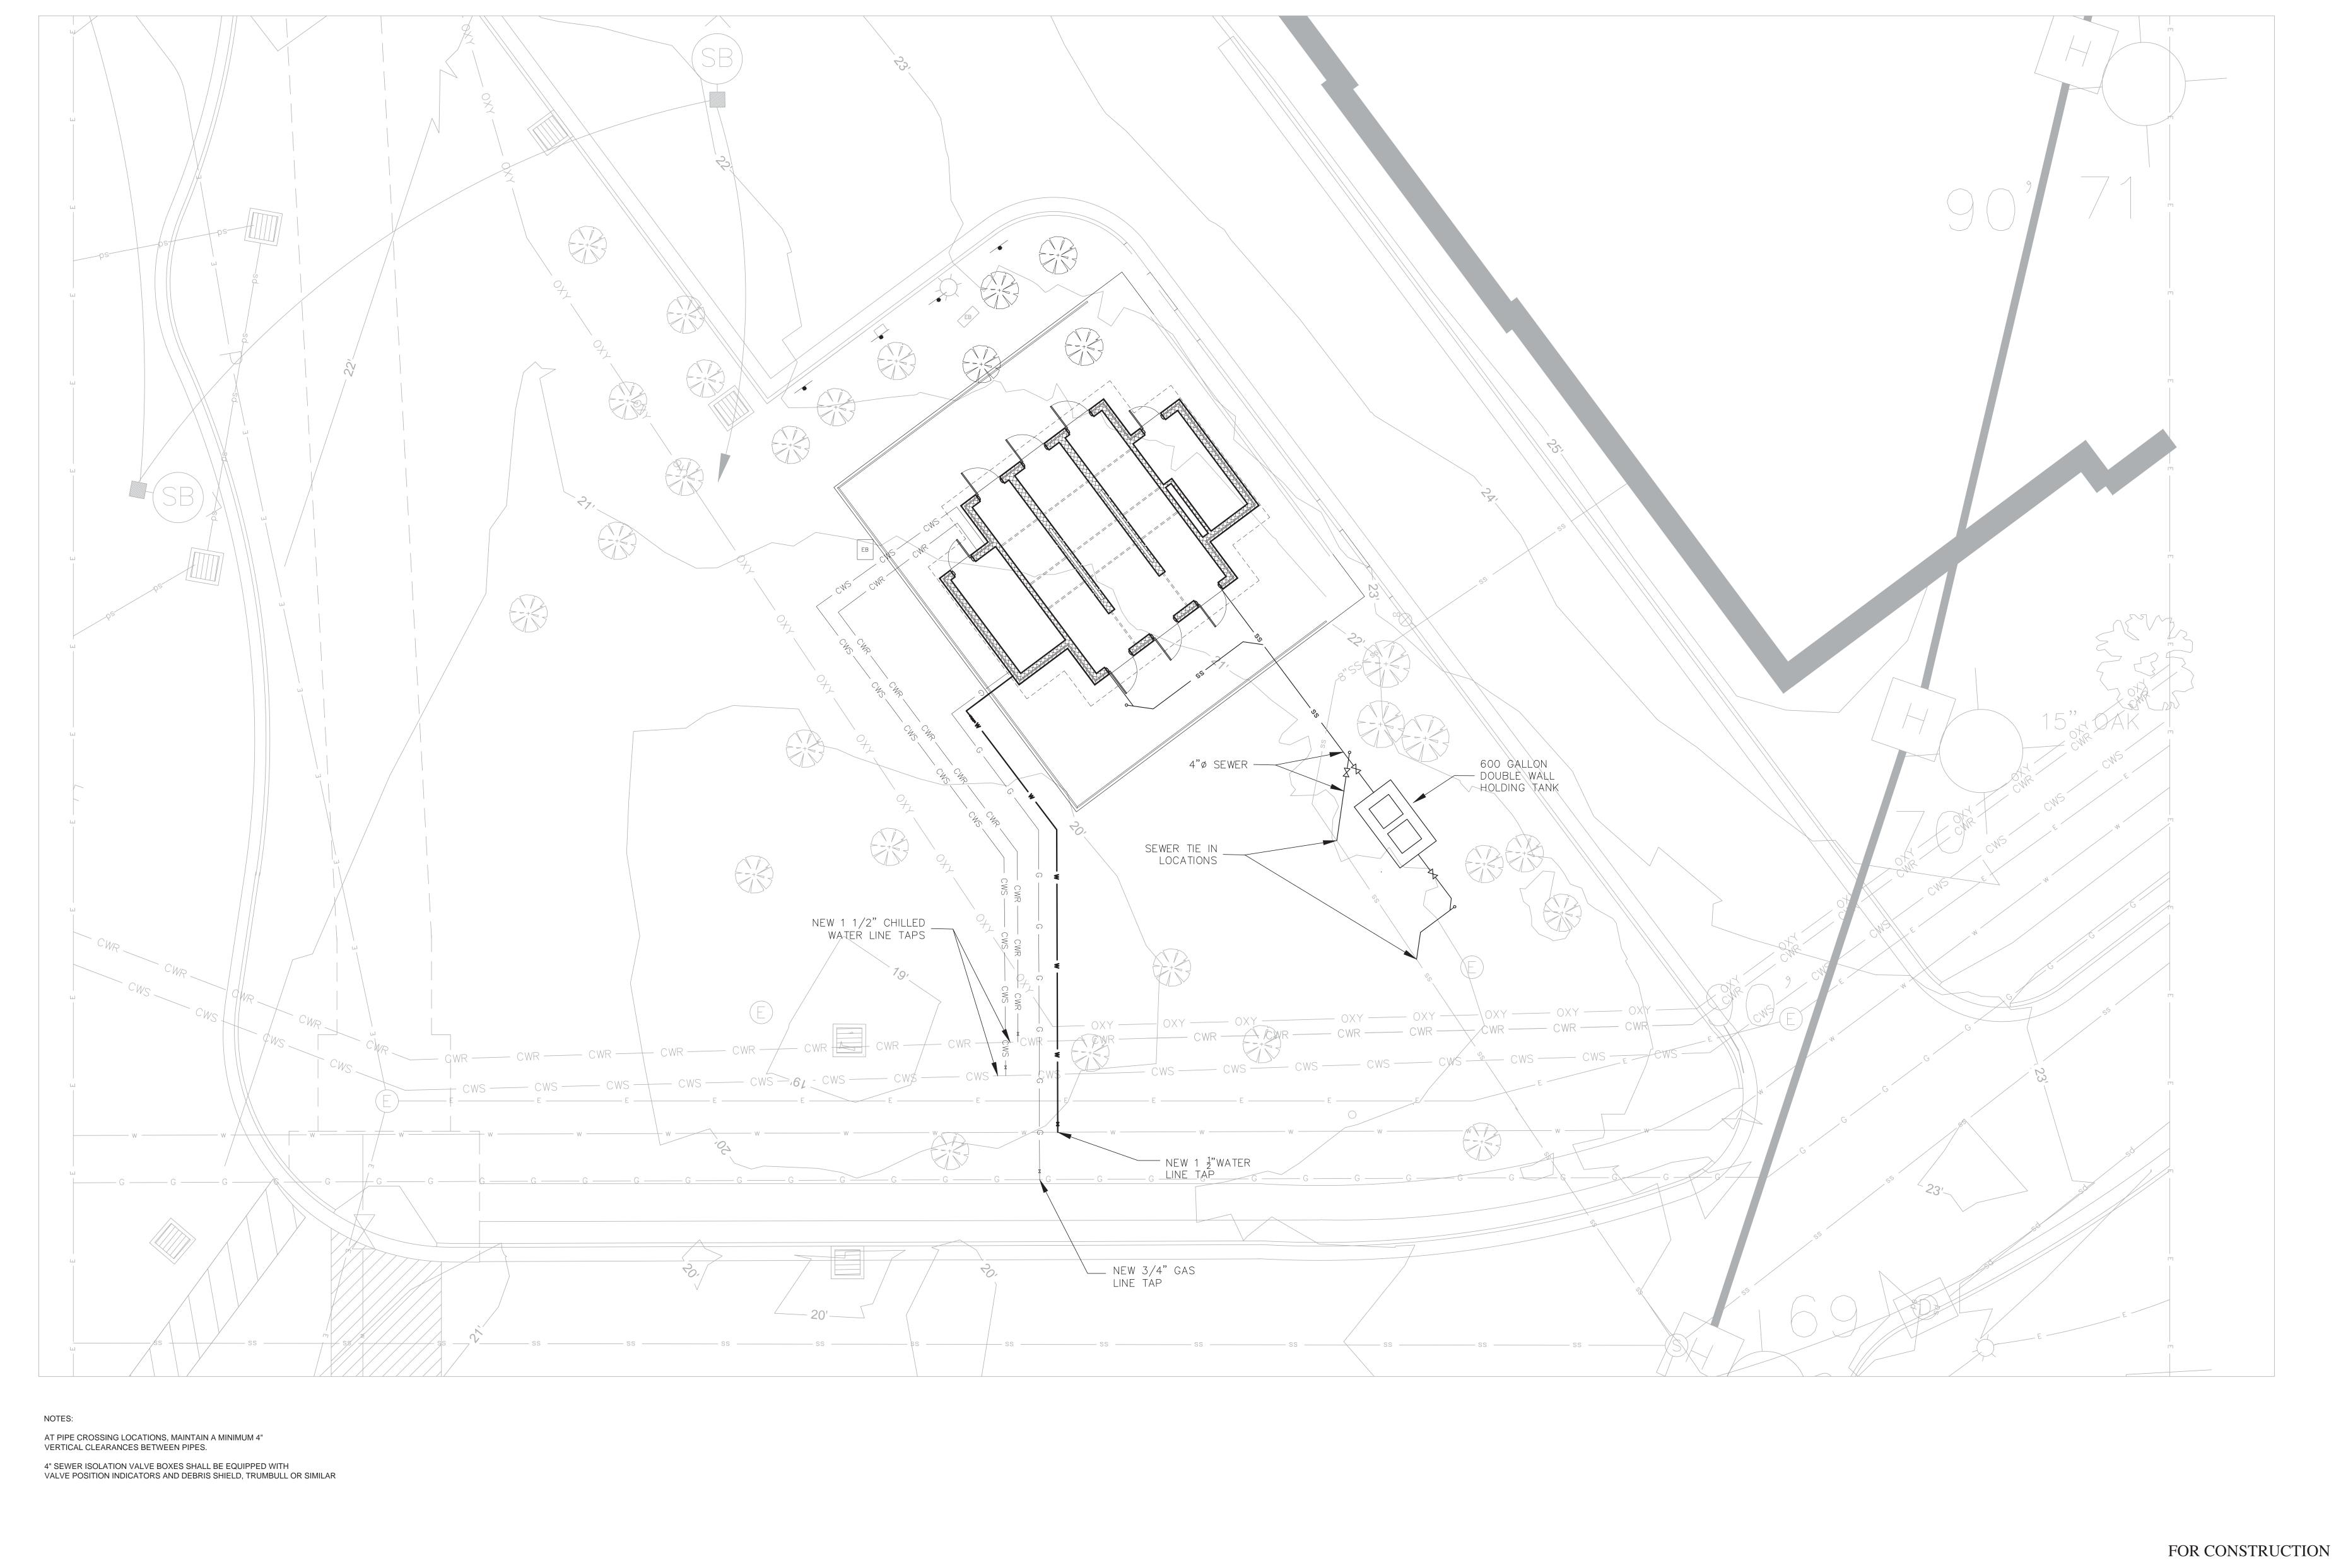





Approved:	
PROGRAM MANAGER, PROJECTS	
SAFETY/INDUSTRIAL HYGIENE	
HEALTH SYSTEM SPECIALIST	
MAINTENANCE SUPERVISOR	
MAINTENANCE FOREMAN	
MAINTENANCE FOREMAN	


MECH. SITE PLAN	VA Gulf Coast Decontamination Uni			Proje
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VAMC BILOXI, MS



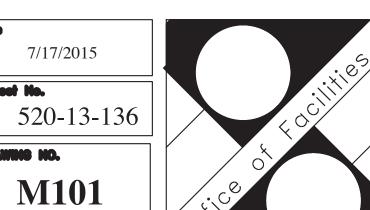



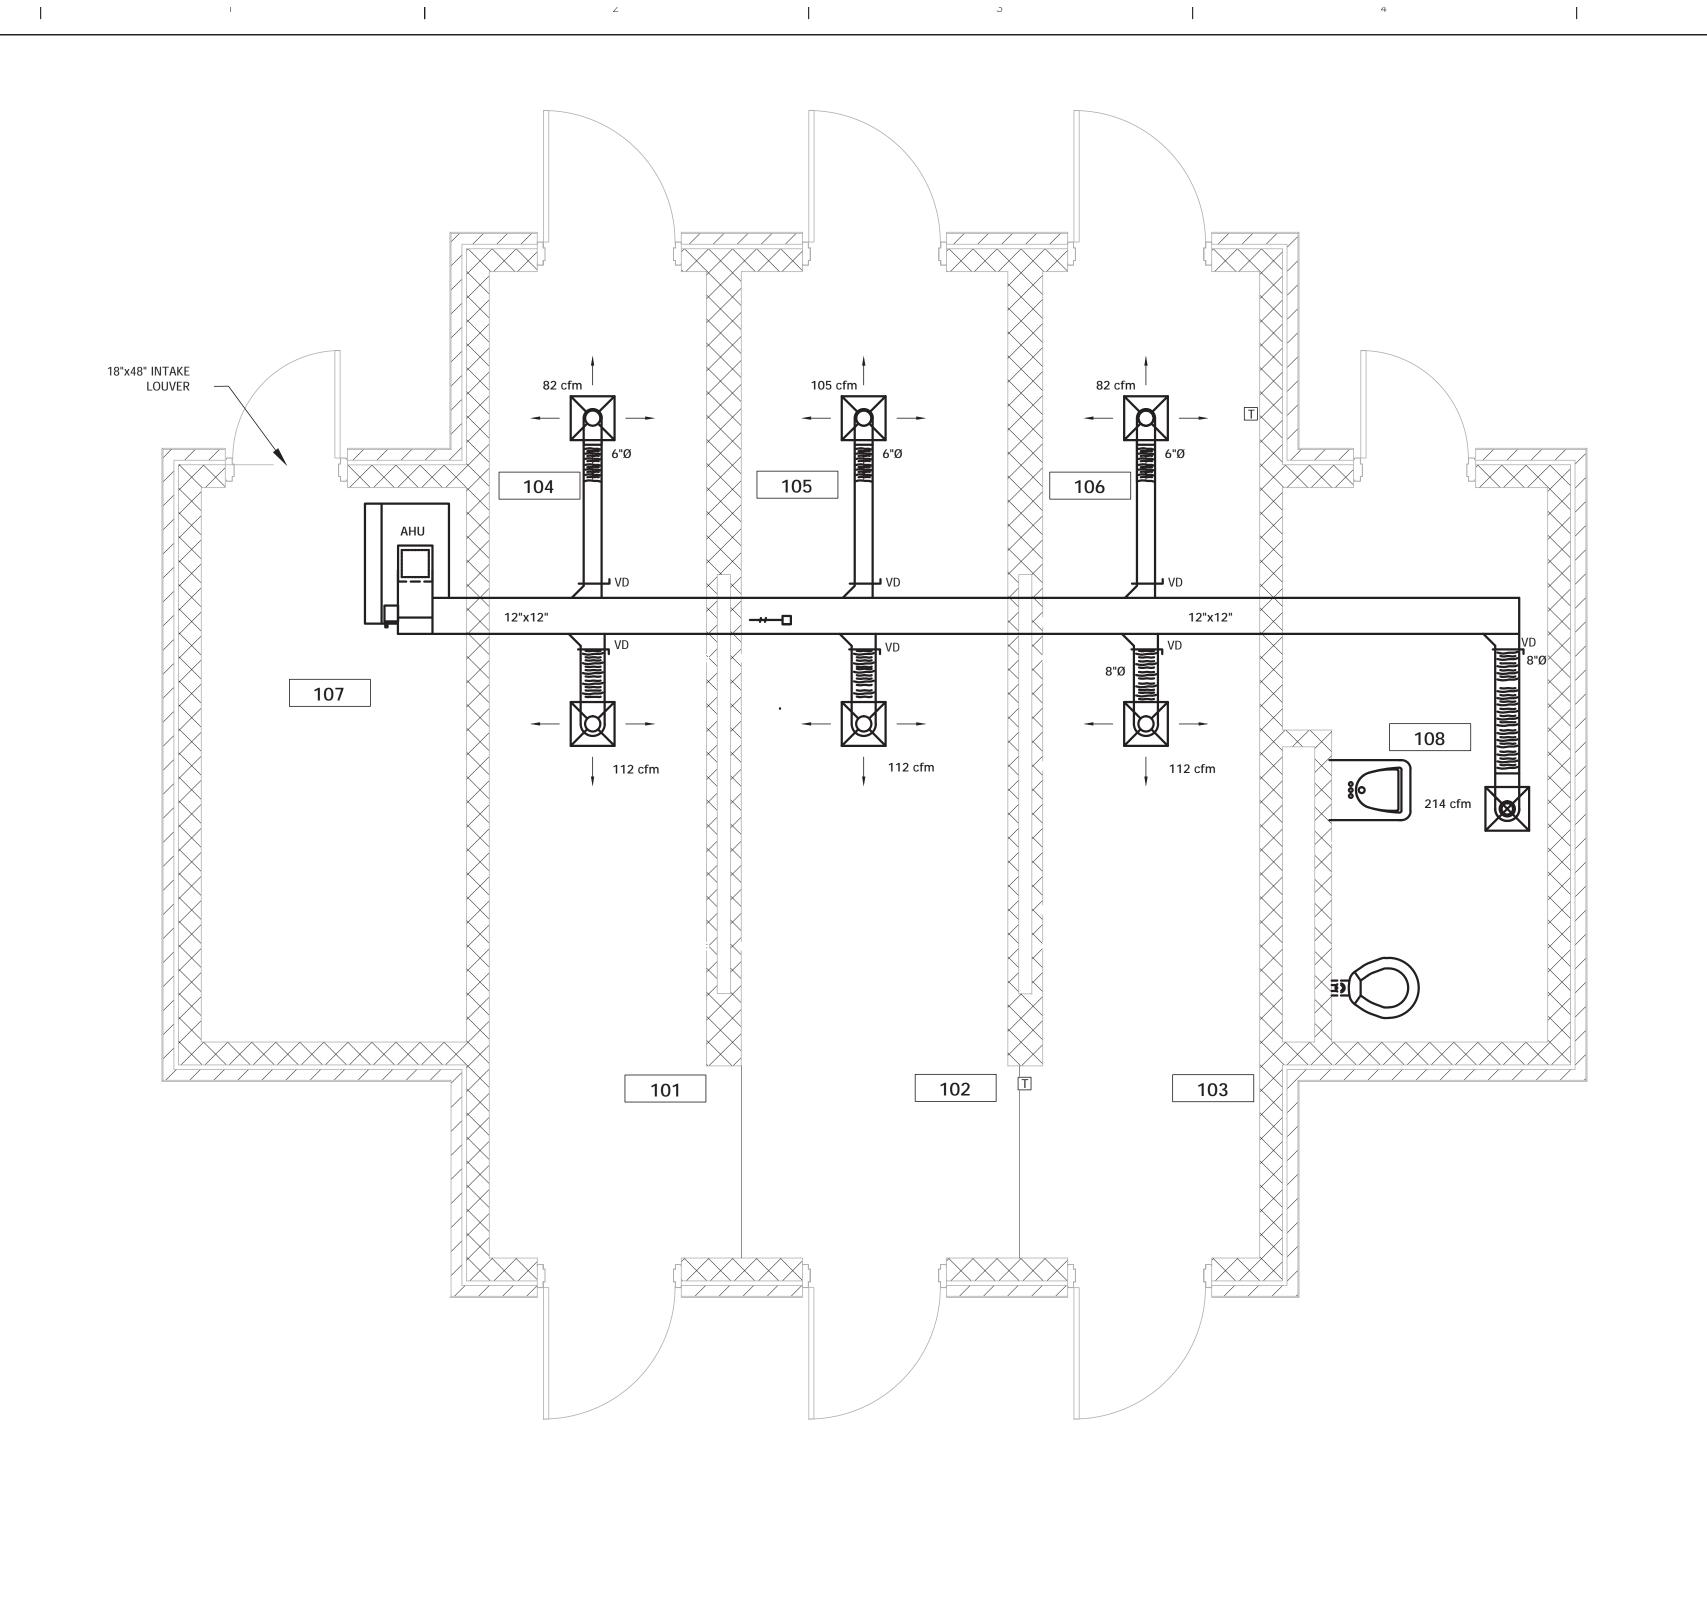

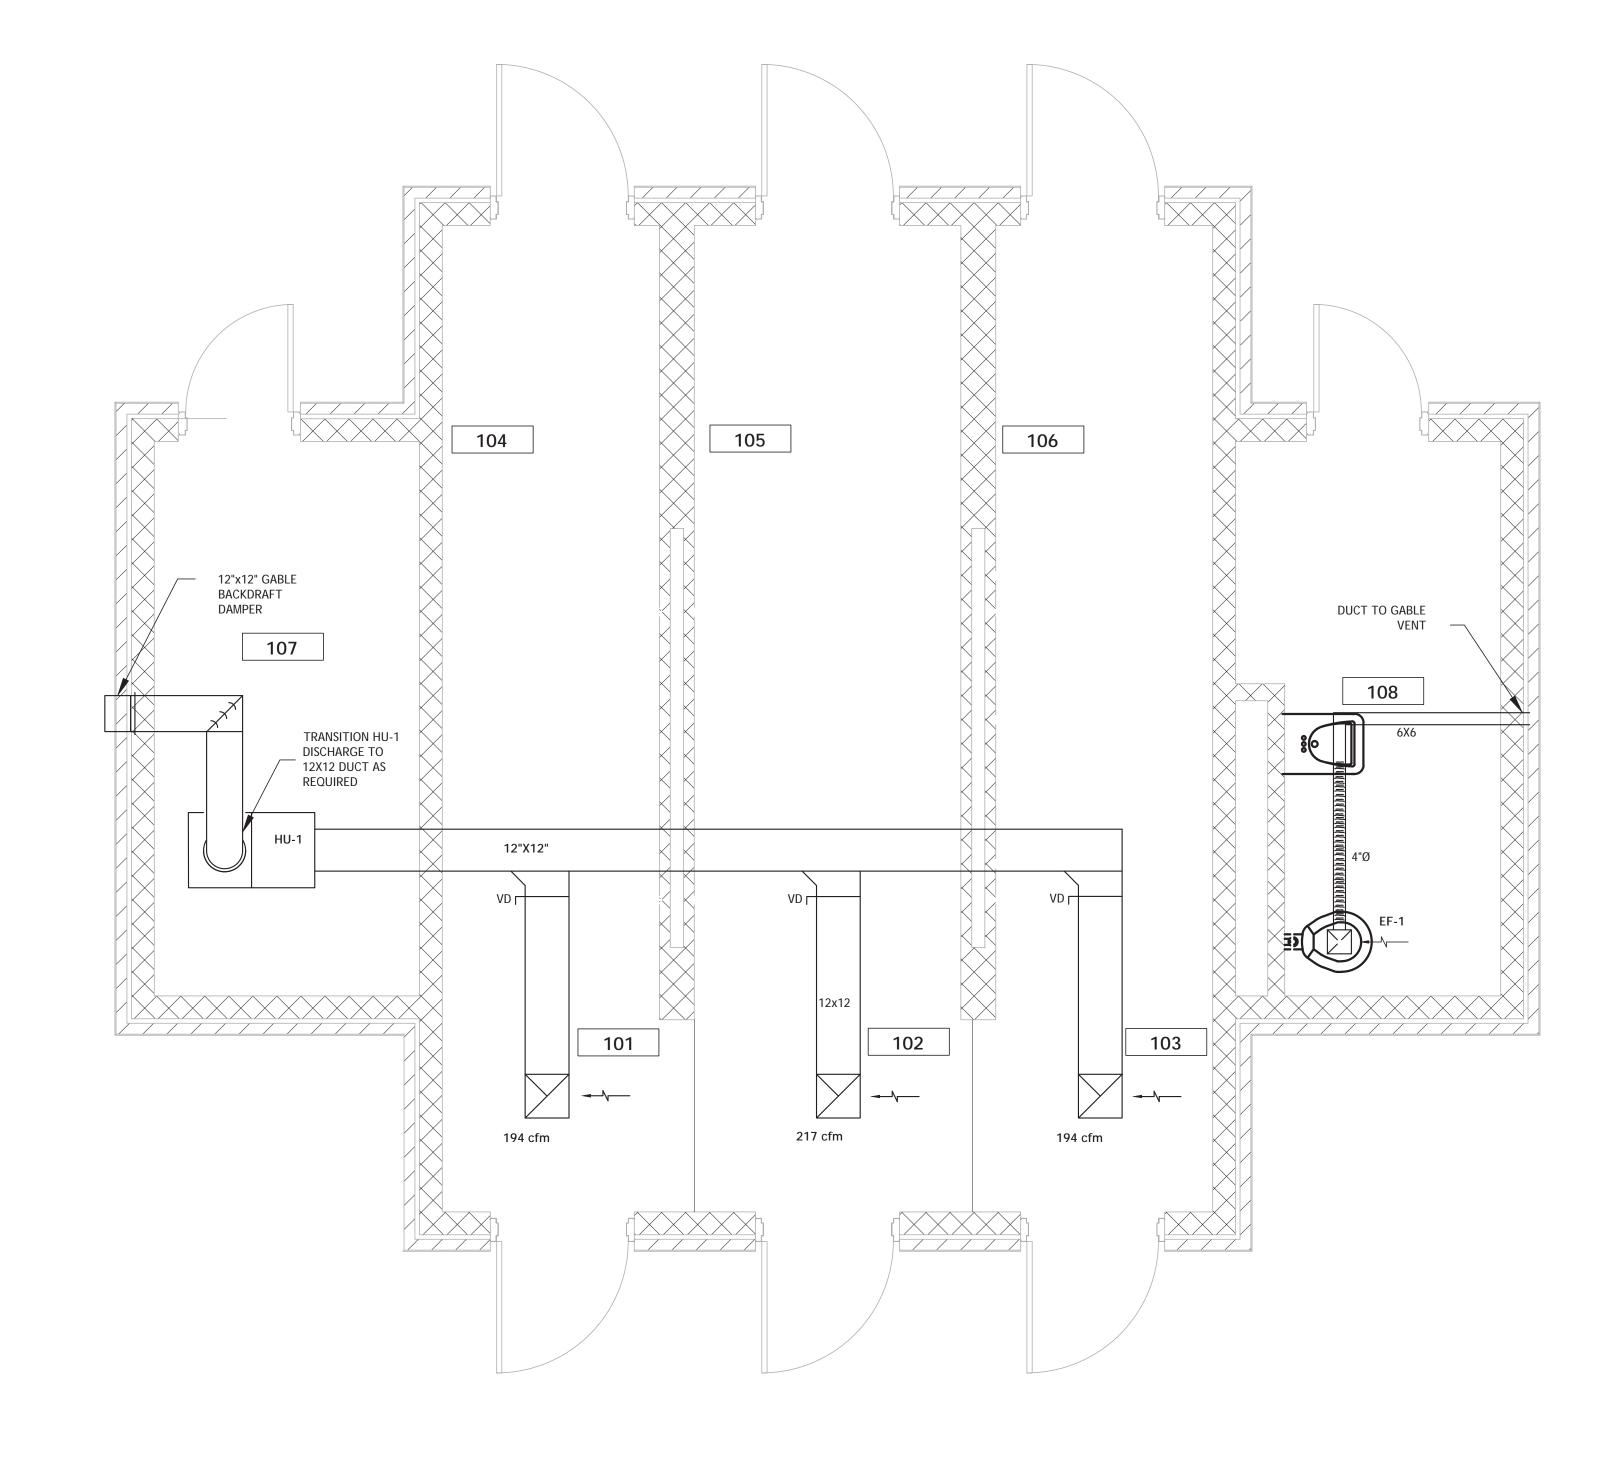1 HVAC SUPPLY PLAN

M201 SCALE: 3/8" = 1'-0"

M201 SCALE: 3/8" = 1'-0"

AIR HANDLING UNIT CHILLED WATER COIL DATA AVAILABLE CHILLED WATER FAN VOLTS/DIFFERENTIAL, PSI H.P. PHASE 10 1 480/3 REQUIRED SENSIBLE | REQUIRED LATENT SYSTEM E.S.P., COOLING, BTUH COOLING, BTUH CFM IN H20 26,000 808 .63

ELECTRIC HEAT DA	TA		EXHAUS	ST FAN D	ATA	
UNIT REQUIRED HEAT, KW	VOLT/PH	UNIT	CFM	STATIC	VOLT/PH	HP
DH-1 17	480/3	EF-1	80	.25"	110/1	.125
		HU-1	1200	.25"	110/1	.33

DH-1 SHALL BE 2 STAGE MINIMUM WITH CORRESPONDING STAGED HEAT THERMOSTAT.

EF-1 AND HEPA UNIT (HU-1) SHALL BE INTERLOCKED TO RUN WITH AHU-1 IN ADDITION TO

HU-1 SHALL BE EQUIPPED WITH A LOCAL VARIABLE SPEED CONTROLS. DURING DECON EVENT, EXHAUST RATE OF DECON AREA TO BE INCREASED BY ADJUSTING WALL MOUNTED HU-1 SPEED CONTROLLER.

INSTALL PERMANENT FLOW METER ON CWS PIPING

DUCT SHALL HAVE A MINIMUM 1" PRESSURE CLASSIFICATION, BASED ON MAXIMUM 1500 FPM

ROUTE MAIN CONDENSATE FROM AHU TO NEAREST DRAIN.

FLEX DUCT SHALL TRANSITION TO RIGID ELBOWS TO THE DIFFUSERS RECT ELBOWS SHALL BE RADIUS TYPE

SUPPLY DIFFUSER BASIS OF DESIGN IS TITUS TDV, 8" ROUND NECK, MAX .08" PRESS. LOSS. EXHAUST GRILL BASIS OF DESIGN IS TITUS 350RL, MAX .02" PRESS. LOSS

TOP OF DOOR LOUVER SHALL BE INSTALLED 12" FROM TOP OF DOOR PANEL.


HANG HU-1 WITH THREADED RODS GALV. STRUT TYPE CHANNELS. BOTTOM OF STRUCTURAL SUPPORTS SHALL BE AT 78".

GABLE EXHAUST BACKDRAFT DAMPERS BASIS OF DESIGN GREENHECK WD300 SERIES. CONTRACTOR SHALL PROVIDE ALL NECESSARY LABOR AND MATERIALS REQUIRED TO PROVIDE

AUTOMATION SYSTEM. CONTRACTOR SHALL DETERMINE AND COORDINATE REQUIREMENTS PRIOR

SUPERVISION OF THE DECON BUILDING HVAC SYSTEM BY THE VA COMPLEX MAIN BUILDING

DUCTWORK SYMBOLS DN SUPPLY DUCT (UP & DOWN) EXHAUST DUCT (UP & DOWN) RETURN DUCT (UP & DOWN) ROUND AND SQUARE 4-WAY CEILING DIFFUSERS SQUARE 3-WAY CEILING DIFFUSERS EXHAUST OR RETURN CEILING REGISTER OR GRILLE VANED ELBOW (PROVIDE ALL SQUARE OR RECTANGULAR ELBOWS WITH VANES EVEN IF SYMBOL IS MISSING)

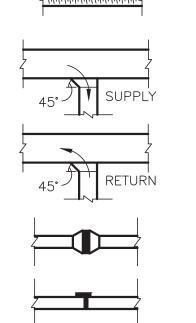

FLEXIBLE DUCTWORK (INSULATED)

STANDARD BRANCH SUPPLY OR RETURN, NO SPLITTER (45° TAP)

DUCT MOUNTED COIL (HOT WATER OR STEAM COIL)

Approved: Service Director


DUCT MOUNTED COIL (ELECTRIC)

OTHER SYMBOLS

THERMOSTAT

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NEW DUCT (INSIDE DIMENSIONS: WIDTH x DEPTH)

Approved:	
PROGRAM MANAGER, PROJECTS	
SAFETY/INDUSTRIAL HYGIENE	
HEALTH SYSTEM SPECIALIST	
MAINTENANCE SUPERVISOR	
MAINTENANCE FOREMAN	
MAINTENANCE FOREMAN	

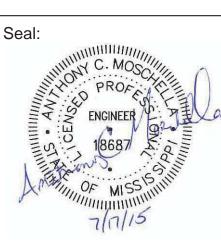
HVAC PLAN	·	Gulf Co aminatio		) Da
ed: Service Engineer	Building Number	Checked MJ	Drawn ACM	DR

VAMC BILOXI, MS


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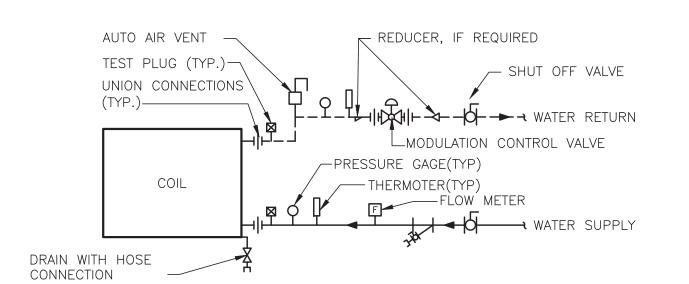
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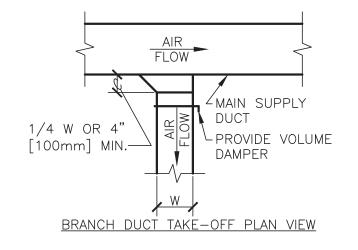
NOTE:

- 1. ALL VANE ELBOWS SHALL BE CONSTRUCTED AND INSTALLED AS DETAILED BY
- 2. WHEN W1 DOES NOT EQUAL W2, VANE SHALL BE SINGLE THICKNESS VANE TYPE REGARDLESS OF W DIMENSION.
- ALL SINGLE THICKNESS VANES SHALL HAVE A 2" [50mm] RADIUS, 1 1/2" [40mm] MAXIMUM SPACE BETWEEN VANES AND A 3/4" [20mm] TRAILING EDGE.
   WHEN W EQUALS W2 AND W1 IS GREATER THAN 20" [500mm] VANES SHALL BE DOUBLE VANE TYPE.




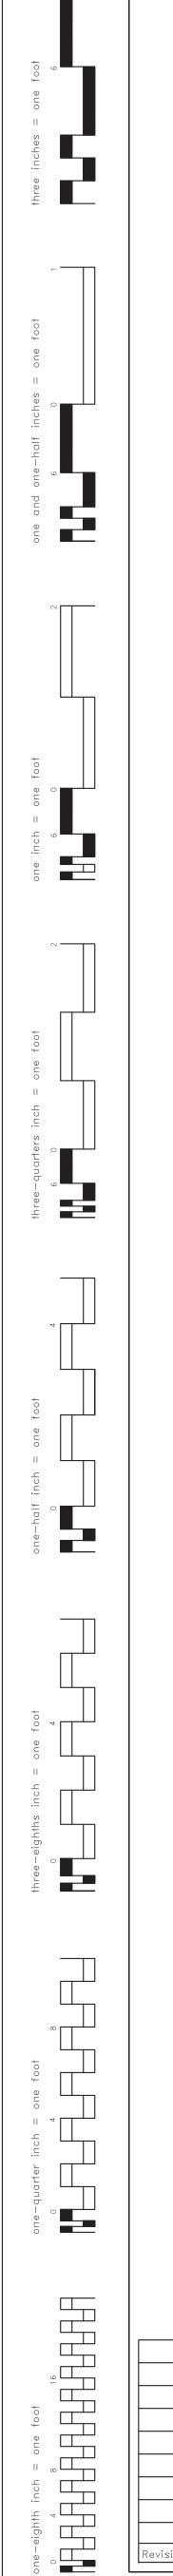

TERMINAL UNIT WATER COILS - PIPING CONNECTIONS

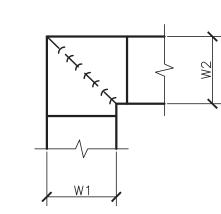


SUPPLY DUCTWORK TAKE-OFF

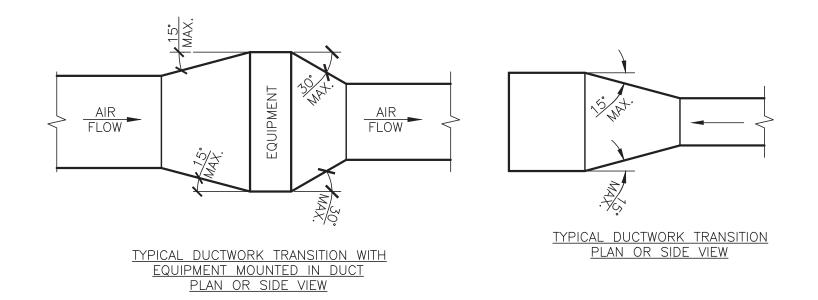


NOTE: Unless otherwise indicated on plans, maximum angles shown shall apply.



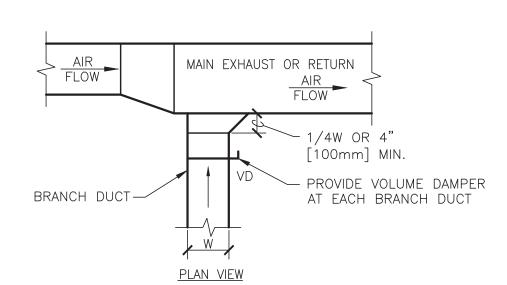



7 EXHAUST OR RETURN BRANCH DUCTWORK

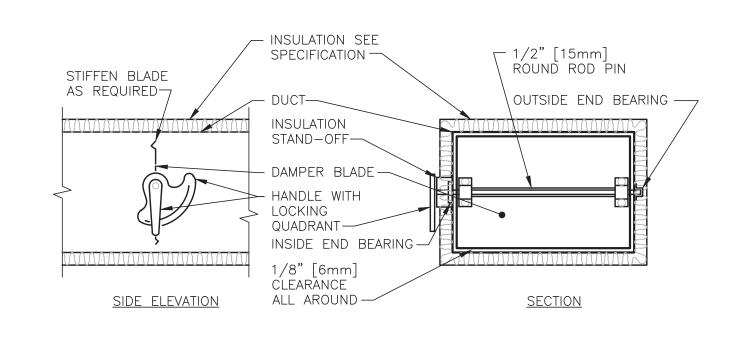


NOTE:

- DELETE INSULATION STAND—OFF ON DUCTWORK WITHOUT EXTERIOR INSULATION.
   DETAIL SHOWS SINGLE BLADE DAMPER. DAMPER INSTALLATION SHALL BE SIMILAR FOR MULTI—BLADE DAMPERS & ROUND DAMPERS.
- 2 VOLUME DAMPER DETAIL

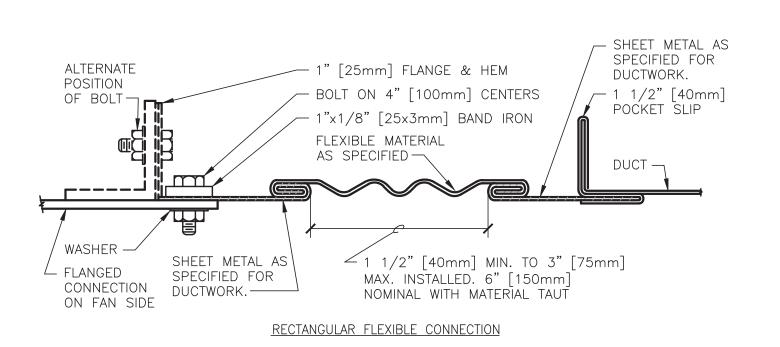

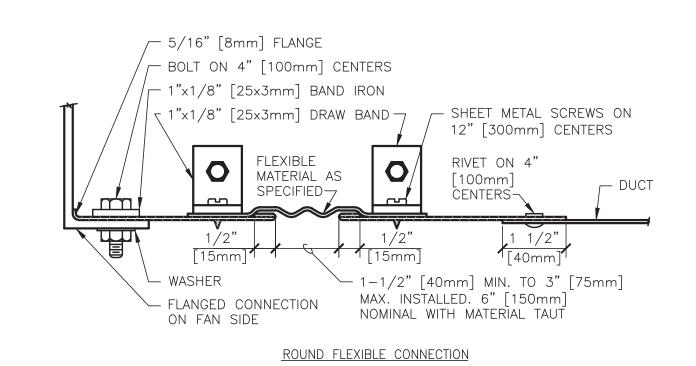

FLEXIBLE DUCT CONNECTIONS

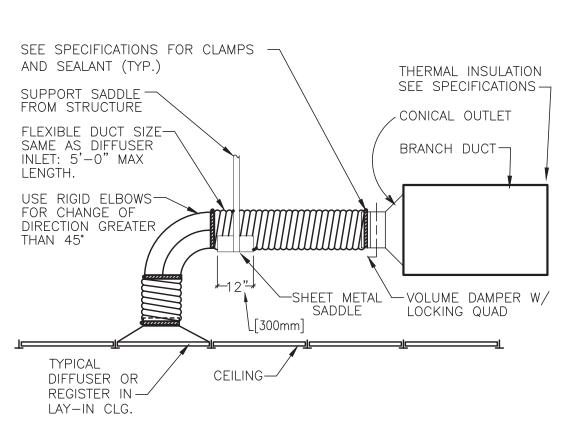


NOTE: The USE of Flexible air duct connectors are not permitted for the dedicated ahu serving the surgical suite.



### FOR CONSTRUCTION



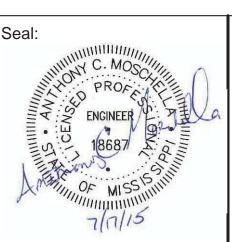





Approved:	
PROGRAM MANAGER, PROJECTS	
SAFETY/INDUSTRIAL HYGIENE	
HEALTH SYSTEM SPECIALIST	
MAINTENANCE SUPERVISOR	
MAINTENANCE FOREMAN	
MAINTENANCE FOREMAN	

Approved: Service Director

MISC HVAC DETAILS	Project Title  VA  Deconta	Gulf Co minatio		Dat
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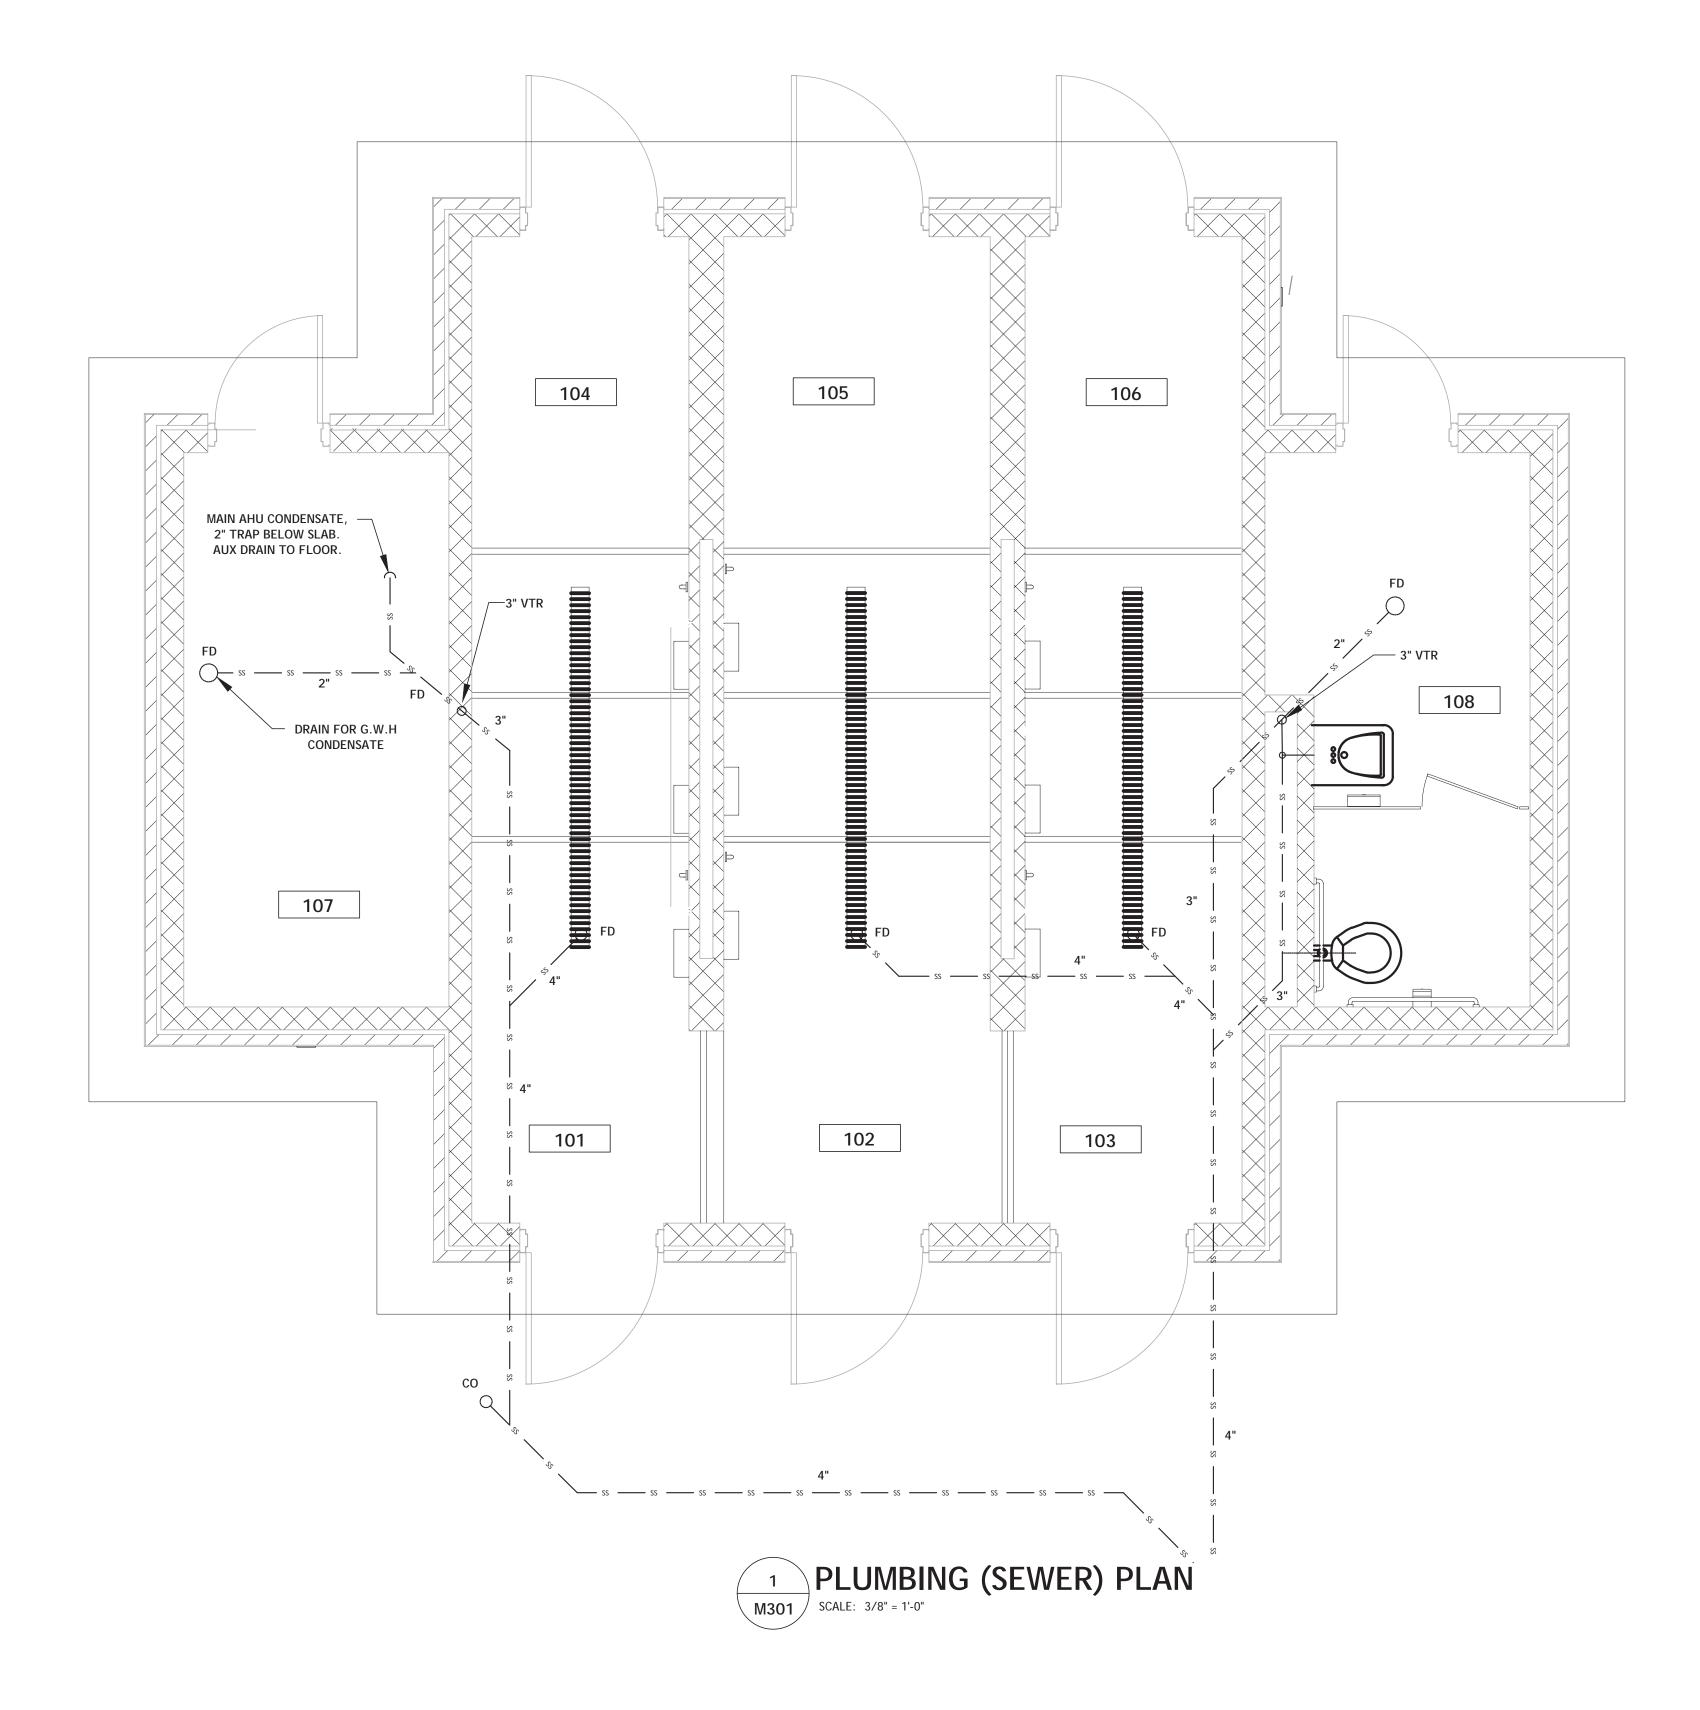
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roject No.
520-13-136

DRAWING NO.

M202





### PLUMBING LEGEND

\_\_\_\_\_ cw \_\_\_\_ rw \_\_\_\_ NEW COLD WATER PIPING \_\_\_\_\_ SS \_\_\_\_\_ NEW SANITARY SEWER \_\_\_\_ G \_\_\_\_ G \_\_\_\_ NEW GAS PIPING SEWER CLEAN OUT FLOOR DRAIN SEWER FLOOR CLEANOUT WALL HYDRANT

VENT TO ROOF VENT GAS WATER HEATER BACKFLOW PREVENTER

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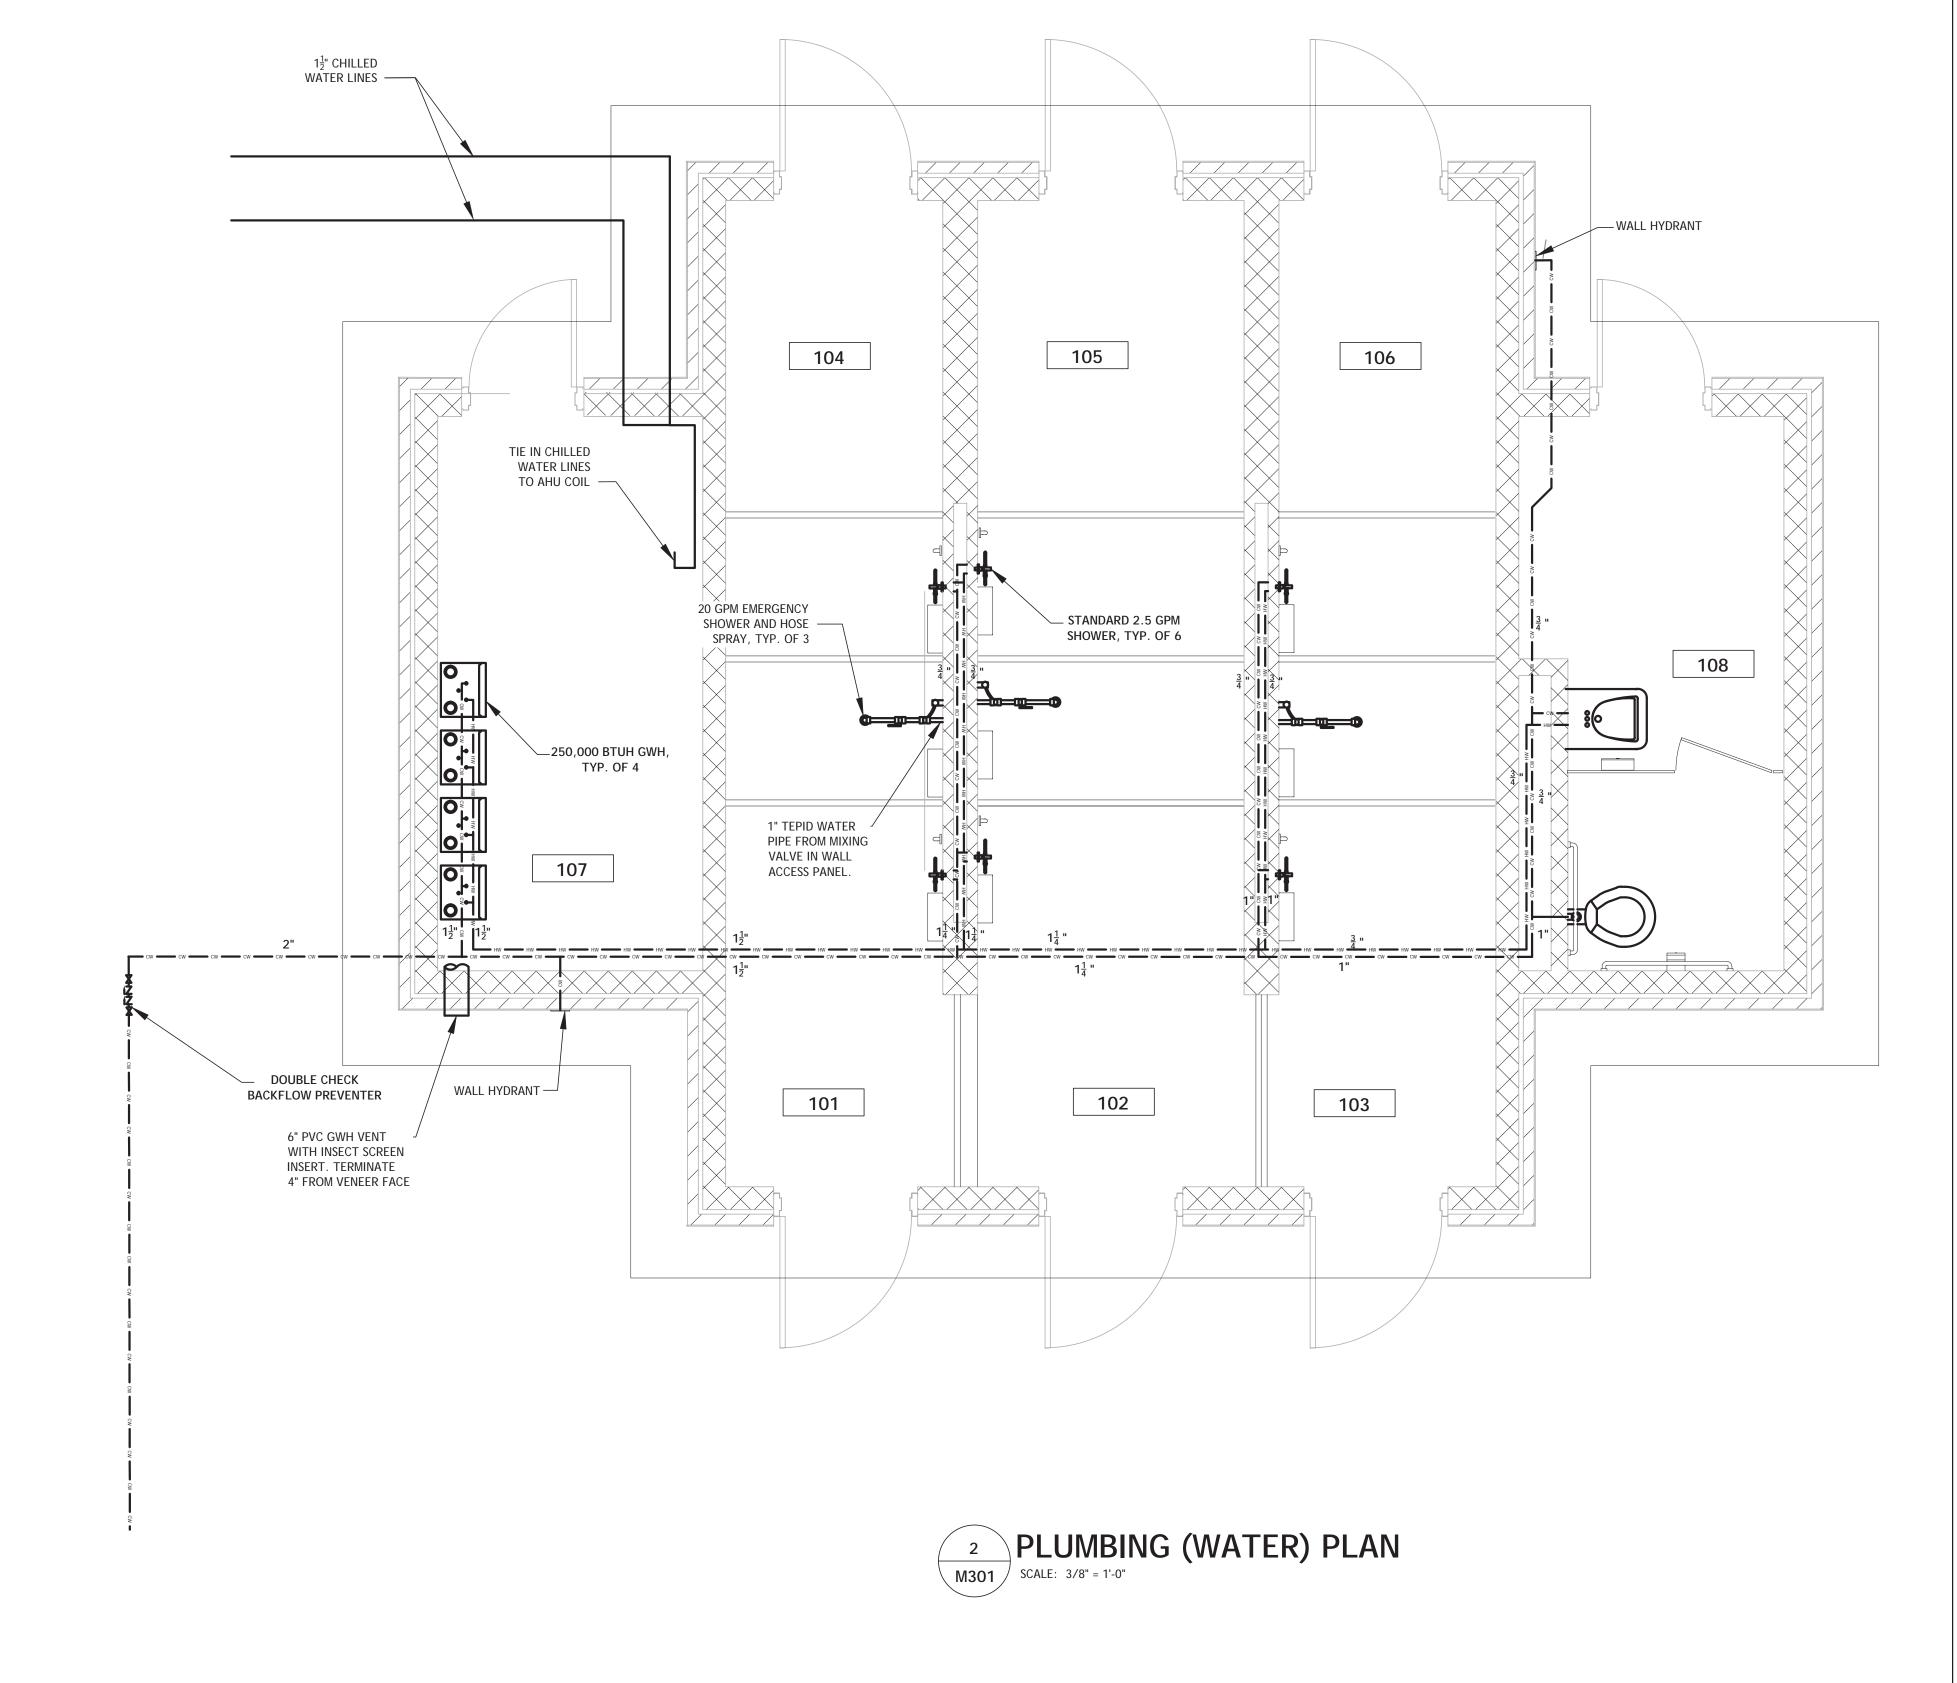
FURNISH AND INSTALL CHILLED WATER SOLENOID AND ISOLATION VALVES, IN ADDITION TO OTHER ACCESORIES AS RECOMMENDED BY THE AHU VENDOR FOR A COMPLETE AND FULLY OPERATIONAL

INSTALL EMERGENCY SHOWER THERMOSTATIC MIXING VALVE IN FLUSH, S.S., WATERTIGHT CABINET IN WALL. CABINET BOTTOM TO

EMERGENCY SHOWER SUPPLY PIPE SHALL EXIT WALL HORIZONTALLY


AND CONNECT TO SHOWER SIDE CONNECTION. TOP CONNECTION

SHALL REMAIN PLUGGED. CONTRACTOR SHALL FURNISH AND INSTALL ALL EQUIPMENT NECESSARY TO MONITOR UNDERGROUND SEWAGE STORAGE TANK. SEE SPECIFICATIONS AND SHEET FOR M101 FOR MORE INFO.



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Consultants: BURK-KLEINPETER, INC. ENGINEERS, ARCHITECTS, PLANNERS, ENVIRONMENTAL SCIENTISTS 4176 CANAL STREET, NEW ORLEANS, LA 70119—5994 PHONE (504)486-590¶ FAX (504)488-1714



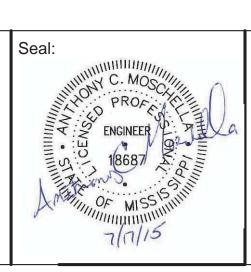

Approved:	
PROGRAM MANAGER, PROJECTS	
SAFETY/INDUSTRIAL HYGIENE	
HEALTH SYSTEM SPECIALIST	
MAINTENANCE SUPERVISOR	
MAINTENANCE FOREMAN	
MAINTENANCE FOREMAN	


Approved: Service Director


PLUMBING PLAN **VA Gulf Coast Decontamination Unit** Approved: Service Engineer XX


VAMC BILOXI, MS

7/17/2015 520-13-136 **M301** 



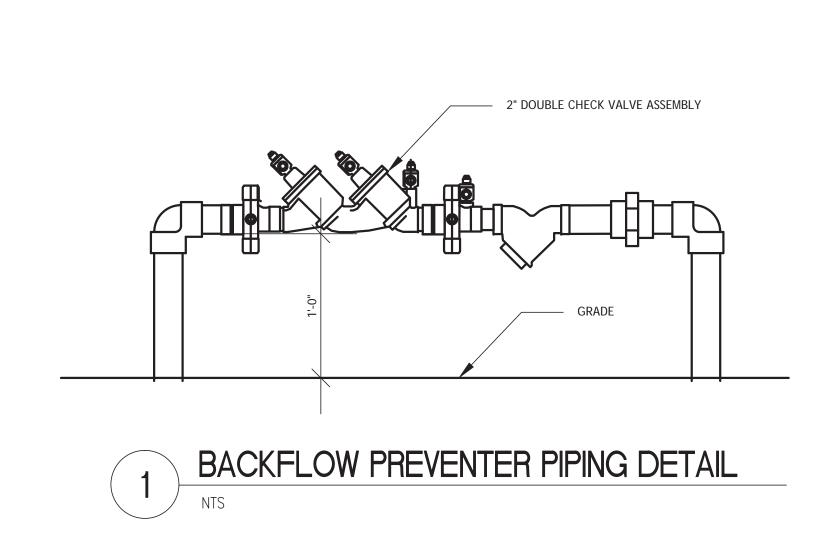


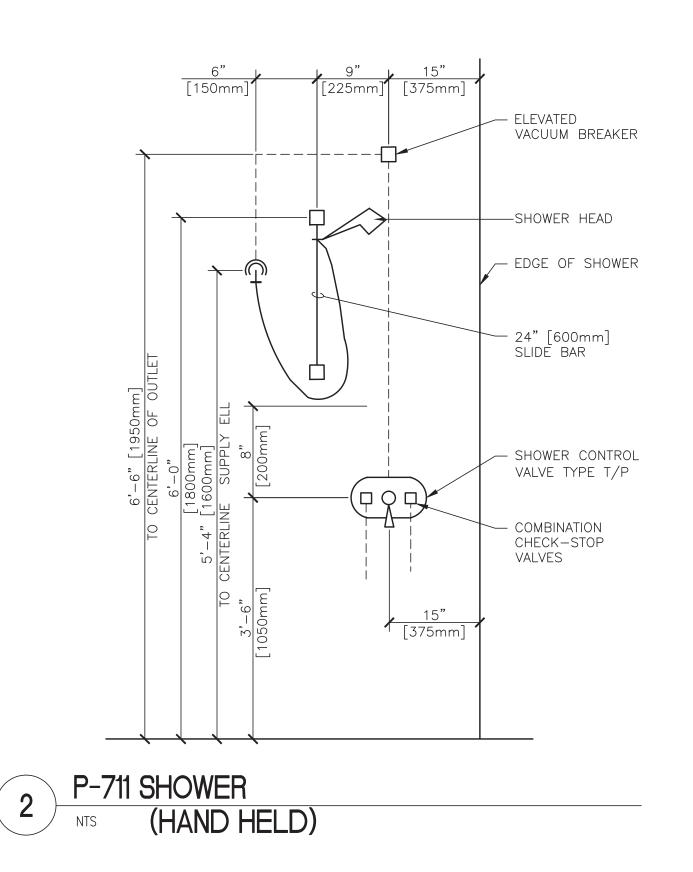

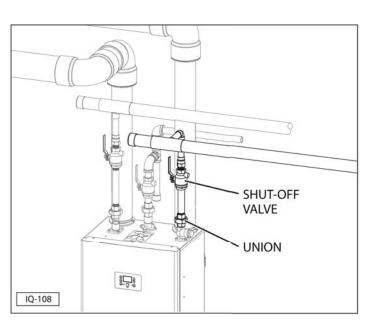


WATER HEATER WATER HOOKUP(TYP)

NTS

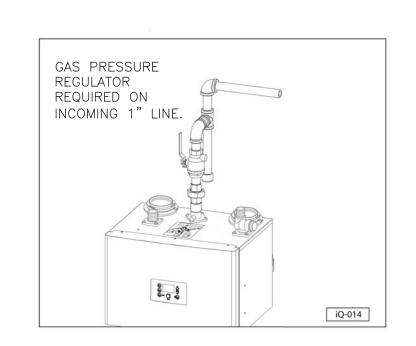

WATER HEATER GAS HOOKUP

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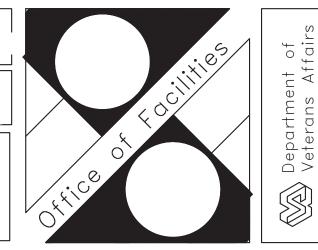
Approved:	
PROGRAM MANAGER, PROJECTS	
I ROOKAWI WANAOER, I ROJECTS	
SAFETY/INDUSTRIAL HYGIENE	
HEALTH SYSTEM SPECIALIST	
MAINTENANCE SUPERVISOR	
MAINTENANCE FOREMAN	
MAINTENANCE FOREMAN	

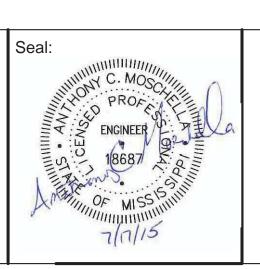Approved: Service Director

ISC PLUMBING DETAILS	Project Title <b>VA</b>	Gulf Co	ast	Date
	Deconta	aminatio	on Unit	roj
Service Engineer	Building Number	Checked	Drawn	DRA

VAMC BILOXI, MS


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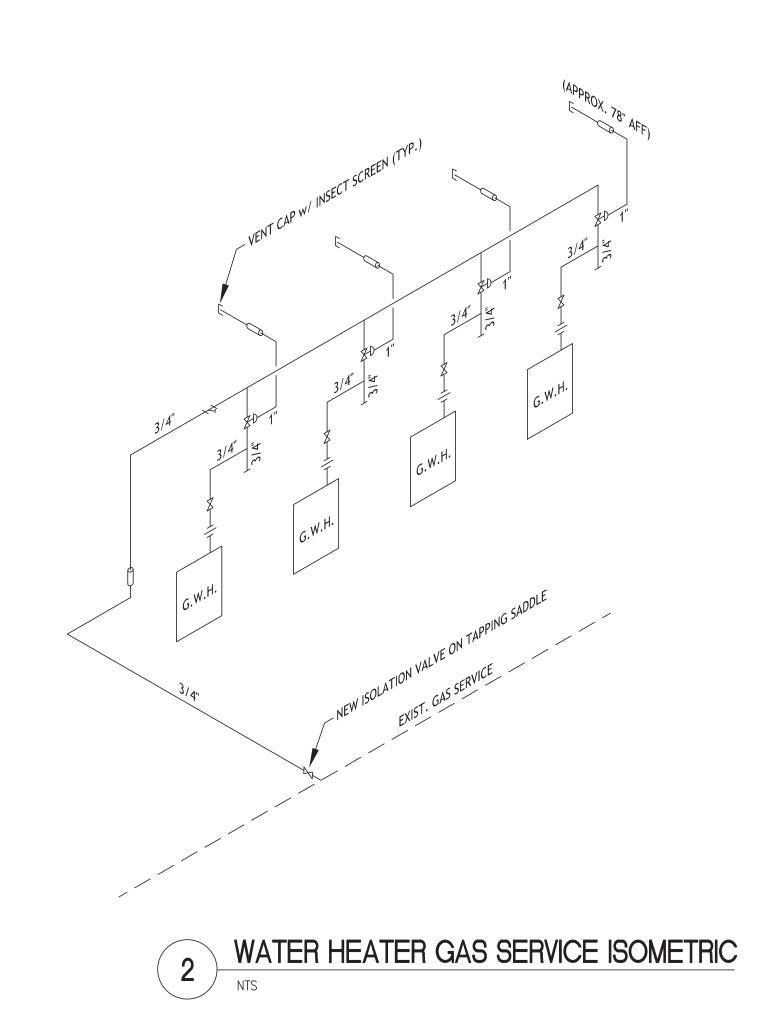


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**ROYAL ENGINEERS** & CONSULTANTS, LLC 4298 ELYSIAN FIELDS AVENUE NEW ORLEANS, LOUISIANA 70122 www.royalengineering.net





WATER HEATER VENT PIPING ISOMETRIC

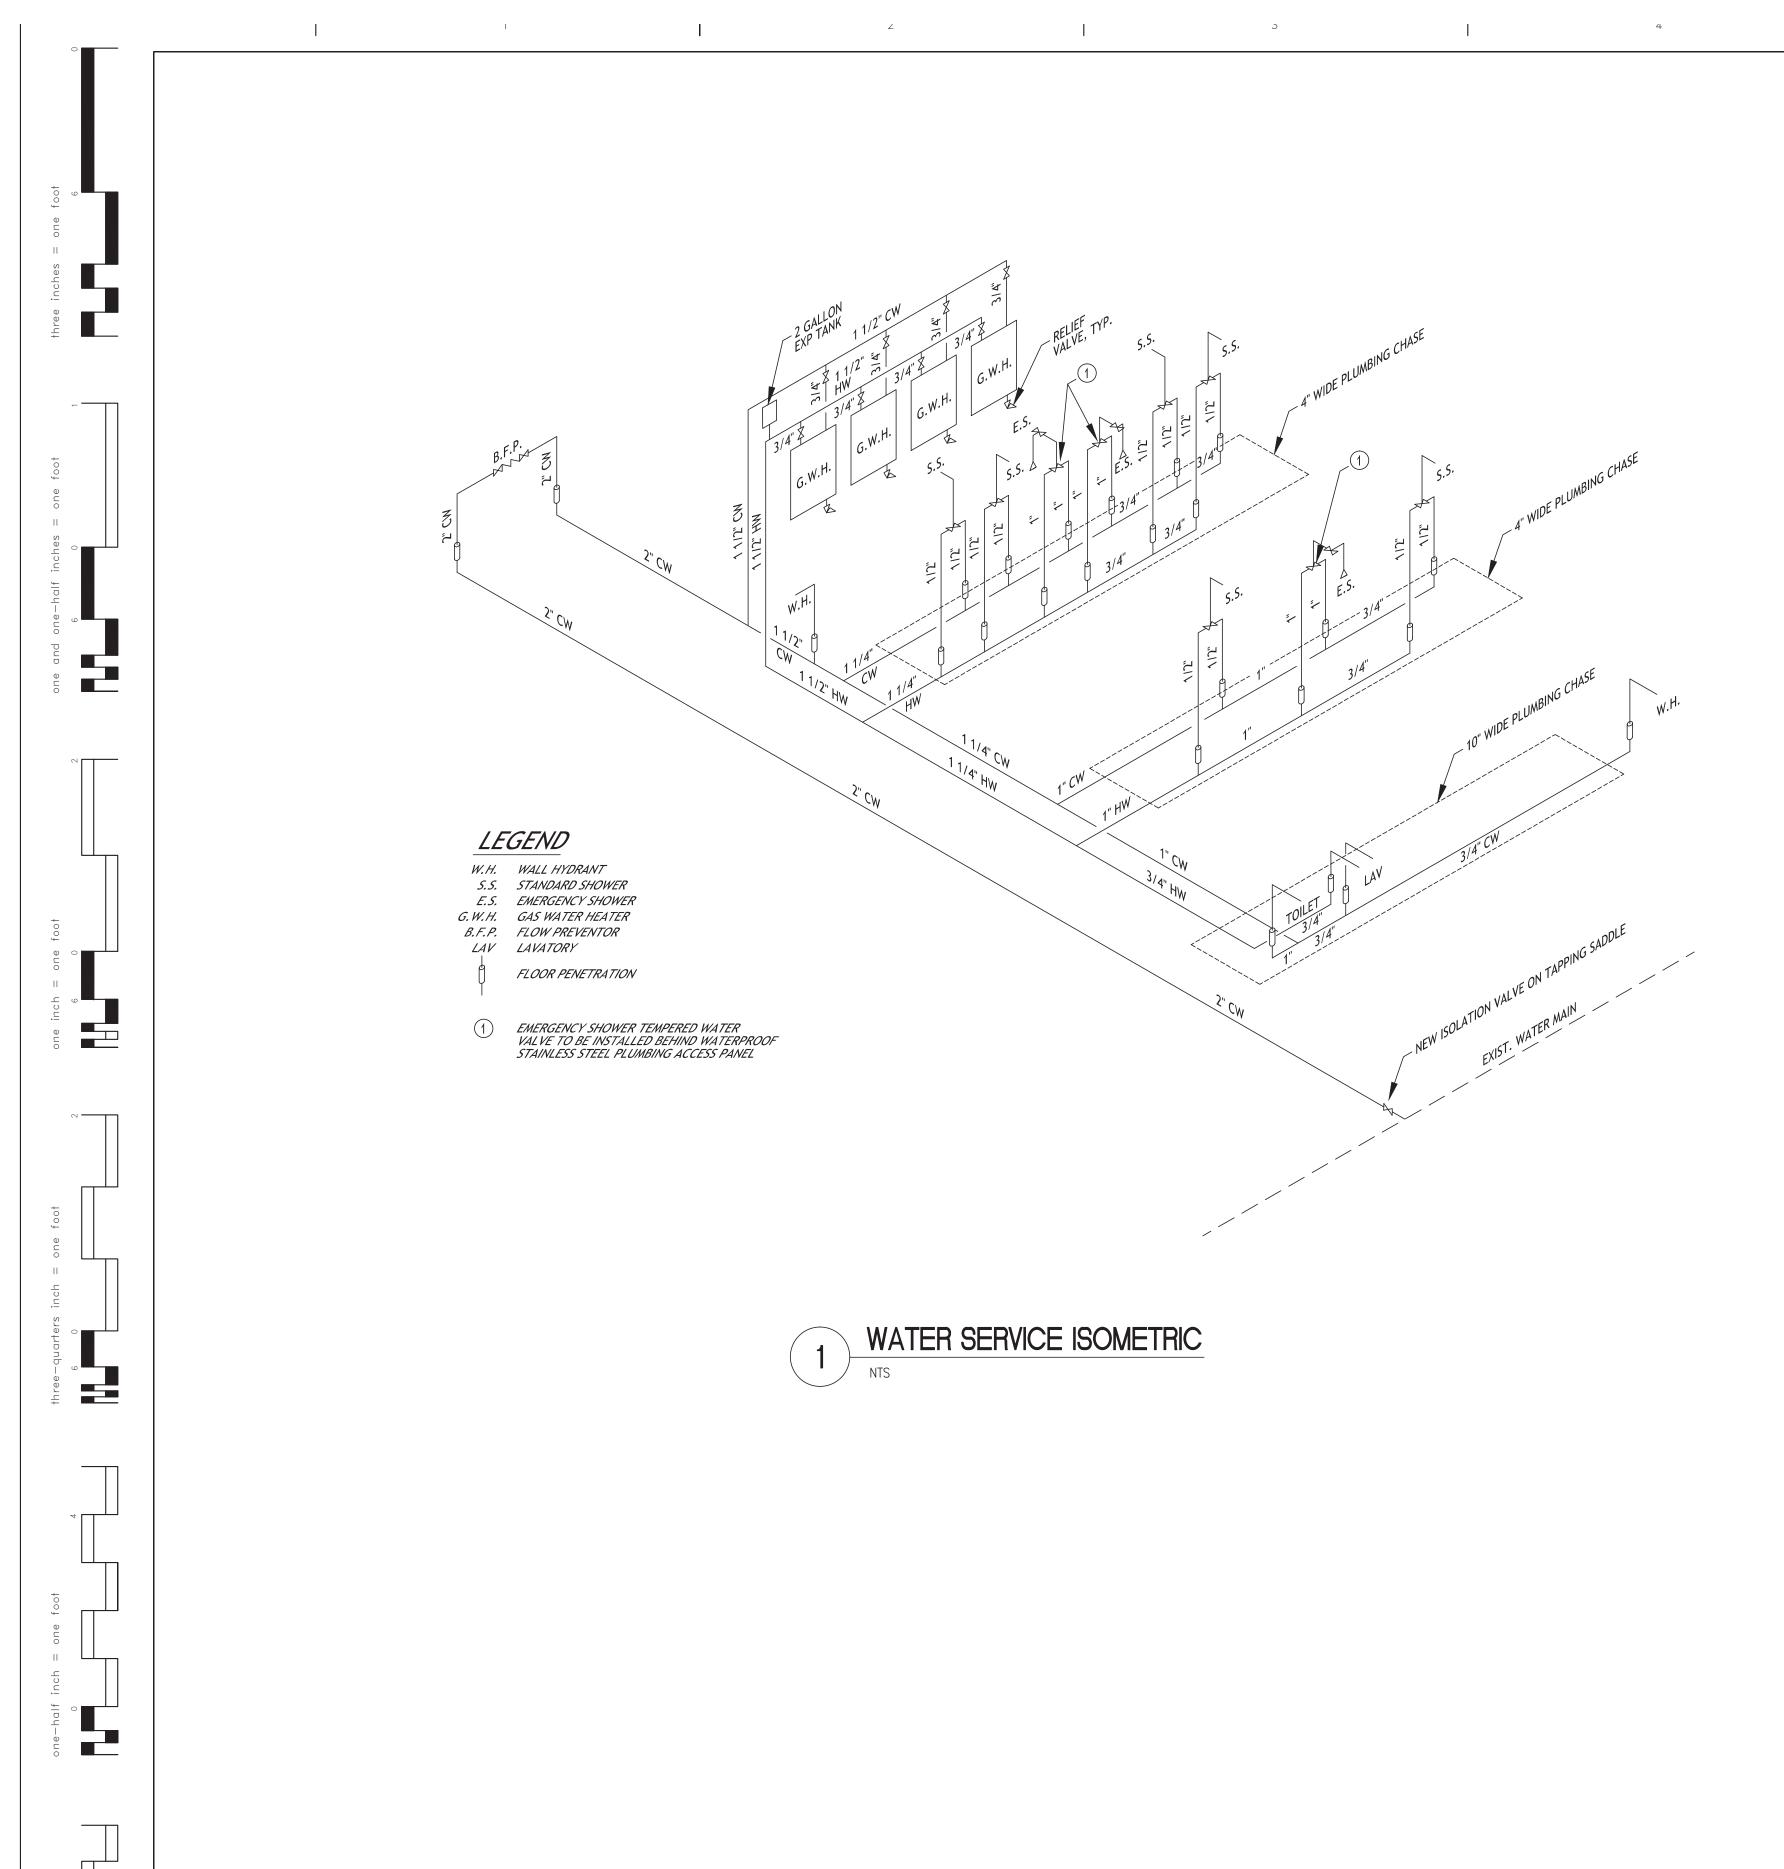
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TAPPING SADDLE ISOLATION VALVES SHALL BE INSTALLED VERTICAL, DEPTH PERMITTING, WITH CAST IRON VALVE BOXES.

GAS REGULATOR OUTLET PRESSURE: 5" H20





	Approved:
ERS LLC	PROGRAM MANAGER, PROJECT SAFETY/INDUSTRIAL HYGIEN
	HEALTH SYSTEM SPECIALIST
NUE 70122	MAINTENANCE SUPERVISOR
	MAINTENANCE FOREMAN
	MAINTENANCE FOREMAN

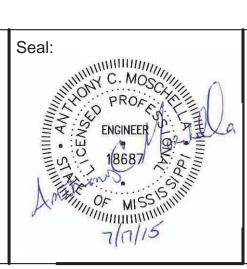	MISC PLUMBING DETA
DJECTS	
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IST	
OR	Approved: Service Engineer
·	Approved: Service Director

**VA Gulf Coast Decontamination Unit** Checked

XX

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7/17/2015 520-13-136 M303



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