

three inches = one foot  
one and one half inches = one foot  
one inch = one foot  
three quarters inch = one foot  
one half inch = one foot  
one quarter inch = one foot  
one eighth inch = one foot

GENERAL SHEET NOTES


1. REFER TO SHEET A001 FOR GENERAL ARCHITECTURAL INFORMATION
2. ALL DRAWING REFERENCES REFER TO DRAWINGS ON BLDG #3, COMMITAL SHELTER, UNLESS NOTED OTHERWISE.
3. AT STUCCO WALLS PROVIDE A STOP WITH A DRIP WHERE METAL RUNNER TRACK MEETS THE STEM WALL. IMMEDIATELY BELOW PROVIDE A STUCCO STOP AND CARRY THE STUCCO DOWN THE STEM WALL A MINIMUM OF 8" BELOW FINISHED GRADE.
4. REFER TO ELECTRICAL DRAWINGS FOR OUTLETS.

KEYED NOTES

1. GALVALUME STANDING SEAM ROOF ON 60 MIL HIGH TEMPERATURE ICE AND SNOW BARRIER ON 3/4" CDX PLYWOOD DECK.
2. GALVALUME GUTTER.
3. PT 2X8 AND 2X10 WRAPPED WITH 24 GA GALVALUME.
4. 2X6 FRAMING.
5. 2X6 BLOCKING.
6. 6.75 X 10.5 GLUE LAM BEAMS. SEE STRUCTURAL.
7. GALVALUME DOWNSPOUT, WEST ELEVATION ONLY.
8. 5" CONCRETE SLAB, SLOPE, SEE STRUCTURAL.
9. GALVALUME METAL COPING.
10. R19 BATT INSULATION.
11. SEISMIC VENER ANCHOR, DUROWALL MODEL NO. DA431. INSTALL AT 16" OC EACH WAY. INSTALL PENCIL ROD, DUROWALL MODEL NO. DA8706, BETWEEN TIES ON THE STONE VENER.
12. 2X6 WOOD TONGUE & GROOVE CEILING DECK.
13. STONE, SEE FINISH SCHEDULE.
14. REINFORCING STEEL, SEE STRUCTURAL.
15. 6" STL TUBE FRAME COLUMN, WITH STONE COVER, SEE STRUCTURAL AND FINISH SCHEDULE.
16. CONCRETE SPREAD/SPOT FOOTING AND REINFORCED CONCRETE PEDESTAL, SEE STRUCTURAL.
17. #3 TIES.
18. SIX #4 VERTICALS.


DISCOVERY CLAUSE

IN THE EVENT THAT BONES OR HISTORIC ARCHAEOLOGICAL MATERIAL ARE UNCOVERED DURING CONSTRUCTION OR EARTH-DISTURBING ACTIVITIES, CEASE WORK IMMEDIATELY AND PROTECT THE REMAINS FROM FURTHER DISTURBANCE. NOTIFY THE OWNER, THE DIRECTOR OF FORT BLISS NATIONAL CEMETERY AT (915) 564-0201. THE OWNER WILL CONTACT THE NEW MEXICO HISTORIC PRESERVATION DIVISION (SHPO). THE OWNER AND SHPO MAY DISCUSS THE APPROPRIATE WAY TO PROCEED. DIRECTION TO THE CONTRACTOR WILL BE PROVIDED BY THE OWNER.

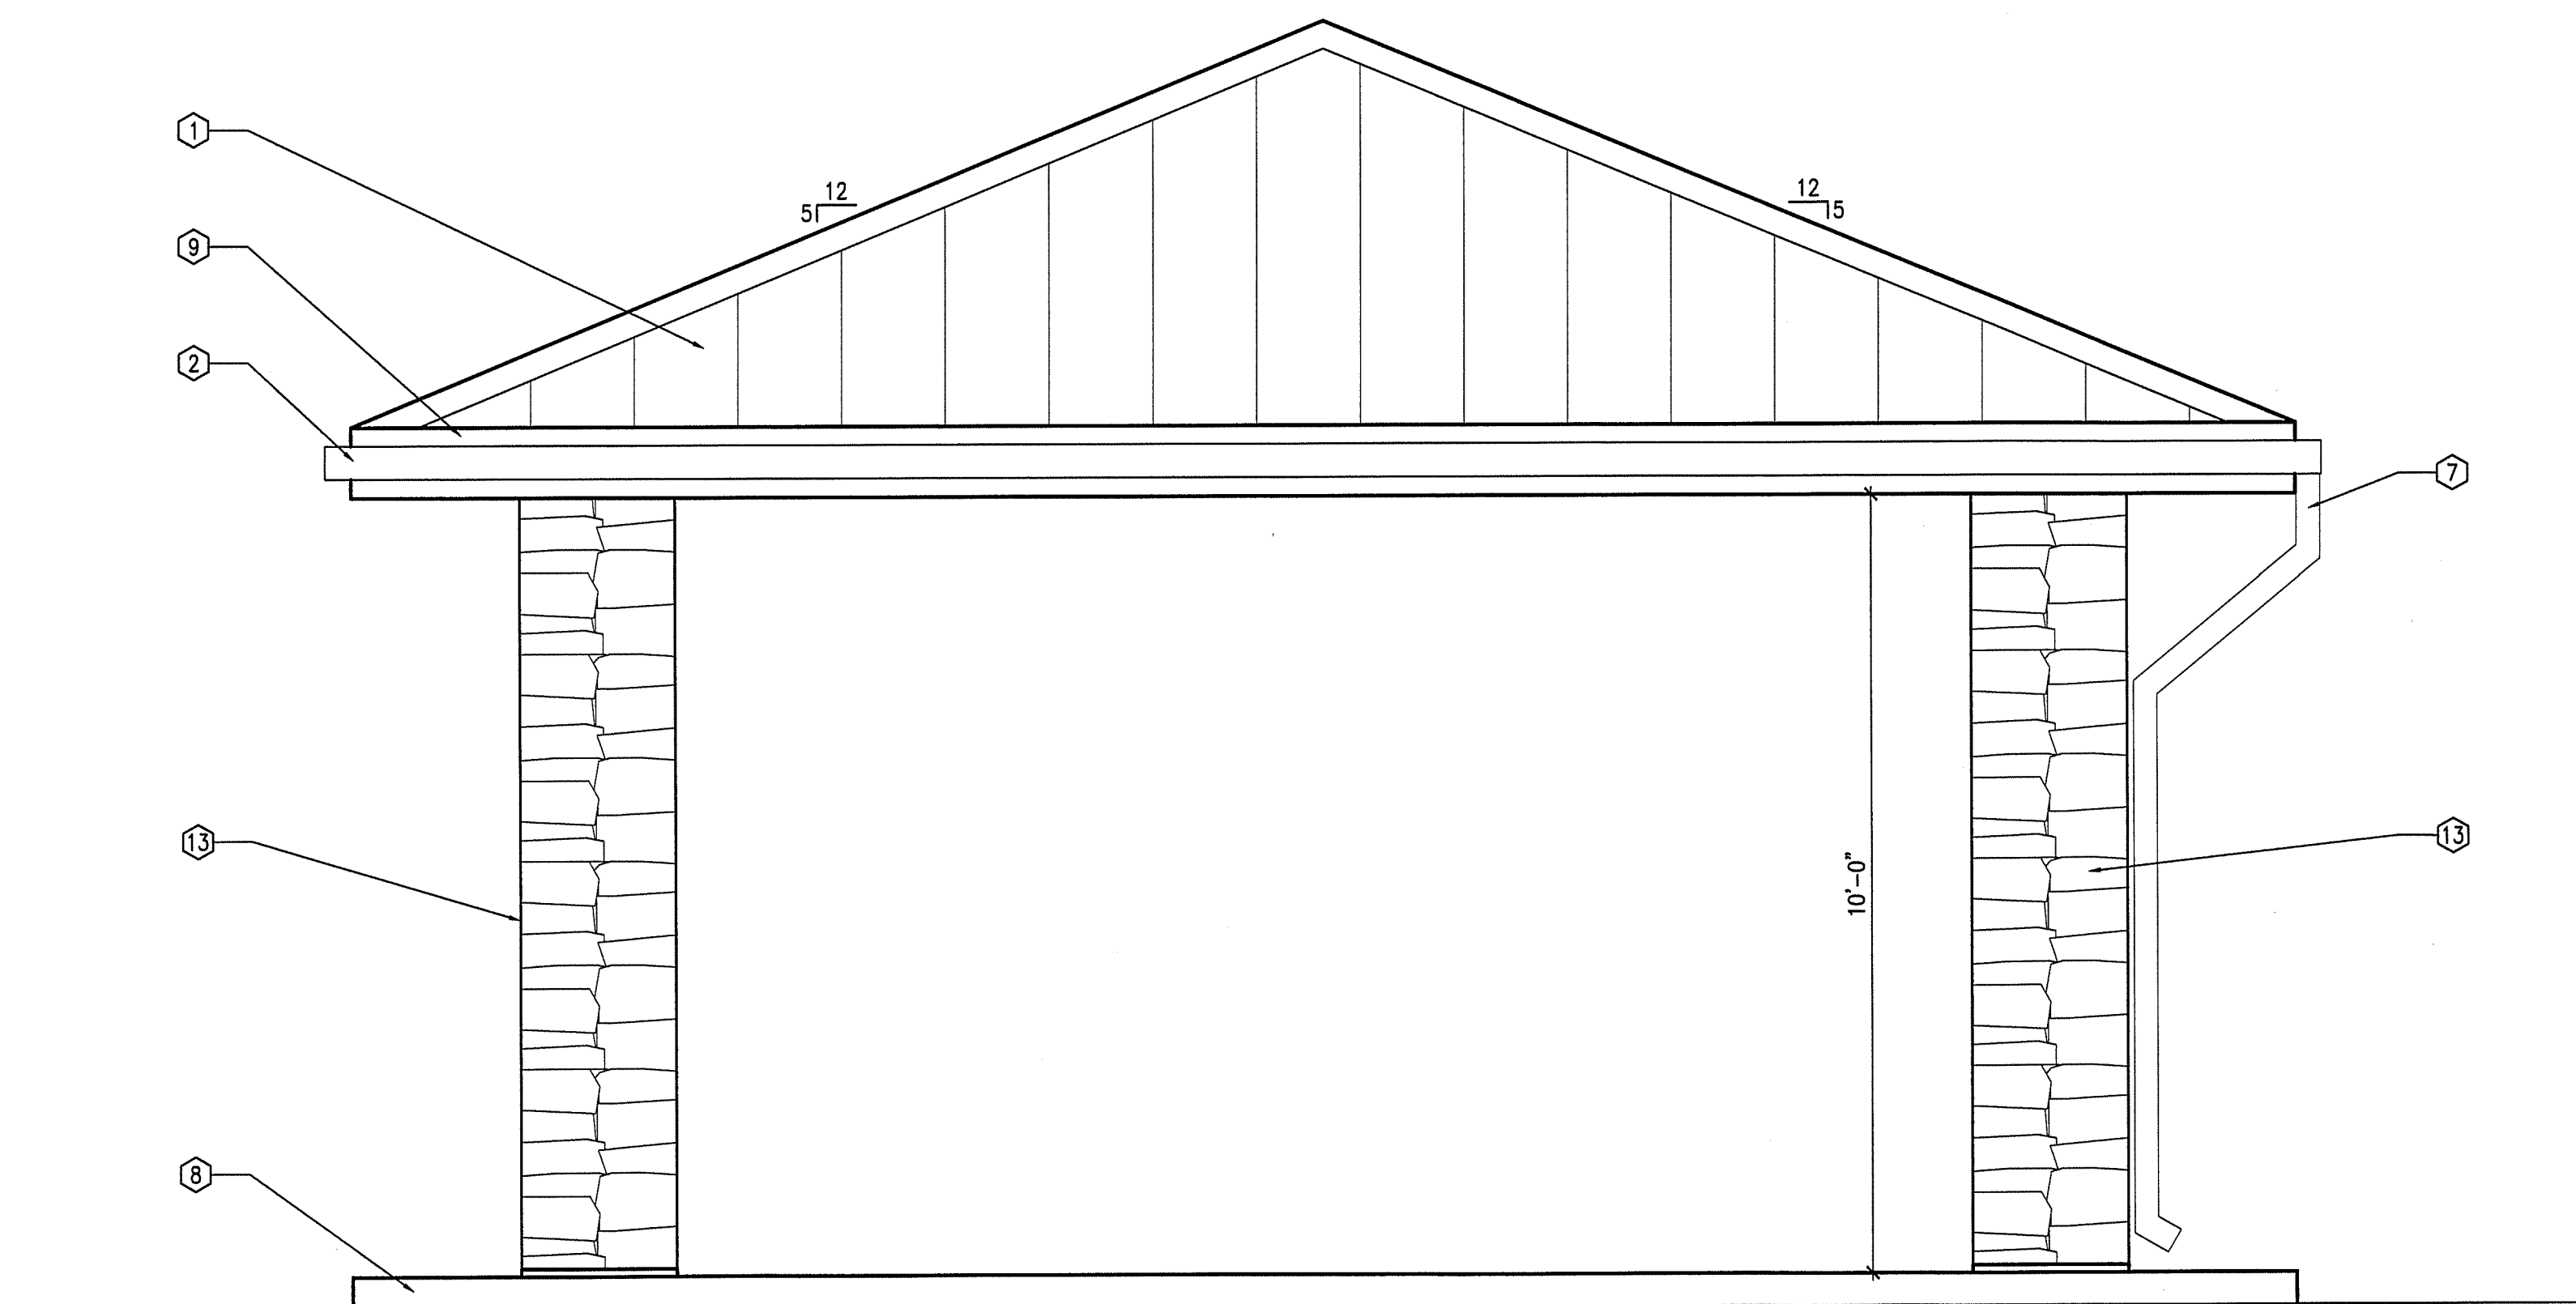

E3  
A221  
COMMITTAL SHELTER ELEVATION  
NOTE: ALL ELEVATIONS SIMILAR



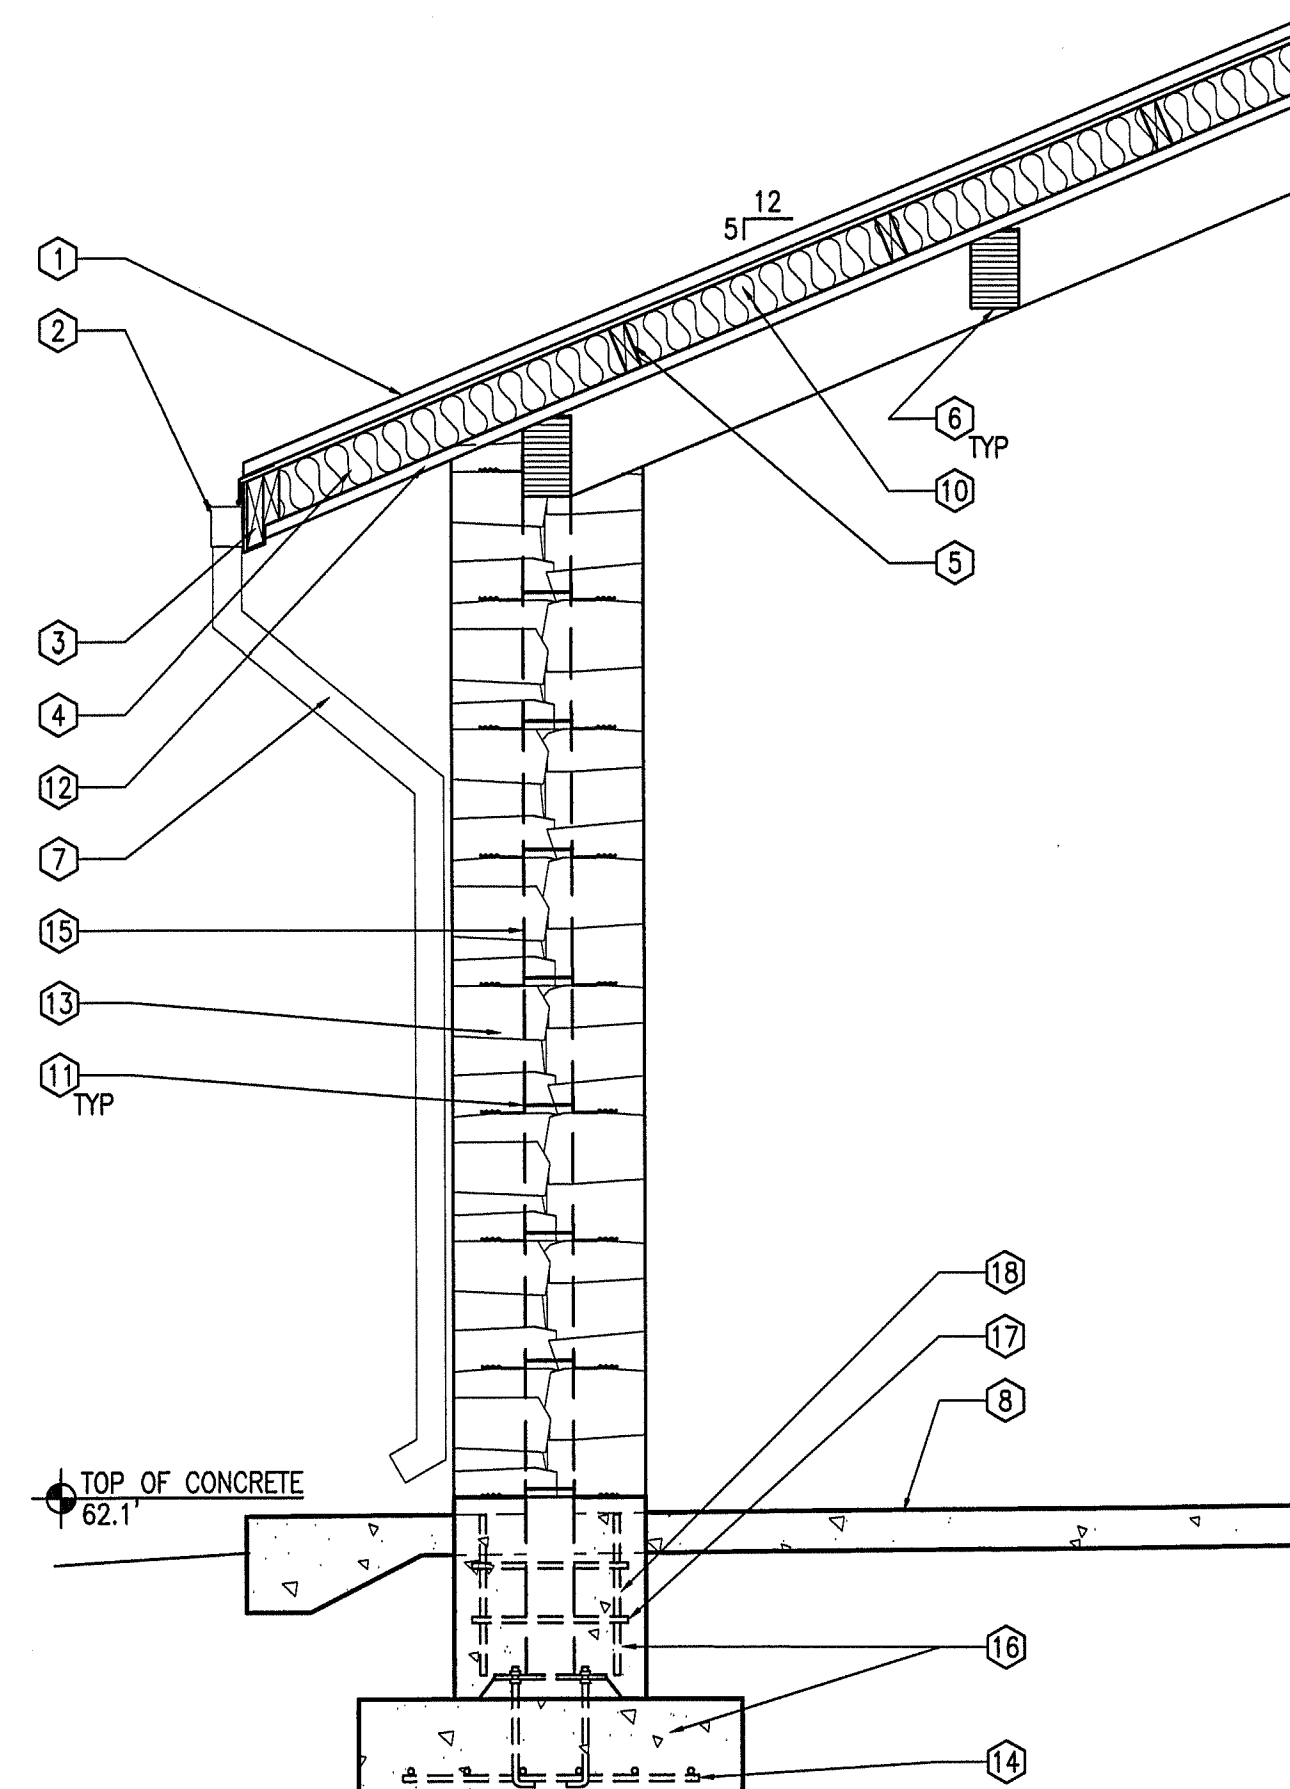


SCALE: 1/2" = 1'-0"



E6  
A221  
COMMITTAL SHELTER SECTION

SCALE: 1/2" = 1'-0"

100% CONSTRUCTION DRAWINGS

SUB-CONSULTANTS		PRIME CONSULTANT		Drawing Title		Project Title		Project Number		NATIONAL CEMETERY ADMINISTRATION OFFICE OF DESIGN AND CONSTRUCTION	
 MORROW REARDON WILKINSON MILLER, LTD., LANDSCAPE ARCHITECTS 210 La Teta NE, Albuquerque, NM 87108 505-268-2286 FAX 505-265-9597 mrw@mrwnm.com		 CHERRY/SEAR/REAMES ARCHITECTS, LLP 225 OLD AVENUE SW, ALBUQUERQUE, NM 87102 505-242-1275 FAX 505-242-4228		  2020 K STREET, SUITE 300 WASHINGTON, DC 20006 TELEPHONE: (202)872-0277 FAX: (202)872-0282.		COMMITTAL SHELTER ELEVATION, SECTION AND ROOF DETAILS		88SCM3007			
Revisions:		Date		Approved: Director Office of Construction Management		Location FORT BAYARD, NEW MEXICO		Building Number BLDG #3			
						Date NOVEMBER 18, 2011		Checked DJS		Drawing Number A-221	
								Drawn ALR		Dwg. 113 of 120	
										 Department of Veterans Affairs	