

three inches = one foot
one and one-half inch = one foot
one inch = one foot
three-quarters inch = one foot
one-half inch = one foot
three-eighths inch = one foot
one-quarter inch = one foot
one-eighth inch = one foot

GENERAL NOTES:


- A. NEW SPRINKLER MAIN PIPING SHALL BE RUN PARALLEL TO EXISTING UNLESS OTHERWISE INDICATED. EXISTING SPRINKLER MAIN PIPING SHALL REMAIN IN PLACE AND ACTIVE UNTIL SHUTDOWN AND CHANGE OVER IS SCHEDULED.
- B. ALL PIPE HANGERS SHALL BE SUPPORTED FROM THE STRUCTURAL CONCRETE SLAB ATTACHMENT TO CONCRETE ENCASED STEEL BEAMS IS STRICTLY PROHIBITED.
- C. SYSTEM SHUT-DOWNS ARE LIMITED TO 8 HOUR INTERVALS WITH NO EXCEPTIONS. COORDINATE CLOSELY WITH THE OWNER AND FOLLOW ALL OWNER SHUT-DOWN REQUIREMENTS AND PROCEDURES.
- D. COORDINATE ALL FIRE ALARM WORK WITH THE OWNER AND SIMPLEX.

REMOVAL NOTES:


- 1 DISCONNECT AND REMOVE SPRINKLER MAIN PIPING AT BASE OF RISER. SPRINKLER RISER PIPING UP TO REMAIN. PREPARE RISER PIPING FOR RECONNECTION.
- 2 DISCONNECT AND REMOVE INDICATING CONTROL VALVE WITH TAMPER SWITCH AND FLOW SWITCH IN THEIR ENTIRETY. EXISTING FIRE ALARM SYSTEM MONITORING MODULE AND ASSOCIATED WIRING TO REMAIN.
- 3 DISCONNECT AND REMOVE INDICATING CONTROL VALVE WITH TAMPER SWITCH IN ITS ENTIRETY. EXISTING FIRE ALARM SYSTEM MONITORING MODULE AND ASSOCIATED WIRING TO REMAIN.
- 4 FIRE ALARM DEVICES SHALL BE DISABLED FROM THE FIRE ALARM SYSTEM TO ALLOW FOR THE DISCONNECTION OF SYSTEM WIRING AND REMOVAL OF TAMPER AND/OR FLOW SWITCH DEVICES.

DRAWING NOTES:

- 1 CONNECT SPRINKLER MAIN PIPING TO BASE OF RISER PIPING PREVIOUSLY PREPARED FOR RECONNECTION.
- 2 PROVIDE INDICATING CONTROL VALVE WITH TAMPER SWITCH AND FLOW SWITCH. RECONNECT TAMPER AND FLOW SWITCHES TO EXISTING FIRE ALARM SYSTEM MONITORING MODULE.
- 3 PROVIDE INDICATING CONTROL VALVE WITH TAMPER SWITCH. RECONNECT TAMPER SWITCH TO EXISTING FIRE ALARM SYSTEM MONITORING MODULE.
- 4 PROVIDE 8"x6" REDUCING FITTING.
- 5 RE-CONNECT SYSTEM WIRING TO NEW DEVICE AS INDICATED UPON COMPLETION OF INSTALLATION. EXTEND SYSTEM WIRING AS NECESSARY TO NEW DEVICE. SPLICING OF WIRES IS NOT ACCEPTABLE. PROVIDE NEW WIRING TO MAKE CONNECTION COMPLETE. PROVIDE ANY AND ALL ELECTRICAL WORK AND MATERIALS TO EXTEND SYSTEM WIRING. PROVIDE SYSTEM TESTING AND VERIFICATION OF DEVICE CONNECTION AND NOTIFICATION UPON COMPLETION OF EACH DEVICE.

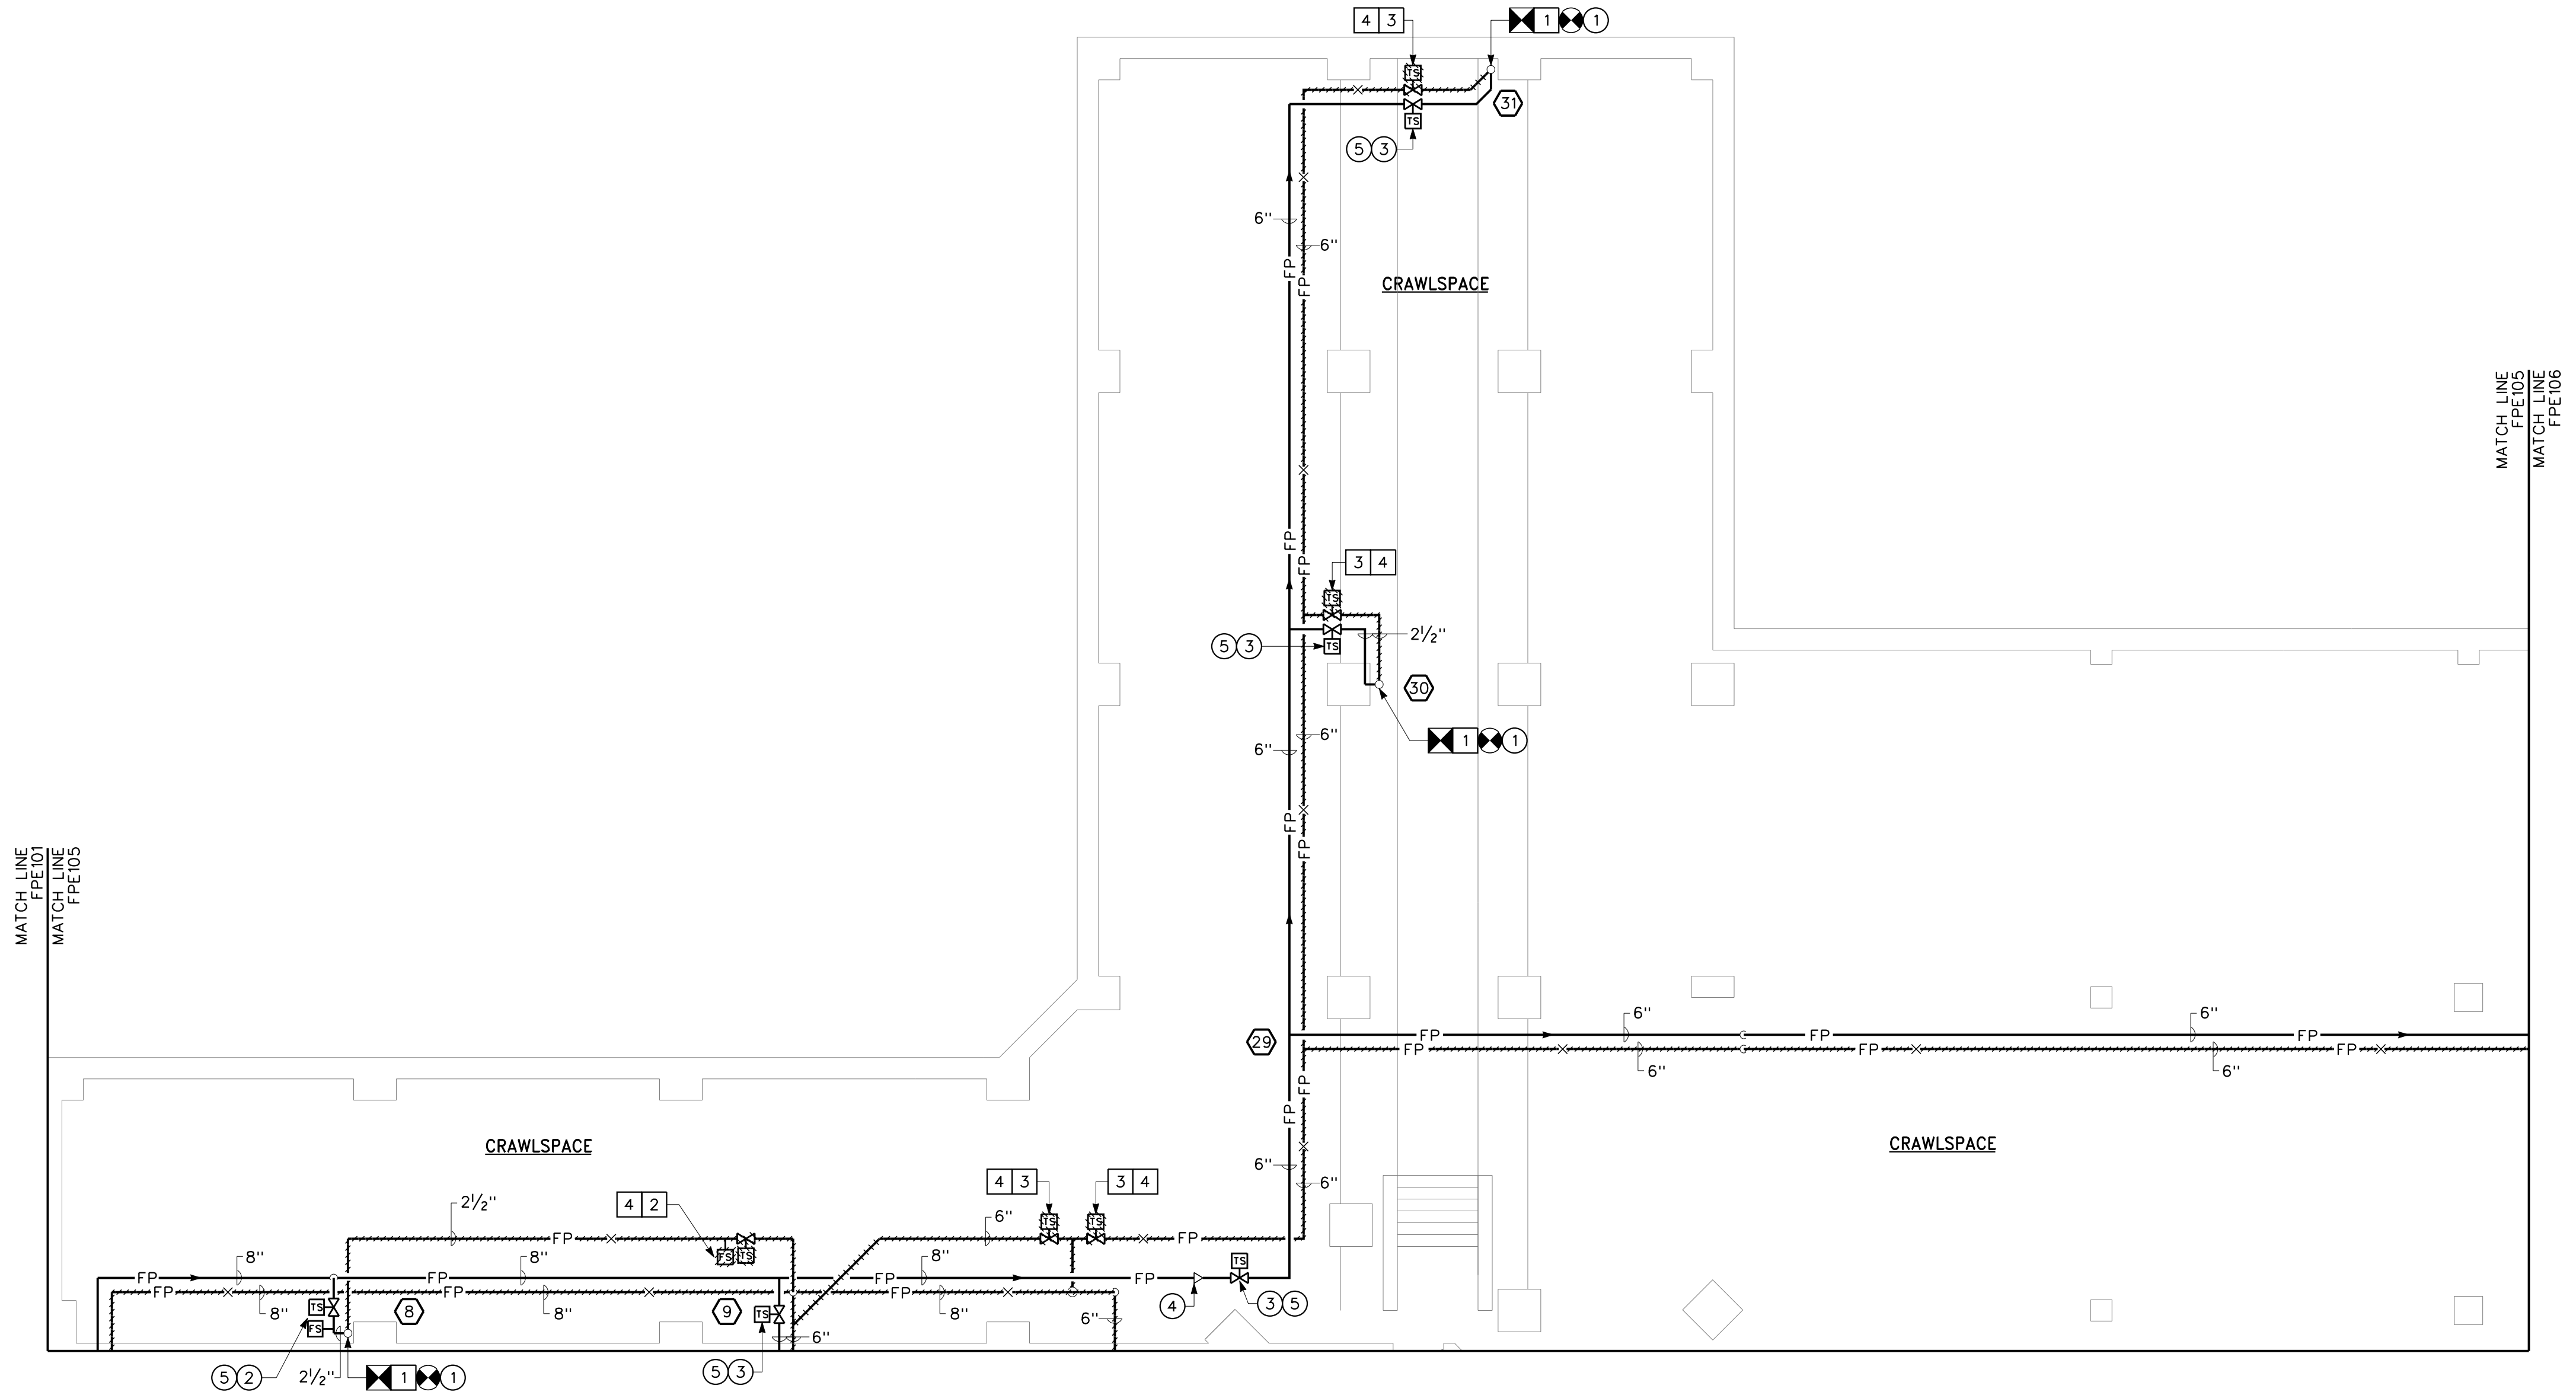

PARTIAL SUB-BASEMENT FLOOR PLAN – BUILDING No. 1 – 'C' WING – FIRE PROTECTION 1
1/8" = 1'-0"

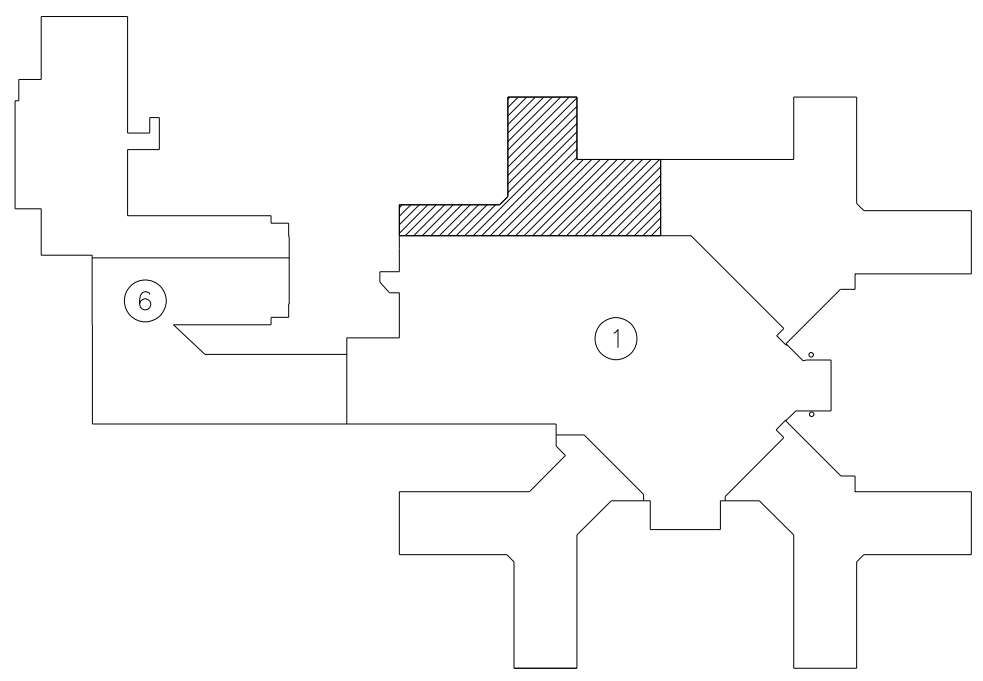

KEY PLAN
NO SCALE

CONSTRUCTION DOCUMENTS	07/01/11
90% SUBMISSION	06/10/11
60% SUBMISSION	12/10/10
Revisions	Date

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stamp

CARDIOLOGY MANAGER	DATE	ENGINEERING MANAGER	DATE
INFECTION CONTROL	DATE	CARELINE MANAGER	DATE
SAFETY OFFICER	DATE	CHIEF OF STAFF	DATE

Drawing Title	
PARTIAL SUB-BASEMENT FLOOR PLAN, 'C' WING No. 1 – 'C' WING	
MEDICAL CENTER DIRECTOR	DATE
ASSOCIATE MEDICAL CENTER DIRECTOR	DATE

Project Title		
REPLACE SPRINKLER MAINS		
Building Number	Checked	Drawn
1 AND 6	DDR	KGP
Location		
V.A.M.C. BUFFALO, NEW YORK		

Date
DECEMBER 10, 2010
Station No.
528
10-107-FPE105

