


NEW WORK KEYED NOTES:
(THIS DRAWING ONLY)

- ① PROVIDE AND INSTALL NEW TRIPLE ZONE VALVE AND RECESSED BOX ASSEMBLY; MEDICAL AIR, OXYGEN, AND MEDICAL VACUUM. BOTTOM OF VALVE BOX SHALL BE AT 54 INCHES ABOVE FINISHED FLOOR.
- ② PROVIDE AND INSTALL NEW AREA ALARM PANEL "A" AT APPROXIMATE LOCATION INDICATED. REFER TO SCHEDULE ON PLUMBING DRAWING PP501.
- ③ PROVIDE AND INSTALL NEW PRESSURE AND VACUUM TRANSDUCER SWITCH ON MEDICAL AIR, OXYGEN, AND MEDICAL VACUUM PIPING FOR AREA ALARM SYSTEM. LOW PRESSURE LIMIT TO BE SET BY INSTALLER.
- ④ PROVIDE AND INSTALL ONE DISS MEDICAL AIR, OXYGEN, AND MEDICAL VACUUM OULET/INLET AT APPROXIMATE LOCATION INDICATED. REFER TO ARCHITECTURE DRAWINGS FOR HEIGHT AND LOCATION.
- ⑤ PROVIDE AND INSTALL ONE DISS MEDICAL AIR AND OXYGEN OUTLET, AND TWO DISS MEDICAL VACUUM INLETS AT APPROXIMATE LOCATION INDICATED. REFER TO ARCHITECTURE DRAWINGS FOR HEIGHT AND LOCATION.

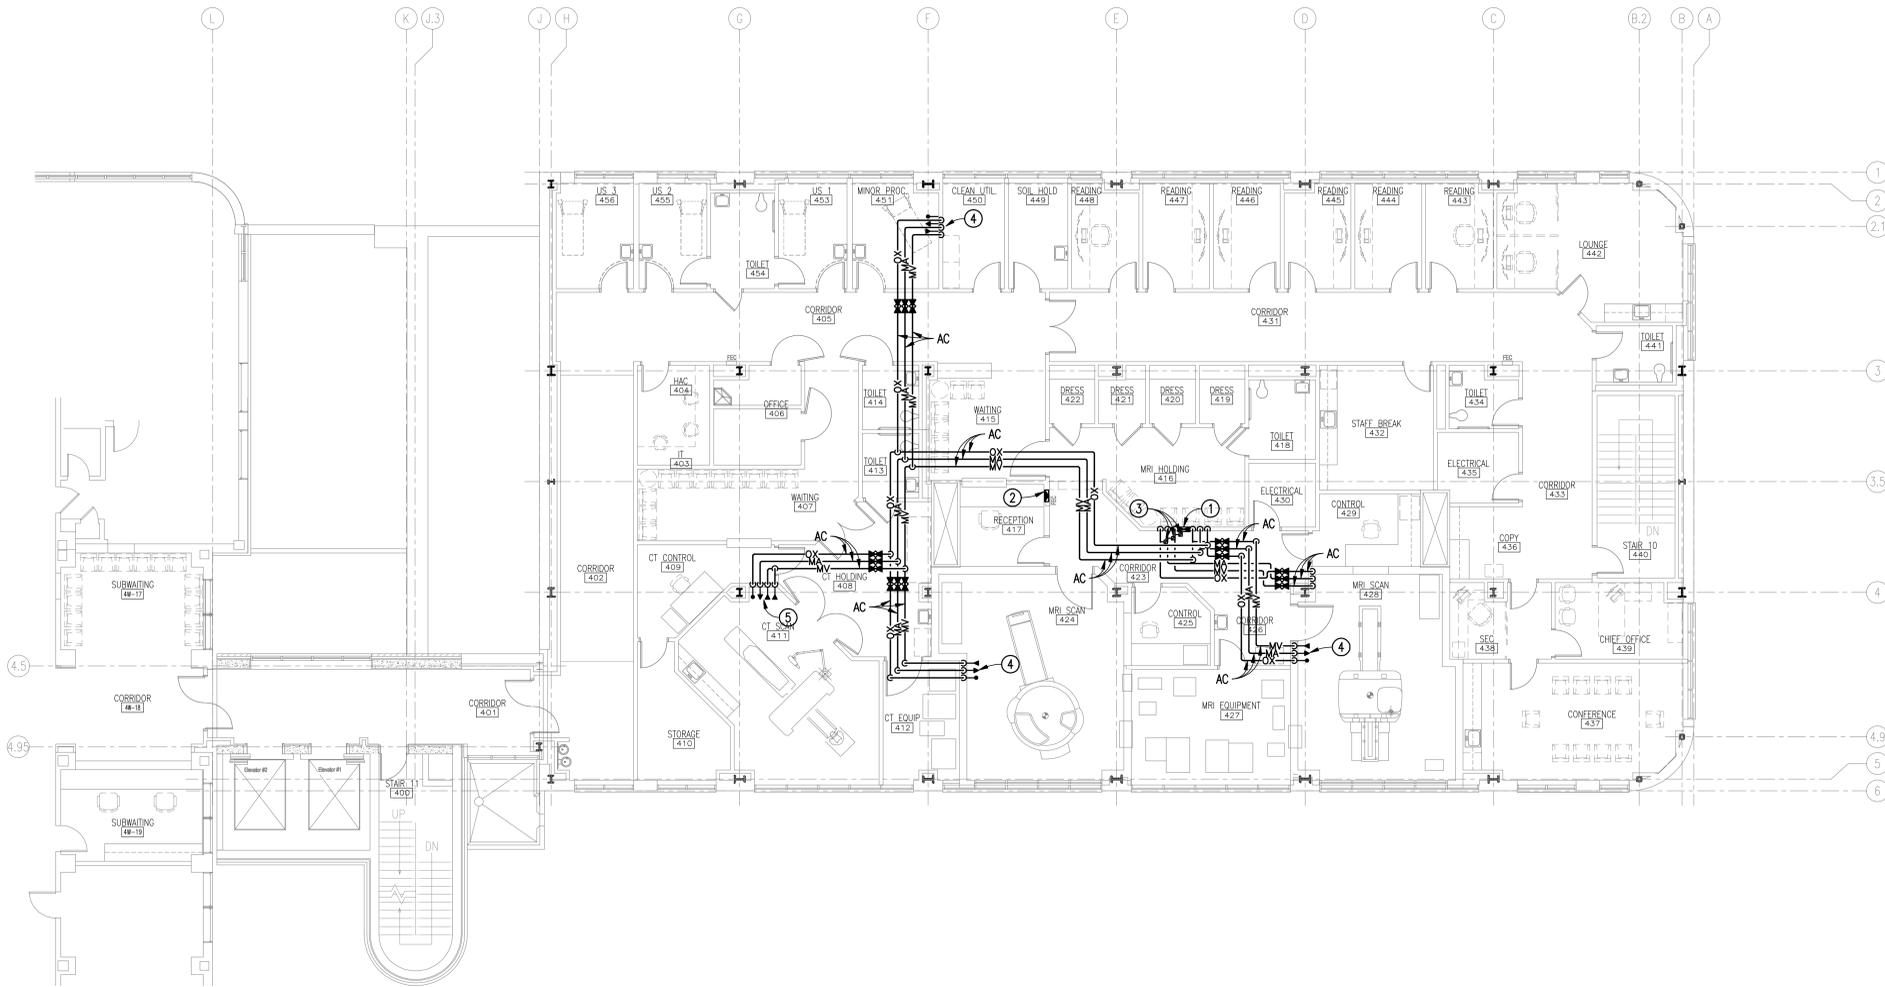

MEDICAL GAS DISTRIBUTION
FOURTH FLOOR NEW WORK PLAN
 SCALE: 1/8" = 1'-0"

GENERAL NOTES

- A. THESE DRAWINGS ARE DIAGRAMMATIC ONLY AND ARE NOT TO BE SCALED. FIELD VERIFY ALL DIMENSIONS, PIPE SIZES, AND INVERTS. REFER TO ARCHITECTURAL DRAWINGS FOR DIMENSIONS AND LOCATIONS OF ALL PLUMBING FIXTURES AND EQUIPMENT.
- B. COORDINATE PIPE ROUTING WITH DUCT ROUTING, EQUIPMENT LOCATIONS, ELECTRICAL INSTALLATIONS, AND BUILDING STRUCTURAL MEMBERS. OFFSET PIPING WHERE REQUIRED TO AVOID CONFLICTS. AVOID PENETRATING ANY MAIN STRUCTURAL BEAM. NOTIFY COR AND ARCHITECT OF ANY CONFLICTS.
- C. CONTRACTOR SHALL REMOVE AND REPAIR PORTIONS OF FLOORS, CEILINGS AND/OR SLABS AFFECTED BY PLUMBING MODIFICATIONS. REPAIR SURFACES TO MATCH EXISTING UNLESS NOTED OTHERWISE ON ARCHITECTURAL DRAWINGS.
- D. PRIOR TO PERFORMING ANY PLUMBING WORK OR PURCHASING ANY MATERIALS VERIFY EXACT LOCATION, ROUTING, AND PIPE SIZES, ETC. OF ALL EXISTING MEDICAL GAS PIPING.
- E. CONNECT PRESSURE SWITCHES TO AREA ALARM PANEL. CONNECT AREA ALARM ALARM TO MASTER ALARM PANEL. PROVIDE ALL NECESSARY CONDUIT, CONNECTORS, AND CONDUCTORS FOR COMPLETE AND OPERABLE LEVEL 1 ALARM SYSTEM PER NFPA 99. ALL ALARM COMMUNICATION WIRING SHALL BE ROUTED IN CONDUIT. PLUMBING CONTRACTOR SHALL WORK WITH ELECTRICAL CONTRACTOR TO INSURE ALL CONDUIT HAS BEEN RUN.
- F. ALL IN LINE MEDICAL GAS SHUT OFF VALVES SHALL BE OF LOCKING TYPE AND LOCKED OPEN UNLESS OTHERWISE NOTED.
- F. REFER TO ISOMETRIC RISER DIAGRAMS PLUMBING DRAWING PP302 FOR PIPE SIZES.
- G. SEE ARCHITECTURAL PLANS FOR WALL RATINGS.

FINAL SUBMITTAL

CONSULTANTS: CLARK•NEXSEN 440 MARTIN LUTHER KING, JR. BLVD. MACON, GA 31201 478-743-8415 FAX 478-743-8239 WWW.CLARKNEXSEN.COM		ARCHITECT: TOLAND MIZELL MOLNAR 590 Means Street NW, Suite 200 Atlanta, GA 30318 404.214.9774	Drawing Title: MEDICAL GAS DISTRIBUTION FOURTH FLOOR NEW WORK PLAN	Project Title: EXPAND RADIOLOGY AND SPS OVERTON BROOKS VAMC	Project Number: 667-083	OFFICE OF CONSTRUCTION AND FACILITIES MANAGEMENT U.S. Department of Veterans Affairs
			Approved: Project Director	Location: SHREVEPORT, LA	Building Number: 1	
Revisions:	Date:	Date: 04-17-2015	Checked: CARLTON	Drawn: BARNHART	Dwg. 88 of 160	

Drawing File: U:\5103-VA Shreveport 3rd and 4th Floors Drawings\513-5123 PP 104 Fourth Floor Lab Gas Supply Distribution.dwg
 Plotted by: DBarnhart
 Plotted Date: May 19, 2015 - 10:12am
 one-eighth inch = one foot
 one-quarter inch = one foot
 three-eighths inch = one foot
 one-half inch = one foot
 three-quarters inch = one foot
 one inch = one foot
 one and one-half inches = one foot
 three inches = one foot