



three inches = one foot
 one and one-half inches = one foot
 one inch = one foot
 three-quarters inch = one foot
 one-half inch = one foot
 three-eighths inch = one foot
 one-quarter inch = one foot
 one-eighth inch = one foot

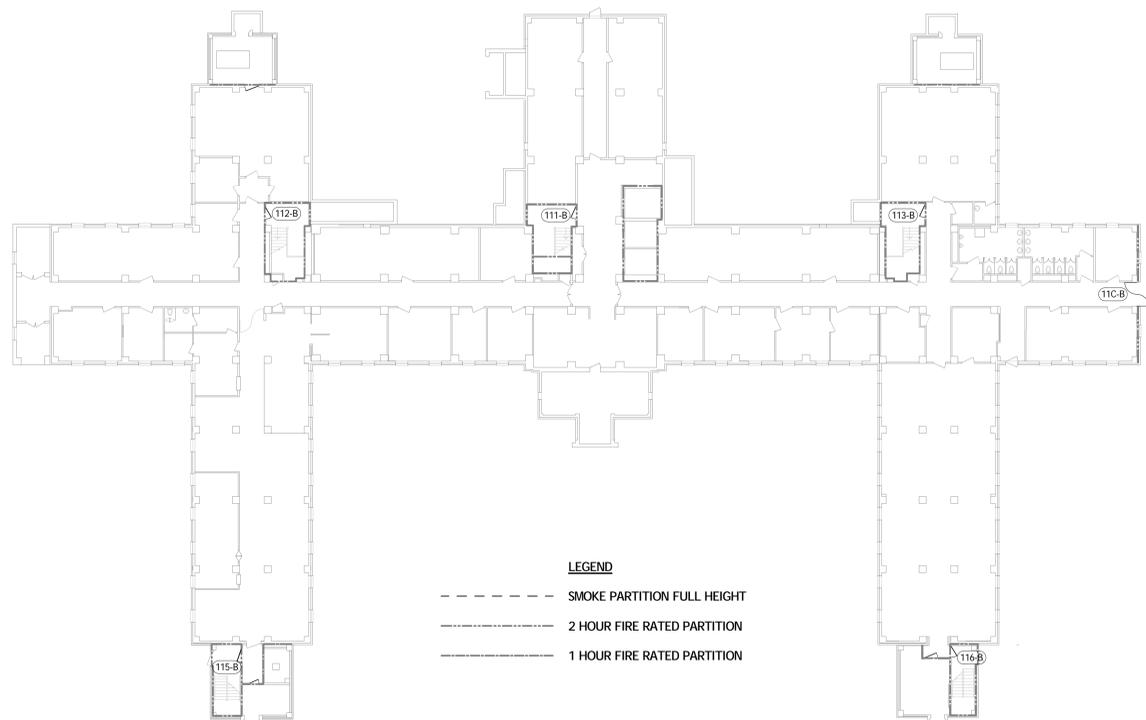


LEGEND
 - - - - - SMOKE PARTITION FULL HEIGHT
 - · - · - 2 HOUR FIRE RATED PARTITION
 - - - - - 1 HOUR FIRE RATED PARTITION

1 BASEMENT
 A201 SCALE: 1" = 20'-0"

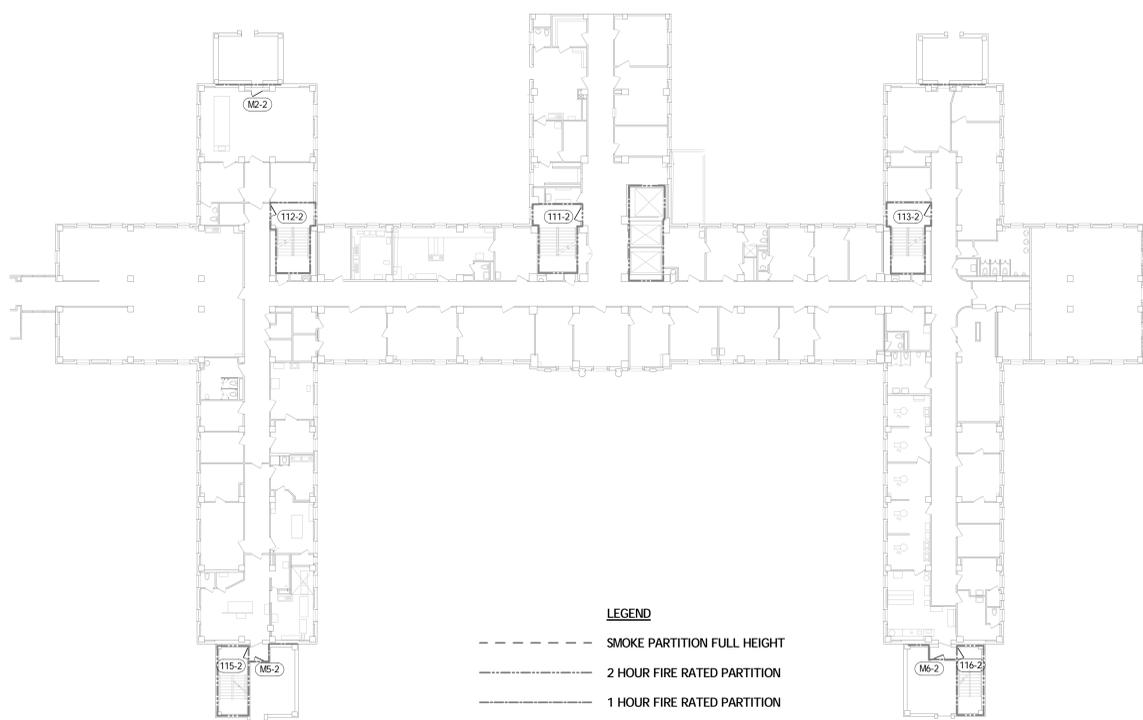


LEGEND
 - - - - - SMOKE PARTITION FULL HEIGHT
 - · - · - 2 HOUR FIRE RATED PARTITION
 - - - - - 1 HOUR FIRE RATED PARTITION

3 2ND FLOOR
 A201 SCALE: 1" = 20'-0"

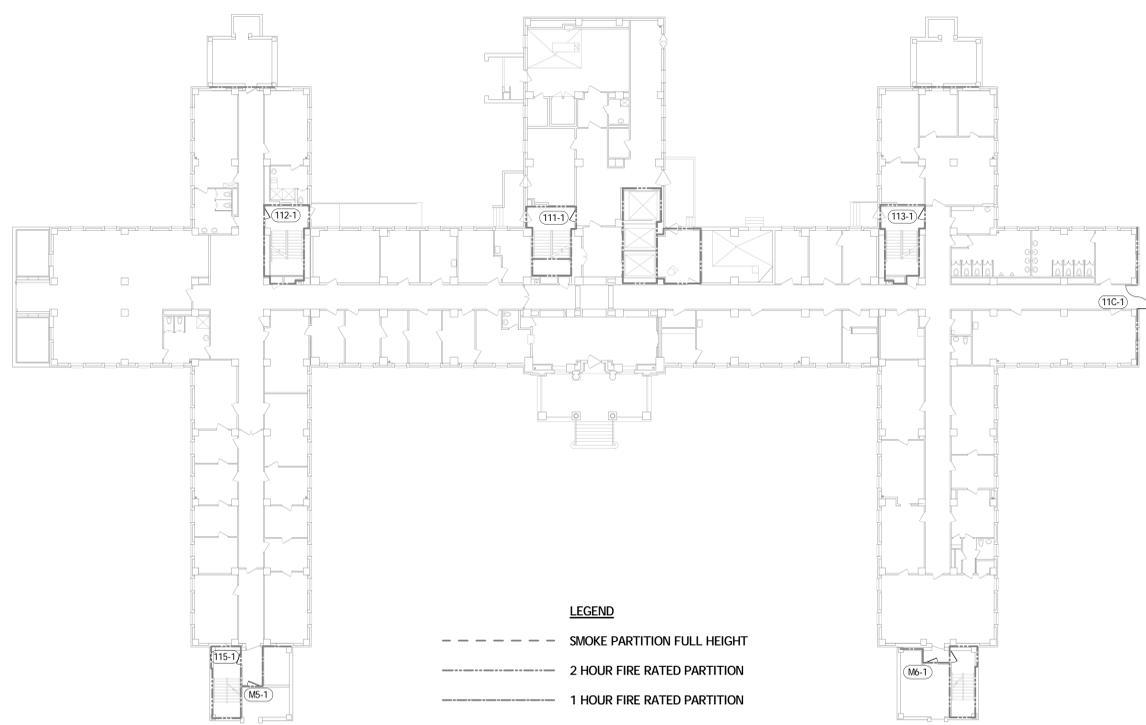

LEGEND
 - - - - - SMOKE PARTITION FULL HEIGHT
 - · - · - 2 HOUR FIRE RATED PARTITION
 - - - - - 1 HOUR FIRE RATED PARTITION

2 1ST FLOOR
 A201 SCALE: 1" = 20'-0"

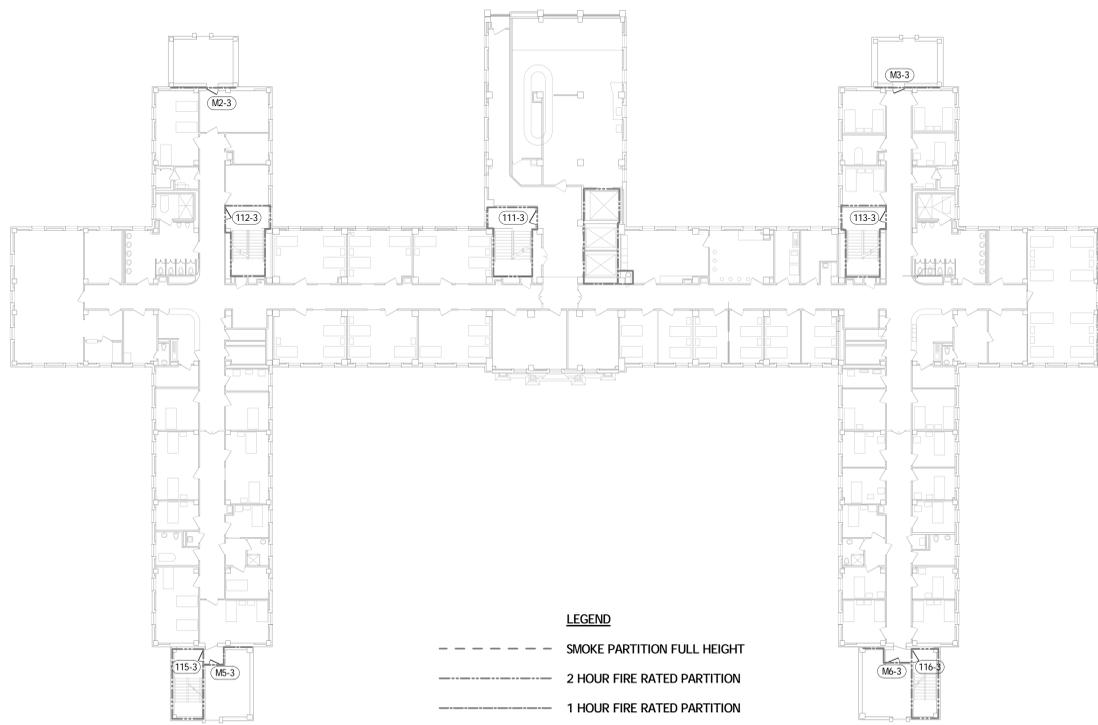

LEGEND
 - - - - - SMOKE PARTITION FULL HEIGHT
 - · - · - 2 HOUR FIRE RATED PARTITION
 - - - - - 1 HOUR FIRE RATED PARTITION

4 3RD FLOOR
 A201 SCALE: 1" = 20'-0"

Revisions	Date

Consultants:




A/E:
ROYAL ENGINEERS & CONSULTANTS, LLC
 4298 ELYSIAN FIELDS AVENUE
 NEW ORLEANS, LOUISIANA 70122
 www.royalengineering.net


Approved:
 PROGRAM MANAGER, PROJECTS _____
 SAFETY/INDUSTRIAL HYGIENE _____
 HEALTH SYSTEM SPECIALIST _____
 MAINTENANCE SUPERVISOR _____
 MAINTENANCE FOREMAN _____
 MAINTENANCE FOREMAN _____

Drawing Title
BLDG. 11 PLANS
 Approved: Service Engineer _____
 Approved: Service Director _____


Project Title
REPLACE FIRE DOORS
 Building Number
11 & 96
 Location
3600 MEMORIAL BLVD, KERRVILLE, TX 78028

Date
 7/21/2016 11:11:37 AM
 Project No.
671A-15-125
 DRAWING NO.
A201
 Dwg. of _____

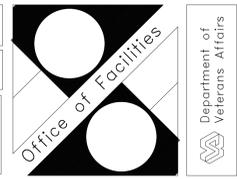


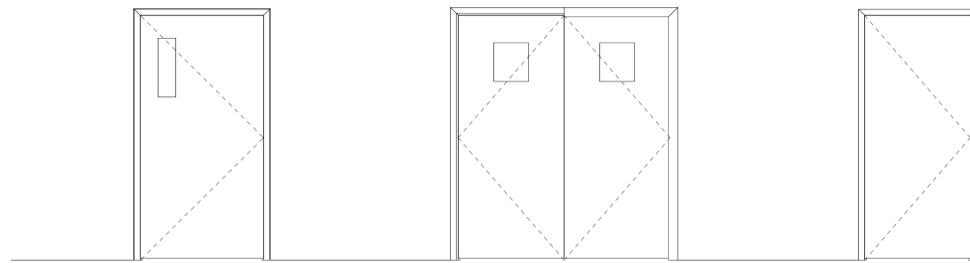


1 DOOR TYPES
SCALE: 1/2" = 1'-0"

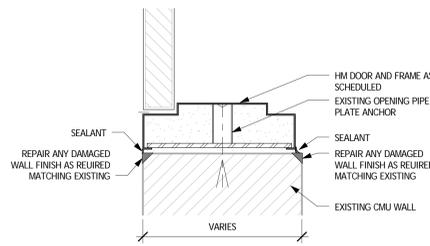


2 DOOR JAMB DETAIL
SCALE: 3" = 1'-0"

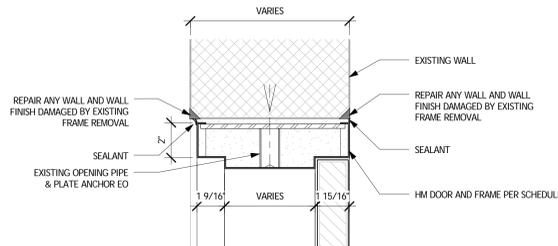

3 DOOR HEAD DETAIL
SCALE: 3" = 1'-0"

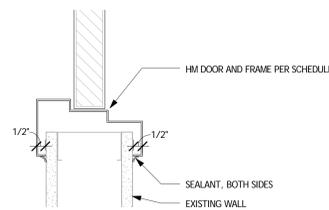

4 DOUBLE EGRESS JAMB DETAIL
SCALE: 3" = 1'-0"

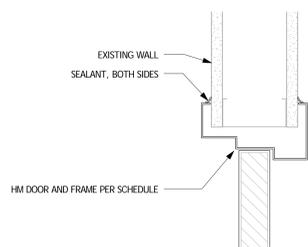

5 DOUBLE EGRESS HEAD DETAIL
SCALE: 3" = 1'-0"

MARK	TYPE	DOOR			FINISH	FIRE RATING	HARDWARE		FRAME			COMMENTS	
		WIDTH	HEIGHT	THICK			MATERIAL	SET	HEAD	JAMB	MATERIAL		FINISH
11C-1	B	6'-0"	7'-0"	1 3/4"	HM	PT	90 MNN	5	5/A501	4/A501	HM	PT	HOLD-OPEN DEVICE
11C-2	B	6'-0"	7'-0"	1 3/4"	HM	PT	90 MNN	5	5/A501	4/A501	HM	PT	HOLD-OPEN DEVICE
96C-1	B	6'-0"	7'-0"	1 3/4"	HM	PT	90 MNN	5	5/A501	4/A501	HM	PT	
96C-2	B	6'-0"	7'-0"	1 3/4"	HM	PT	90 MNN	5	5/A501	4/A501	HM	PT	
111-1	A	3'-6"	7'-0"	1 3/4"	HM	PT	90 MNN	1	3/A501	2/A501	HM	PT	
111-2	A	3'-6"	7'-0"	1 3/4"	HM	PT	90 MNN	1	3/A501	2/A501	HM	PT	
111-3	A	3'-6"	7'-0"	1 3/4"	HM	PT	90 MNN	1	3/A501	2/A501	HM	PT	
111-4	A	3'-6"	7'-0"	1 3/4"	HM	PT	90 MNN	1	3/A501	2/A501	HM	PT	
111-5	A	3'-6"	7'-0"	1 3/4"	HM	PT	90 MNN	1	3/A501	2/A501	HM	PT	
111-6	A	3'-6"	7'-0"	1 3/4"	HM	PT	90 MNN	1	3/A501	2/A501	HM	PT	
111-7	A	3'-6"	7'-0"	1 3/4"	HM	PT	90 MNN	1	3/A501	2/A501	HM	PT	
111-8	A	3'-6"	7'-0"	1 3/4"	HM	PT	90 MNN	1	3/A501	2/A501	HM	PT	
112-1	A	3'-6"	7'-0"	1 3/4"	HM	PT	90 MNN	2	3/A501	2/A501	HM	PT	
112-2	A	3'-6"	7'-0"	1 3/4"	HM	PT	90 MNN	1	3/A501	2/A501	HM	PT	
112-3	A	3'-6"	7'-0"	1 3/4"	HM	PT	90 MNN	1	3/A501	2/A501	HM	PT	
112-4	A	3'-6"	7'-0"	1 3/4"	HM	PT	90 MNN	1	3/A501	2/A501	HM	PT	
112-5	A	3'-6"	7'-0"	1 3/4"	HM	PT	90 MNN	1	3/A501	2/A501	HM	PT	MAGLOCK
112-6	A	3'-6"	7'-0"	1 3/4"	HM	PT	90 MNN	1	3/A501	2/A501	HM	PT	
112-7	A	3'-6"	7'-0"	1 3/4"	HM	PT	90 MNN	1	3/A501	2/A501	HM	PT	
112-8	A	3'-6"	7'-0"	1 3/4"	HM	PT	90 MNN	1	3/A501	2/A501	HM	PT	
113-1	A	3'-6"	7'-0"	1 3/4"	HM	PT	90 MNN	1	3/A501	2/A501	HM	PT	
113-2	A	3'-6"	7'-0"	1 3/4"	HM	PT	90 MNN	1	3/A501	2/A501	HM	PT	
113-3	A	3'-6"	7'-0"	1 3/4"	HM	PT	90 MNN	1	3/A501	2/A501	HM	PT	
113-4	A	3'-6"	7'-0"	1 3/4"	HM	PT	90 MNN	1	3/A501	2/A501	HM	PT	
113-5	A	3'-6"	7'-0"	1 3/4"	HM	PT	90 MNN	1	3/A501	2/A501	HM	PT	
113-6	A	3'-6"	7'-0"	1 3/4"	HM	PT	90 MNN	1	3/A501	2/A501	HM	PT	MAGLOCK
113-7	A	3'-6"	7'-0"	1 3/4"	HM	PT	90 MNN	1	3/A501	2/A501	HM	PT	
113-8	A	3'-6"	7'-0"	1 3/4"	HM	PT	90 MNN	1	3/A501	2/A501	HM	PT	
115-1	A	3'-6"	7'-0"	1 3/4"	HM	PT	90 MNN	1	3/A501	2/A501	HM	PT	
115-2	A	3'-6"	7'-0"	1 3/4"	HM	PT	90 MNN	1	3/A501	2/A501	HM	PT	
115-3	A	3'-6"	7'-0"	1 3/4"	HM	PT	90 MNN	1	3/A501	2/A501	HM	PT	
115-4	A	3'-6"	7'-0"	1 3/4"	HM	PT	90 MNN	1	3/A501	2/A501	HM	PT	
115-5	A	3'-6"	7'-0"	1 3/4"	HM	PT	90 MNN	1	3/A501	2/A501	HM	PT	
115-6	A	3'-6"	7'-0"	1 3/4"	HM	PT	90 MNN	1	3/A501	2/A501	HM	PT	
115-8	A	3'-6"	7'-0"	1 3/4"	HM	PT	90 MNN	1	3/A501	2/A501	HM	PT	
116-1	A	3'-6"	7'-0"	1 3/4"	HM	PT	90 MNN	3	3/A501	2/A501	HM	PT	DOOR ALARM
116-2	A	3'-6"	7'-0"	1 3/4"	HM	PT	90 MNN	3	3/A501	2/A501	HM	PT	DOOR ALARM
116-3	A	3'-6"	7'-0"	1 3/4"	HM	PT	90 MNN	3	3/A501	2/A501	HM	PT	DOOR ALARM
116-4	A	3'-6"	7'-0"	1 3/4"	HM	PT	90 MNN	3	3/A501	2/A501	HM	PT	DOOR ALARM
116-5	A	3'-6"	7'-0"	1 3/4"	HM	PT	90 MNN	3	3/A501	2/A501	HM	PT	DOOR ALARM
116-6	A	3'-6"	7'-0"	1 3/4"	HM	PT	90 MNN	3	3/A501	2/A501	HM	PT	DOOR ALARM
962-1	A	3'-6"	7'-0"	1 3/4"	HM	PT	90 MNN	4	3/A501	2/A501	HM	PT	
962-2	A	3'-6"	7'-0"	1 3/4"	HM	PT	90 MNN	4	3/A501	2/A501	HM	PT	
964-1	A	3'-6"	7'-0"	1 3/4"	HM	PT	90 MNN	4	3/A501	2/A501	HM	PT	
964-2	A	3'-6"	7'-0"	1 3/4"	HM	PT	90 MNN	4	3/A501	2/A501	HM	PT	
M2-2	C	3'-0"	7'-0"	1 3/4"	HM	PT	45 MNN	7	3/A501	2/A501	HM	PT	
M2-3	C	3'-0"	7'-0"	1 3/4"	HM	PT	45 MNN	7	3/A501	2/A501	HM	PT	
M2-4	C	3'-0"	7'-0"	1 3/4"	HM	PT	45 MNN	7	3/A501	2/A501	HM	PT	
M2-5	C	3'-0"	7'-0"	1 3/4"	HM	PT	45 MNN	7	3/A501	2/A501	HM	PT	
M2-6	C	3'-0"	7'-0"	1 3/4"	HM	PT	45 MNN	7	3/A501	2/A501	HM	PT	
M3-3	C	3'-0"	7'-0"	1 3/4"	HM	PT	45 MNN	7	3/A501	2/A501	HM	PT	
M3-4	C	3'-0"	7'-0"	1 3/4"	HM	PT	45 MNN	7	3/A501	2/A501	HM	PT	
M3-5	C	3'-0"	7'-0"	1 3/4"	HM	PT	45 MNN	7	3/A501	2/A501	HM	PT	
M3-6	C	3'-0"	7'-0"	1 3/4"	HM	PT	45 MNN	7	3/A501	2/A501	HM	PT	
M5-1	C	3'-0"	7'-0"	1 3/4"	HM	PT	45 MNN	6	3/A501	2/A501	HM	PT	
M5-2	C	3'-0"	7'-0"	1 3/4"	HM	PT	45 MNN	6	3/A501	2/A501	HM	PT	
M5-3	C	3'-0"	7'-0"	1 3/4"	HM	PT	45 MNN	6	3/A501	2/A501	HM	PT	
M5-4	C	3'-0"	7'-0"	1 3/4"	HM	PT	45 MNN	6	3/A501	2/A501	HM	PT	
M5-5	C	3'-0"	7'-0"	1 3/4"	HM	PT	45 MNN	6	3/A501	2/A501	HM	PT	
M5-6	C	3'-0"	7'-0"	1 3/4"	HM	PT	45 MNN	6	3/A501	2/A501	HM	PT	
M5-7	C	3'-0"	7'-0"	1 3/4"	HM	PT	45 MNN	6	3/A501	2/A501	HM	PT	
M6-1	C	3'-0"	7'-0"	1 3/4"	HM	PT	45 MNN	6	3/A501	2/A501	HM	PT	
M6-2	C	3'-0"	7'-0"	1 3/4"	HM	PT	45 MNN	6	3/A501	2/A501	HM	PT	
M6-3	C	3'-0"	7'-0"	1 3/4"	HM	PT	45 MNN	6	3/A501	2/A501	HM	PT	
M6-4	C	3'-0"	7'-0"	1 3/4"	HM	PT	45 MNN	6	3/A501	2/A501	HM	PT	
M6-5	C	3'-0"	7'-0"	1 3/4"	HM	PT	45 MNN	6	3/A501	2/A501	HM	PT	
M6-6	C	3'-0"	7'-0"	1 3/4"	HM	PT	45 MNN	6	3/A501	2/A501	HM	PT	

DOOR INSTALLATION GENERAL NOTES:

- PRIOR TO BID AND AGAIN PRIOR TO ORDERING ANY MATERIALS, CONTRACTOR SHALL CONFIRM ALL DOOR QUANTITIES, TYPES, LOCATIONS, SIZES, PARTITION TYPES, PARTITION WIDTHS, AND INSPECT ALL FINISH TYPES SURROUNDING EACH DOOR. CONTRACTOR SHALL REPAIR ALL WALL FINISHES DAMAGED DURING REMOVAL OF EXISTING FRAMES AND INSTALLATION OF NEW DOORS AND FRAMES. REPAIR SHALL MATCH EXISTING.
- EXISTING WALL DEPTH AND PARTITION TYPE DIFFER. CONTRACTOR SHALL VERIFY EXISTING CONDITIONS OF EACH OPENING PRIOR TO BID AND AGAIN PRIOR TO ORDERING ANY MATERIALS.
- CONTRACTOR SHALL PAINT ALL NEW HM DOORS AND FRAMES ACCORDING TO PAINT SPECIFICATION, MATCHING EXISTING COLORS TO BE APPROVED BY OWNER.
- DOOR SCHEDULE COMMENTS SCOPE OF WORK:
 - MAGLOCK: INSTALL NEW MAGLOCK AND TIE INTO EXISTING LOW-VOLTAGE SYSTEM. COORDINATE WITH VA ACCESS CONTROLS PROVIDER.
 - DOOR ALARM: RECONNECT EXISTING DOOR ALARM SENSOR TO EXISTING ALARM SYSTEM MATCH EXISTING INSTALLATION. IF EXISTING FIRE ALARM SENSOR IS DAMAGED DURING DEMOLITION OR INCOMPATIBLE WITH NEW DOOR HARDWARE THEN INSTALL NEW SENSOR COMPATIBLE WITH EXISTING ALARM SYSTEM. COORDINATE WITH VA ACCESS CONTROLS PROVIDER.
 - HOLD-OPEN DEVICE: INSTALL NEW HOLD OPEN DEVICE COMPATIBLE WITH NEW DOORS, FRAMES, AND HARDWARE AND COMPATIBLE WITH EXISTING LOW-VOLTAGE SYSTEM. COORDINATE WITH VA ACCESS CONTROLS PROVIDER.

Revisions	Date

Consultants:



A/E: **ROYAL ENGINEERS & CONSULTANTS, LLC**
 4298 ELYSIAN FIELDS AVENUE
 NEW ORLEANS, LOUISIANA 70122
 www.royalengineering.net

Approved:

PROGRAM MANAGER, PROJECTS _____
 SAFETY/INDUSTRIAL HYGIENE _____
 HEALTH SYSTEM SPECIALIST _____
 MAINTENANCE SUPERVISOR _____
 MAINTENANCE FOREMAN _____
 MAINTENANCE FOREMAN _____

Drawing Title: **DOOR SCHEDULE AND TYPES**

Approved: Service Engineer _____
 Approved: Service Director _____

Project Title: **REPLACE FIRE DOORS**

Building Number: 11 & 96
 Checked: MP
 Drawn: IP
 Location: 3600 MEMORIAL BLVD, KERRVILLE, TX 78028

Date: 7/21/2016 11:11:45 AM
 Project No.: 671A-15-125
 DRAWING NO.: **A501**
 Dwg. of _____

