


A three inches = one foot  
 B one and one-half inches = one foot  
 C one inch = one foot  
 D three-quarters inch = one foot  
 E one-half inch = one foot  
 F three-eighths inch = one foot  
 G one-quarter inch = one foot  
 H one-eighth inch = one foot

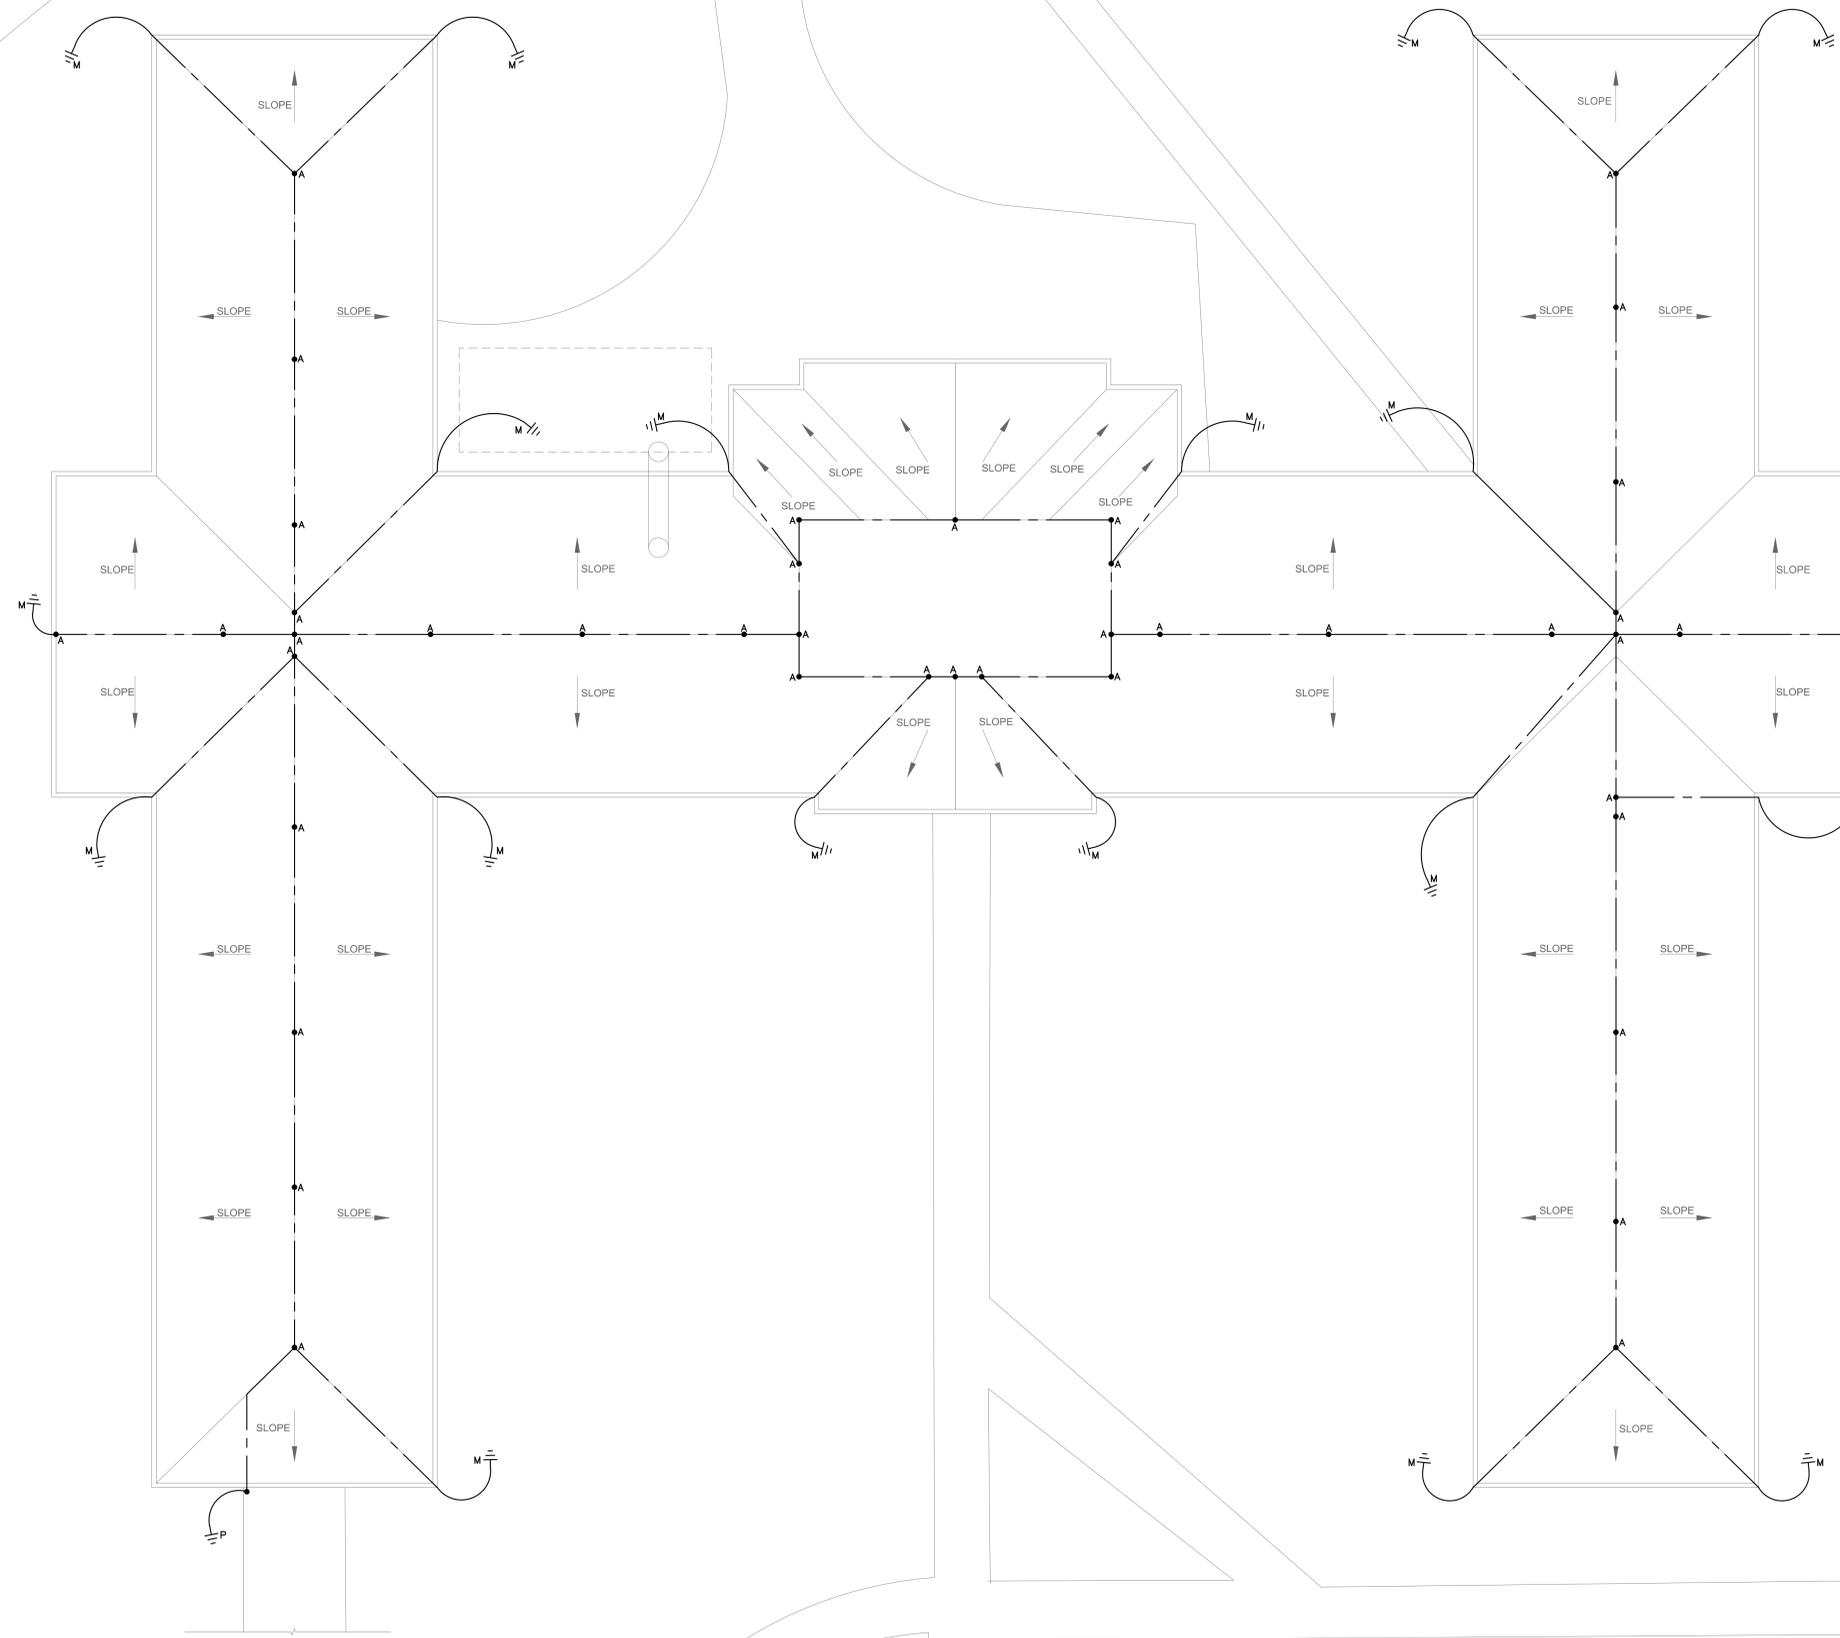

- GENERAL NOTES:**
1. ELECTRICAL CONTRACTOR SHALL BE RESPONSIBLE FOR REMOVING EXISTING LIGHTNING PROTECTION SYSTEM HARDWARE AND CABLES.
  2. THE LIGHTNING PROTECTION SYSTEM SHALL BE INSPECTED AND APPROVED BY UL WITHOUT VARIATION PRIOR TO FINAL ACCEPTANCE.


**BUILDING 39 ROOF PLAN - LIGHTNING PROTECTION**  
 SCALE: 1/8" = 1'-0"

  
**S B C**  
 SALLADIEH ENGINEERING GROUP, P.C.  
 1507 ALEX DRIVE, SUITE 101  
 BIRMINGHAM, ALABAMA 35218  
 205.833.7033 FAX: 205.314.0180  
 www.sajidieengineering.com  
 PROJECT: 09-97

Revisions	Date

  
**BIRCHFIELD  
 PENUEL &  
 ASSOCIATES,  
 ARCHITECTS**  
 2805 CRESCENT AVENUE · SUITE 200 · BIRMINGHAM, ALABAMA 35209

  
 No. 17564  
 PROFESSIONAL ENGINEER  
 SAJJAD  
 5/27/10

**Replace Shingles - Building 39 - 40**  
**Department of Veterans Affairs**  
**MEDICAL CENTER**  
**TUSCALOOSA, ALABAMA**

Drawing Title	
BUILDING 39 ROOF PLAN - LIGHTNING PROTECTION	
Approved: Chief Engineer	

Project Title		
REPLACE SHINGLES - BUILDINGS 39 & 40		
DEPARTMENT OF VETERANS AFFAIRS		
Building Numbers	Checked	Drawn
39 & 40	JJS	DB
Location		
VA MEDICAL CENTER TUSCALOOSA, ALABAMA		

Date:	06-04-2010
Project Number:	679-10-103
DRAWING NO.	39-E2.0
Dwg	9 of 10

**Veterans Administration**