

ARCHITECTURAL SYMBOL LEGEND

- CENTER LINE
- ELEVATION INDICATOR
- MATCH LINE
- CONTRACT LIMIT LINE
- FEATURES ABOVE LINE INDICATOR
- HIDDEN FEATURES LINE
- PROPERTY LINE
- BREAK, ROUND
- BREAK, STRAIGHT
- DETAIL INDICATOR
- DETAIL INDICATOR FOR SMALL CONDITIONS
- DIMENSION LINE
- DOOR OPENING - NEW
- DOOR OPENING - NEW
- DRAWING BLOCK TITLE
- ELEVATION INDICATOR, EXTERIOR OR INTERIOR, SINGLE VIEW
- ELEVATION INDICATOR, INTERIOR, MULTIPLE VIEW
- BUILDING SECTION INDICATOR
- FLOOR FINISH, FURNITURE, FIXTURE, & EQUIPMENT INDICATOR
- GRAPHIC SCALE, 1/4" = 1'-0"
- ROOM NAME AND NUMBER
- COLUMN GRID - NEW
- COLUMN GRID - EXISTING
- KEYNOTE
- WALL PARTITION TYPE
- WINDOW TYPE
- FIRE EXTINGUISHER
- FIRE EXTINGUISHER CABINET (RECESSED, SEMI-RECESSED, SURFACE-MOUNTED)
- CORNER GUARD
- NORTH ARROW
- VV ITEM - VA SUPPLIED & INSTALLED
- VC ITEM - VA SUPPLIED & CONTRACTOR INSTALLED
- CC ITEM - CONTRACTOR SUPPLIED & INSTALLED

MATERIALS LEGEND

- BASE COURSE
- BATT INSULATION
- CONCRETE
- EARTH
- BRICK
- RIGID INSULATION
- EXISTING CONSTRUCTION TO REMAIN
- EXISTING CONSTRUCTION TO BE REMOVED
- EXISTING CONSTRUCTION TO BE REMOVED (SPECIFIC AREA)
- NEW CONSTRUCTION

RCP SYMBOL LEGEND

- 2x4 FLUORESCENT LIGHT FIXTURE
- 2x2 FLUORESCENT LIGHT FIXTURE
- 1' x 4' SURFACE MOUNTED FLUORESCENT LIGHT FIXTURE
- STRIP LED LIGHT FIXTURE
- COVE LIGHT FIXTURE
- UNDER-CABINET LIGHT FIXTURE
- RECESSED LIGHT FIXTURE
- DOWNLIGHT FIXTURE
- WALL MOUNTED LIGHT FIXTURE
- SPRINKLER HEAD
- EMERGENCY LIGHT FIXTURE
- EMERGENCY EXIT LIGHT FIXTURES
- SUPPLY DIFFUSER (SQUARE)
- RETURN REGISTER
- ACCESS PANEL, AP
- SPEAKER
- OCCUPANT SENSOR
- SMOKE DETECTOR
- AUDIO OR VISUAL FIRE ALARM

FIRE RATED CONSTRUCTION LEGEND

- NOT RATED
- 1/2 HOUR RATED
- 1 HOUR RATED
- 2 HOUR RATED
- 3 HOUR RATED
- 4 HOUR RATED

EXAMPLE: ONE HOUR FIRE WALL

FIRE ASSEMBLY TYPES:
 F = FIRE PARTITION
 FB = FIRE BARRIER
 FW = FIRE WALL
 S = SMOKE PARTITION
 SB = SMOKE BARRIER

LIFE SAFETY SYMBOL LEGEND

- EXIT SIGN
- TRAVEL DISTANCE TO EXITS
- FIRE EXTINGUISHER
- FIRE EXTINGUISHER CABINET (RECESSED, SEMI-RECESSED, SURFACE-MOUNTED)

GENERAL NOTES

- THE CONTRACTOR SHALL BID THE FOLLOWING ITEMS BY UNIT PRICE DUE TO THE POTENTIAL FOR SIGNIFICANTLY VARYING QUANTITIES BASED ON DISCOVERIES MADE DURING DEMOLITION:
 - REPLACEMENT OF EXISTING ROOF SHEATHING ON LODGE
 - PATCH AND REPAIR EXISTING PLASTER AND LATH CEILINGS IN LODGE
 - EXISTING MASONRY TUCKPOINTING/RESTORATION
- AFTER PAINT REMOVAL OF EXISTING BRICK, ALL CLEANING OF SAID BRICK MUST BE COMPLETE BEFORE NEW ALUMINUM WINDOWS, DOORS AND STOREFRONT ARE ADDED.
- ANY FURNITURE INDICATED IN THE DRAWINGS IS FOR INFORMATION PURPOSES ONLY AND NOT A PART OF THIS PROJECT'S SCOPE OF WORK. FURNITURE WILL BE PURCHASED UNDER A SEPARATE CONTRACT BY THE NCA.
- CONTRACTOR TO REPAIR/TUCKPOINT THE EXISTING LODGE MASONRY DAMAGED BY THE CONTRACTOR THROUGHOUT THE DURATION OF THE PROJECT UNDER CONSTRUCTION.

PROJECT DATA

USE	BUSINESS	
OCCUPANCY LOAD		
NFPA 101 OCCUPANCY CLASSIFICATION	CHAPTER 38: NEW BUSINESS**	
OCCUPANCY LOAD PER CLASSIFICATION	TABLE 7.3.1.2: 100 SF/PERSON	
AREA / 100 GROSS SF		
BASEMENT - EXIST: 960 SF/100 SF*	10 OCCUPANTS (UNCHANGED)	
BASEMENT - ADDITION: 611 SF/100 SF*	7 OCCUPANTS	
FIRST FL - EXIST: 980 SF/100 SF	10 OCCUPANTS (UNCHANGED)	
FIRST FL - ADDITION: 591 SF/100 SF	6 OCCUPANTS	
SECOND FL - EXIST: 828 SF/100 SF	9 OCCUPANTS (UNCHANGED)	
TOTAL - EXISTING:	29 OCCUPANTS (UNCHANGED)	
TOTAL - ADDITION:	12 OCCUPANTS	
TOTAL - EXISTING + ADDITION:	42 TOTAL OCCUPANTS	
*STORAGE OCCUPANCY INCIDENTAL TO PREDOMINANT BUSINESS OCCUPANCY AND THEREFORE SUBJECT TO THE CODE THAT APPLIES TO THE PREDOMINANT OCCUPANCY - NFPA 101 6.1.14.1.3 (1)		
**THE MULTI-PURPOSE ROOM HAS BEEN CLASSIFIED UNDER THE PREDOMINANT OCCUPANCY "NEW BUSINESS" IN ACCORDANCE WITH NFPA 101 A6.1.2.1.		
CONSTRUCTION TYPE - NFPA 220, 7.2:		
EXISTING BUILDING	TYPE V (000) (UNCHANGED)	
NEW ADDITION	TYPE V (000)	
SPRINKLERED: NO		
BUILDING ELEMENT - FIRE RESISTANCE RATING - NFPA 220, TABLE 7.2.1.1:		
	REQUIRED	PROPOSED
EXTERIOR BEARING WALLS		
SUPPORTING MORE THAN ONE FLOOR, COLUMNS, OR OTHER BEARING WALLS	NA	NA
SUPPORTING ONE FLOOR ONLY	NA	NA
SUPPORTING ROOF ONLY	0	0
INTERIOR BEARING WALLS		
SUPPORTING MORE THAN ONE FLOOR, COLUMNS, OR OTHER BEARING WALLS	NA	NA
SUPPORTING ONE FLOOR ONLY	NA	NA
SUPPORTING ROOF ONLY	NA	NA
COLUMNS		
SUPPORTING MORE THAN ONE FLOOR, COLUMNS, OR OTHER BEARING WALLS	NA	NA
SUPPORTING ONE FLOOR ONLY	NA	NA
SUPPORTING ROOF ONLY	0	0
FLOOR-CEILING ASSEMBLIES		
FLOOR-CEILING ASSEMBLIES	0	0
ROOF-CEILING ASSEMBLIES		
ROOF-CEILING ASSEMBLIES	0	0
INTERIOR NONBEARING WALLS		
INTERIOR NONBEARING WALLS	0	0
EXTERIOR NONBEARING WALLS		
EXTERIOR NONBEARING WALLS	NA	NA
BUILDING HEIGHTS AND AREAS - NFPA 220 (5000), TABLE 7.4.1		
TOTAL AREA (EXCLUDES BASEMENT)	9,000 SF	2,390 SF
FIRST FLOOR AREA	-	1,571 SF
SECOND FLOOR AREA	-	828 SF
HEIGHTS		
STORIES	2 STORIES	2 STORIES
EGRESS WIDTH - 7.2.2.2.1.2 & TABLE 7.3.3.1		
OCCUPANTS x 0.2 (LEVEL COMPONENTS)	36" MIN	34"
41 OCC x 0.2 = REQUIRED WIDTH IN INCHES	8.2" MIN	34"
OCCUPANTS x 0.3 (STAIRWAYS)	36" MIN	36"
41 OCC x 0.3 = REQUIRED WIDTH IN INCHES	12.3" MIN	36"
EXITS, EXIT ACCESS, & DOORWAYS (NEW ADDITION)		
NO. OF EXITS - NFPA 101, 39.2.4.3	1	1
DOOR WIDTH - NFPA 101, 7.2.1.2.3.2	32" MIN	34"
COMMON PATH OF TRAVEL - NFPA 101, 39.2.5.3.3	NA	NA
EXIT ACCESS TRAVEL DISTANCE	100'	95'
W/O SPRINKLERS - NFPA 101, 38.2.4.4 (2)		
DEAD END CORRIDORS	20' MAX	0'
W/O SPRINKLERS - NFPA 101, 38.2.5.2.2		
PLUMBING FIXTURES - NSPC 2009, TABLE 7.21.1		
WATER CLOSETS - MEN/WOMEN/UNISEX	1/1/0	1/1/1
LAVATORIES - MEN/WOMEN/UNISEX	1/1/0	1/1/1
DRINKING FOUNTAIN	0	0
SERVICE SINK (AS REQ'D BY AHJ)	1	1

CODE INFORMATION

JURISDICTION: VETERAN'S ADMINISTRATION

APPLICABLE CODES

BUILDING CODE: VA DIRECTIVES, DESIGN MANUALS, MASTER SPECIFICATIONS, VA NATIONAL CAD STANDARD APPLICATION GUIDE, AND OTHER GUIDANCE ON THE TECHNICAL INFORMATION LIBRARY (TIL) (<http://www.dfm.va.gov/til>)

NFPA NATIONAL FIRE CODES WITH THE EXCEPTION OF NFPA 5000 AND NFPA 900

IBC 2012 (LATEST EDITION)

VA SEISMIC DESIGN REQUIREMENTS, H-18-8

BUILDING CODE REQUIREMENTS FOR REINFORCED CONCRETE, AMERICAN INSTITUTE AND COMMENTARY (ACI 318)

MANUAL OF STEEL CONSTRUCTION, LOAD AND RESISTANCE FACTOR DESIGN SPECIFICATIONS FOR STRUCTURAL STEEL BUILDINGS, AMERICAN INSTITUTE OF STEEL CONSTRUCTION (AISC)

MECHANICAL CODE: ASME BOILER AND PRESSURE VESSEL CODE

ASME CODE FOR PRESSURE PIPING

VENTILATION FOR ACCEPTABLE INDOOR AIR QUALITY - ASHRAE STANDARD 62.1 - 2004

SAFETY STANDARD FOR REFRIGERATION SYSTEMS - ASHRAE STANDARD 15 - 2007

PLUMBING CODE: NATIONAL STANDARD PLUMBING CODE (NSPC)

ELECTRICAL CODE: NATIONAL ELECTRIC CODE (NEC)

FIRE/LIFE SAFETY CODE: NFPA 101 LIFE SAFETY CODE

OSHA

ACCESSIBILITY CODE: ARCHITECTURAL BARRIERS ACT ACCESSIBILITY STANDARDS (ABAAS) INCLUDING VA SUPPLEMENT, BARRIER FREE DESIGN GUIDE (PG-18-3)

ENERGY CODE: ENERGY POLICY ACT OF 2005 (EPAct)


DOE INTERIM FUNAL RULE: ENERGY CONSERVATION STANDARDS FOR NEW FEDERAL, COMMERCIAL AND MULTI-FAMILY HIGH-RISE RESIDENTIAL BUILDINGS AND NEW LOW-RISE RESIDENTIAL BUILDINGS, 10 CFR PARTS 433, 434 AND 435

FEDERAL LEADERSHIP IN HIGH PERFORMANCE AND SUSTAINABLE BUILDINGS: MEMORANDUM OF UNDERSTANDING (MOU)

EXECUTIVE ORDER 13693: PLANNING FOR FEDERAL SUSTAINABILITY IN THE NEXT DECADE

ELEVATOR CODE: SAFETY CODE FOR ELEVATORS AND ESCALATORS, AMERICAN SOCIETY OF MECHANICAL ENGINEERS (ASME) A 17.1/CSA B44-2013

CONSTRUCTION & SAFETY SIGNS: STATED IN THE GENERAL REQUIREMENTS SECTION 01010 OF THE VA MASTER CONSTRUCTION SPECIFICATION

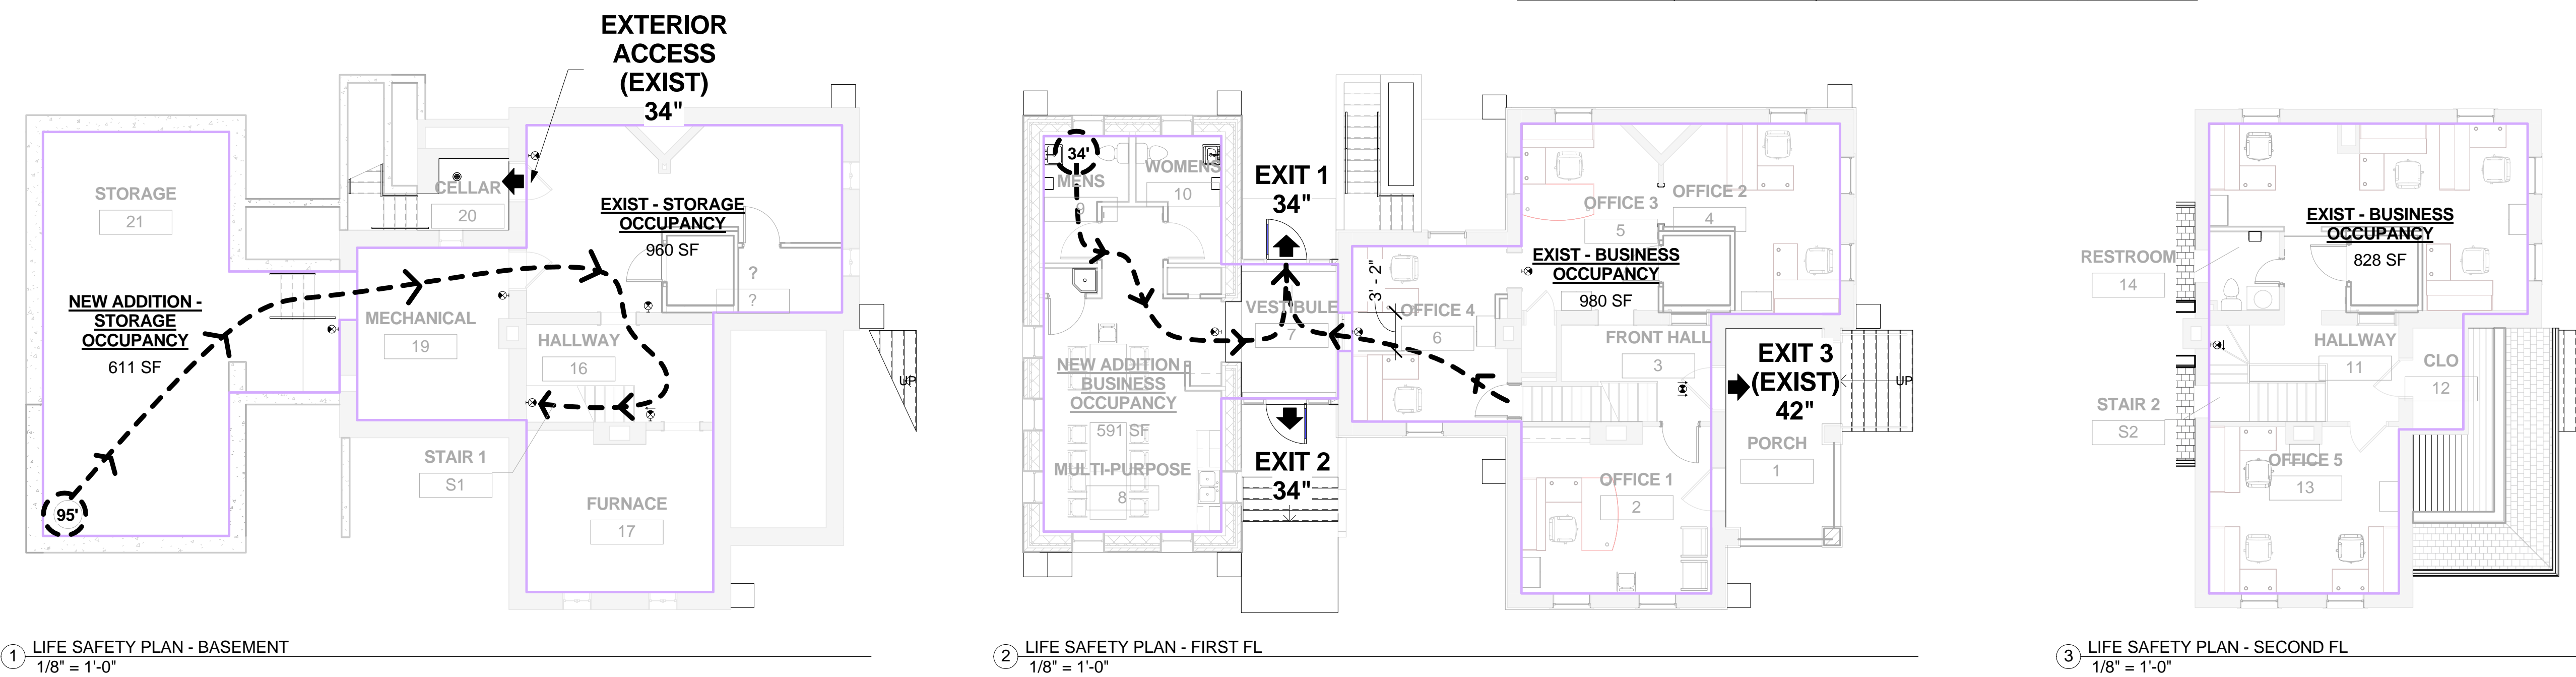

BID SET DOCUMENTS

CONSULTANTS: ENGINEERING CONSULTANTS The FUTURE Built SMARTER. 623 26TH AVENUE QUAKO CITY, IL 61201 309.788.0673 FAX: 309.786.5567	I HEREBY CERTIFY THAT THIS PLAN, SPECIFICATION, OR REPORT WAS PREPARED BY ME OR UNDER MY DIRECT SUPERVISION AND THAT I AM A DULY LICENSED ARCHITECT UNDER THE LAWS OF THE STATE OF MINNESOTA. SIGNATURE: TYPED OR PRINTED NAME: PAUL D. DAHLBERG DATE: FEBRUARY 25, 2016 LICENSE NUMBER: 15870	ARCHITECT/ENGINEERS: ANDERSON ENGINEERING ENGINEERING • ARCHITECTURE • LAND SURVEYING ENVIRONMENTAL SERVICES • LANDSCAPE ARCHITECTURE AE PROJECT NO.: 13802	Drawing Title PROJECT DATA & LIFE SAFETY PLANS Approved: Project Director	Project Title LODGE REHABILITATION Location FT LEAVENWORTH NATIONAL CEMETERY LEAVENWORTH, KS	Project Number 887CM3005	Office of Construction and Facilities Management U.S. Department of Veterans Affairs
					Building Number	

ROOM FINISH SCHEDULE						
ROOM NO.	ROOM NAME	FLR FINISH	WALL BASE	WALL FINISH	CLG FINISH	REMARKS
S1	STAIR	E	E	E	E	
S2	STAIR	P-3, P-4/CP-1	--	--	P-1	3, 5, 7
1	PORCH	CD-1	--	P-2, P-5	S-2	1, 9
2	OFFICE 1	E/S-1	WB-1/P-1	P-6	P-1	8
3	FRONT HALL	E/S-1	E	P-8	P-1	3
4	OFFICE 2	E/S-1	E	P-7	P-1	3
5	OFFICE 3	E/S-1	E	P-7	P-1	3
6	OFFICE 4	WD-1/S-1	WB-1/P-1	P-7	P-1	2
7	VESTIBULE	PPT-1	--	P-7	S-3	10, 13
8	MULTI-PURPOSE	PPT-1/PPT-2	PPT-5	CWT-1, 2/P-7	S-3	15
9	MENS	PPT-3, PPT-4	CWT-3	CWT-1, 2/P-9	P-1	11
10	WOMENS	PPT-3, PPT-4	CWT-3	CWT-1, 2/P-9	P-1	11
11	HALLWAY	S-1	E	P-8	P-1	3
12	CLOSET	S-1	E	E	E	
13	OFFICE 5	S-1	E	P-6	P-1	3
14	RESTROOM	PPT-3, PPT-4	CWT-3	CWT-1, 2/P-9	P-1	11, 14
15	OFFICE 6	S-1	E	P-6	P-1	3
16	HALLWAY	E	--	E	E	
17	FURNACE	E	--	E	E	
18	STORAGE	E	--	E	E	
19	MECHANICAL	--	--	E	E	
20	CELLAR	--	--	P-2	P-2	6, 16
21	STORAGE	--	--	--	--	4
22	ELEVATOR MACHINE	E	--	P-1	GY/P-1	


- REMARKS:
- CAREFULLY REMOVE EXIST PAINT ON BRICK USING LEAST ABRASIVE METHOD TO RESTORE BRICK TO ITS ORIG NAT FIN.
 - AFTER DEMO OF EXIST VINYL TILE, INSPECT FL FOR CONDITION OF ANY EXISTING WD STRIP FLOORING BELOW AND NOTIFY NCA PROJECT MANAGER OF THE FINDINGS AND FOR FURTHER DIRECTION ON RESTORATION. IF EXIST WD STRIP FLOORING IS IN PLACE, REPL. DAMAGED FL BDS TO MATCH EXIST. SAND AND RE-FINISH ENTIRE FL WITH S-1. IF NO ORIG WD STRIP FLOORING IS FOUND BENEATH THE VINYL TILE, PREP SUBFLOOR FOR INSTALLATION OF NEW WD STRIP FLOORING. INSTALL NEW WD STRIP FLOORING OF A SIZE, SPECIES, AND FINISH TO MATCH EXIST WD STRIP FLOORING IN ADJ ROOMS.
 - REMOVE EXISTING LOOSE PAINT AND LOOSE MATERIAL FROM WALLS AND CLGS. PLAS CLG AREAS SHOULD BE CLEANED, DRIED AND PRIMED PRIOR TO PATCHING. PATCH AND REPAIR SURFACES TO A SMOOTH FINISH USING MASTER OF PLAS AND PAINT AS SCHED.
 - SMOOTH WALL FIN, CLEAN AND MAKE DUST-FREE BEFORE CLEAR COAT IS APPLIED.
 - CONFIRM ALL TREADS, RISERS, PICKETS, POST, GARRIAGE, HANDRAILS & TRIM ARE PROPERLY FIXED BEFORE FINAL COAT APPLICATION. SEE INTERIOR ELEVATION FOR NEW PAINT TYPES REQUIRED FOR EACH STAIR COMPONENT.
 - REMOVE LOOSE MATL AND EXIST PAINT FROM WALLS. RE-SURFACE WALLS TO SMOOTH FIN. ENSURE PROPER BONDING OF NEW SURF TO WALL. PREPARE FOR FINAL FINISH COAT OF PAINT, P-2. INSTALL NEW 5/8" MOISTURE RESISTANT TYPE 'X' GYP BD FOR ENTIRE CLG, PAINT P-2.
 - PROVIDE AND INSTALL STAIR RUNNER AND ASSOC ACCESSORIES AS NEEDED.
 - AFTER REMOVAL OF EXIST WD WALL PANELING AND WD BASE, INSTALL NEW 5/8" TYPE 'X' GYP BD FINISH PAINTED P-1 ON ALL WALLS. AFTER REMOVAL OF EXIST CARPET FLG, PADDING & OSB SUBFLOOR, PREP AND REFINISH ORIGINAL WD STRIP FLG. DO NOT PAINT EXISTING BRICK WALLS. WALL PAINT FINISH APPLIES TO SCREENED PORCH AND GYP BD FINISHES ONLY.
 - PROVIDE WD REDUCER (FTS-3) TRANSITION BETWEEN OFFICE 4 AND ADJ ROOMS IF NEW WD FLOOR IS REQD.
 - INSTALL CWT FROM FINISHED FL TO 6'-0" HT ON ALL WALLS IN ROOM, TYP.
 - SAND ANY LOOSE PAINT/STAIN FINISH FROM EXIST BEADBOARD CLG AND APPLY NEW STAIN AND SEALER. REPLACE/PATCH ANY MISSING OR DAMAGED TRIM, BOARDS, AND OPENINGS. CREATE NEW OPENINGS AS NEEDED FOR NEW CLG MOUNTED ITEMS, SUCH AS LIGHT FIXTURES AND SMOKE DETECTOR.
 - EXPOSED BRICK TO REMAIN UNFINISHED. DO NOT PAINT.
 - INSTALL NEW 5/8" MOISTURE RESISTANT, TYPE 'X' GYP BD ON ALL WALL AND CLG SURFACES, FINISH AS SCHEDULED.
 - CERAMIC TILE FINISH IS FOR THE INTERIOR WALLS OF MOP CLOSET ONLY. FINISH ALL WALLS INSIDE MOP CLOSET WITH CERAMIC TILE CWT-1 & CWT-2 (TOP COURSE ONLY) TO 48" AFF; PAINTED GYP BOARD FINISH ABOVE.
 - REMOVE DEBRIS, CLEAN EXISTING WHITE PAINT FROM WALLS, REPAINT P-2. NEW CONCRETE SURFACES TO REMAIN UNFINISHED.

FINISH PLAN GENERAL NOTES


- ALL EXIST INT PAINTED TRIM SHOULD BE SANDED AND REFINISHED WITH A NEW COAT OF PAINT, P-1, UNLESS OTHERWISE INDICATED.
- REFER TO SHEET A2.01 FOR FINISH INFORMATION ON THE REFLECTED CEILING PLANS.
- REFER TO SHEET A8.01 FOR ENLARGED FLOOR PLANS AND INTERIOR ELEVATIONS.
- LOCATE CHANGES IN FLOOR FINISH MATERIAL UNDER CENTERLINE OF CLOSED DOOR, UNLESS OTHERWISE INDICATED.
- PAINT ALL NON SST FIRE EXTINGUISHERS CABINETS, VENTS, GRILLS, ACCESS PANELS, PLUG STRIPS, BASEBOARD RADIATION ENCLOSURES, ELECTRICAL PANEL BOARDS, DIFFUSERS, ELECTRICAL PANEL BOARDS, DIFFUSERS, SPEAKERS, TRIM RINGS, AND EXPOSED DUCTS TO MATCH ADJACENT SURFACE FINISH.
- PROVIDE SEALANT AT JOINT BETWEEN COUNTERTOPS, BACKSPLASH, AND CERAMIC PLUMBING FIXTURES.
- ALL SOFFITS AND BULKHEADS TO BE PAINTED TO MATCH ADJACENT WALL SURFACE, UNLESS OTHERWISE INDICATED.
- WHERE A NEW FLOOR DRAIN IS INSTALLED, SLOPE FLOOR TO DRAIN 1/8" PER FOOT MINIMUM, TYP. FOR NEW FLOOR DRAIN IN EXIST RESTROOM ON THE SECOND FLOOR OF THE LODGE, SLOPE FLOOR AS CLOSE TO 1/8" AS POSSIBLE, AS LIMITED BY EXIST CONSTRUCTION, WHILE MAINTAINING A LEVEL FLOOR TRANSITION BETWEEN THE FINISHED SURFACE OF THE SECOND FLOOR HALLWAY AND RESTROOM.
- INSTALL NEW CLOTH ROLLER WINDOW SHADES ON WINDOWS AS SHOWN ON THE DRAWINGS. FIELD VERIFY WIDTH AND HEIGHT OF ALL WINDOW OPENINGS REQUIRING WINDOW SHADES AS DIMENSIONS MAY VARY FROM THOSE SHOWN ON THE DRAWINGS DUE TO EXISTING CONDITIONS AND RENOVATION WORK.
- PATCH TO MATCH ANY EXIST WOOD WALL BASE DAMAGED OR REQUIRED TO BE REMOVED DURING CONSTRUCTION.
- WHERE NEW PAINT FINISH IS INDICATED IN THE ROOM FINISH SCHEDULE IN AN EXIST SPACE, PAINT ENTIRE SURFACE (ALL WALLS, OR ENTIRE CLG, FOR EXAMPLE).
- ALIGN NEW RESTROOM FLOOR DRAIN AND FLOOR SLOPE LINES WITH TILE GROUT JOINTS WHERE POSSIBLE TO REDUCE NUMBER OF TILES REQUIRING TO BE CUT.
- REFER TO SPECIFICATION SECTION 033053 'SHORT FORM CAST-IN-PLACE CONCRETE' FOR ADDITIONAL FINISH INFO REGARDING CIP CONC SURFACES.
- REFER TO SPECIFICATION SECTION 14 24 00 'ELEVATORS AND LIFTS' FOR INFORMATION REGARDING FINISHES FOR THE ELEVATOR CAB AND ACCESSORIES.

FINISH CODE ABBREVIATIONS:


CC	CLEAR COAT	PTM	PATCH TO MATCH EXISTING
CP	CARPET	RB	RESILIENT BASE
CWT	CERAMIC WALL TILE	S	STAIN
E	EXISTING FINISH TO REMAIN	WD	WOOD STRIP FLOORING
PPT	PORCELAIN PAVER TILE	WS	WINDOW SHADE
P	PAINT		
CD	COMPOSITE DECKING		

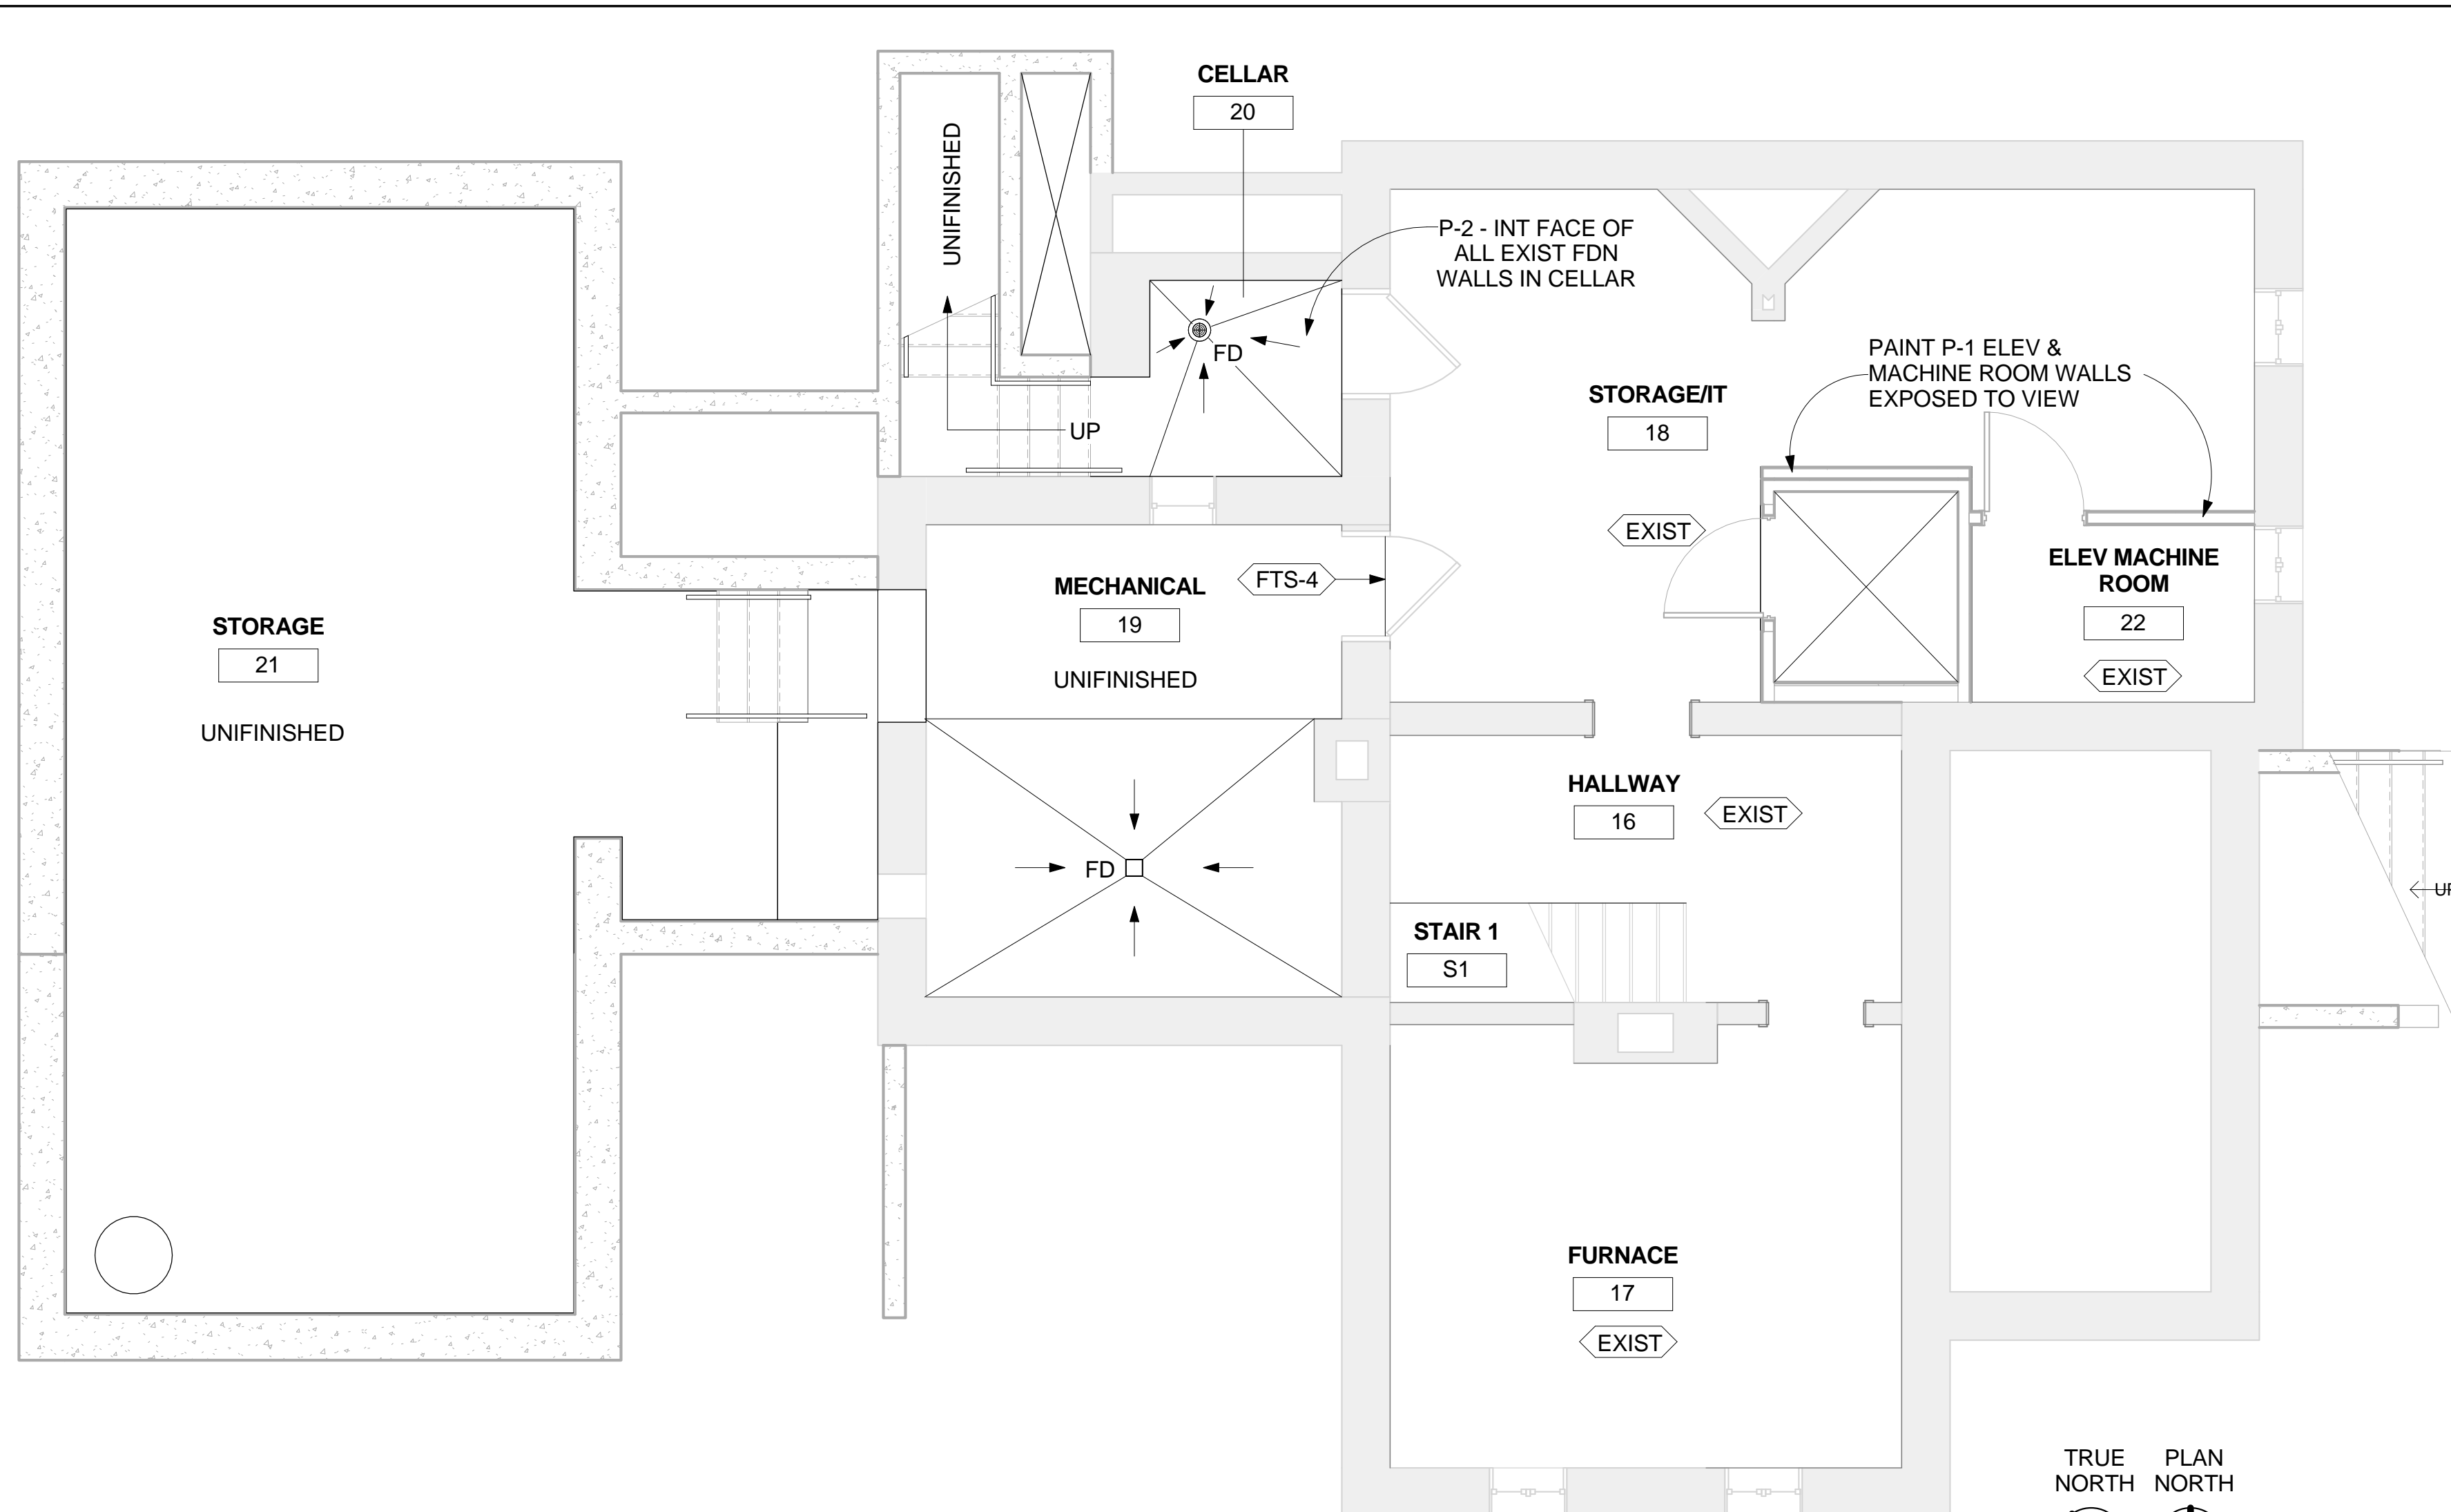


1 FINISH PLAN BASEMENT LEVEL
1/4" = 1'-0"

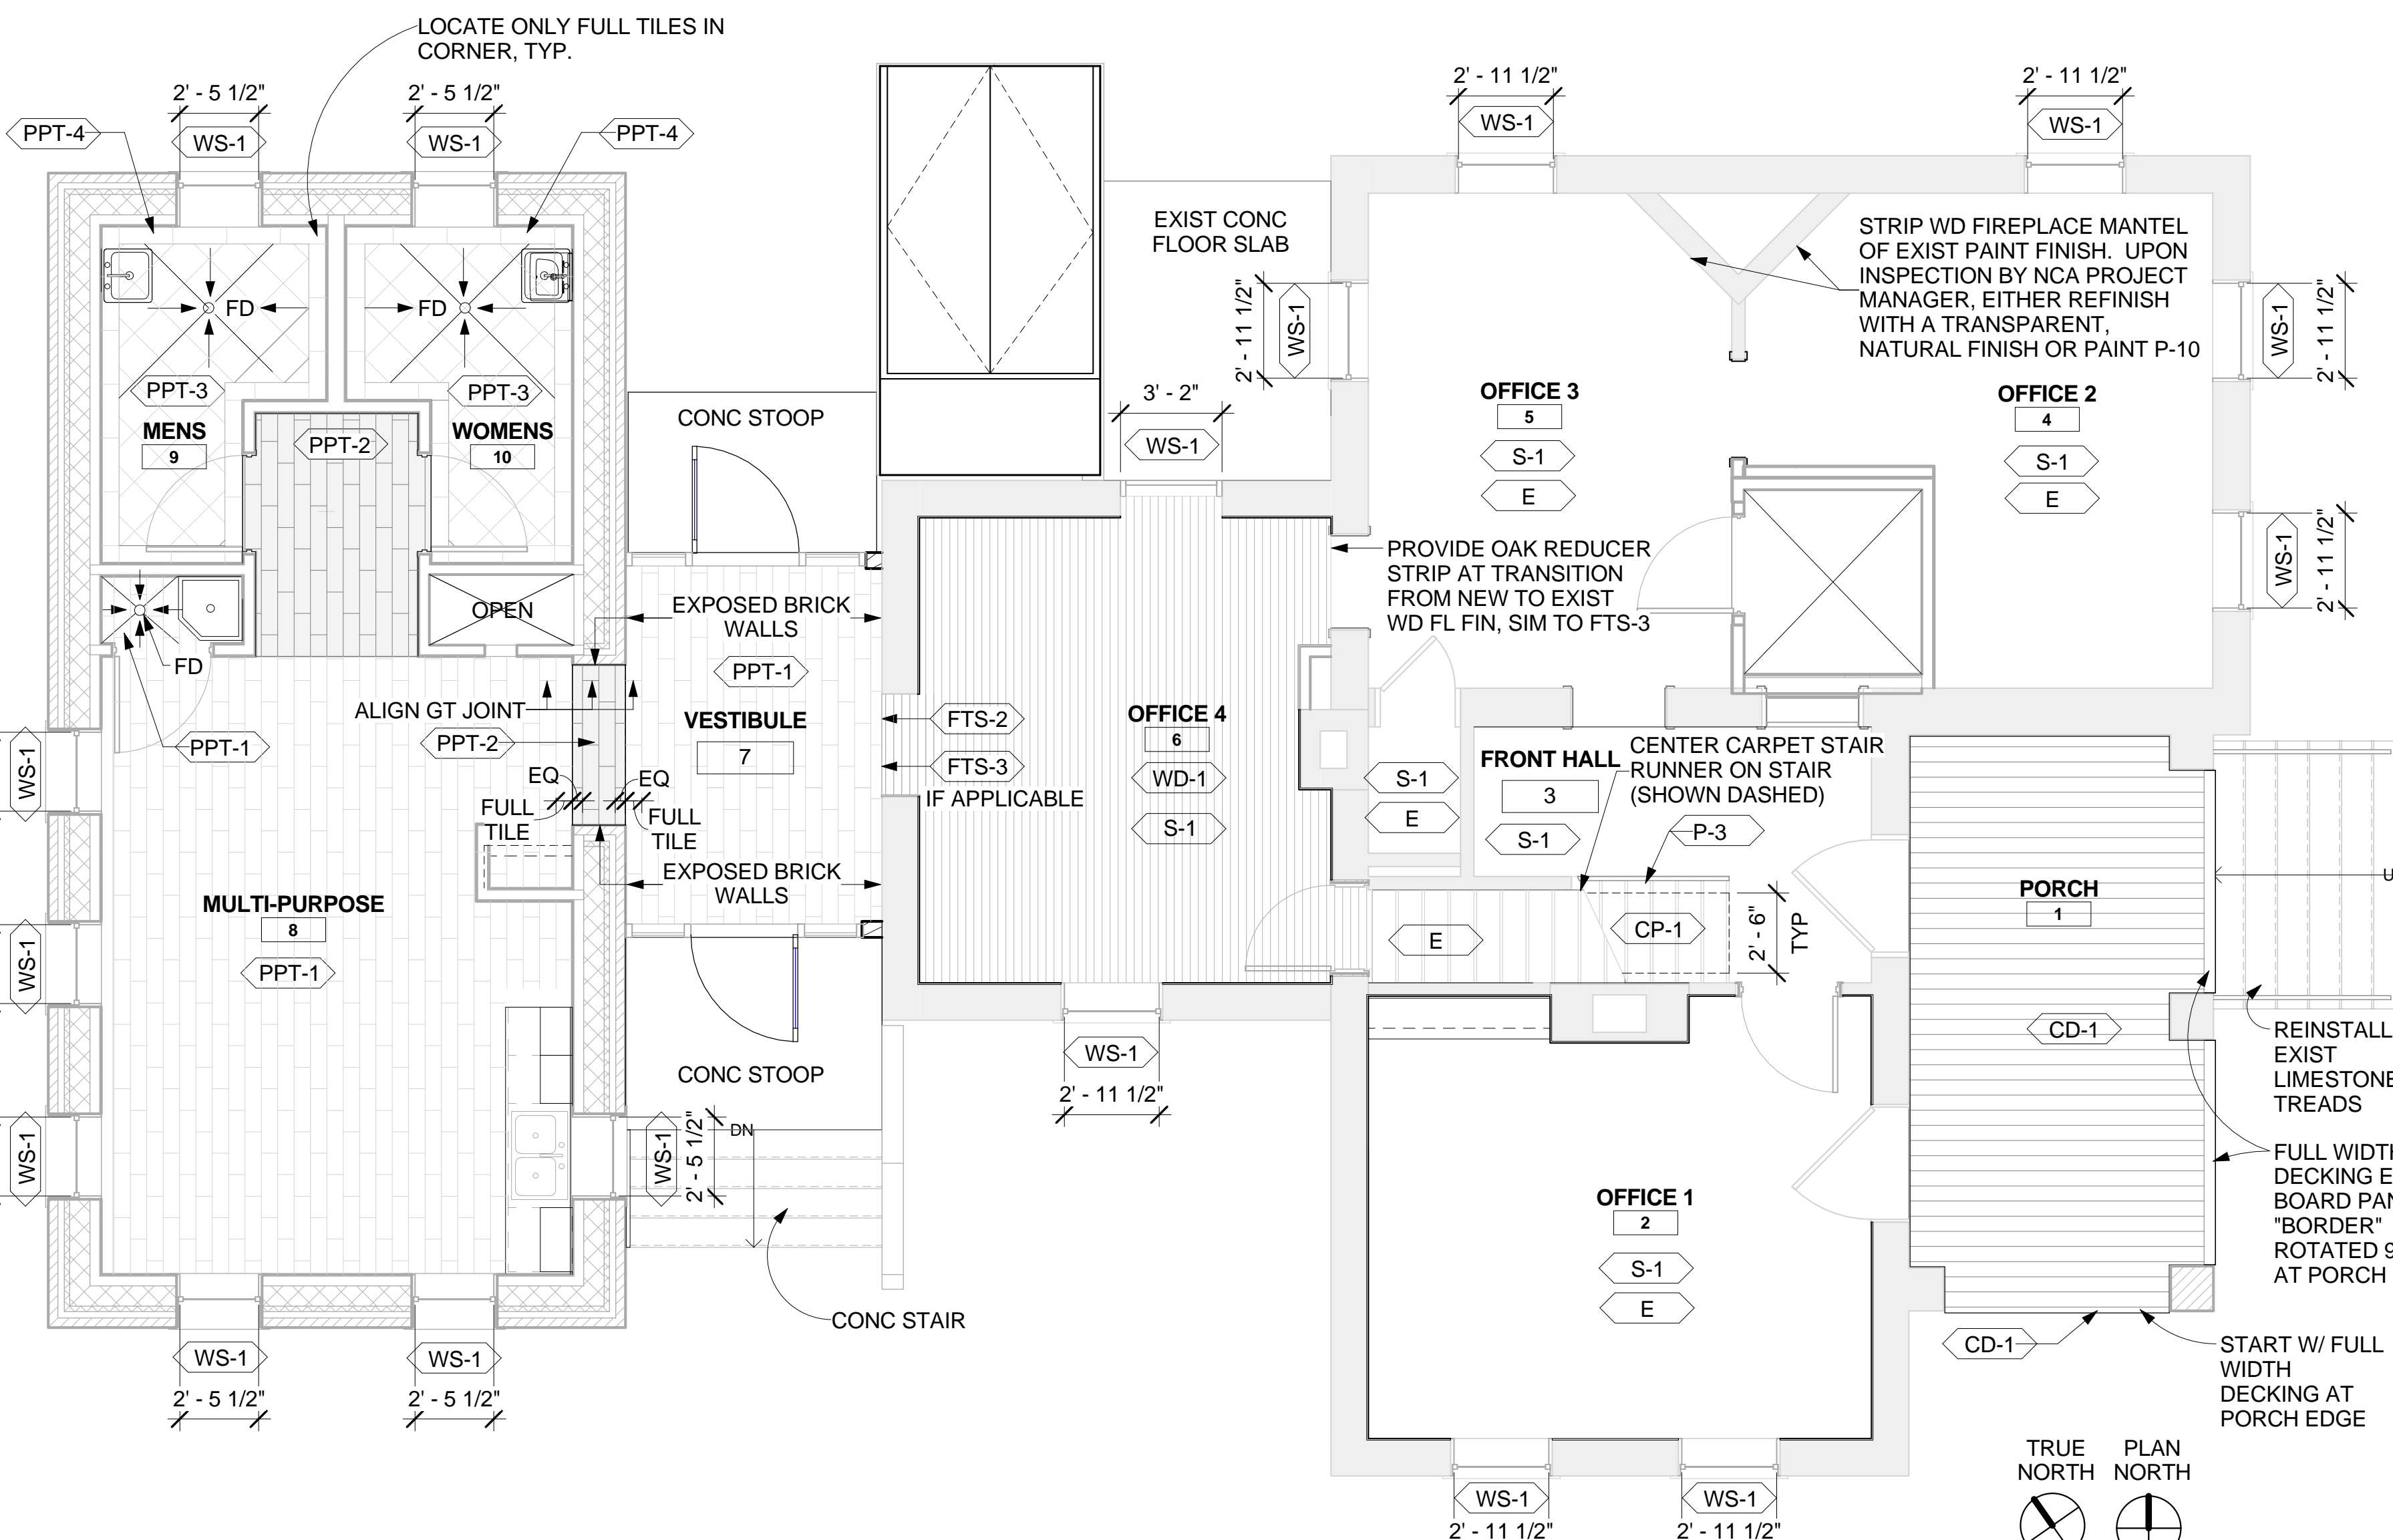

2 FINISH PLAN FIRST LEVEL
1/4" = 1'-0"

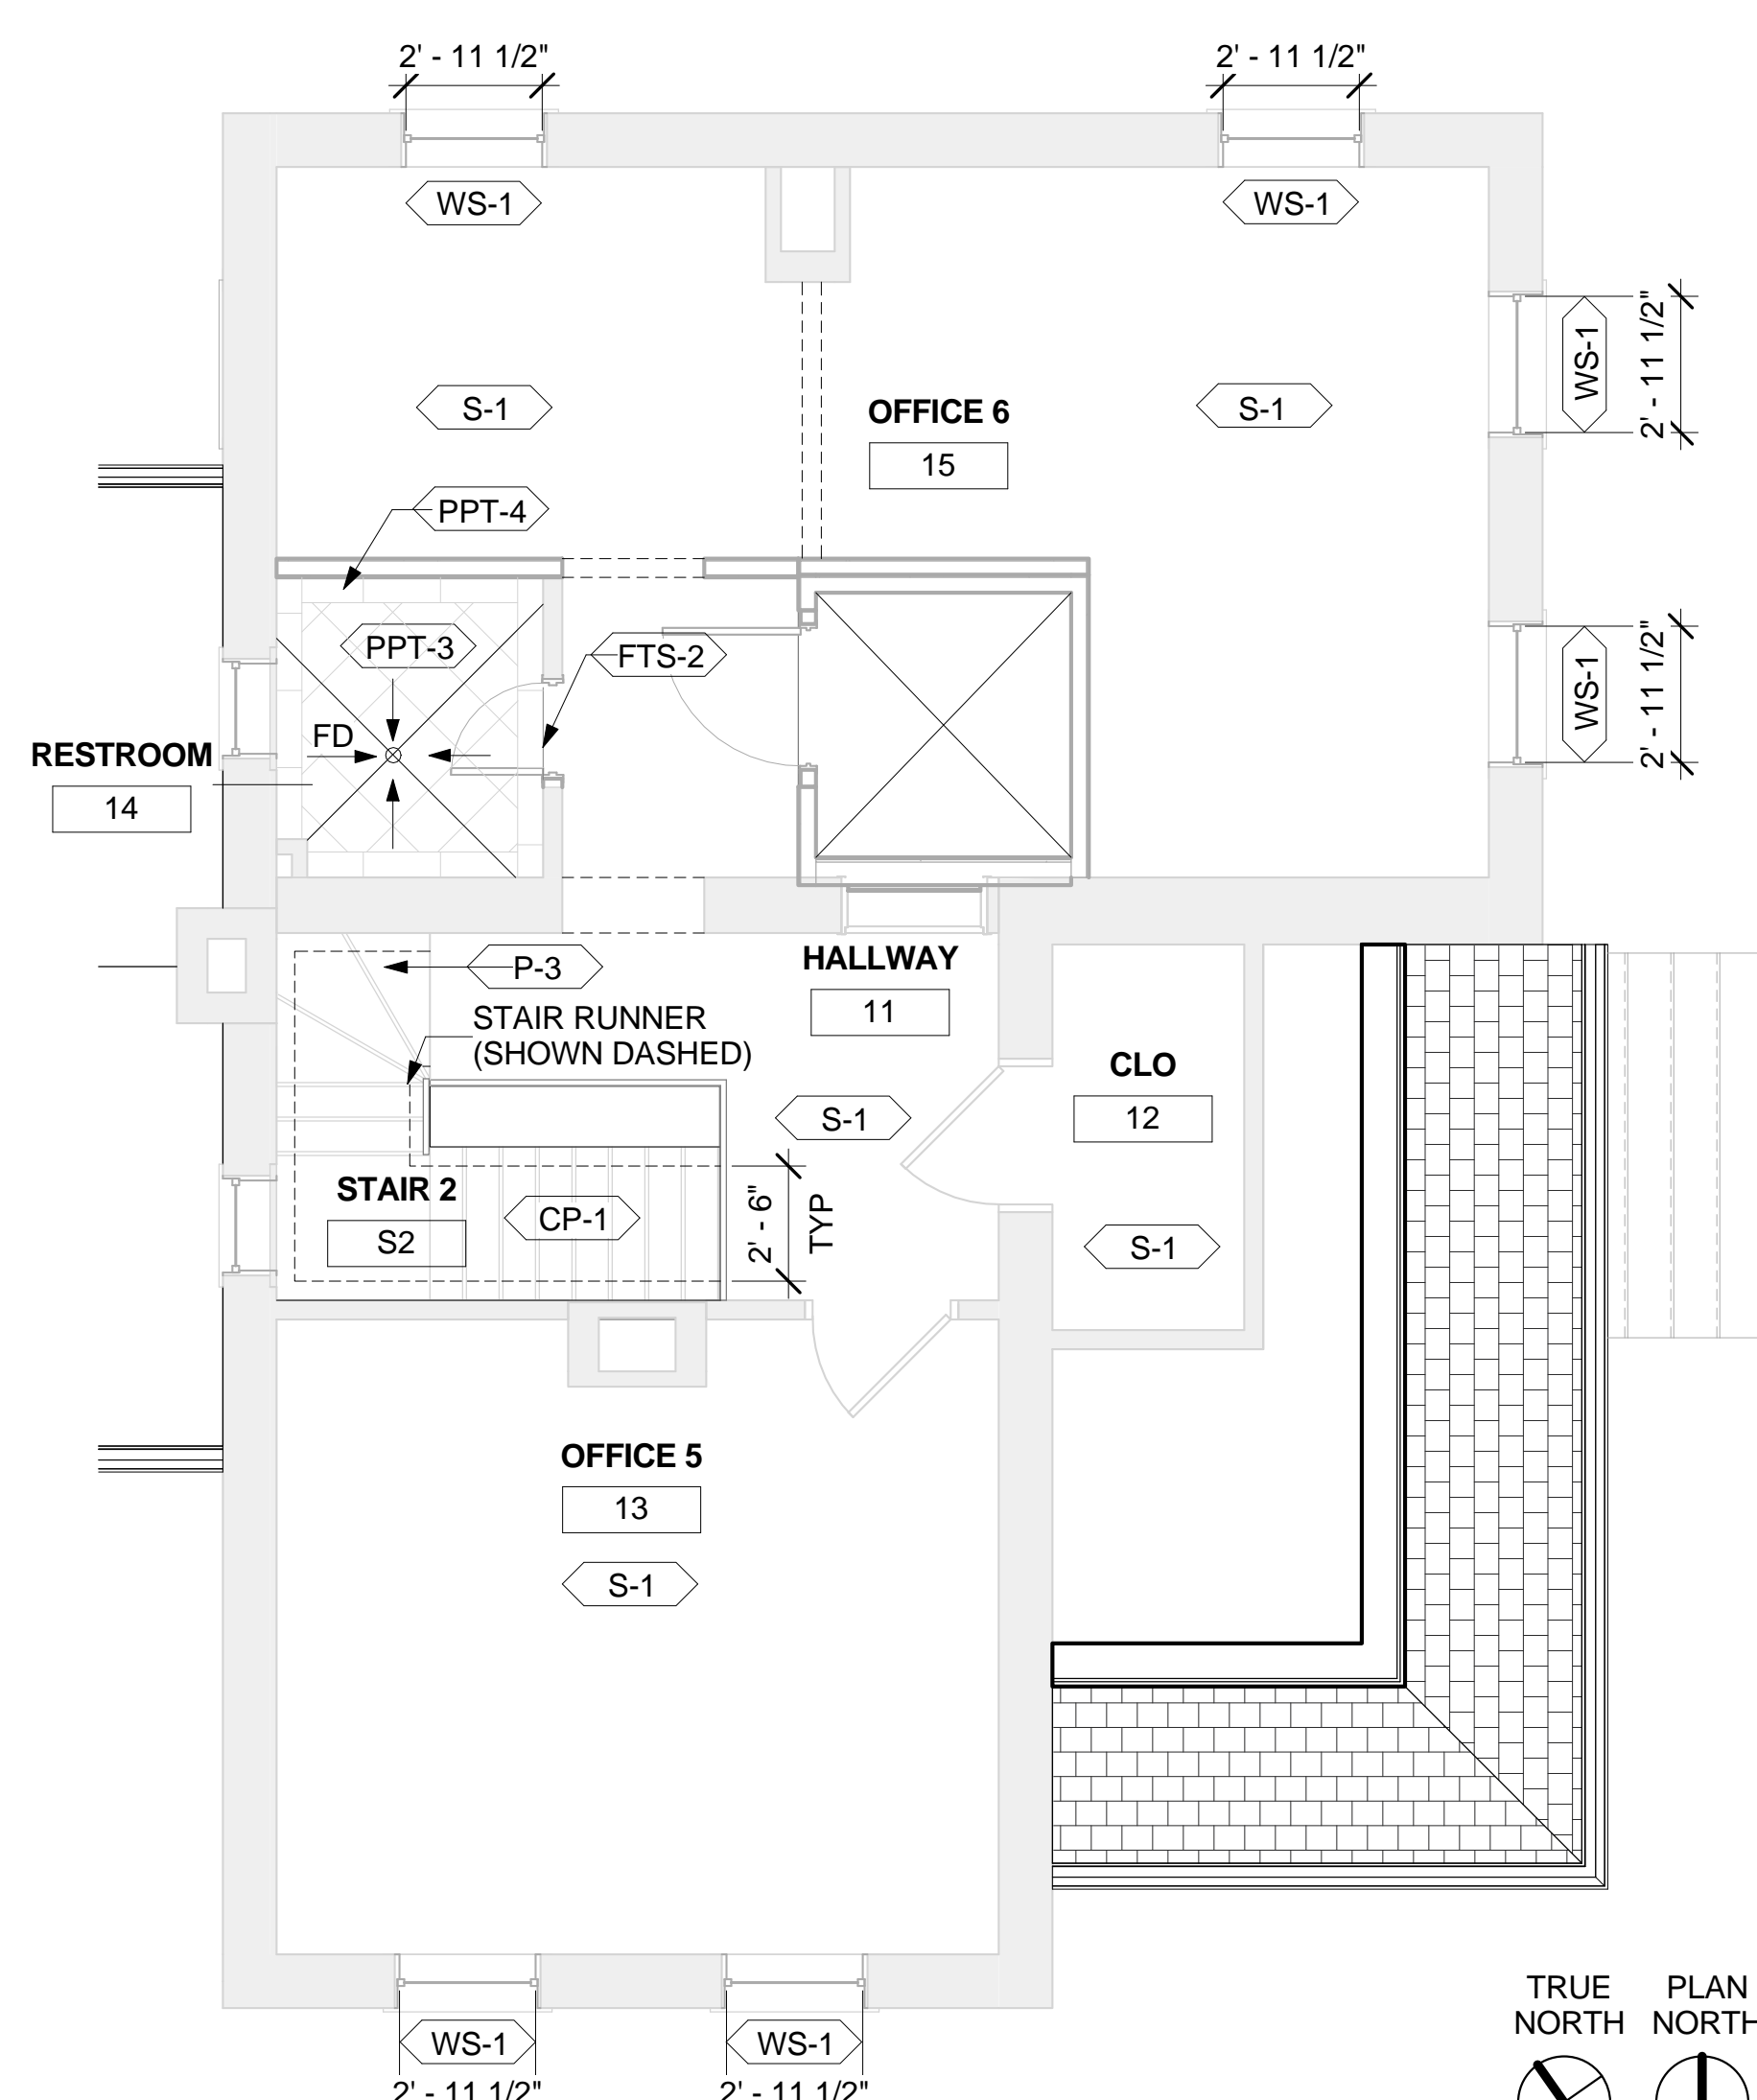

3 FINISH PLAN SECOND LEVEL
1/4" = 1'-0"

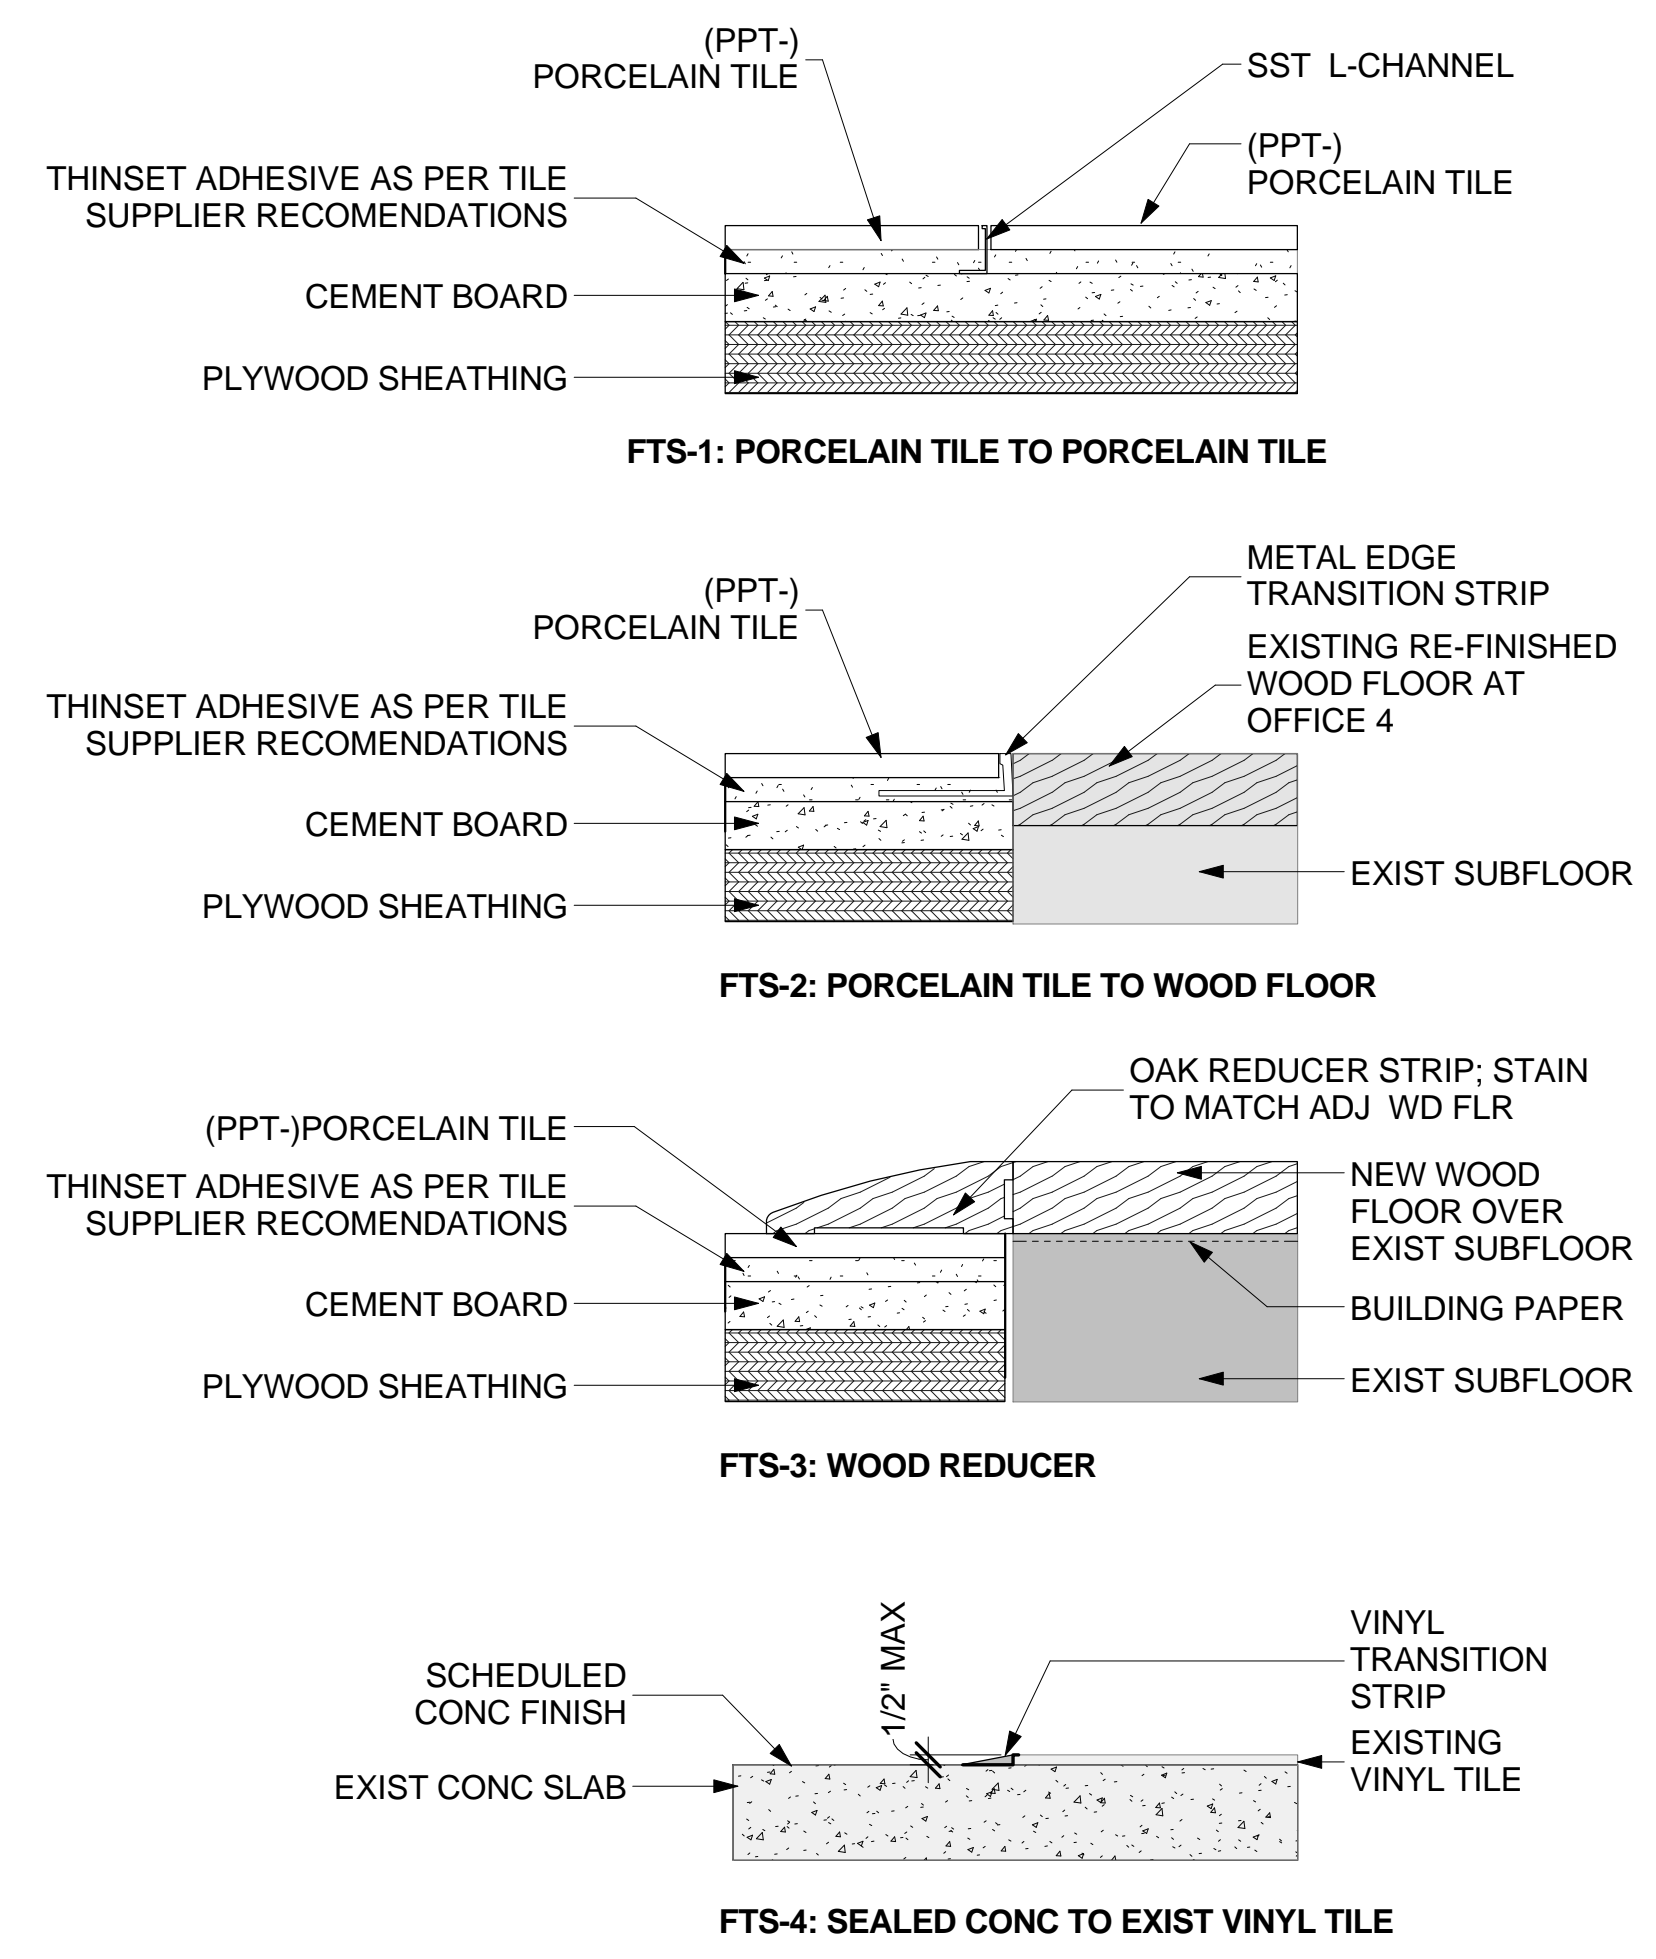

4 FLOOR TRANSITIONS
6" = 1'-0"

BID SET DOCUMENTS

CONSULTANTS: ENGINEERING CONSULTANTS The FUTURE Built SMARTER! 623 26TH AVENUE SUITE 200, ST. LOUIS, MO 63103 PH: 314.433.8873 FAX: 314.433.8873	I HEREBY CERTIFY THAT THIS PLAN, SPECIFICATION, OR REPORT WAS PREPARED BY ME OR UNDER MY DIRECT SUPERVISION AND THAT I AM A DULY LICENSED ARCHITECT UNDER THE LAWS OF THE STATE OF MINNESOTA. SIGNATURE: TYPED OR PRINTED NAME: PAUL D. DAHLBERG DATE: FEBRUARY 25, 2016 LICENSE NUMBER: 15870	ARCHITECT/ENGINEERS: ANDERSON ENGINEERING ENGINEERING • ARCHITECTURE • LAND SURVEYING ENVIRONMENTAL SERVICES • LANDSCAPE ARCHITECTURE AE PROJECT NO.: 13802	Drawing Title FINISH FLOOR PLANS Approved: Project Director	Project Title LODGE REHABILITATION Location FT LEAVENWORTH NATIONAL CEMETERY LEAVENWORTH, KS	Project Number 887CM3005 Building Number Drawing Number A1.04 Dwg. 19 of 67	Office of Construction and Facilities Management U.S. Department of Veterans Affairs

