


GENERAL CONSTRUCTION NOTES

1. THE GENERAL CONTRACTOR SHALL VERIFY EXISTING CONDITIONS AND DIMENSIONS AT THE JOB SITE PRIOR TO BIDDING ON THIS PROJECT.
2. ALL TRAFFIC CONTROL AND ALL SAFETY DEVICES, INCLUDING SIGNAGE SHALL BE PROVIDED BY THE GENERAL CONTRACTOR PRIOR TO THE COMMENCEMENT OF WORK. THE G.C. SHALL INSTALL BARRICADES AS DEEMED NECESSARY BY THE ASSIGNED COR (CONTRACTING OFFICER'S REPRESENTATIVE).
3. THE GENERAL CONTRACTOR SHALL VERIFY THE ACTUAL LOCATIONS OF ALL UTILITIES BY WHATEVER MEANS NECESSARY TO PREVENT DAMAGE DURING THE CONSTRUCTION.
4. THE CONTRACTOR IS RESPONSIBLE FOR THE PROTECTION OF ALL SIDEWALKS AND ROADWAYS AND EXISTING V.A. PROPERTY. ANY V.A. PROPERTY WITHIN OR OUTSIDE OF THE WORK AREA LIMITS THAT IS DAMAGED DURING CONSTRUCTION WILL BE REPLACED OR REPAIRED TO ITS ORIGINAL CONDITION AT THE CONTRACTOR'S EXPENSE.
5. ALL WORK WILL BE COMPLETED DURING NORMAL WORKING HOURS, MONDAY THROUGH FRIDAY FROM 8:00 AM TO 4:30 PM. THERE WILL BE NO WORK DURING WEEKENDS OR GOVERNMENT HOLIDAYS UNLESS PREARRANGED WITH AND APPROVED BY THE ASSIGNED PROJECT COR.
6. THE GENERAL CONTRACTOR SHALL PROVIDE COPIES OF ALL MATERIAL DELIVERY "BATCH" TICKETS TO THE ASSIGNED COR.
7. ALL FACILITY PARKING AREAS AND ROADWAYS SHALL BE KEPT FREE OF ANY CONSTRUCTION DEBRIS. THE CONTRACTOR SHALL BE RESPONSIBLE FOR CLEANING IMPACTED AREAS AT THE END OF EACH WORK DAY.

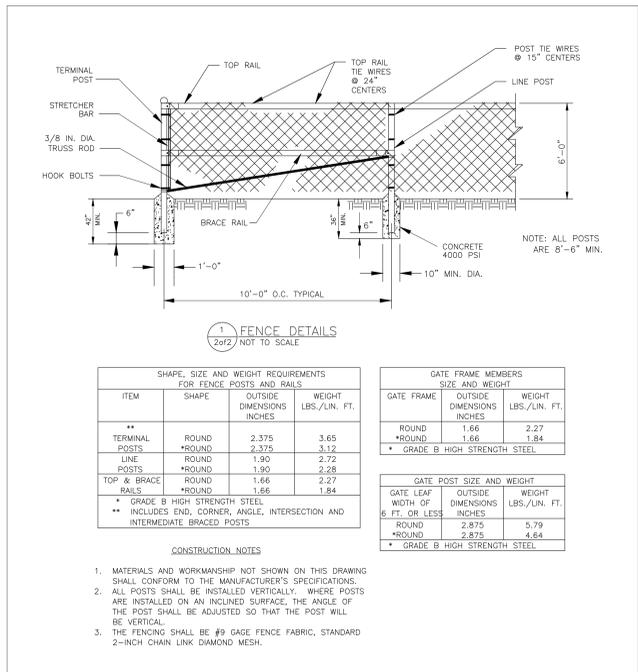


SHAPE, SIZE AND WEIGHT REQUIREMENTS FOR FENCE POSTS AND RAILS			GATE FRAME MEMBERS SIZE AND WEIGHT		
ITEM	SHAPE	OUTSIDE DIMENSIONS LBS./LIN. FT. INCHES	GATE FRAME	OUTSIDE DIMENSIONS LBS./LIN. FT. INCHES	WEIGHT
** TERMINAL POSTS	ROUND	2.375	ROUND	1.66	2.27
	*ROUND	2.375	*ROUND	1.66	1.84
LINE POSTS	ROUND	1.90			
	*ROUND	1.90			
TOP & BRACE RAILS	ROUND	1.66			
	*ROUND	1.66			

* GRADE B HIGH STRENGTH STEEL
** INCLUDES END, CORNER, ANGLE, INTERSECTION AND INTERMEDIATE BRACED POSTS

GATE POST SIZE AND WEIGHT		
GATE LEAF WIDTH OF 6 FT. OR LESS	OUTSIDE DIMENSIONS INCHES	WEIGHT LBS./LIN. FT.
ROUND	2.375	5.79
*ROUND	2.875	4.64

* GRADE B HIGH STRENGTH STEEL


CONSTRUCTION NOTES
1. MATERIALS AND WORKMANSHIP NOT SHOWN ON THIS DRAWING SHALL CONFORM TO THE MANUFACTURER'S SPECIFICATIONS.
2. ALL POSTS SHALL BE INSTALLED VERTICALLY. WHERE POSTS ARE INSTALLED ON AN INCLINED SURFACE, THE ANGLE OF THE POST SHALL BE ADJUSTED SO THAT THE POST WILL BE VERTICAL.
3. THE FENCING SHALL BE #9 GAGE FENCE FABRIC, STANDARD 2-INCH CHAIN LINK DIAMOND MESH.

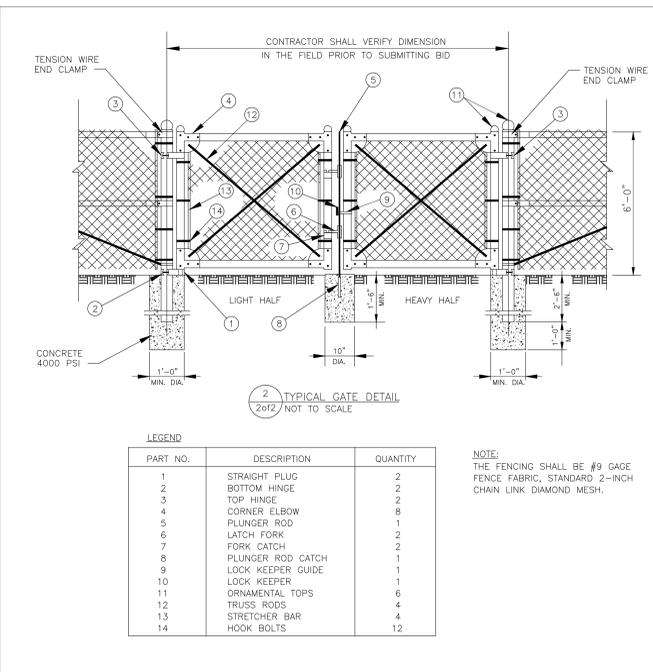

LEGEND

PART NO.	DESCRIPTION	QUANTITY
1	STRAIGHT PLUG	2
2	BOTTOM HINGE	2
3	TOP HINGE	2
4	CORNER ELBOW	8
5	PLUNGER ROD	1
6	LATCH FORK	2
7	FORK CATCH	2
8	PLUNGER ROD CATCH	1
9	LOCK KEEPER GUIDE	1
10	LOCK KEEPER	1
11	ORNAMENTAL TOPS	6
12	TRUSS RODS	4
13	STRETCHER BAR	4
14	HOOK BOLTS	12


NOTE: THE FENCING SHALL BE #9 GAGE FENCE FABRIC, STANDARD 2-INCH CHAIN LINK DIAMOND MESH.

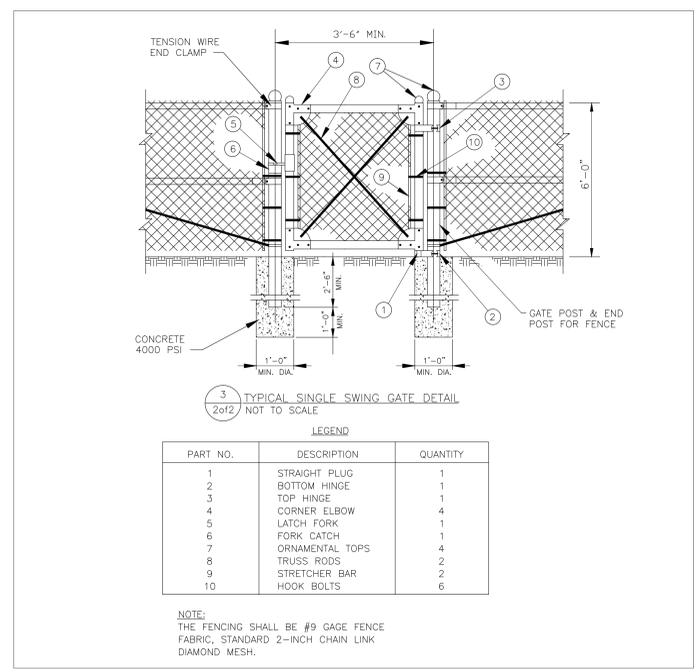

LEGEND

PART NO.	DESCRIPTION	QUANTITY
1	STRAIGHT PLUG	1
2	BOTTOM HINGE	1
3	TOP HINGE	1
4	CORNER ELBOW	4
5	LATCH FORK	1
6	FORK CATCH	1
7	ORNAMENTAL TOPS	4
8	TRUSS RODS	2
9	STRETCHER BAR	2
10	HOOK BOLTS	6

NOTE: THE FENCING SHALL BE #9 GAGE FENCE FABRIC, STANDARD 2-INCH CHAIN LINK DIAMOND MESH.

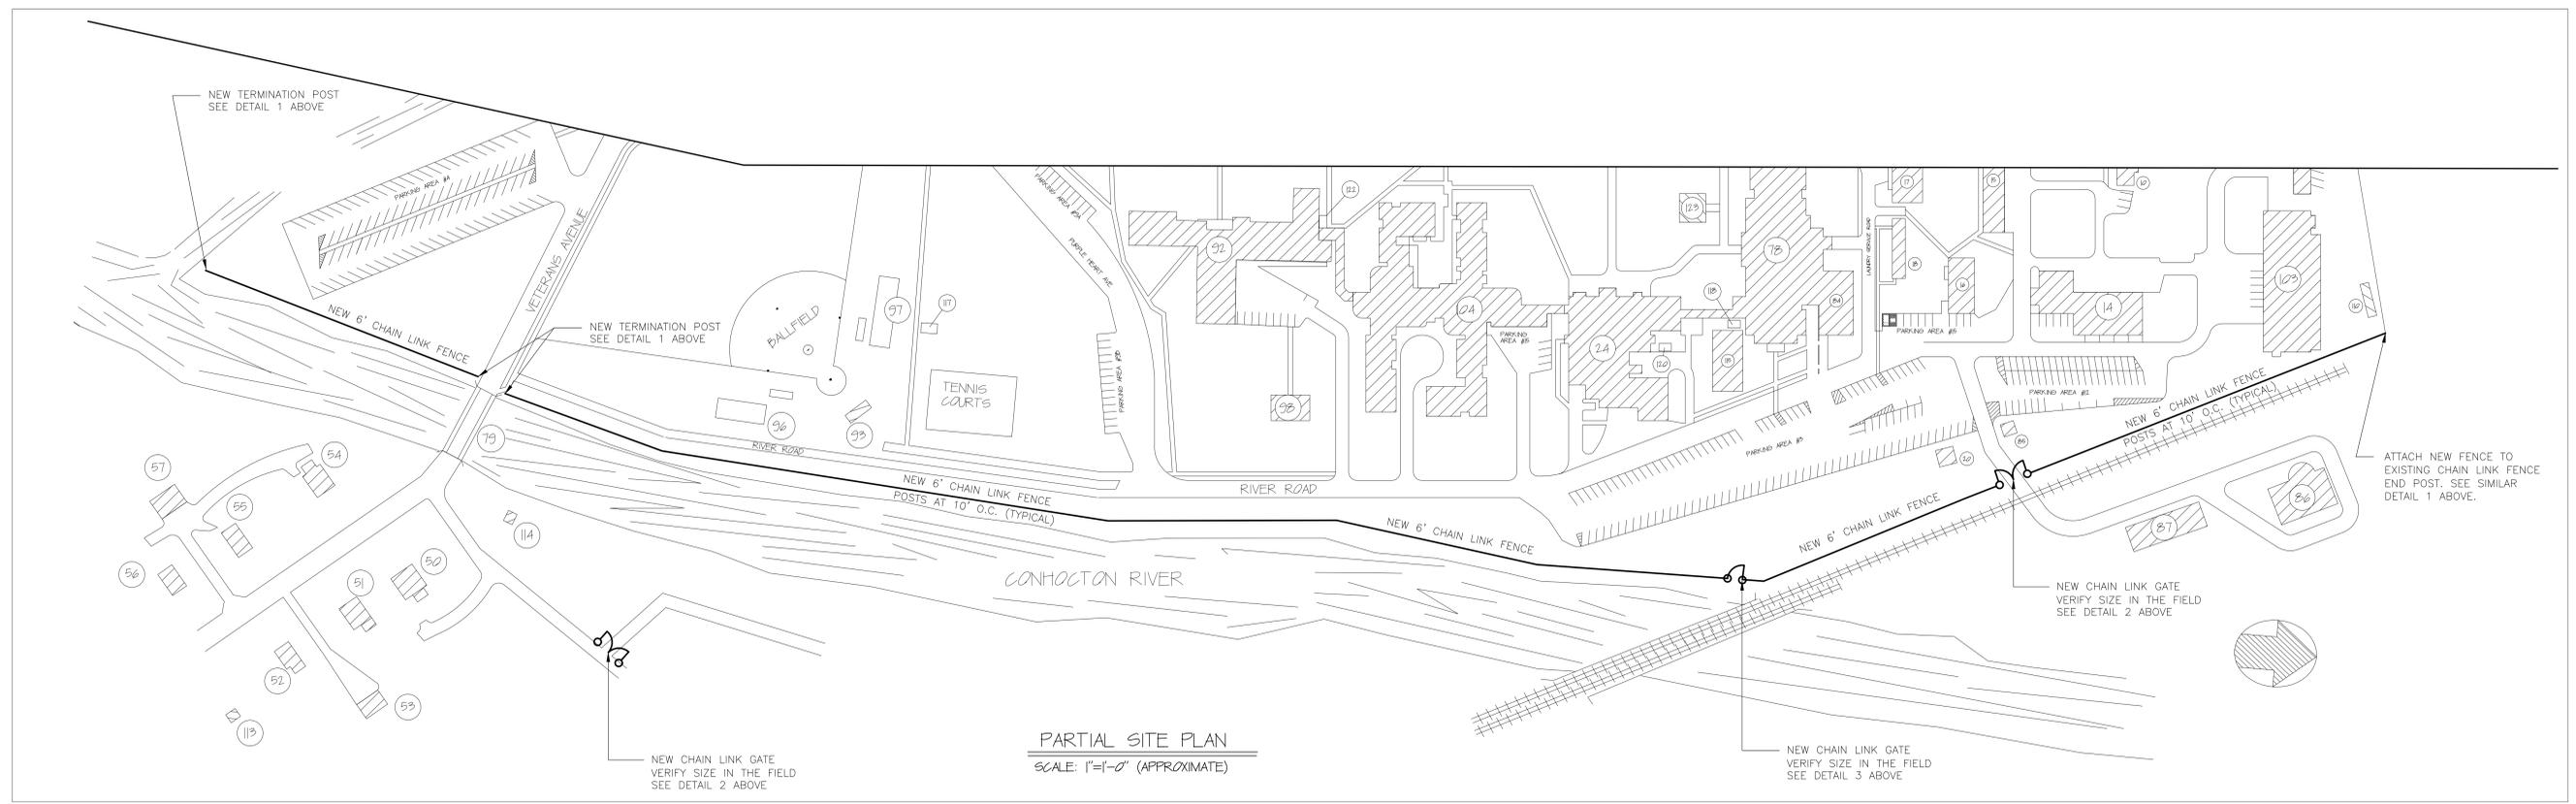

PARTIAL SITE PLAN
SCALE: 1"=1'-0" (APPROXIMATE)

Revisions	Date

Drawing Title PLANS, DETAILS & GENERAL NOTES		Project Title INSTALL 6" CHAIN LINK FENCE		Date 12/30/11
Approved: Engineering Project Manager Date		Building No. STATION		Project No. 528A6-12-607
Approved: Medical Center Director Date		Checked JAY	Drawn JHH	DRAWING NO. VAMC-528A6-1732
		Location BATH, NEW YORK		A-1 Dwg. 2 Of 2