





NOTES:

- REMOVE WALLS, DOOR AND FRAME, ELECTRICAL SWITCH LEGS, OUTLETS, THERMOSTAT, WOODEN HANDRAIL FOR AREA SHOWN HATCHED.
 - INSTALL NEW QUAD OUTLET ON WALL AS INDICATED ON RENOVATION PLAN PRIOR TO REMOVING WALL. THESE CPU'S NEED TO BE POWERED ALL THE TIME.
 - CUT EXISTING G.W.B. CEILING AND RELOCATE THE BUNDLE OF CABLE CONNECTED TO CPU'S AND PATCH CEILING BACK TO MATCH EXISTING SURFACE. TAKE EXTREME CARE IN RELOCATED AS FAR AS THE CABLE ALLOWS(SHOULD NOT BE MORE THAN 18"). NEEDS TO BE RELOCATED TOWARDS THE OUTSIDE WALL.
- REMOVE EXISTING CEILING SYSTEM AND LIGHT FIXTURES AND STORE LIGHTS FOR REINSTALLATION LATER IN PROJECT.
- REMOVE EXISTING PLUMBING LINES AND CAP LINES BEHIND WALL. PATCH WALL TO MATCH SURROUNDING AREA.
- REMOVE V.C.T. TILE AND DISPOSE OFF STATION.
- REMOVE EXISTING MEDICAL GAS HEADWALLS FROM ROOMS 2B-101 AND 2B-104 AND REINSTALL AS PER ELEVATION DRAWING PER THIS SHEET. TIE IN ALL EXISTING UTILITIES ON EACH HEADWALL AND CERTIFY ALL GAS SYSTEMS AFFECTED BY THE RELOCATION OF UNITS.
- CONSTRUCT NEW 8" G.W.B. WALL FROM FLOOR TO A HEIGHT OF 84" AND A OPENING OF 5'-0" WIDE X 6'-8" HIGH.
 - REMOVE EXISTING MEDICAL GAS HEADWALLS FROM ROOMS 2B-106 AND 2B-113 AND REINSTALL ON THE NEW WALL CONSTRUCTED. TIE IN ALL EXISTING UTILITIES ON EACH HEADWALL. CERTIFY ALL MEDIAL GAS SYSTEMS AFFECTED BY RELOCATION.
 - INSTALL ON ALL EXPOSE CORNERS IN THE OPENING NEW S.S. METAL CORNER. PATCH AND REPAIR ALL DAMAGE TO THE WALLS OF THE ROOMS 2B-106 AND 2B-113 FROM THE REMOVAL OF THE HEADWALLS.
- INSTALL NEW METAL FRAME AND DOOR. SWING DOOR OUT TO THE CORRIDOR SIDE AS INDICATED. REUSE EXISTING HARDWARE SALVAGED FROM DEMO.
- CONSTRUCT NEW WALL AND INSTALL NEW TELESCOPING BY BESAM UNISIDE TELESCOPIC DOOR OR EQUAL. DOOR TO HAVE A CLEAR OPENING OF AT LEAST 52"± OR GREATER. CONSTRUCT NEW WALL TO FILL OPENING AS REQUIRED FOR NEW DOOR. DOOR TO HAVE TOUCHLESS DOOR OPENERS EQUAL TO THE ON BOTH THE INSIDE ROOM 2A-104 AND ACROSS THE HALLWAY ON INSIDE OF THE CORRIDOR WALL AT THE EXIT DOOR OF THE GI CLINIC. THE NEW DOOR IS NOT TO HAVE A THRESHOLD, SO THERE WILL BE SMOOTH TRANSITION FROM ONE SIDE TO THE OTHER. POWER FOR THE NEW DOOR TO BE FROM THE ELECTRICAL CLOSET 2A-101 PANEL 2N21. USE ANY SPARE BREAKER THAT IS AVAILABLE.
- INSTALL NEW 3/4" Ø. TYPE K COPPER PIPE FOR NEW O₂, VACUUM AND AIR LINES FROM EXISTING LINES IN CORRIDOR. SEE SHEET 2 FOR LOCATION OF LINES IN CORRIDOR.
- INSTALL NEW LAVATORY WITH WRIST BLADES AS PER SPECS. TIE INTO EXISTING WATER SUPPLY AND WASTE LINES.
- RELOCATE EXISTING CORRIDOR LIGHT SWITCH AND DOOR BELL TO NEW AREA AS INDICATED ON PLAN.
- INSTALL NEW SEAMLESS FLOORING TEKNOFLOR "FORESTSCAPES" COLLECTION. NEW FLOOR TO CREATE A 6" HIGH WALL BASE. SEAL ENDS AS REQUIRED BY MANUFACTURE REQUIREMENTS. PREP FLOOR PRIOR TO INSTALLING FLOORING AS RECOMMENDED BY MANUFACTURE REQUIREMENTS.
- INSTALL NEW 2'x2' A.C.T AT THE SAME ELEVATION OF PREVIOUS HEIGHT AND INSTALL EXISTING LIGHTS SALVAGED FROM DEMO PHASE
- INSTALL NEW CURTAIN TRACKS AS SHOWN ON PLAN.
- REINSTALL EXISTING THERMOSTAT ON WALL AS SHOWN.
- PAINT ALL WALLS COLOR TO BE GIVEN PRIOR TO STARTING PAINTING PHASE.
- INSTALL NEW CAT 6 CABLE AND A QUAD OUTLET FOR NEW DATA AND TELEPHONE JACKS. INSTALL AT 18" A.F.F.

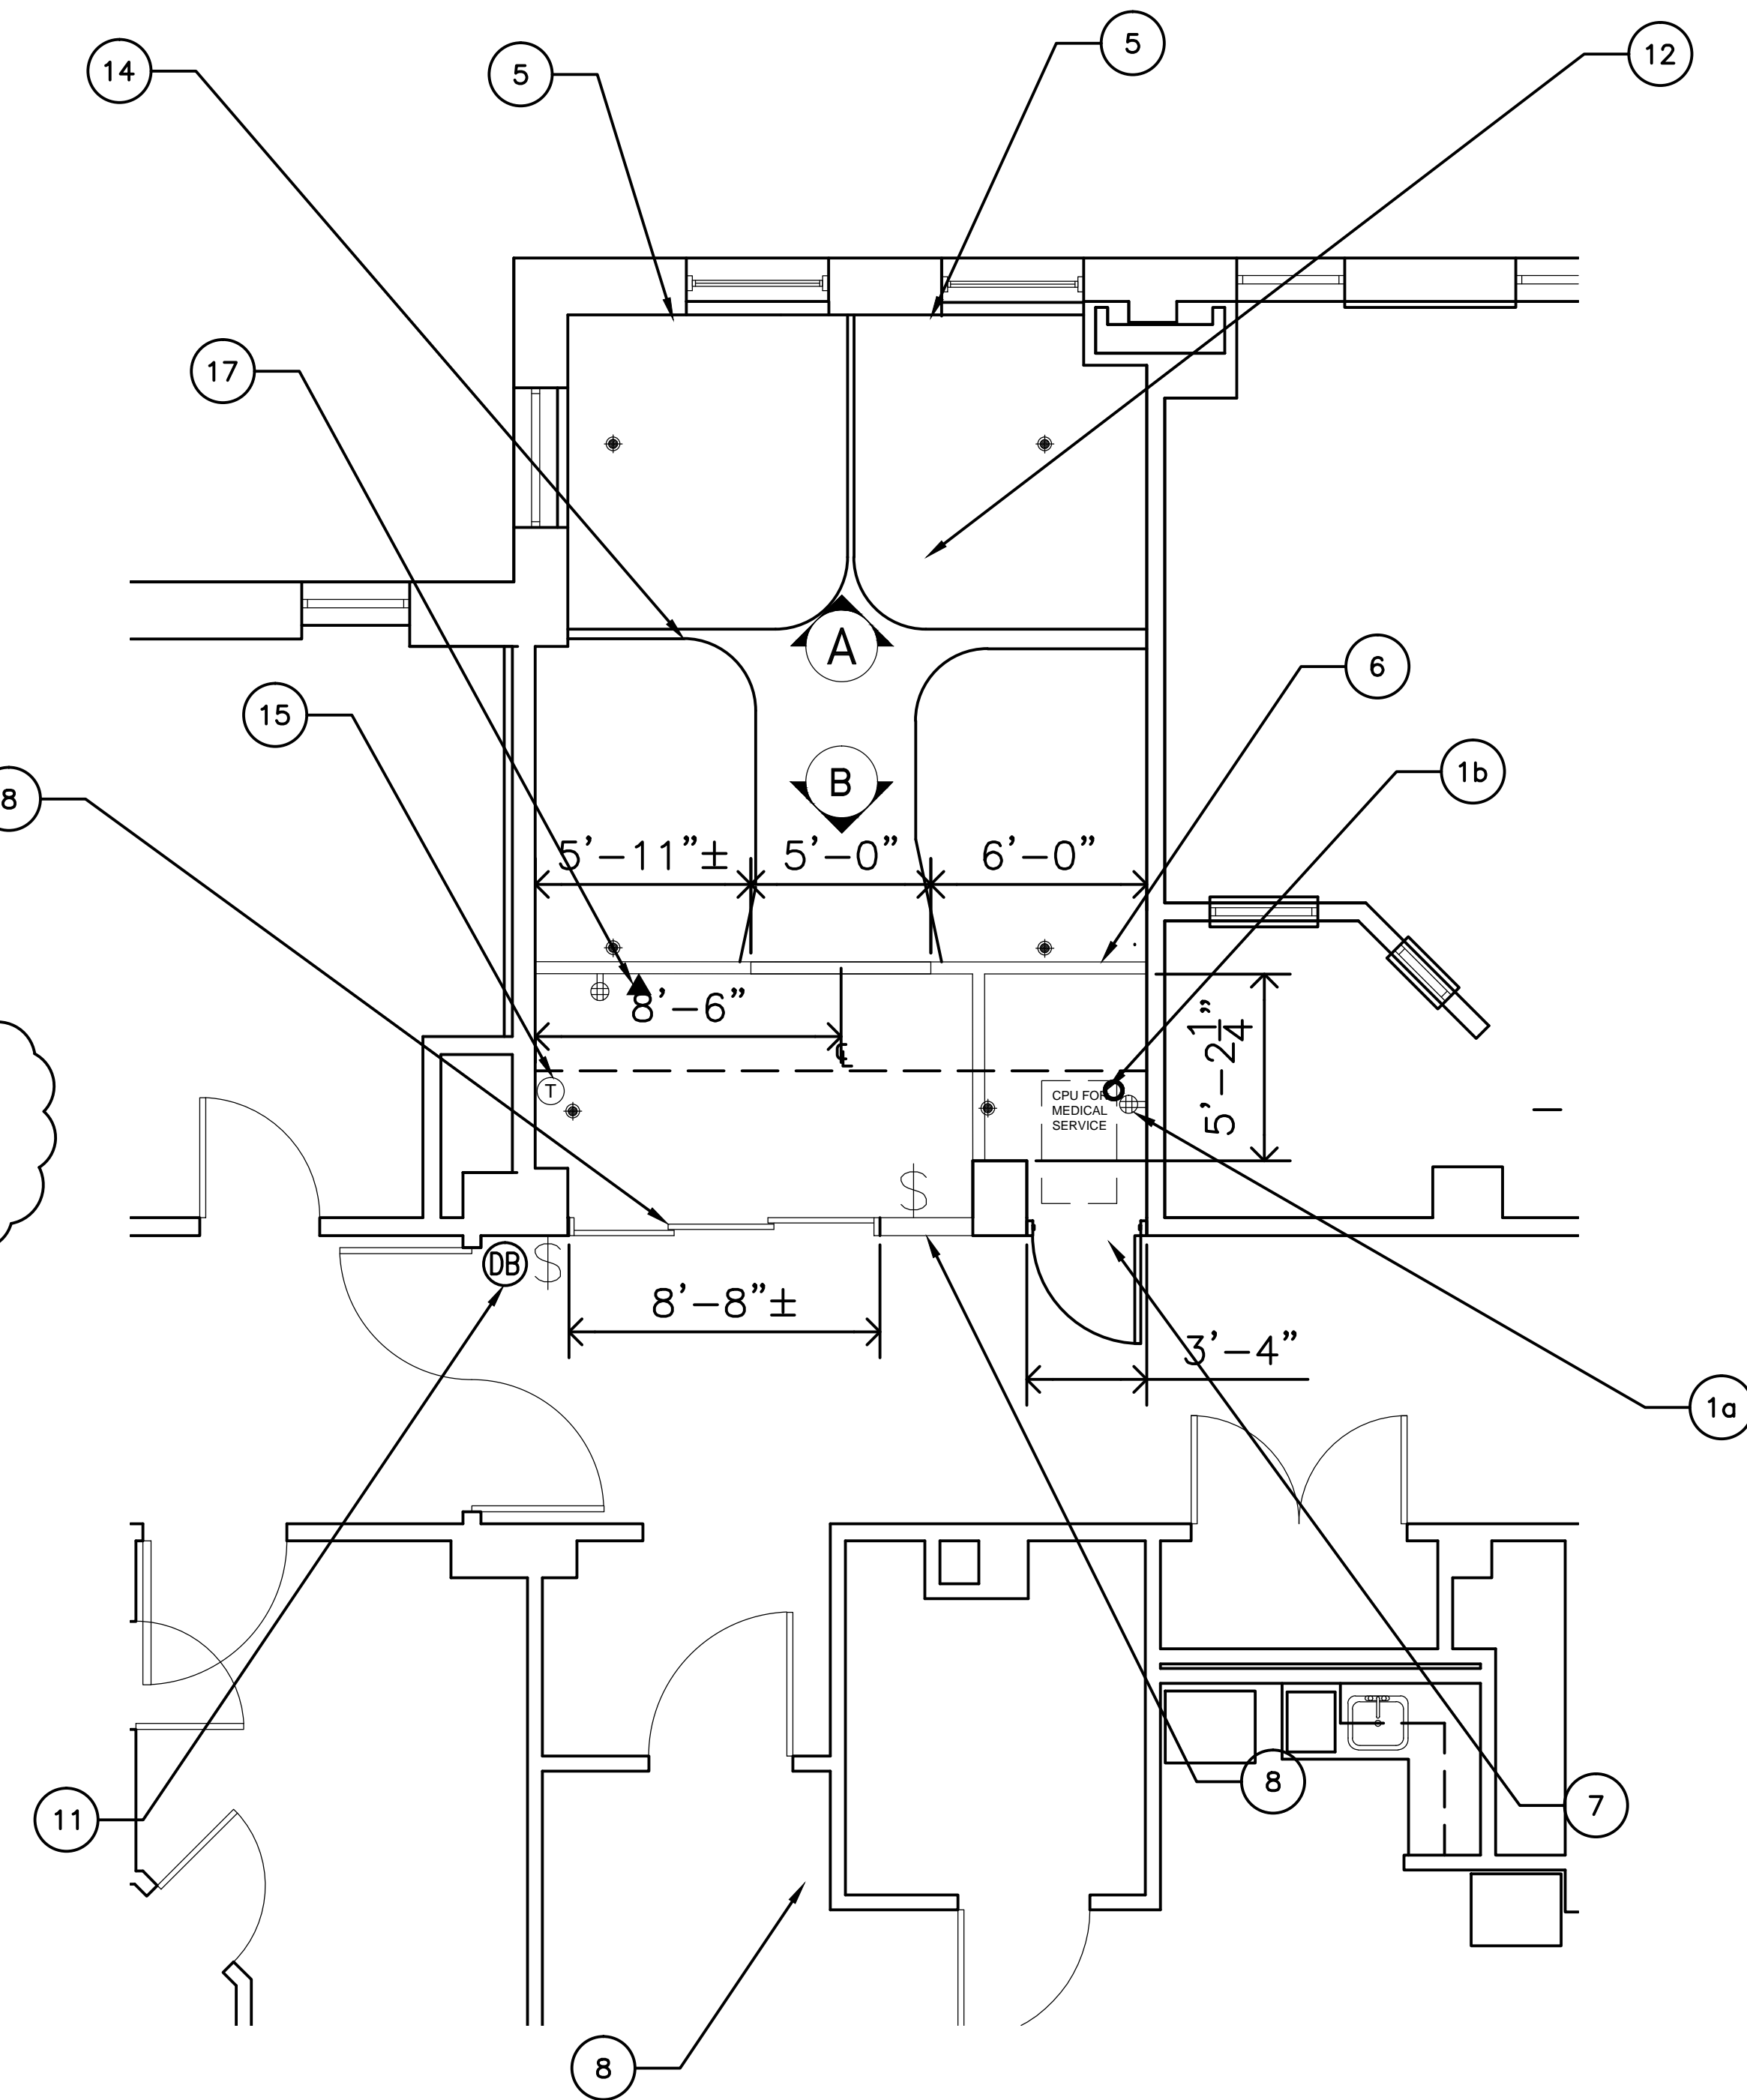

RENOVATION PHASE OF RM 2A-104

1/4" = 1'-0"

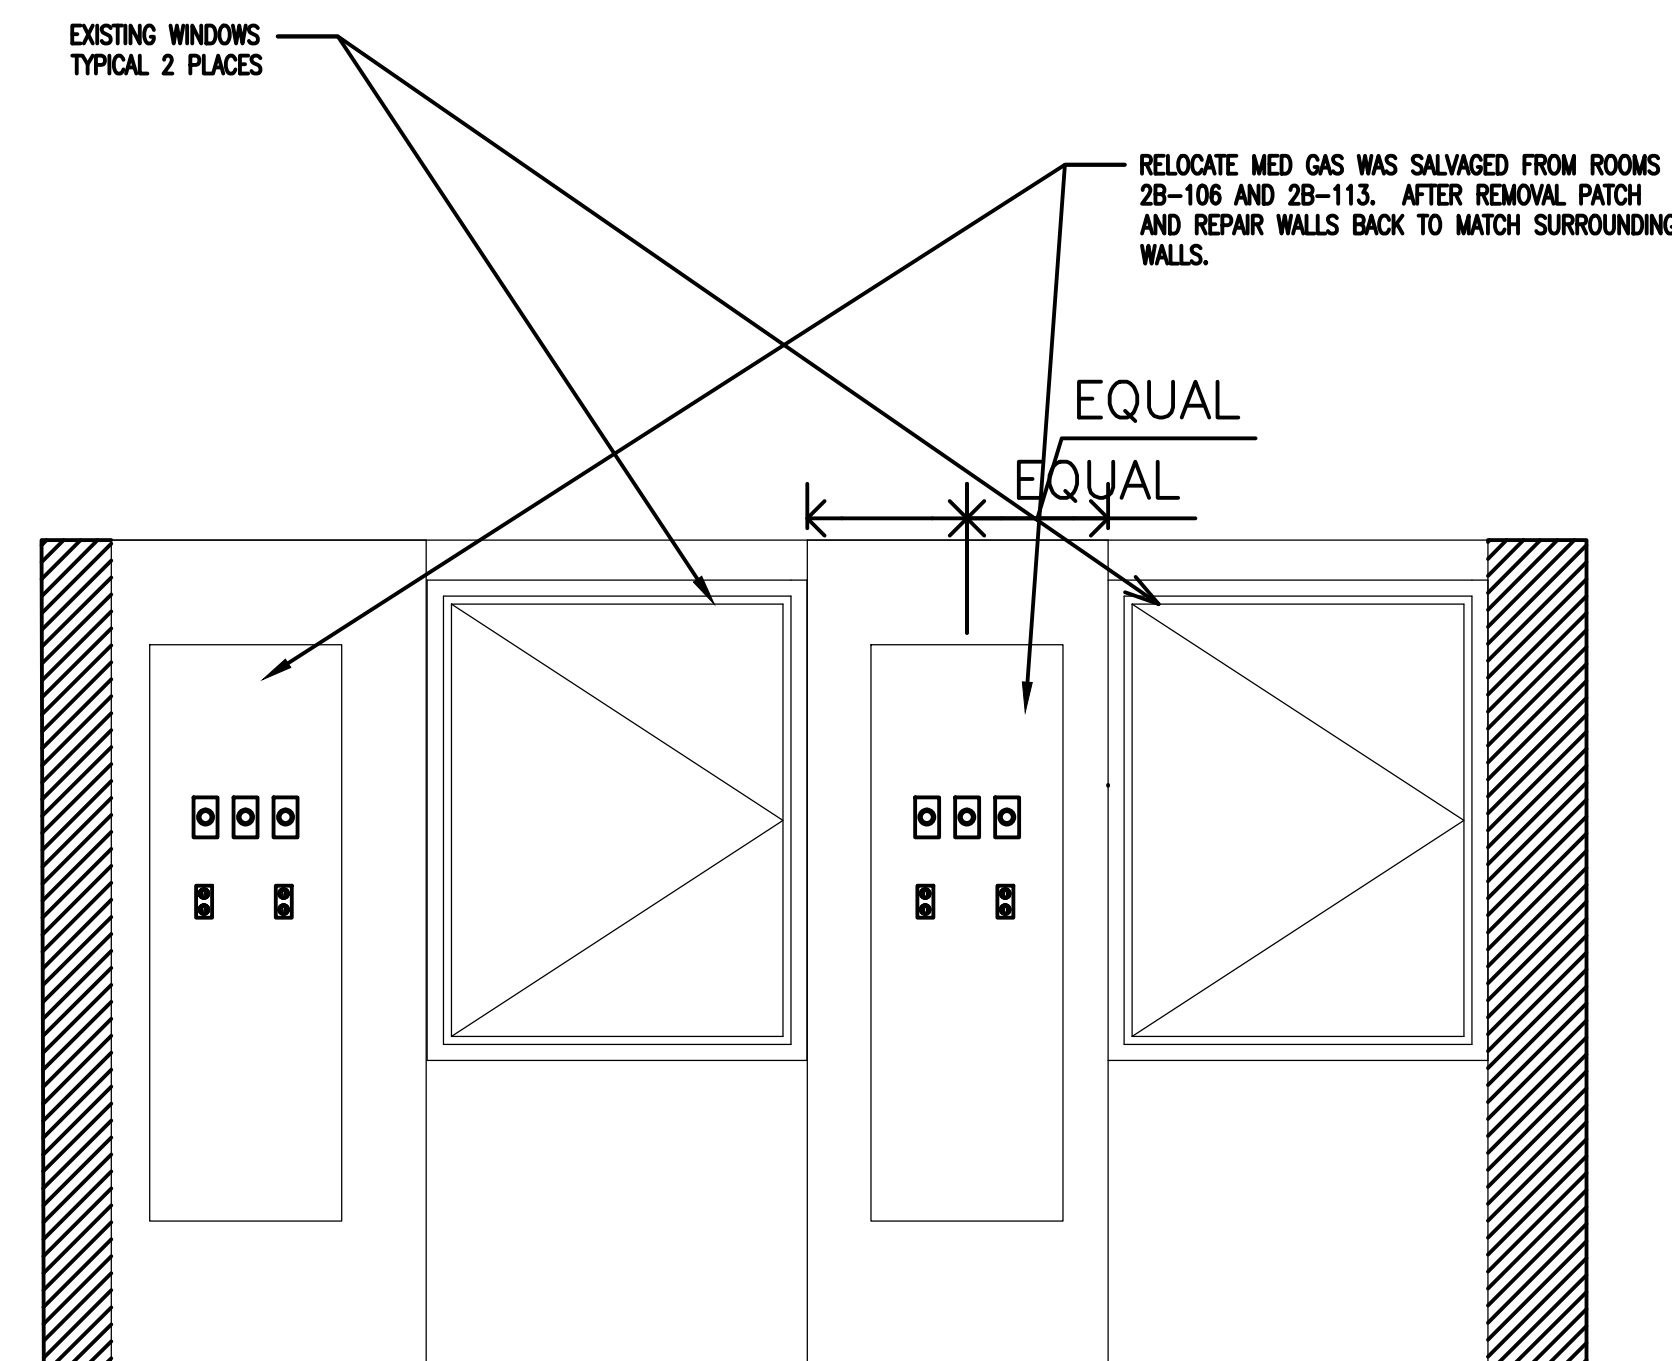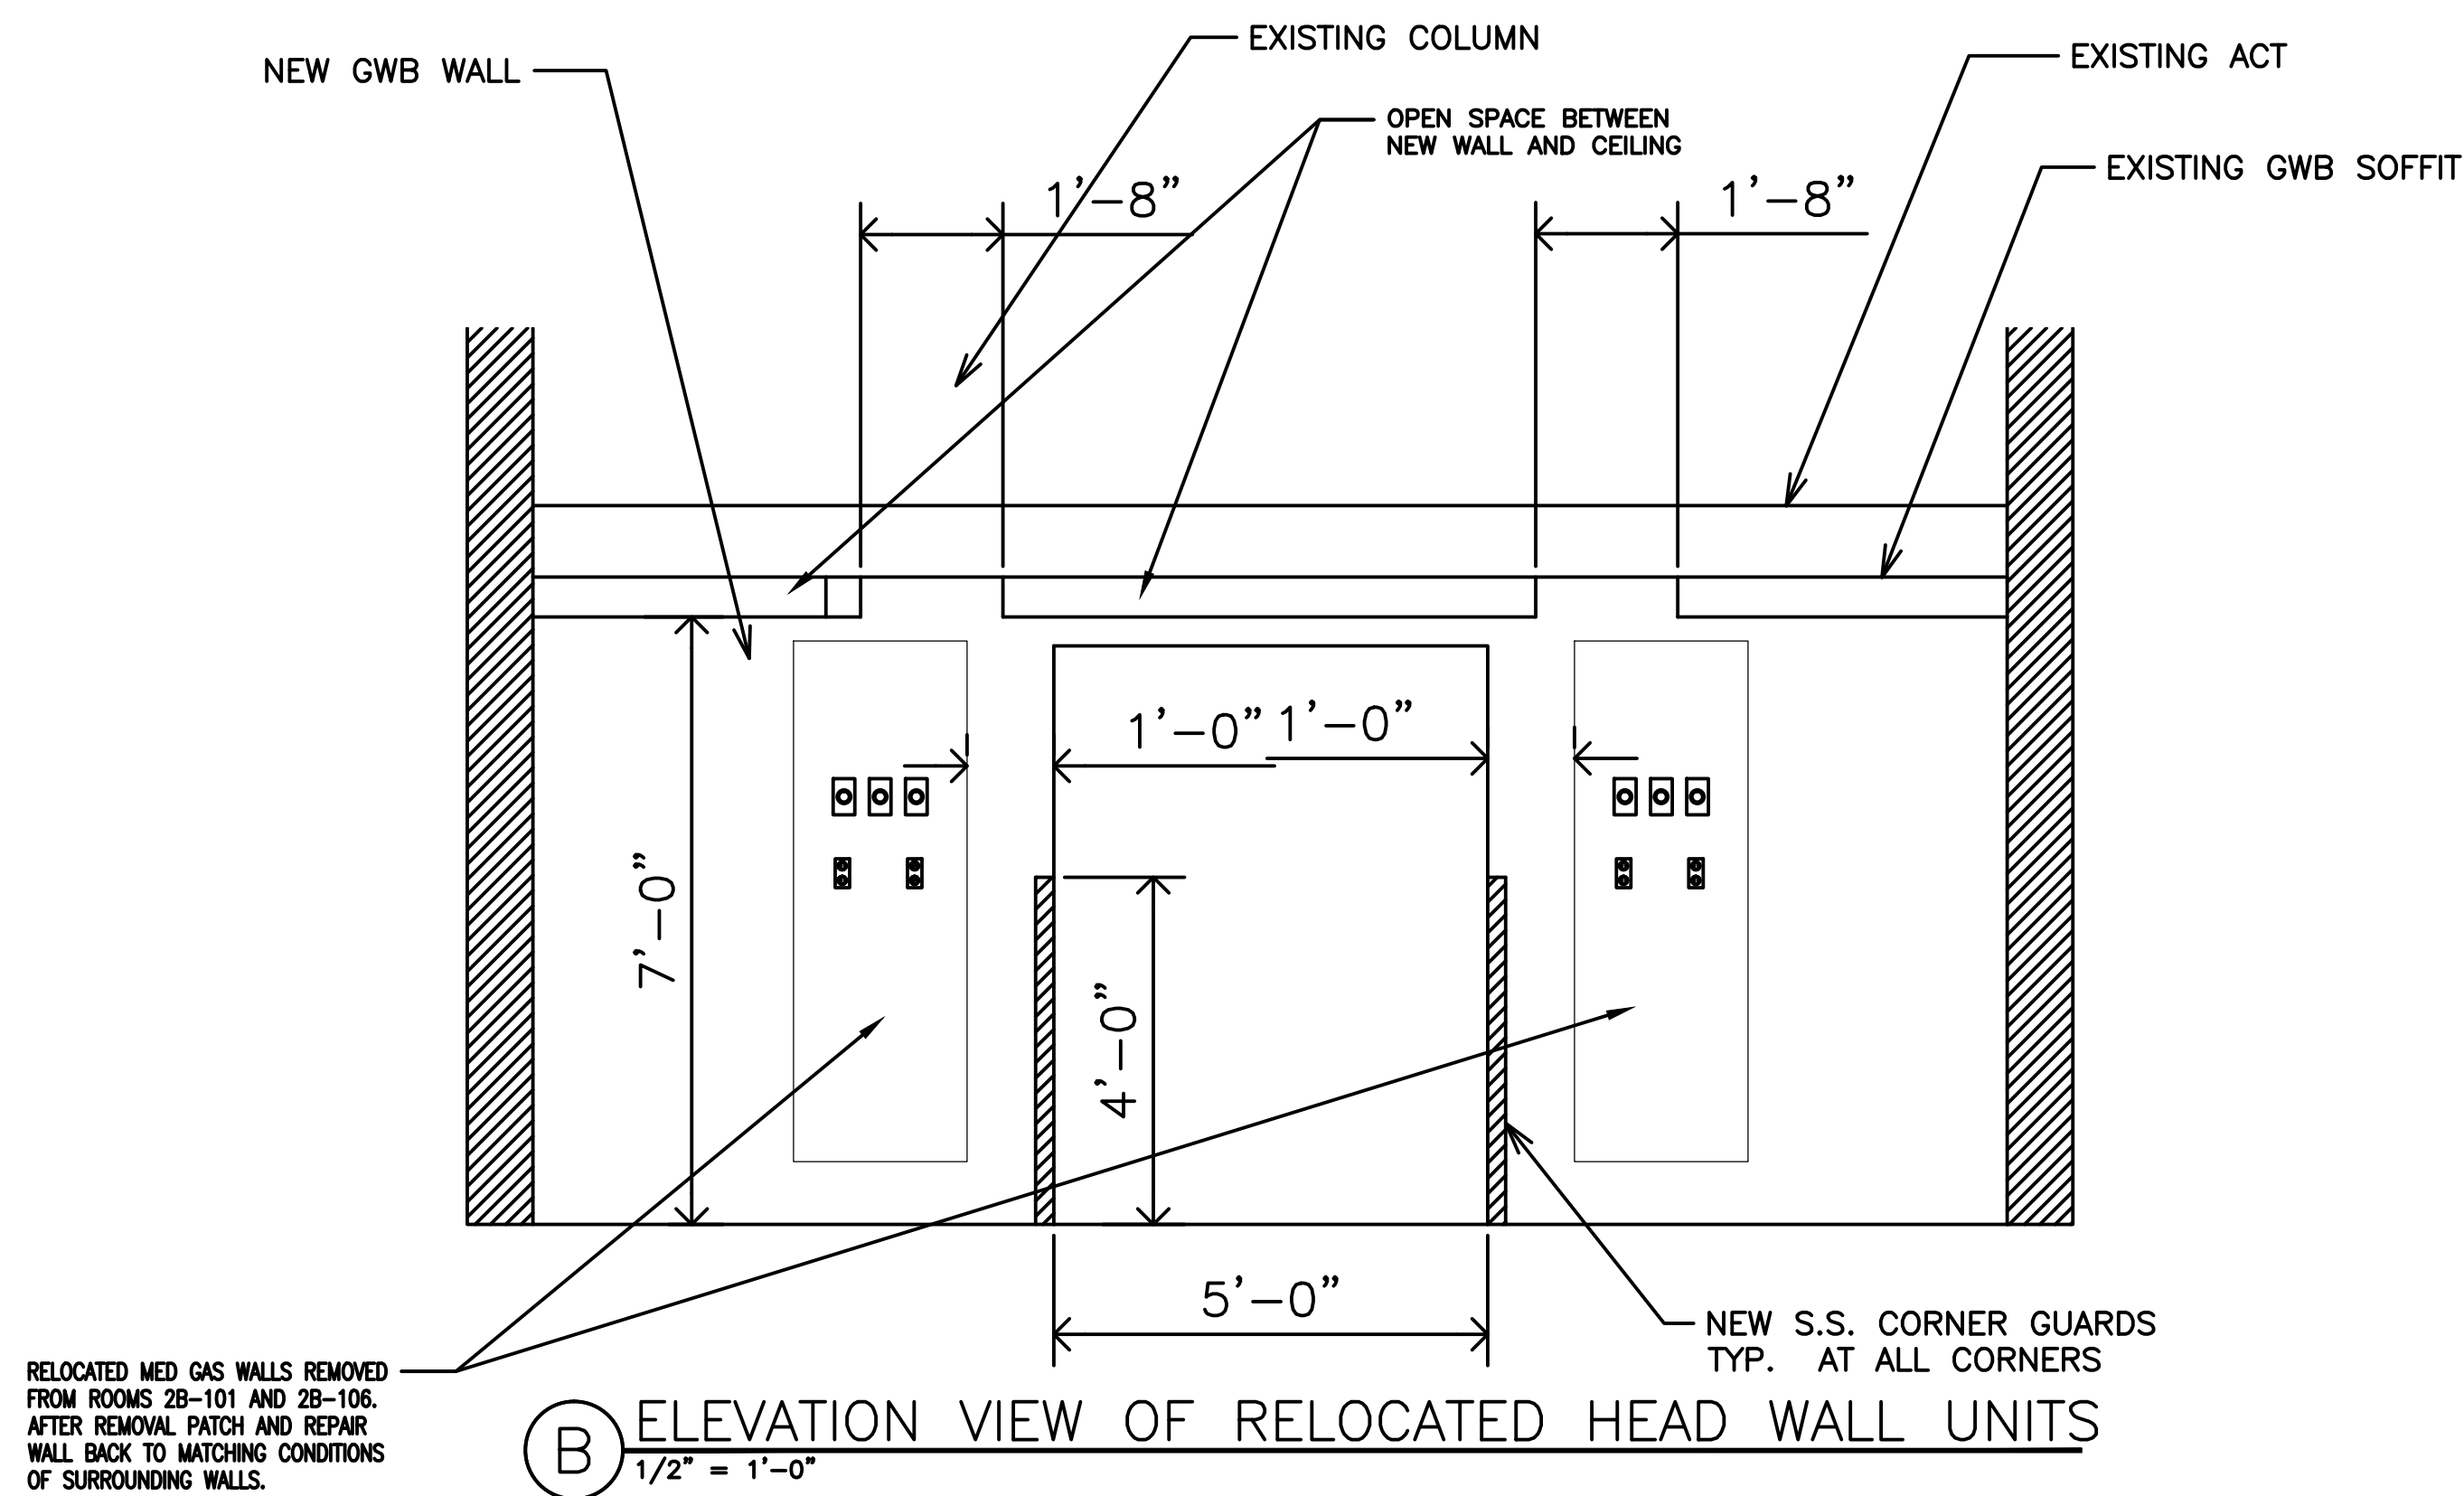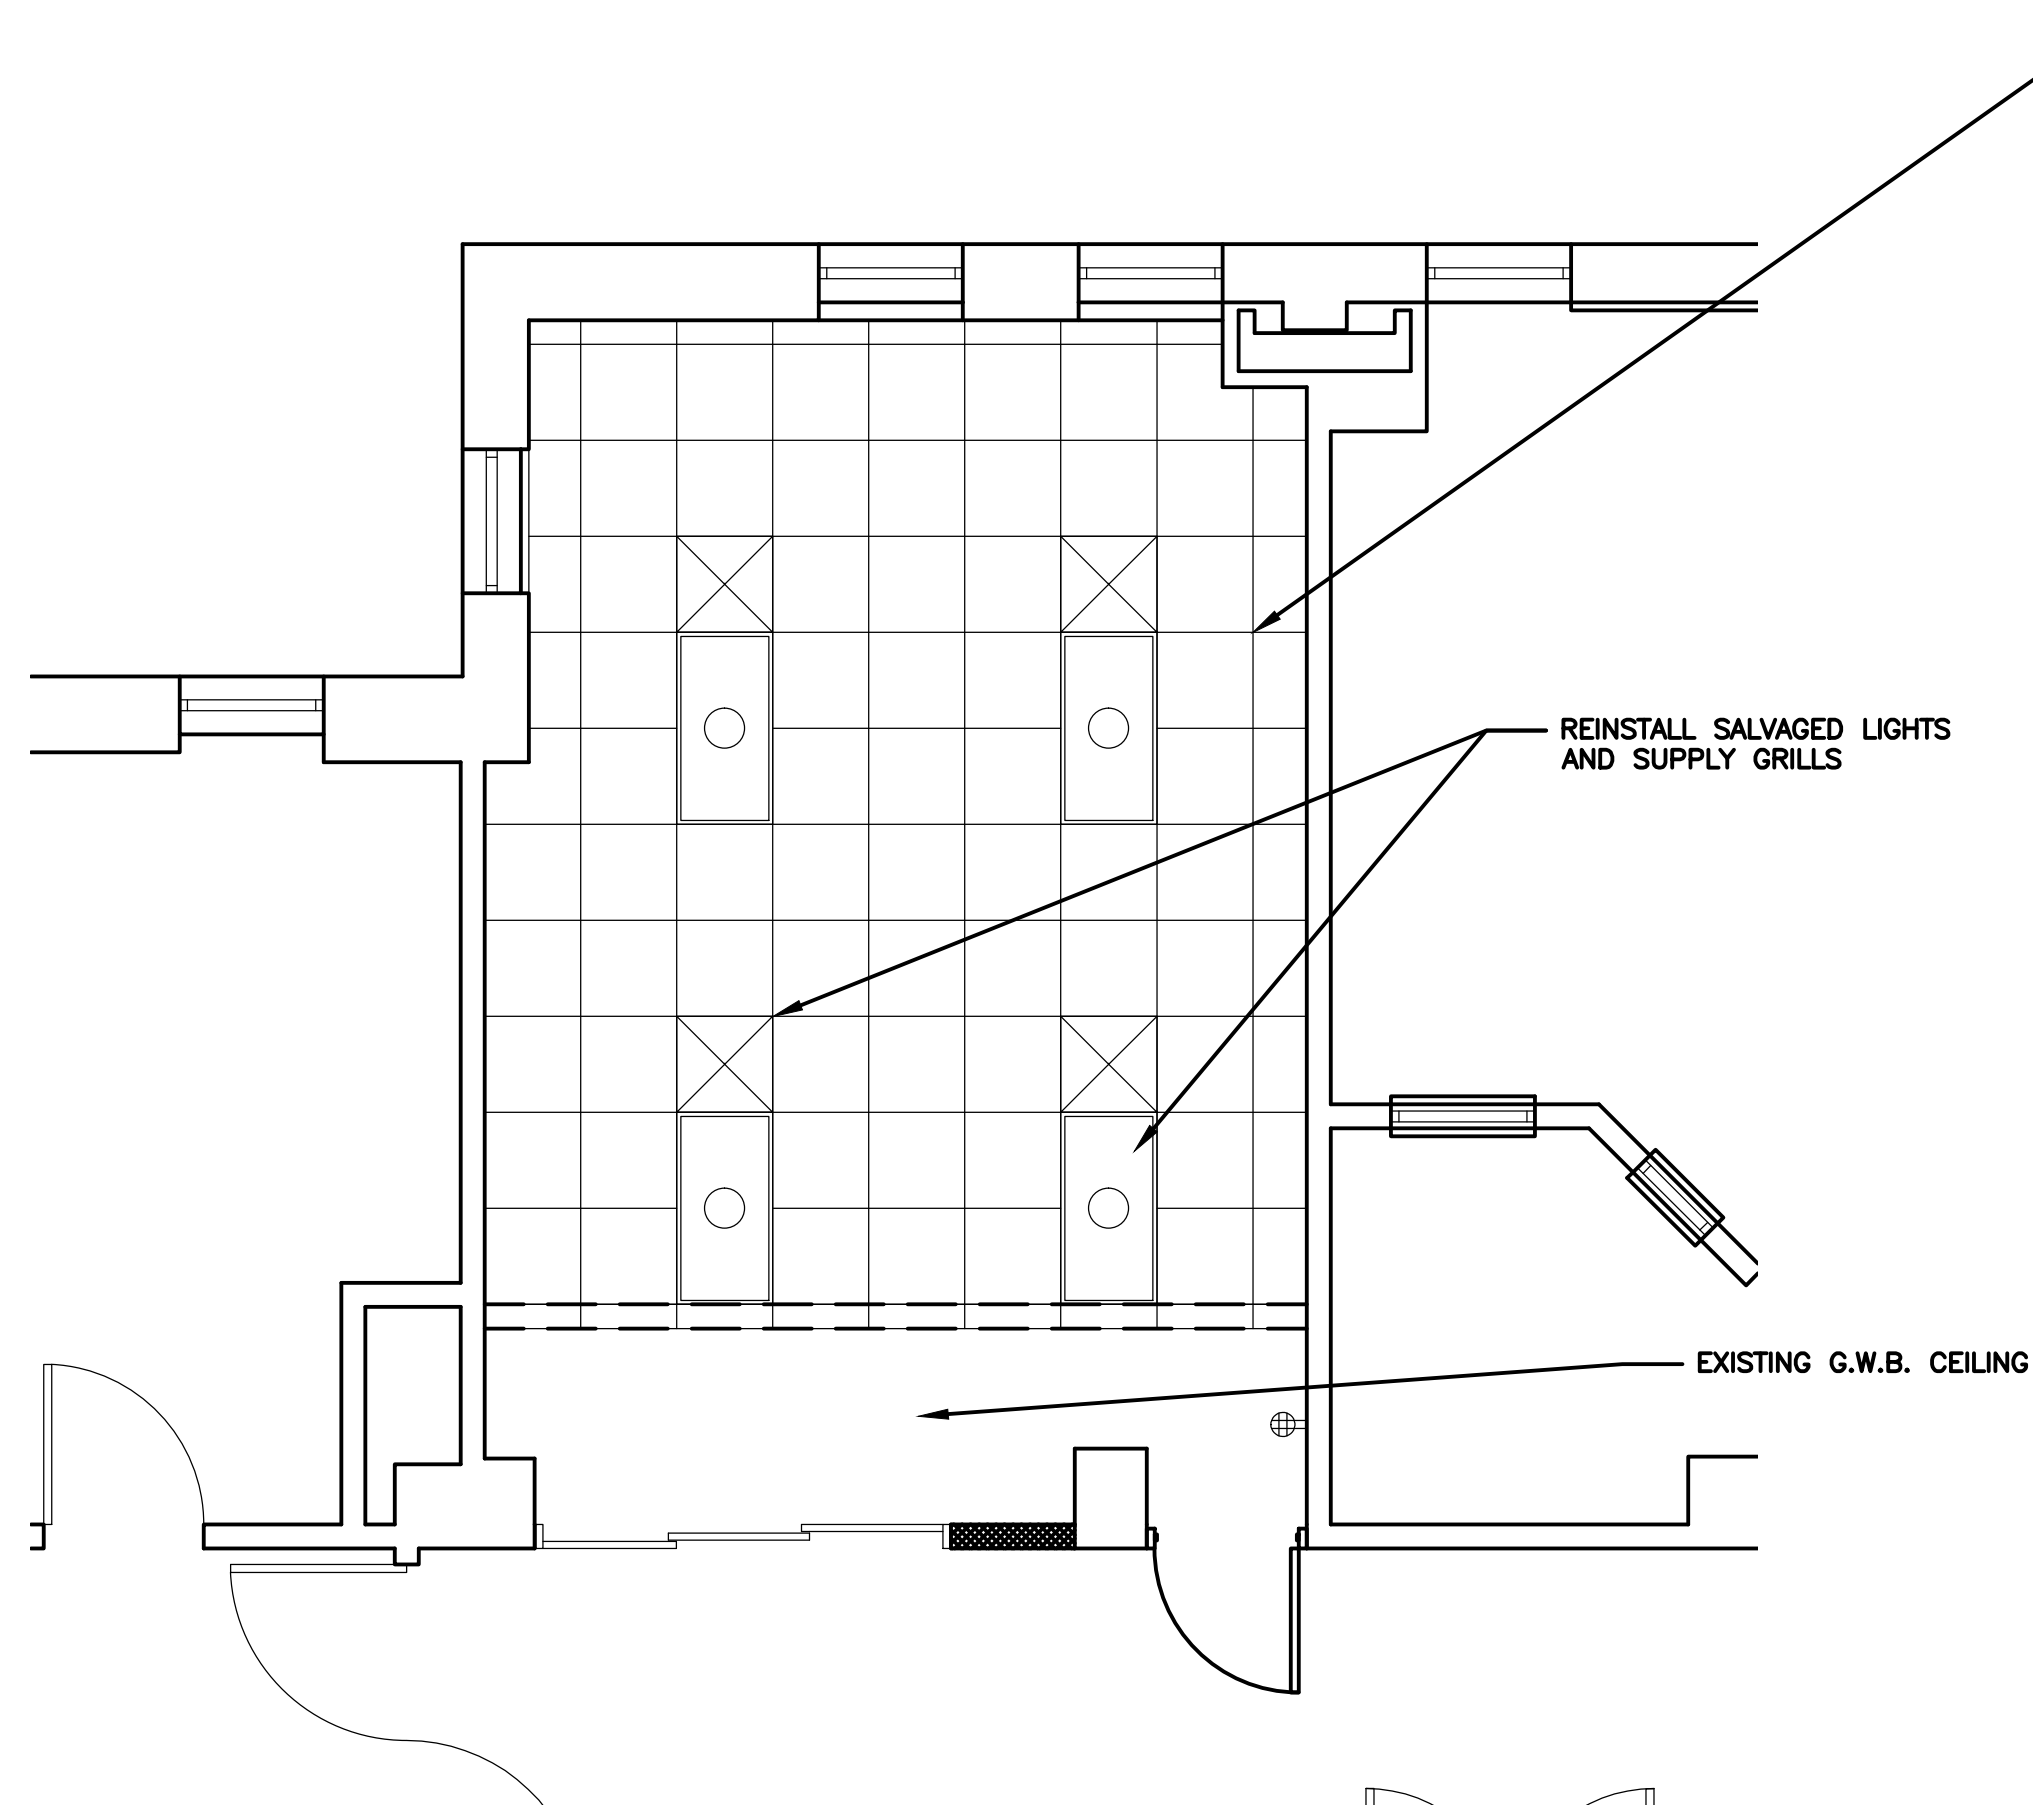

A ELEVATION VIEW OF RELOCATED HEAD WALL UNITS

1/2" = 1'-0"

1	REV'D DOOR TYPE AND INFORMATION	2/23/12
Revision		Date


RECOMMEND APPROVAL			
REQUESTER	Date	CHIEF OF STAFF	Date
CHIEF OF SERVICE	Date	ASSOC. DIR. for OPERATIONS	Date
ASSOC. DIR. PATIENT CARE SVC.	Date	ASSOC. DIR. for OPERATIONS	Date
APPROVAL BY:	Date		
MEDICAL CENTER DIRECTOR			

Drawing Title	PLANS, NOTES
Approved: Safety Manager/M&O Supervisor	
Approved:Chief of Facilities Management Svr.	


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BLDG. 21 Rm 2A-104	
Building Number	B21-2A
Checked	
Drawn	G.L.M.
Location	W.G.(BIII) Hefner Medical Center 1601 Brenner Ave. Salisbury NC 28144

Date	8-21-2011
Project No.	659-11-561
DRAWING NO.	1
DWG. 1 OF 2	


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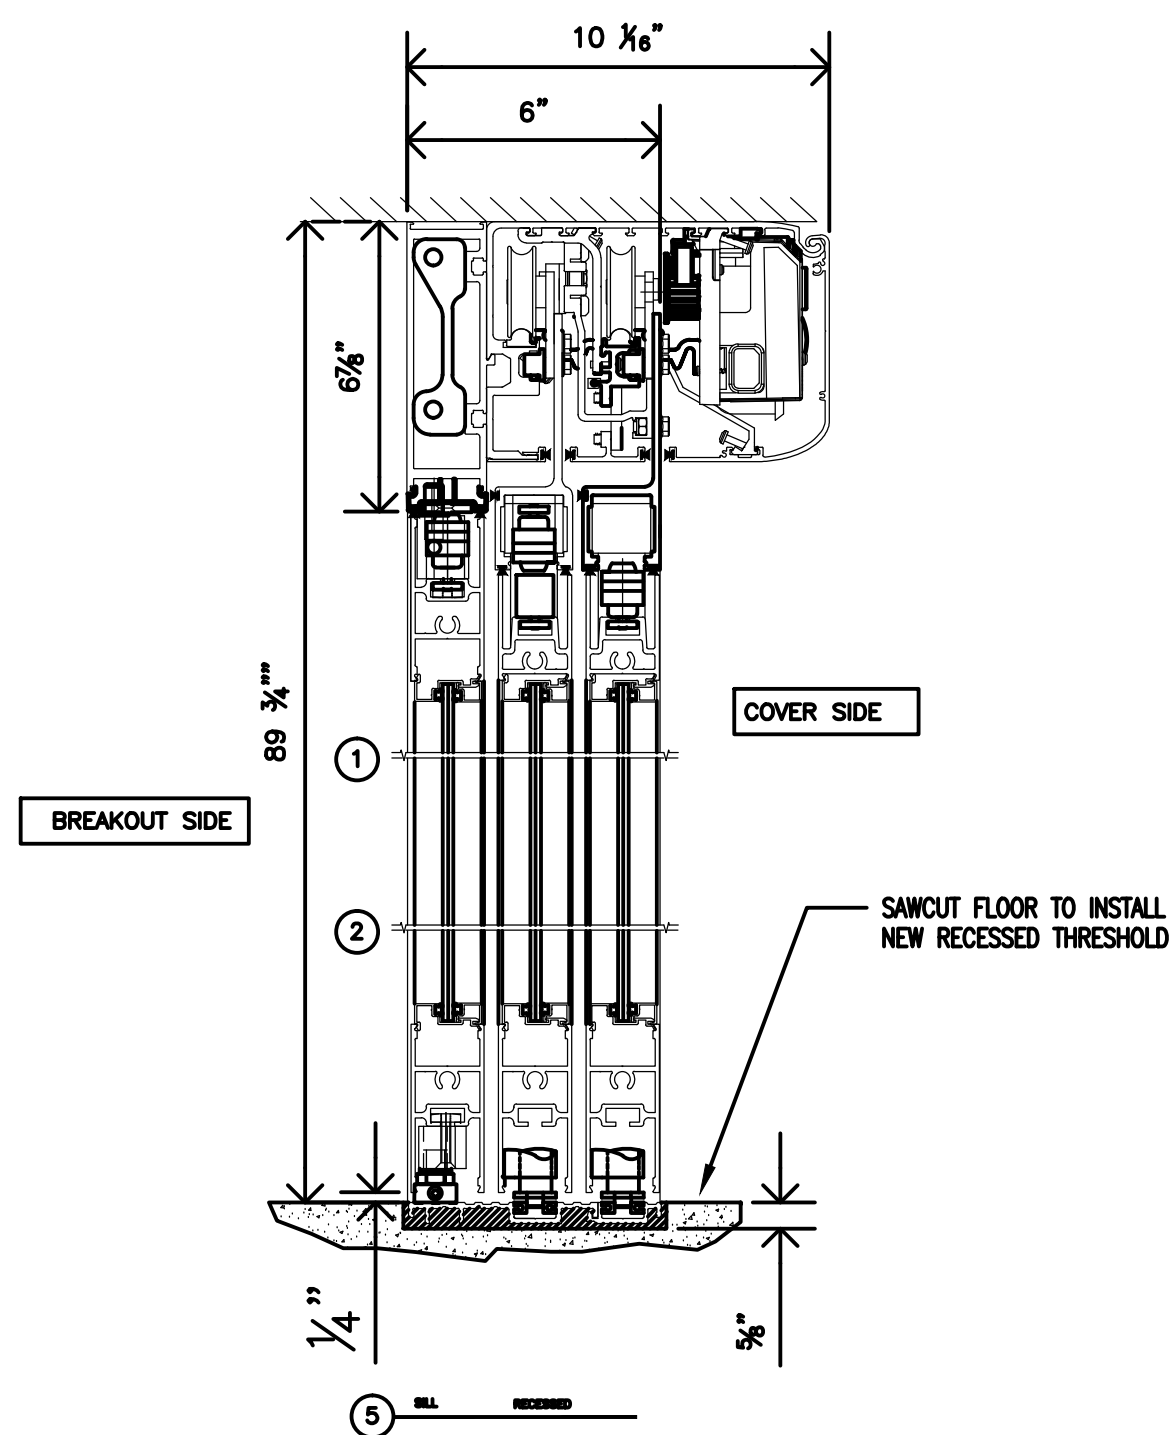
MEDICAL AIR, VACUUM AND OXYGEN LINES PLAN
1/4" = 1'-0"

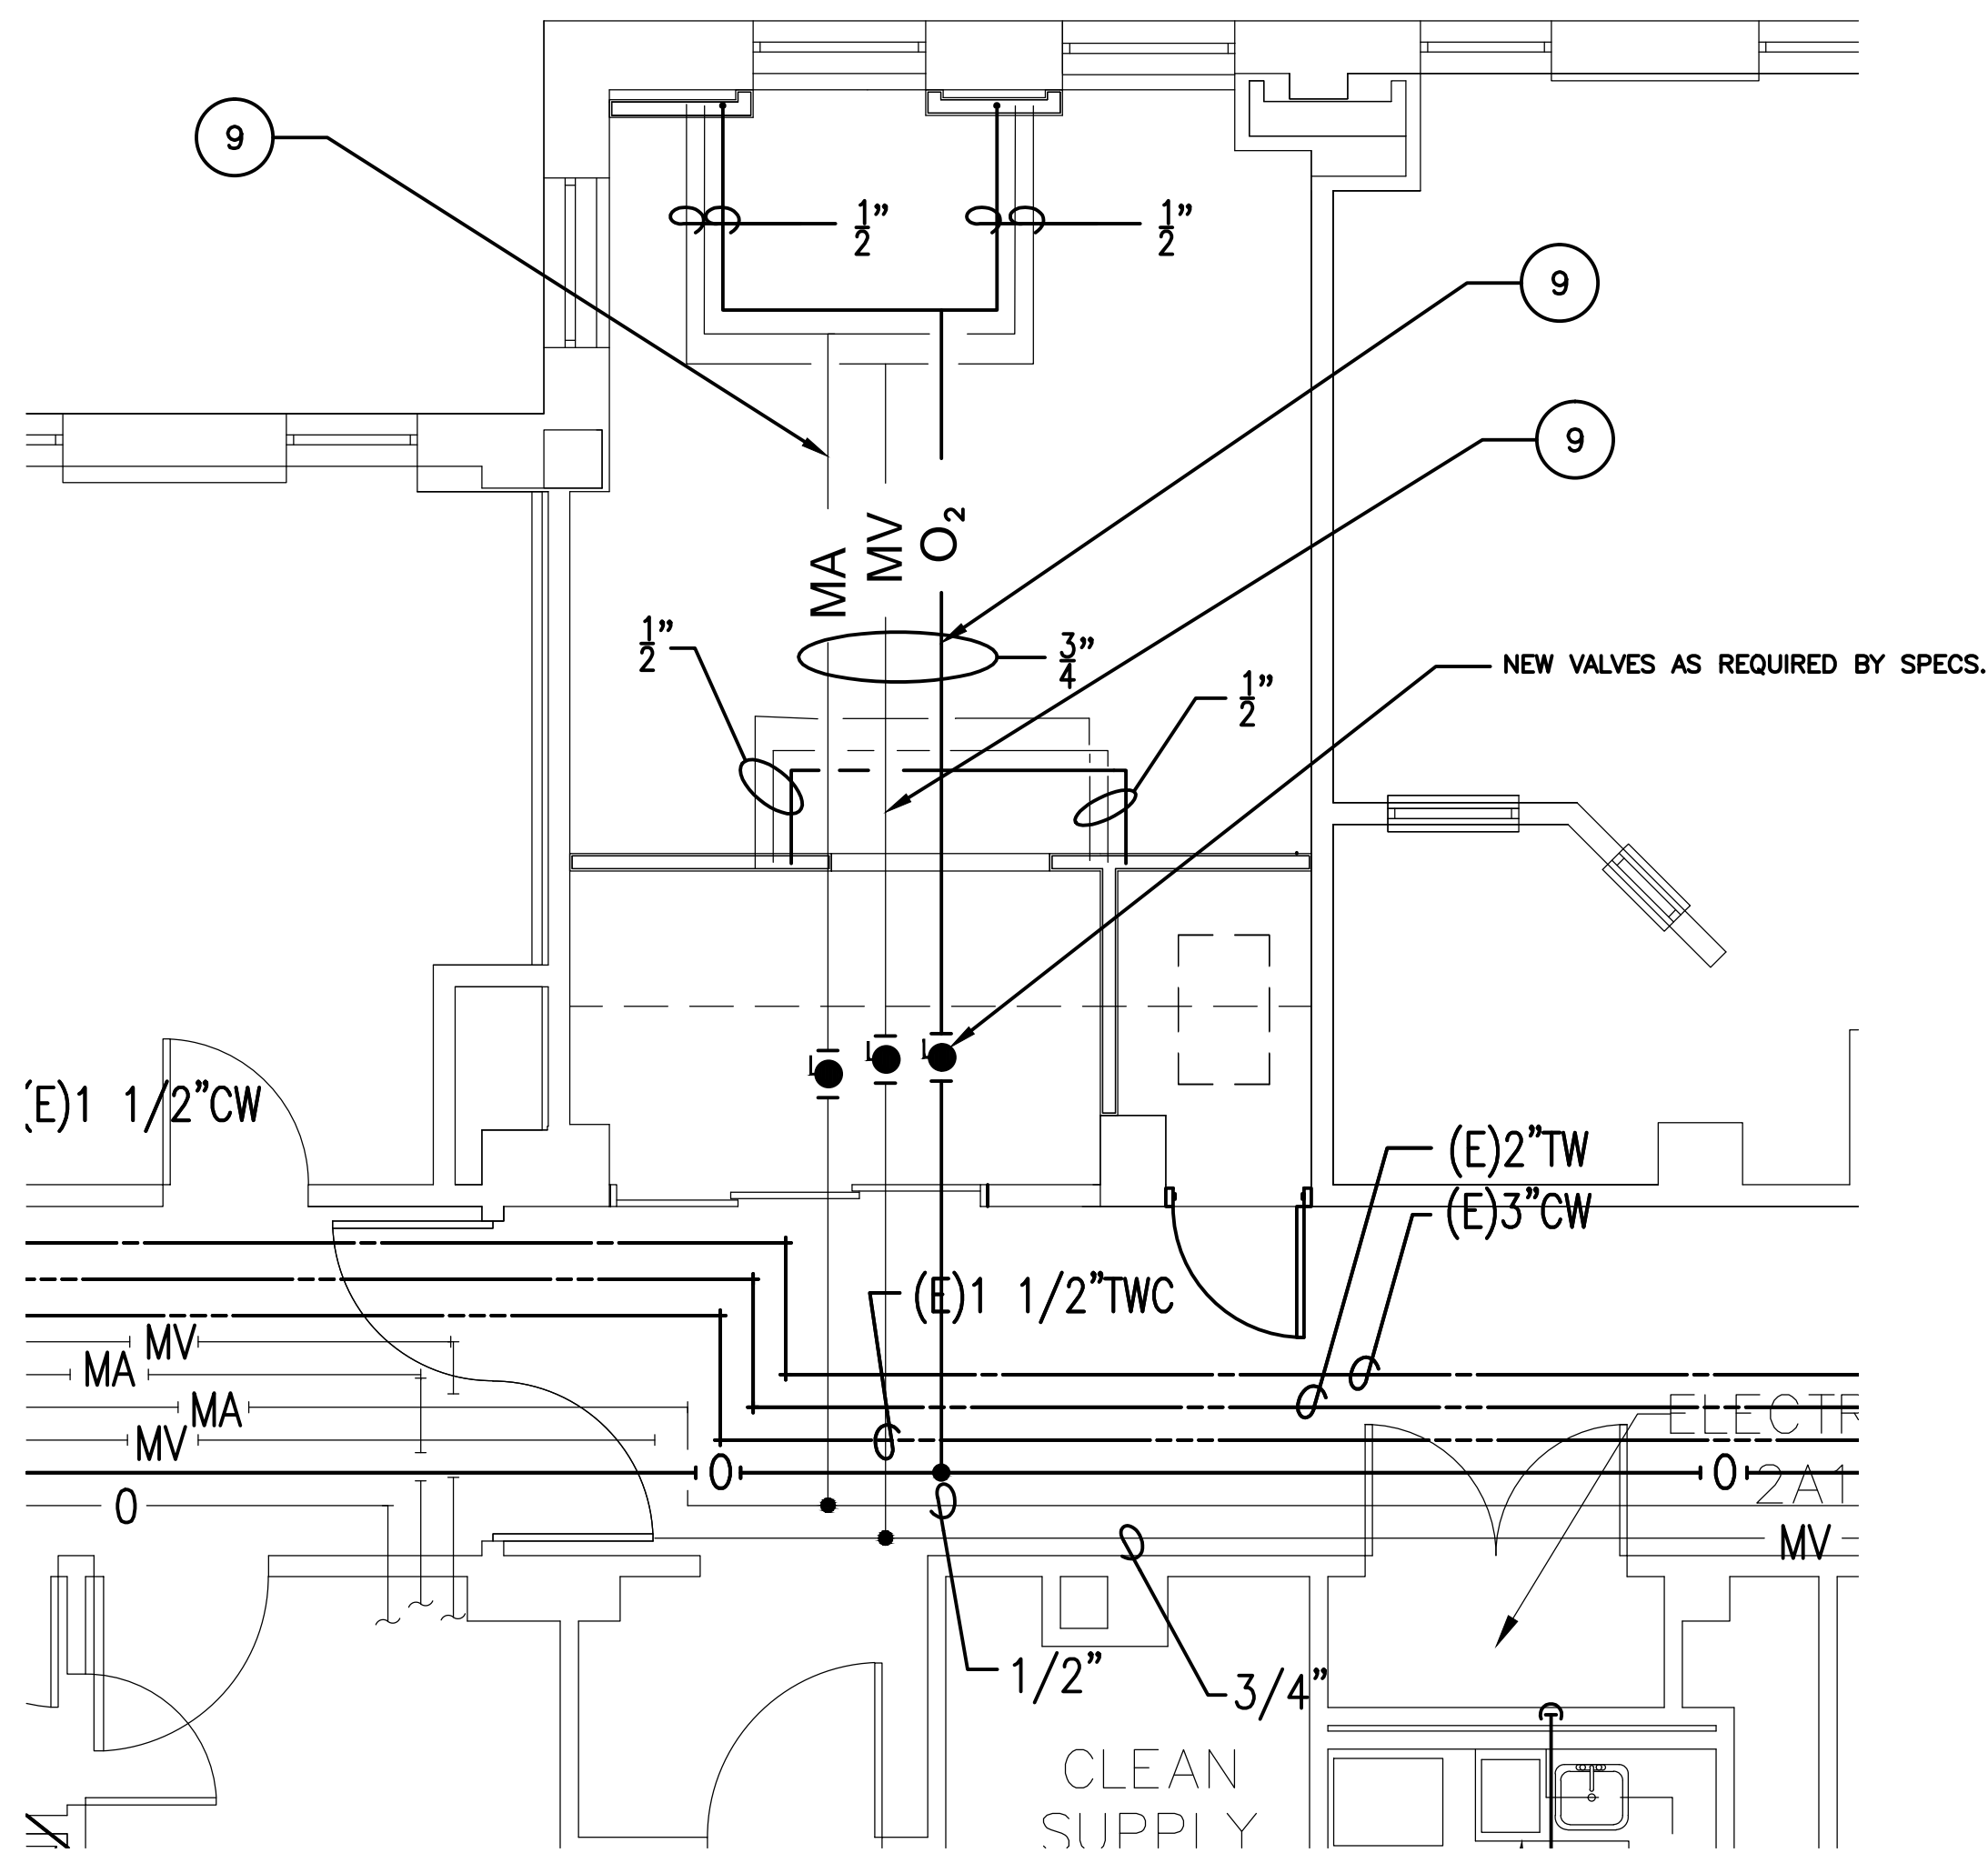


PLUMBING PLAN
1/4" = 1'-0"

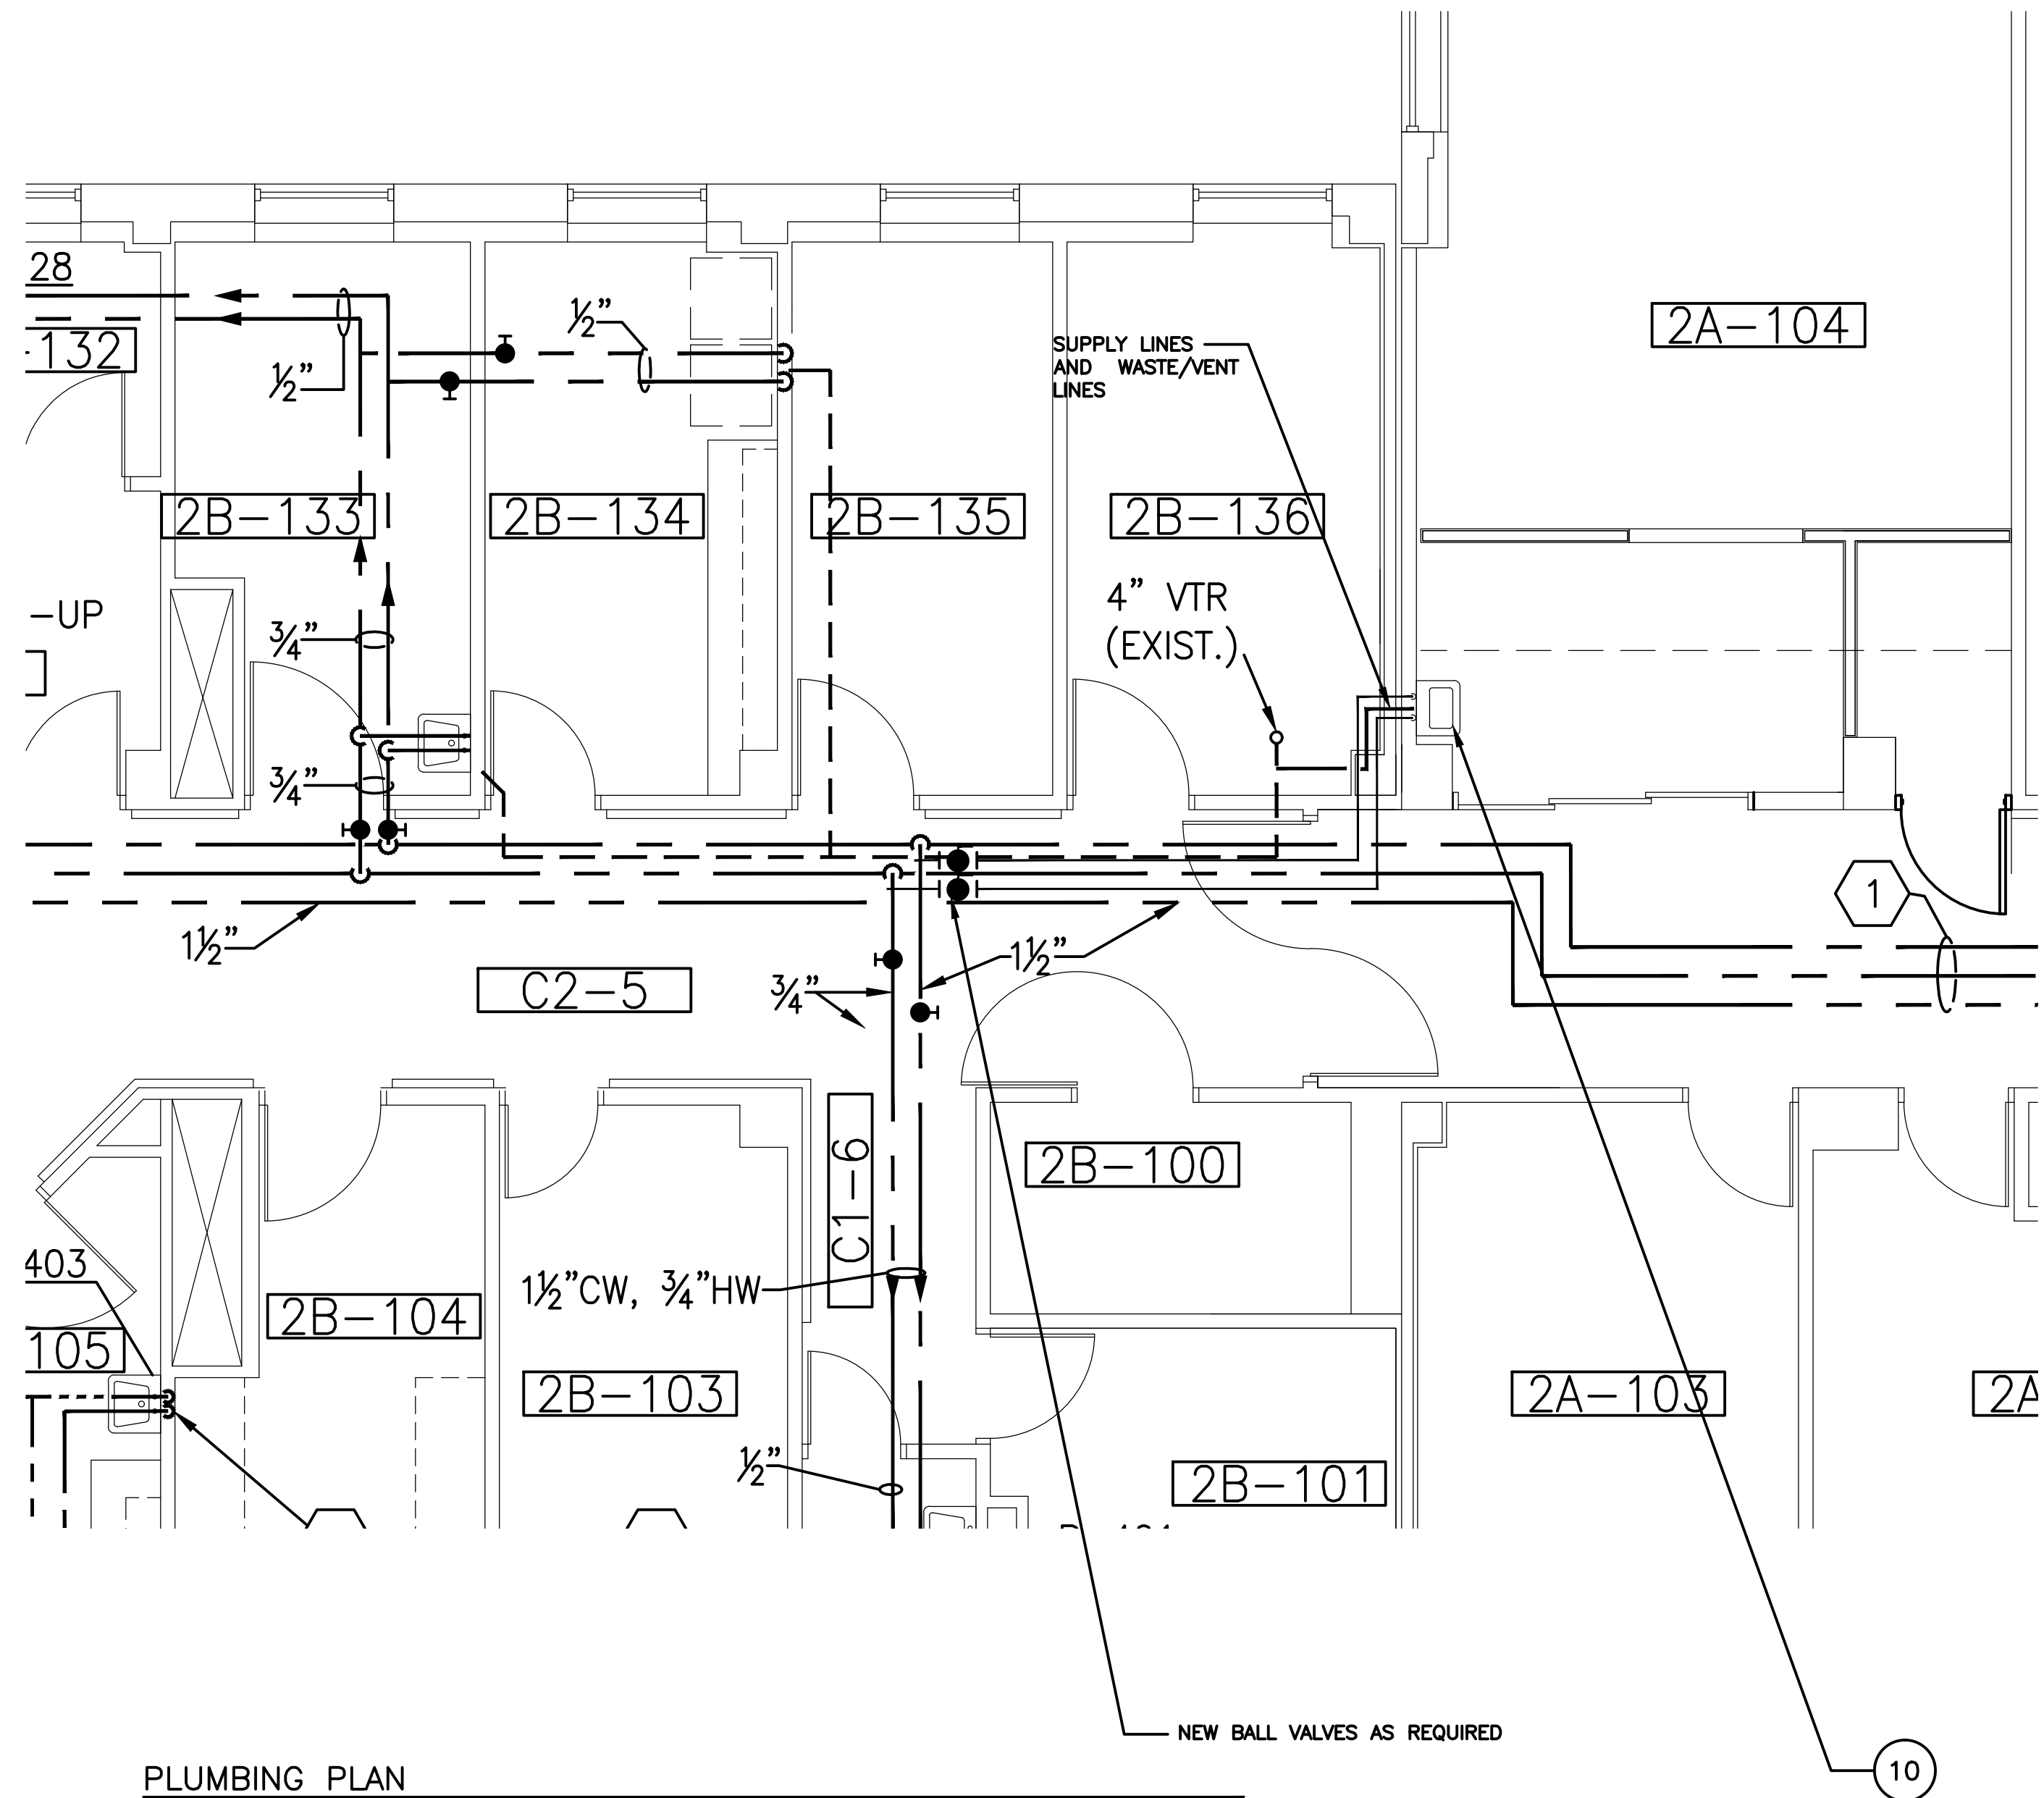


CORRIDOR DOOR
N.T.S.

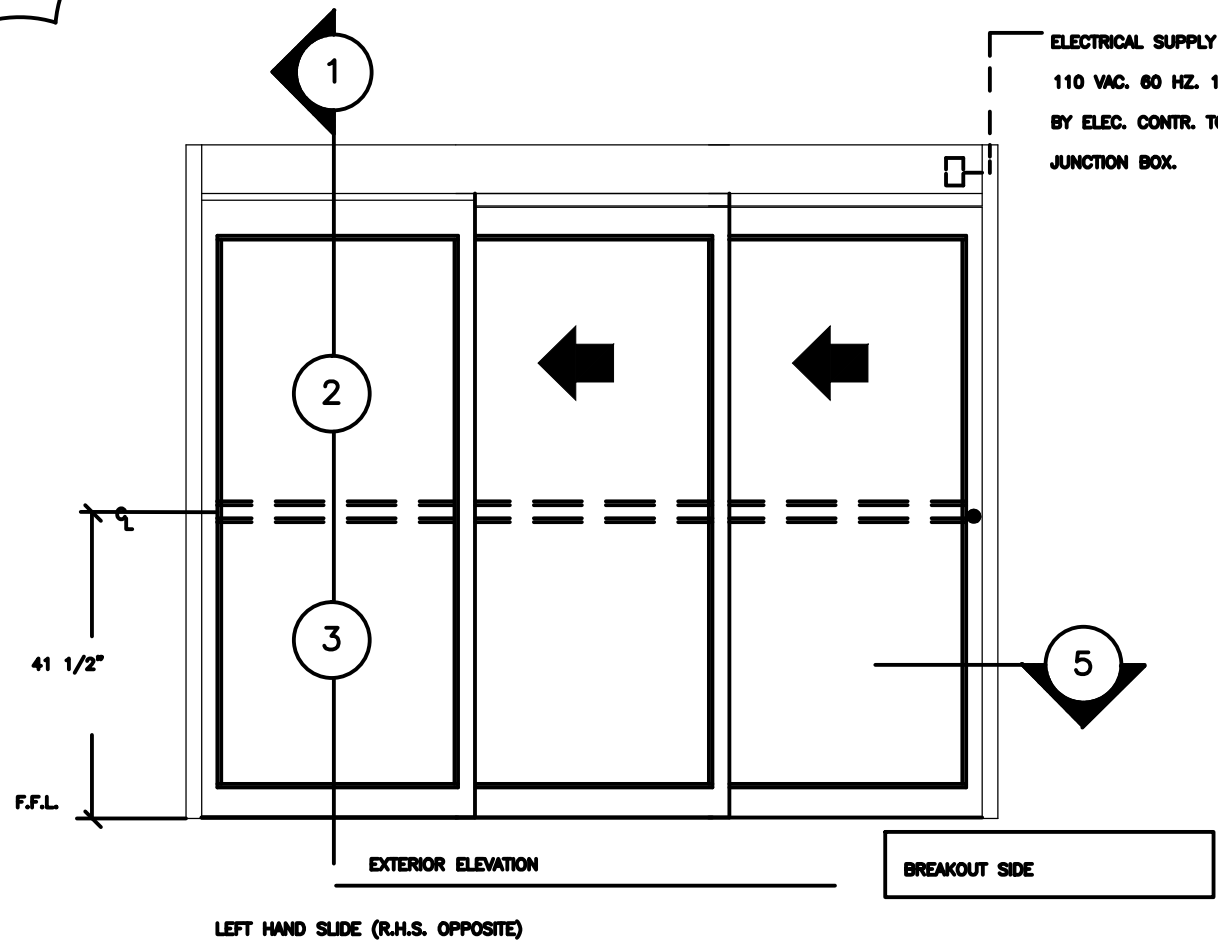

SECTION OF CORRIDOR DOOR
N.T.S.

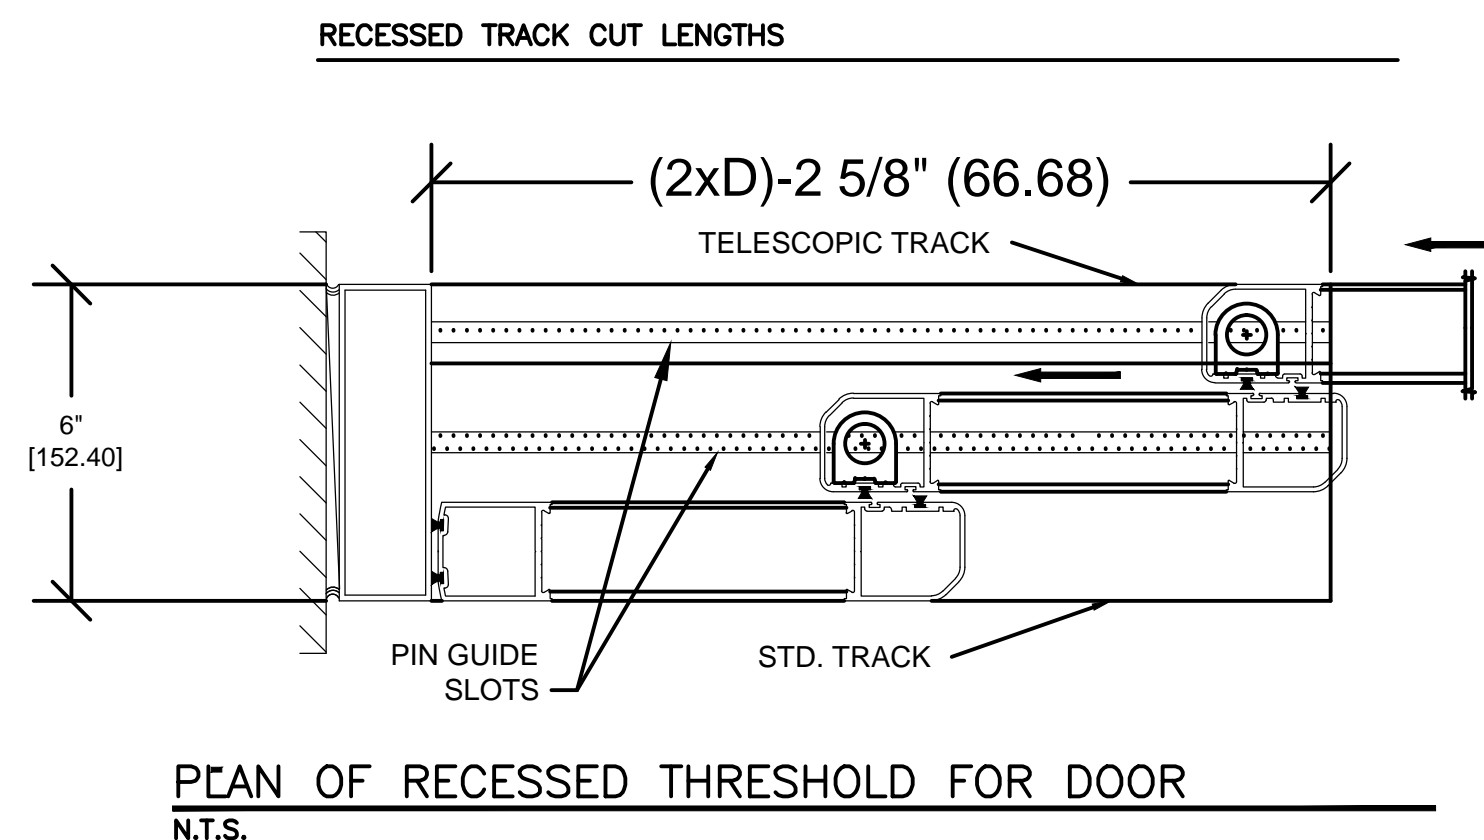

PLAN OF RECESSED THRESHOLD FOR DOOR
N.T.S.

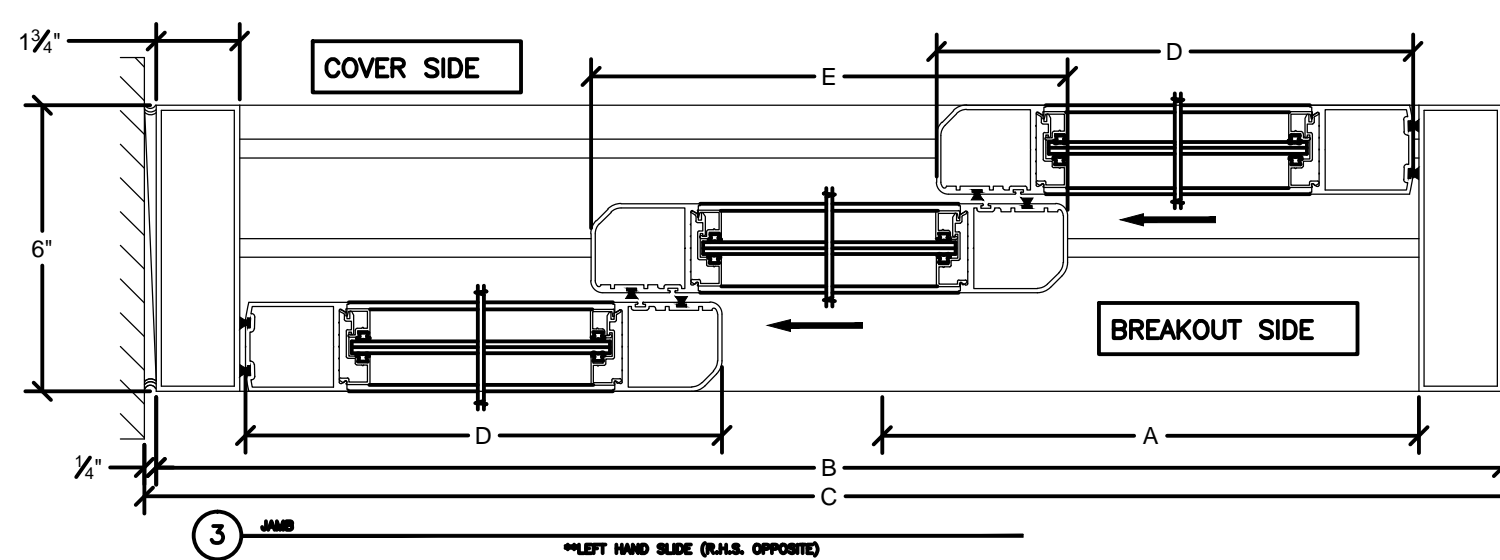

UNISLIDE OVERHEAD CONCEALED	DOOR OPENING A	OVERALL FRAME WIDTH B	MASONRY OPENING WIDTH C	ACTIVE & SIDELITE LEAF WIDTH D & E
8'	52 7/16"	96"	96 1/2"	32 9/16"

DESIGN INFORMATION ON BESAM DOOR OR EQUAL
N.T.S.

Revision	Date
1 REV'D DOOR TYPE AND INFORMATION	2/23/12

RECOMMEND APPROVAL			
REQUESTER	Date	CHIEF OF STAFF	Date
CHIEF OF SERVICE	Date	ASSOC. DIR. for OPERATIONS	Date
ASSOC. DIR. PATIENT CARE SVC.	Date	ASSOC. DIR. for OPERATIONS	Date
APPROVAL BY:	Date	Medical Center Director	Date

Drawing Title	PLANS, NOTES
Approved: Safety Manager/M&O Supervisor	
Approved: Chief of Facilities Management Svr.	

Project Title	GI RECOVERY ROOM BLDG. 21 RM 2A-104
Building Number	Bldg 21-2A
Checked	G.L.M.
Location	W.G.(Bill) Hefner Medical Center 1601 Brenner Ave. Salisbury NC 28144

Date	8-21-2011
Project No.	659-11-561
DRAWING NO.	2
DWG. 2 OF 2	

Department of
Veterans Affairs