



PANELBOARD KP3										SCHEDULE									
VOLTAGE: 208Y/120V		PHASE: 3		WIRE: 4		MAINS: 100A MCB				BUS SIZE: 100A		FAULT DUTY: 42KA MIN		MOUNTING: RECESSED					
SERVES		LOAD IN KVA		BRKR		LOAD IN KVA		BRKR		SERVES		LOAD IN KVA		BRKR		LOAD IN KVA		BRKR	
No.		LTG	RCPT	MTR	A/C	HTG	MISC	TRIP	P			MISC	HTG	A/C	MTR	RCPT	LTG		No.
1	EXHAUST HOOD EF-1/SF-1							20	1			1	20						2
3	SPARE							20	1			1	20						4
5	SPARE							20	1			1	20						6
7	EXHAUST HOOD LTG.							20	1			1	20						8
9	RANGE						8.7	50	2			2	20						10
11												1	20						12
13	DUCT HEATER HC-1											2	50						14
15																			16
17																			18
19	SPARE							20	1			1	20						20
21	SPARE							20	1			1	20						22
23	SPARE							20	1			1	20						24
25	SPARE							20	1			1	20						26
27	SPARE							20	1			1	20						28
29	SPARE							20	1			1	20						30
TOTALS										17.5		7.5		0.0		1.2		0.0	
												CONNECTED KVA						26.2	

LIGHTING FIXTURE SCHEDULE												
TYPE	DESCRIPTION	MOUNTING	LAMP			RATINGS			MANUFACTURE	CATALOG NO.	REMARKS	
			#	TYPE	WATT	V	A	W				
B	1X4 WRAP AROUND	SURFACE	2	T5	28	120	0.2	56	LITHONIA OR EQUAL	AW-228T5-AR-MVOLT GEB10IS	-	
C	2X4 TROFFER	RECESSED	2	T8	32	120	0.6	64	LITHONIA OR EQUAL	2SP8C232T8-RW-A12125 MVOLT-GEB10IS	-	
D	PENDANT DECORATIVE	PENDANT	1	TTT	13	120	0.2	13	LITHONIA OR EQUAL	11998-GW	DIMMING BALLAST	
E	DECORATIVE	SURFACE	2	T5C	22 40	120	0.5	62	SHAPER OR EQUAL	293-22-T5C/2/22/40/-120V-PB-FB	DIMMING BALLAST	
F	UNDER CABINET	WALL MOUNT	1	T8	25	120	0.2	25	LITHONIA OR EQUAL	2UC-17T8-MVOLT-GEB10IS	-	

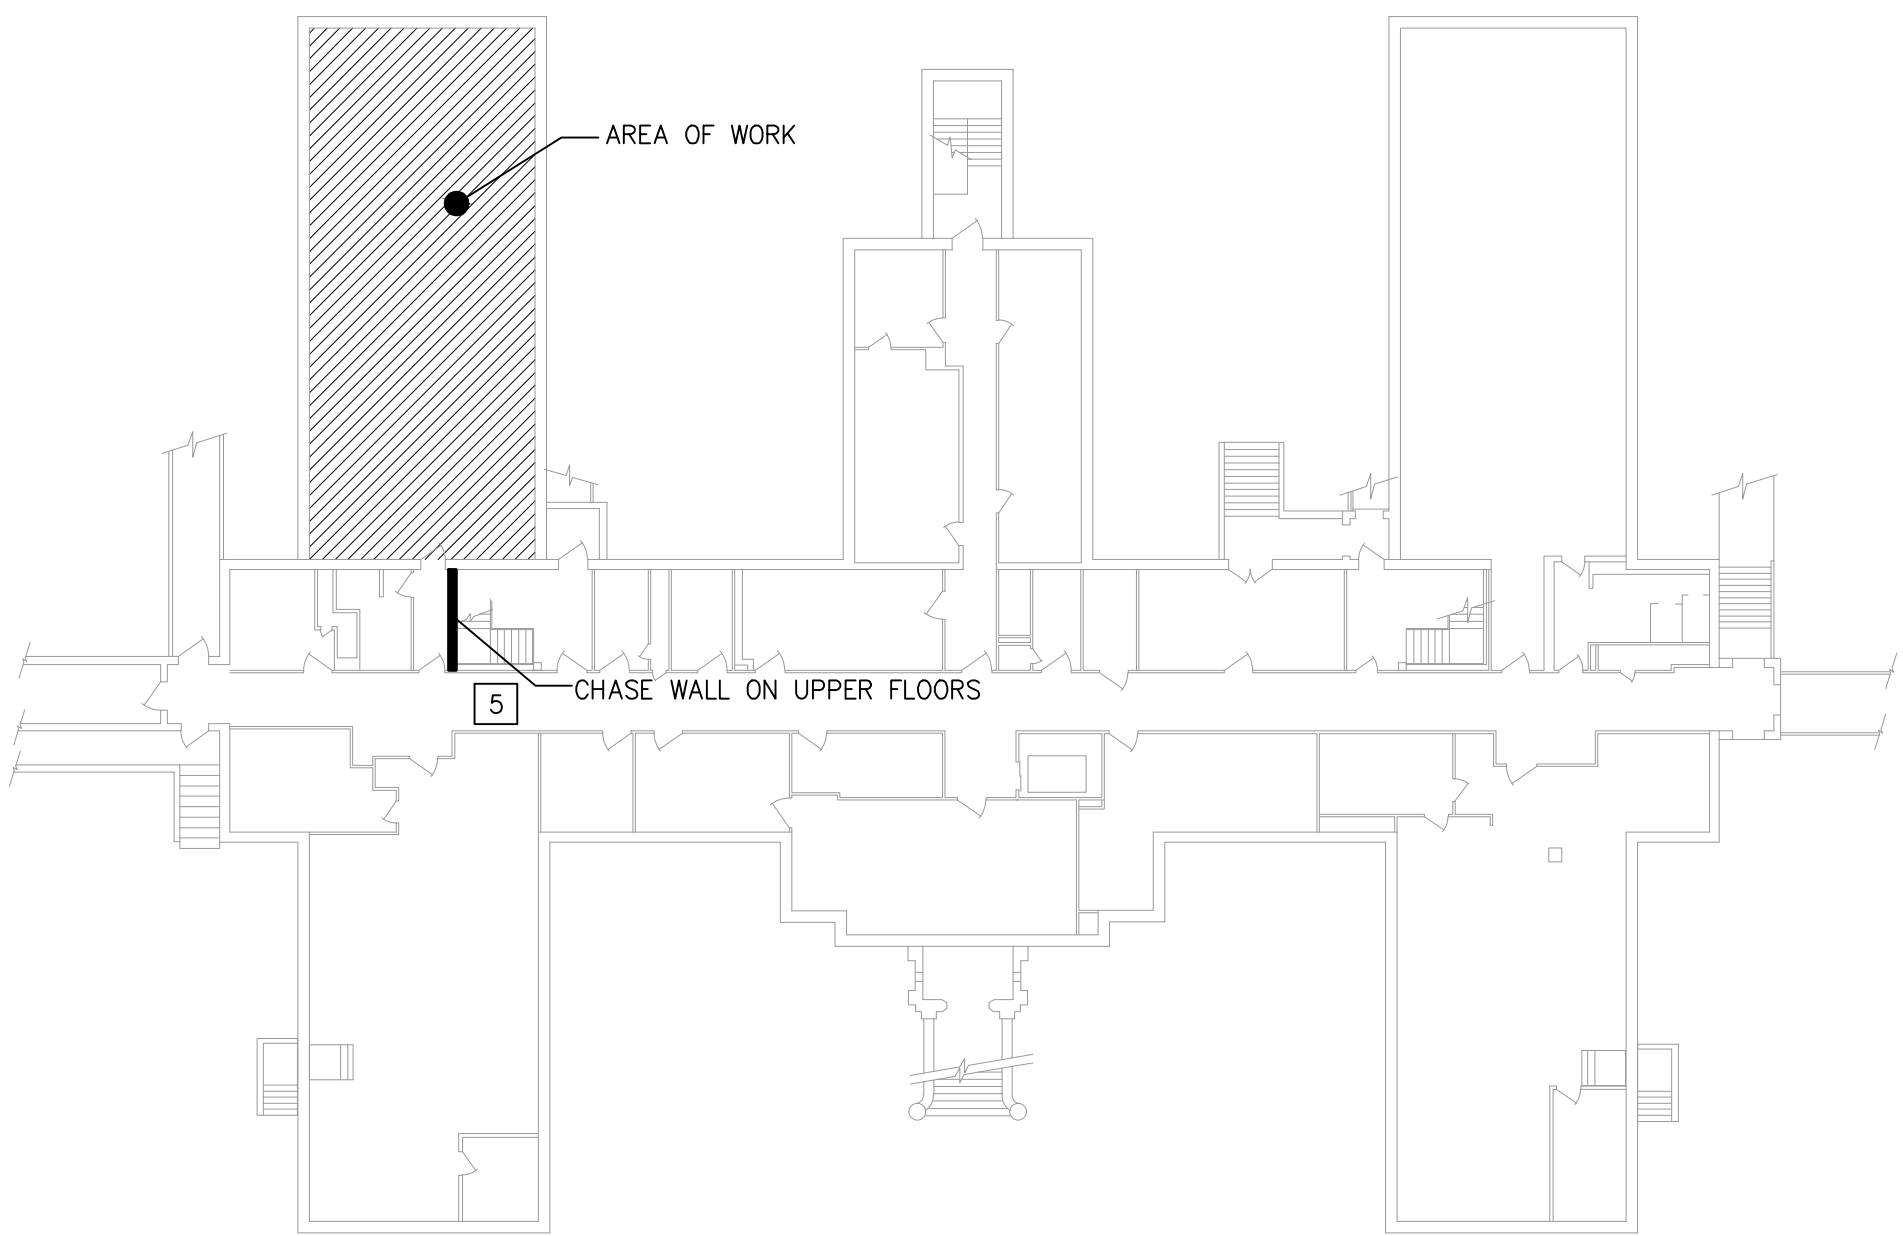


KEY PLAN  
SCALE: NTS

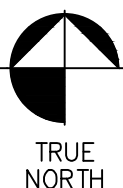


- SHEET NOTES:
- A. SELECTIVE DEMOLITION INCLUDES, BUT IS NOT LIMITED TO, REMOVAL AND DISPOSAL OF EQUIPMENT AND SYSTEMS MADE OBSOLETE AND/OR REPLACED BY NEW WORK AND FOR EXISTING EQUIPMENT AND SYSTEMS WHICH ARE TO REMAIN.
- B. THE DEMOLITION WORK INDICATED ON THE DRAWINGS IS INTENDED TO ASSIST THE CONTRACTOR AND GIVE GENERAL INFORMATION. PRIOR TO SUBMITTING BID, THE CONTRACTOR SHALL VISIT THE PROJECT SITE, REVIEW ORIGINAL DRAWINGS IF AVAILABLE. CONTRACTOR IS RESPONSIBLE TO DETERMINE THE FULL EXTENT OF SELECTIVE DEMOLITION, AND INCLUDE ALL REQUIRED SELECTIVE DEMOLITION WORK IN THE BID, WHETHER OR NOT SPECIFICALLY SHOWN ON DRAWINGS. NO ADDITIONAL COSTS WILL BE GRANTED FOR SELECTIVE DEMOLITION. LEGALLY DISPOSE OF ALL ITEMS AND MATERIALS, EXCEPT ANY ITEMS SPECIFICALLY DESIGNATED BY THE OWNER TO BE SALVAGED. REMOVE AND PLACE THE DESIGNATED SALVAGED EQUIPMENT IN A LOCATION DIRECTED BY THE OWNER.
- C. REFER TO GENERAL CONSTRUCTION TRADE DRAWINGS FOR EXTENT OF AREA TO BE DEMOLISHED.

- KEYED NOTES:
1. JUNCTION BOX FOR EXHAUST HOOD. (1)1ø/120V) TYP DISC, FA CONNECTION
2. (4) #3 THHN CU, (1) #8 THHN CU GND, (1) 1 1/2" CONDUIT
3. REMOVE EXISTING LIGHTING, SAVE CIRCUITS FOR RE-USE
4. REMOVE RECEPTACLES, REMOVE FEED BACK TO SOURCE
5. EXISTING 225A PANEL. UTILIZE EXISTING 100A 3P BREAKER @ 18,20,22 TO FEED NEW PANEL. PANELS E & F CURRENTLY FED FROM THIS PANEL. TO BE RE-FED. (PANEL E LOCATED ON GROUND FLOOR, PANEL F LOCATED ON FIRST FLOOR). PROVIDE NEW BREAKERS IN PANEL BOP LOCATED ON SECOND FLOOR. PROVIDE NEW FEED TO PANELS E & F FROM BOP. ALL PANELS ARE "STACKED" DIRECTLY ABOVE THIS LOCATION.
6. RECEPTACLE TO BE PROVIDED WITH CONTACTOR. INTERLOCK WITH ANSUL AND EXHAUST FAN CONTROL TO DISCONNECT POWER UPON ACTIVATION OF ANSUL SYSTEM.


1 LOWER FLOOR DEMOLITION ELECTRICAL FLOOR PLAN  
SCALE: 1/4" = 1'-0"

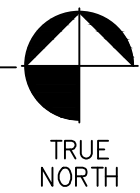

2 LOWER FLOOR ELECTRICAL FLOOR PLAN  
SCALE: 1/4" = 1'-0"

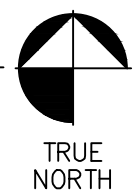

3 LOWER FLOOR LIGHTING FLOOR PLAN  
SCALE: 1/4" = 1'-0"

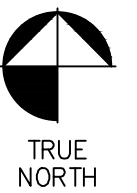

CONSULTANTS:		ARCHITECT/ENGINEERS:		Drawing Title		Project Title		Project Number		Office of Construction and Facilities Management Department of Veterans Affairs			
 <b>AJH DESIGN</b> 216 OAKWOOD AVENUE ELMIRA HEIGHTS, NEW YORK 14903 PH: (607) 737-4638 FAX: (607) 737-1277 AJH 11-058		 <b>Larson Design Group</b> Larson Design Group • Architects • Engineers • Surveyors 1000 Commerce Park Drive • Suite 201 Williamsport, PA 17701 PHONE 570.323.6603 TOLL FREE 877.323.6603 FAX 570.323.9902 • www.larsondesigngroup.com		ELECTRICAL PLANS		KITCHEN RENOVATIONS		6944-001					
				Approved Project Director CHRISTOPHER HALL		Location BUILDING #9 ROOM 5C		Building Number #9					
Revisions ISSUED FOR CONSTRUCTION		2/24/2012		Date		Checked		Drawn		9-ES 1			
2-24-2012		RDH		BDC		Dep. 1 of 1							