

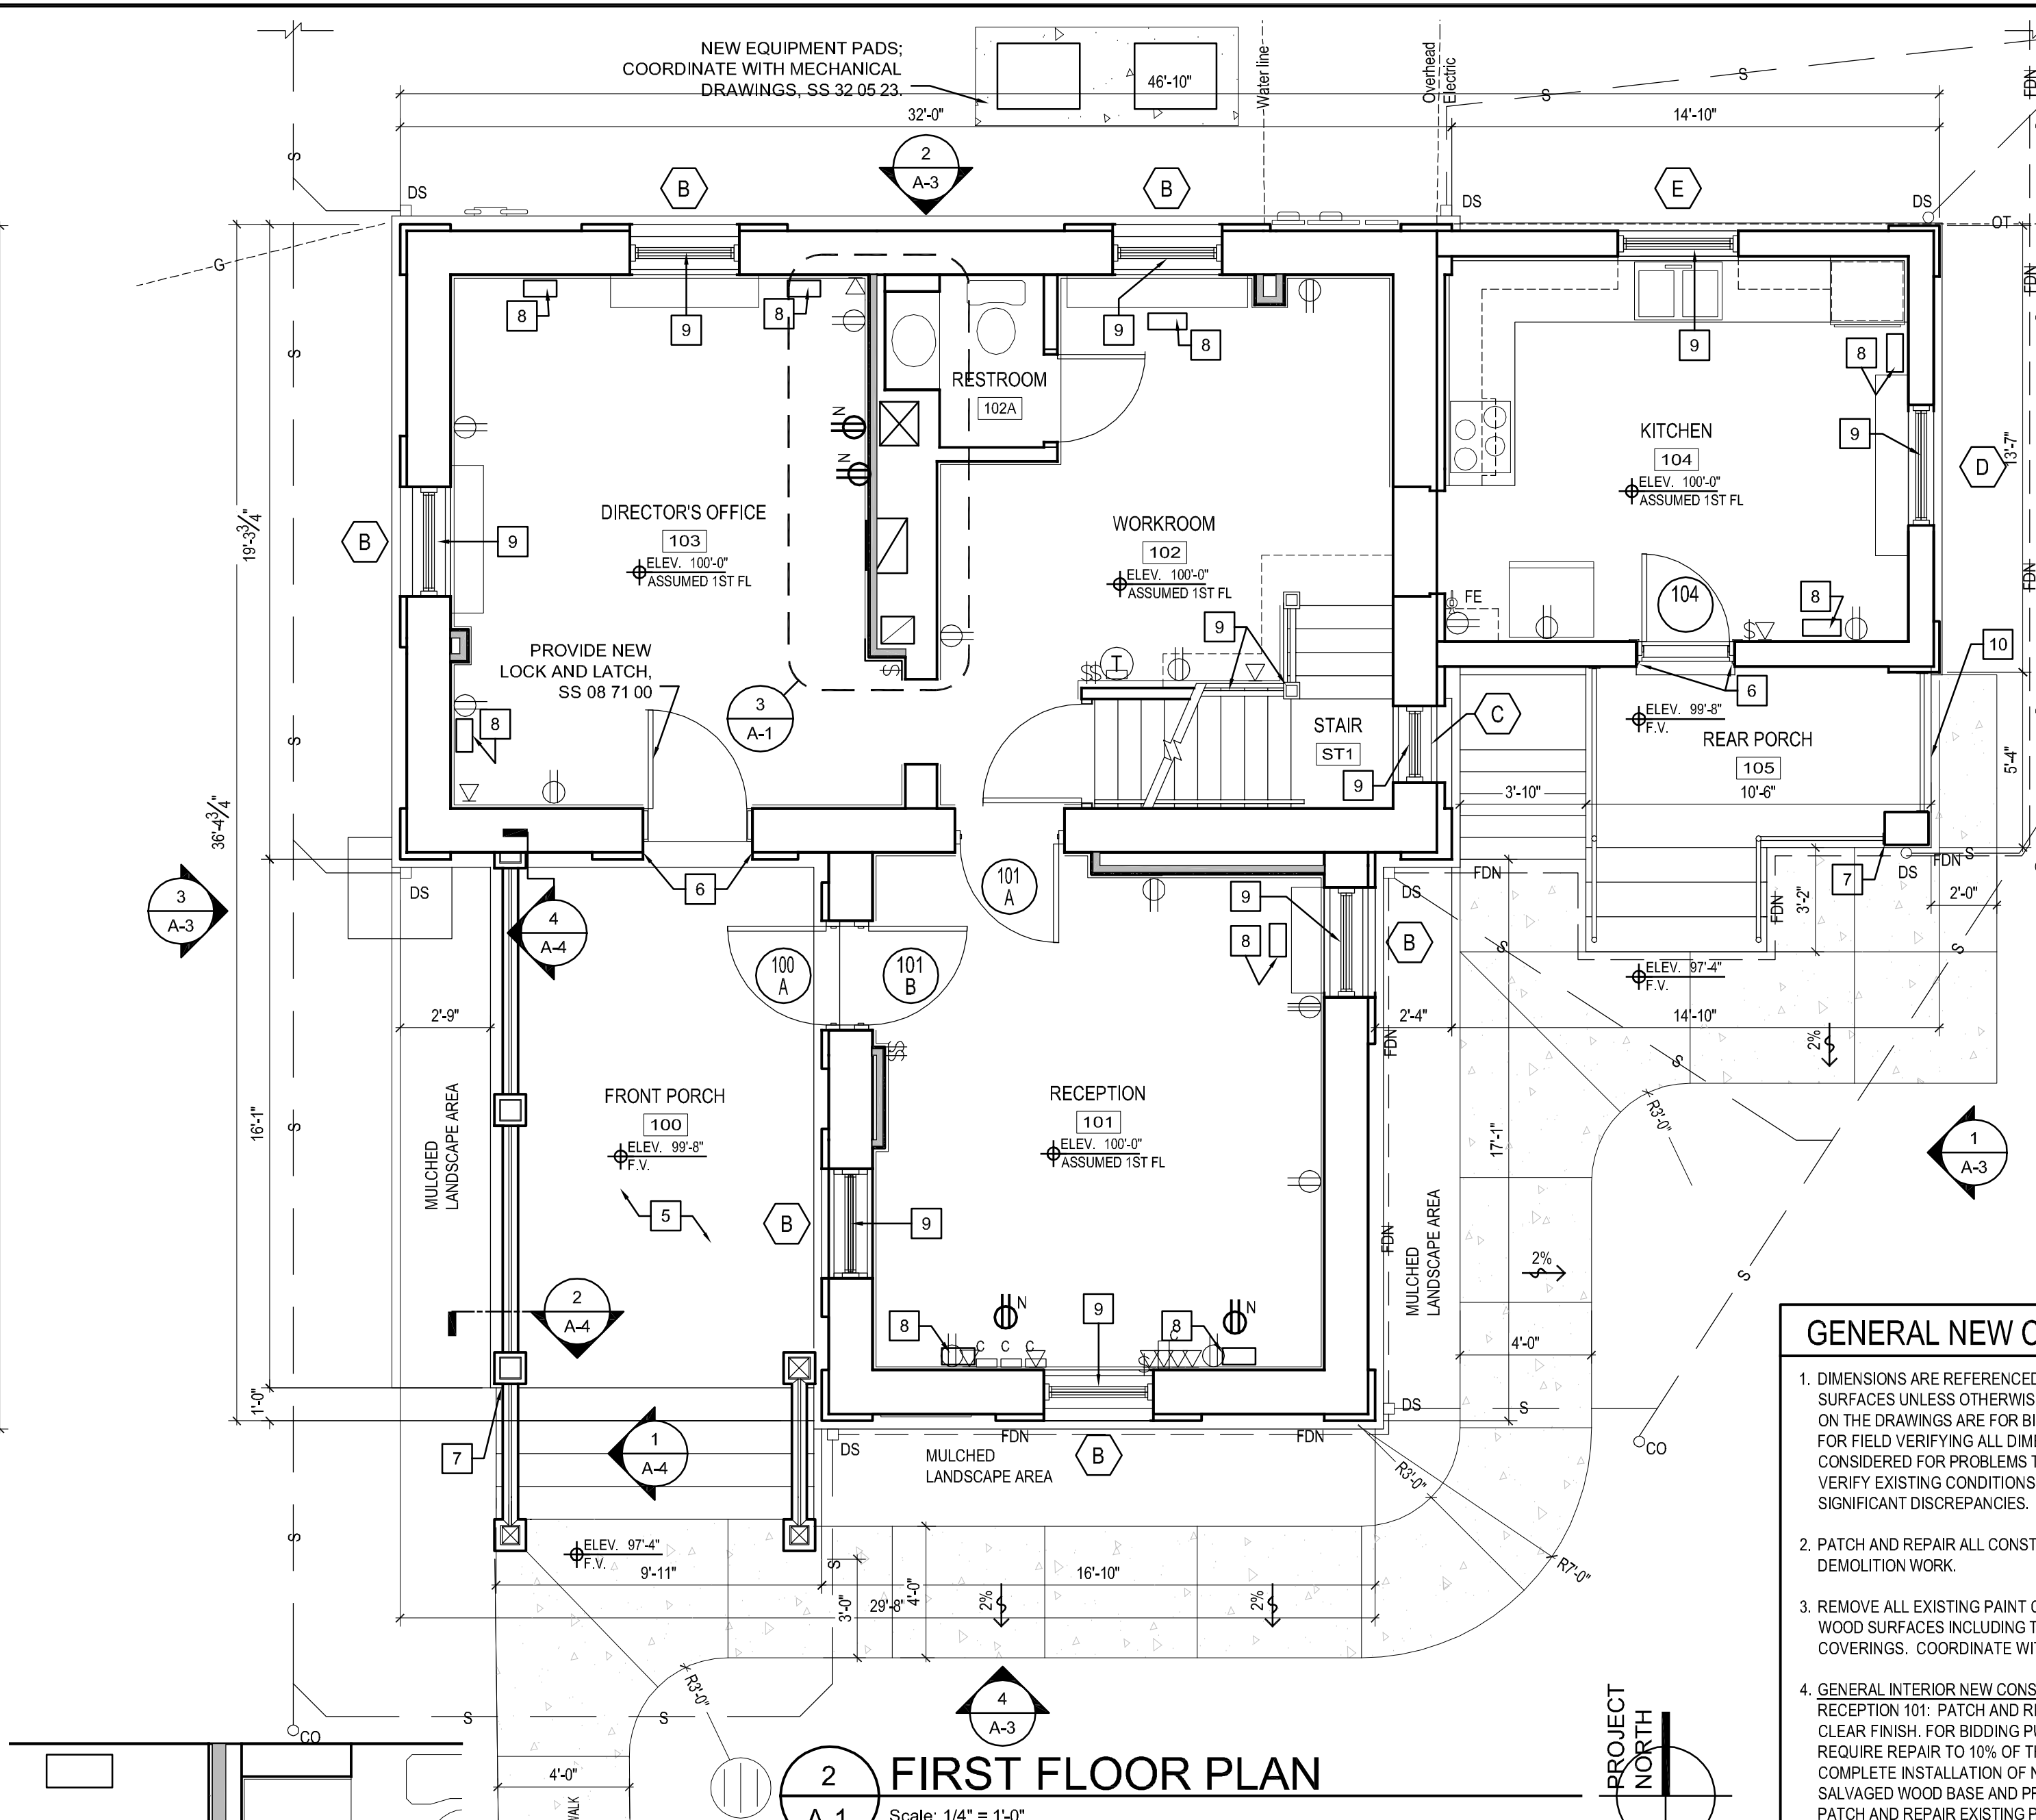


1 BASEMENT FLOOR PLAN
Scale: 1/4" = 1'-0"

DOOR AND FRAME SCHEDULE												
DOOR MARK	DOOR LOCATION	DOOR INFORMATION				FRAME INFORMATION					HDW. SET 087100	REMARKS
		SIZE		MATL	TYPE	MATL	TYPE	JAMB DEPTH	DETAIL			
		Width	Height						Head	Jamb		
100A	FRONT PORCH	3'-0"	7'-11"	WD/GL	D	WD	1	4 1/2"	-	-	100A	EXTERIOR STORM DOOR
101A	RECEPTION	3'-0"	7'-11"	WD	C	NEW WD	1	-	-	-	101A	INTERIOR DUTCH DOOR
101B	RECEPTION	3'-0"	7'-11"	WD	A	EX WD	EX	-	-	-	101B	EXTERIOR DOOR, HISTORIC
104	KITCHEN	2'-8"	7'-0"	WD	B	EX WD	EX	-	-	-	104	EXTERIOR DOOR, HISTORIC

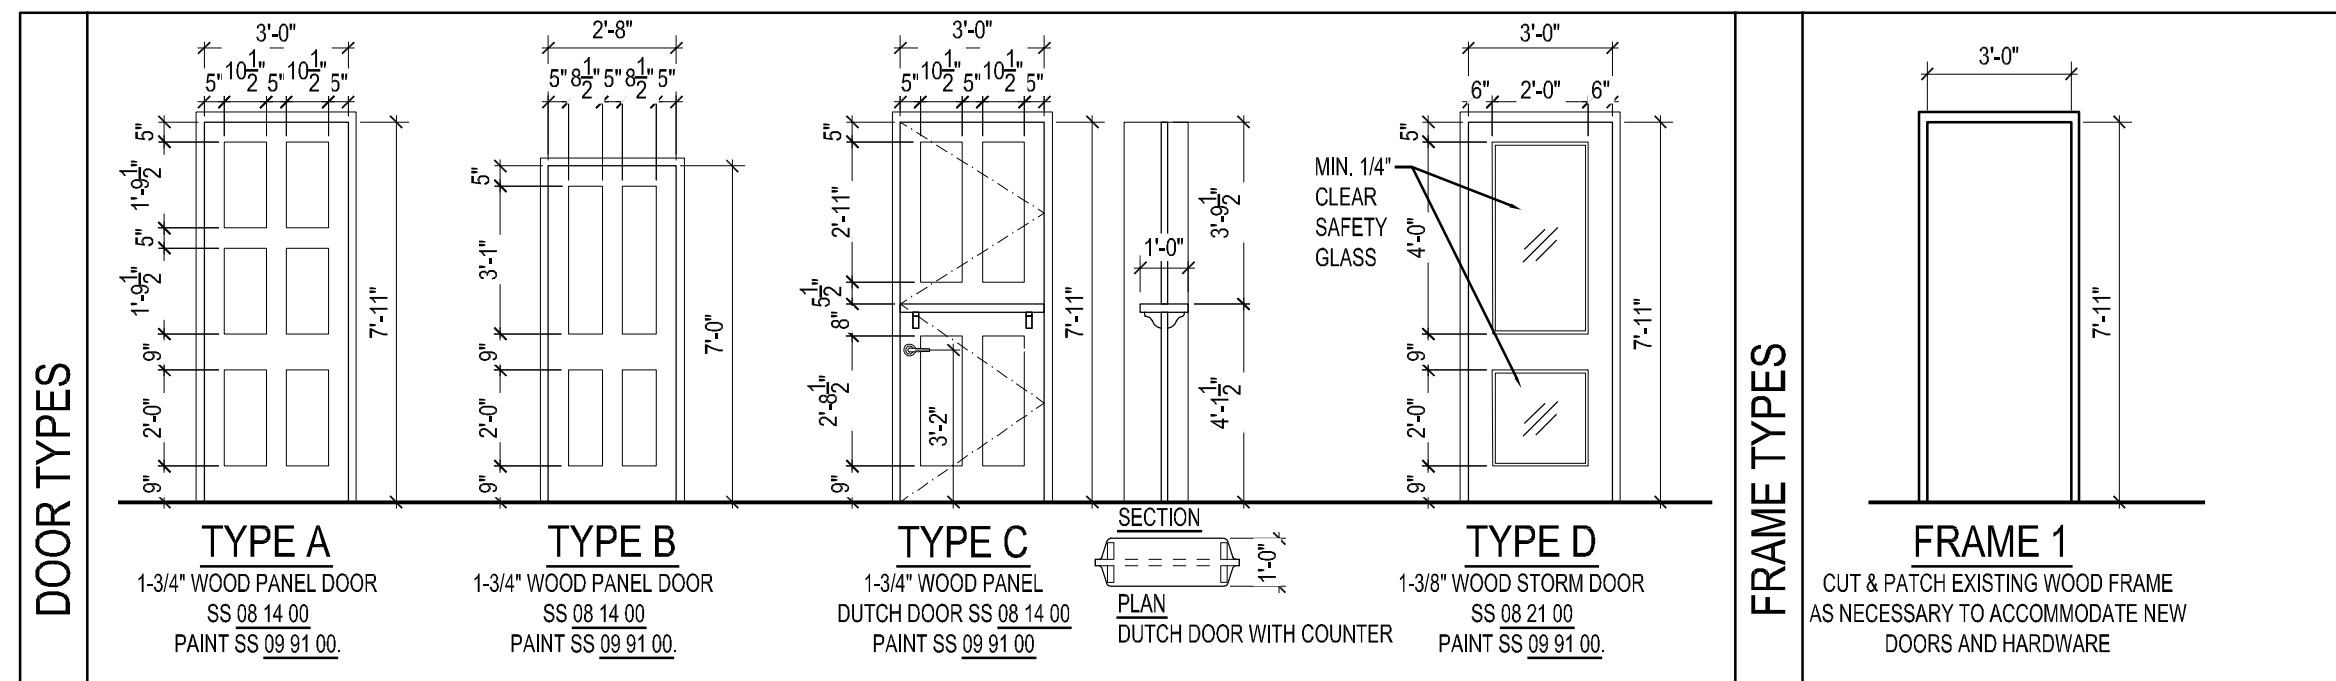

2 FIRST FLOOR PLAN
Scale: 1/4" = 1'-0"

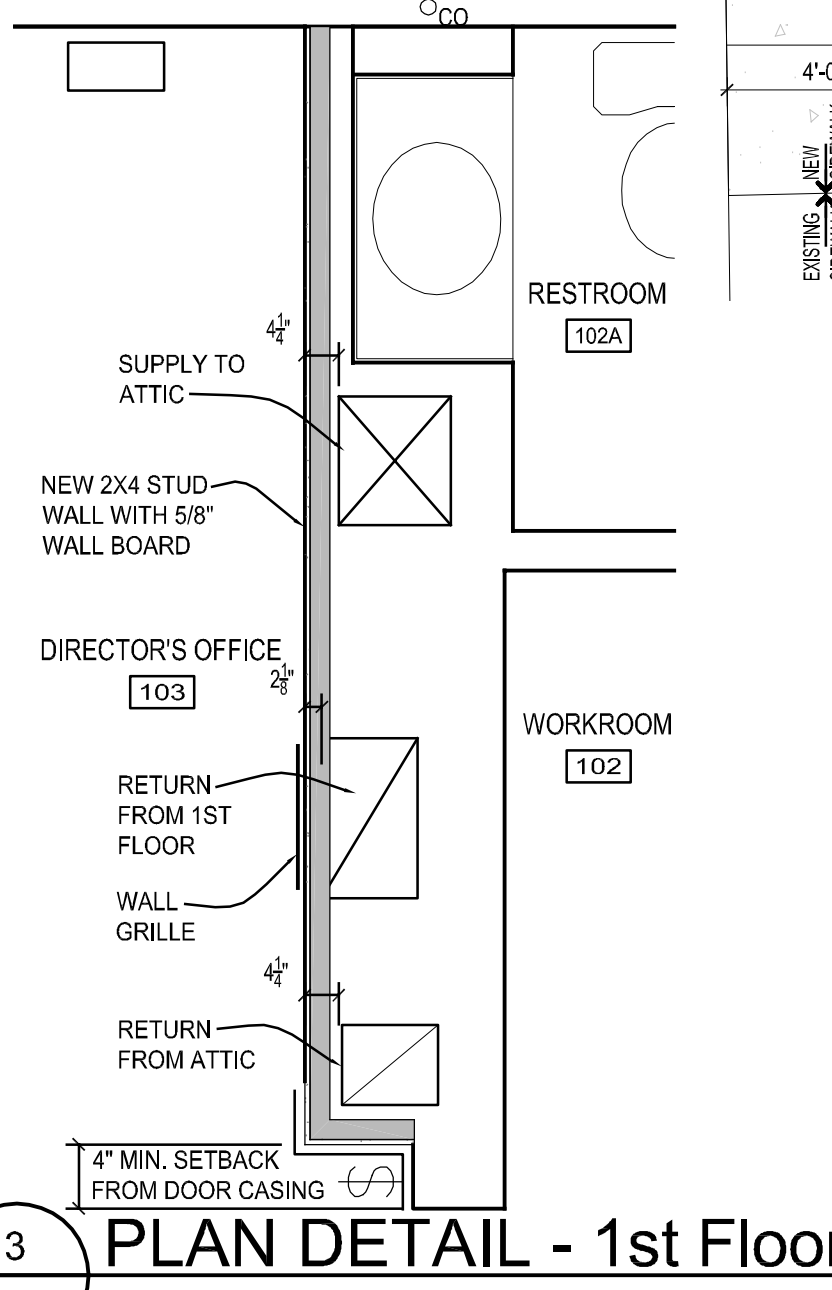

3 PLAN DETAIL - 1st Floor
Scale: 1/2" = 1'-0"

SYMBOLS LEGEND

EXISTING WALL CONSTRUCTION TO REMAIN.

ENLARGED PLAN / DETAIL IDENTIFICATION

SECTION DESIGNATION

ELEVATION DESIGNATION

WINDOW TYPE IN EXISTING OPENINGS. REFER TO WINDOW SCHEDULE ON DRAWING A-2.

DOOR OPENING DESIGNATION. REFER TO SCHEDULE ON DRAWING A-1.

TAG NOTE. REFER TO LEGEND ON SHEET WHERE NOTE IS REFERENCED.

F.V. FIELD VERIFY

DS NEW DOWNSPOUT, WORK OF SS 07 60 00.

EXISTING ELECTRICAL/COMMUNICATION DEVICE RELOCATED AS NECESSARY. OUTROUTE PLASTER/MASONRY TO CONCEAL ALL JUNCTION BOXES AND/OR CONDUIT. INCLUDE MATERIAL/LABOR COSTS TO PROVIDE JUNCTION BOX, JACK, AND COVER FOR ALL DATA CABLING CURRENTLY EXPOSED AND ROUTED THROUGH FINISHED FLOOR. INCLUDE MATERIAL/LABOR COSTS TO PROVIDE NEW "MULTI-SERVICE" BOX, JACKS AND COVERS TO COMBINE SEVERAL INDIVIDUAL COMMUNICATION CONNECTIONS ON SOUTH WALL OF RECEPTION 101.

N NEW DUPLEX OUTLET INSTALLED IN WOOD BASEBOARD. CONCEAL JUNCTION BOX & CONDUIT IN PLASTER/MASONRY. WIRE TO CLOSEST AVAILABLE CIRCUIT.

NEW CHASE CONSTRUCTED OF 2X4 STUDS @ 16" OC AND SINGLE LAYER OF 5/8" WALLBOARD. EXTEND WALLBOARD TO EXISTING PLASTER CEILING ABOVE. (APPROXIMATELY 10'-0" - FIELD VERIFY). WORK OF SPECIFICATION SECTION 09 20 00.

NEW 4" UNDERGROUND FOUNDATION DRAIN EXTENDING AROUND (3) SIDES OF BUILDING AS SHOWN. PROVIDE MINIMUM 1% SLOPE TO OUTLET AND A MINIMUM DEPTH OF 12" AT ANY LOCATION. DISCHARGE PIPE TO DAYLIGHT THROUGH EXISTING STONE RETAINING WALL LOCATED APPROXIMATELY 25' BEYOND SOUTH BUILDING ELEVATION. WORK OF SPECIFICATION SECTION 33 46 13

NEW 6" UNDERGROUND STORM PIPING TIED TO ALL NEW DOWNSPOUTS AND ASSOCIATED CLEANOUTS (CO). PROVIDE PVC BOOT RECEPTORS CUT FLUSH WITH FINISH GRADE AND SEAL DOWNSPOUTS TO BOOTS. PROVIDE MINIMUM 1% SLOPE TO OUTLET AND A MINIMUM DEPTH OF 24" AT ANY LOCATION. DISCHARGE PIPE TO DAYLIGHT THROUGH EXISTING STONE RETAINING WALL LOCATED APPROXIMATELY 25' BEYOND SOUTH BUILDING ELEVATION. WORK OF SPECIFICATION SECTION 33 46 13

NEW CONCRETE PAVEMENT WITH 2% SLOPE AWAY FROM BUILDING IN ALL LOCATIONS. REFER TO DETAIL 4 ON SHEET A-5. WORK OF SPECIFICATION SECTION 32 05 23.

- SHEET A-1 TAG NOTES**
- EXISTING METAL WINDOW GRATE. REMOVE PAINT TO BARE METAL (WHITE BLAST FINISH). PROVIDE NEW PAINT FINISH AND REINSTALL. COORDINATE WITH SS 02 83 33.13.
 - CLEAN, SCRAPE AND REMOVE LOOSE, FLAKING MATERIAL TO PREPARE WALL FOR NEW CEMENTITIOUS COATING. WORK OF SPECIFICATION SECTION 09 91 00.
 - ROD OUT AND CLEAN EXISTING FLOOR DRAIN. DEMONSTRATE PROPER OPERATION TO OWNER.
 - PROVIDE NEW LANDING NEWEL POST. ATTACH TO EXISTING RAILING. PROVIDE NEW RAILING AND PICKETS BETWEEN NEWEL POST AND WALL BEYOND WHERE PANELING HAS BEEN REMOVED. POST, RAIL AND PICKETS TO MATCH EXISTING CONDITIONS. WORK OF SPECIFICATION SECTION 06 20 00.
 - PROVIDE NEW CLEAR PENETRATING SEALER ON EXISTING CONCRETE PORCH AND STAIRS. SS 09 91 00.
 - REPAIR EXISTING WOOD DOOR FRAME/CASINGS/TRIM WHERE STORM DOOR HAS BEEN REMOVED. REMOVE ALL EXISTING PAINT COATINGS TO BARE WOOD ON DOOR/FRAME/CASINGS AND TRIM. PROVIDE NEW PAINT FINISH.
 - EXISTING WIRELESS BRIDGE SHALL REMAIN OPERATIONAL AT ALL TIMES EXCEPT FOR 6-HOUR PERIOD DURING RELOCATION. CONTRACTOR IS RESPONSIBLE FOR RELOCATING WIRELESS BRIDGE TO EXTERIOR SOUTHEAST CORNER OF PORCH 105 ROOF. CONTRACTOR IS ALSO RESPONSIBLE FOR RELOCATION WIRELESS BRIDGE MONITOR ON THE EXTERIOR OF THE MAINTENANCE BUILDING (REFER TO SITE PLAN ON COVER SHEET). CONTRACTOR SHALL PROVIDE ALL MATERIAL, LABOR AND EQUIPMENT NECESSARY.
 - CUT AND PATCH EXISTING FLOOR TO ACCOMMODATE NEW FLOOR REGISTERS.
 - TEMPORARILY REMOVE WINDOW SASHES ON FIRST FLOOR FOR REPAIRS. REMOVE ALL EXISTING PAINT COATINGS AND REPLACE ALL WINDOW PUTTY. PROVIDE NEW PAINT FINISH AND REINSTALL. SS 06 20 00 & SS 02 83 33.13 & SS 09 91 00.
 - NEW CRAWL SPACE ACCESS PANEL. REFER TO DETAIL 3A-2.

- GENERAL NEW CONSTRUCTION NOTES**
- DIMENSIONS ARE REFERENCED FROM FACE OF EXISTING MASONRY OR FINISH SURFACES UNLESS OTHERWISE NOTED. DOOR AND WINDOW DIMENSIONS INCLUDED ON THE DRAWINGS ARE FOR BIDDING PURPOSES ONLY. CONTRACTOR IS RESPONSIBLE FOR FIELD VERIFYING ALL DIMENSIONS. NO ADDITIONAL COMPENSATION WILL BE CONSIDERED FOR PROBLEMS THAT OCCUR RESULTING FROM FAILURE TO FIELD VERIFY EXISTING CONDITIONS AND/OR DIMENSIONS. NOTIFY ARCHITECT OF SIGNIFICANT DISCREPANCIES.
 - PATCH AND REPAIR ALL CONSTRUCTION ASSEMBLIES AND FINISHES DISTURBED BY DEMOLITION WORK.
 - REMOVE ALL EXISTING PAINT COATINGS TO BARE WOOD FROM EXISTING EXTERIOR WOOD SURFACES INCLUDING THOSE PREVIOUSLY CONCEALED BY SHEET METAL COVERINGS. COORDINATE WITH SPEC SECTION 02 83 33.13.
 - GENERAL INTERIOR NEW CONSTRUCTION REQUIREMENTS: BASE BID
RECEPTION 101: PATCH AND REPAIR EXISTING WOOD FLOOR AND PREPARE FOR NEW CLEAR FINISH. FOR BIDDING PURPOSES, FLOOR PATCHING WILL REQUIRE REPAIR TO 10% OF THE FLOOR SURFACE IN ADDITION TO WORK REQUIRED TO COMPLETE INSTALLATION OF NEW MECHANICAL SUPPLY GRILLES. REINSTALL SALVAGED WOOD BASE AND PREPARE FOR NEW FINISH.
PATCH AND REPAIR EXISTING PLASTER WALLS. FOR BIDDING PURPOSES, PATCHING WILL REQUIRE REPAIR TO 20% OF THE FULL WALL AREA EVENLY DISTRIBUTED AROUND THE ENTIRE SURFACE. COST ADJUSTMENT FOR ACTUAL WORK REQUIRED WILL BE MADE USING CONTRACT UNTIL PRICES. REFER TO FINISH SCHEDULE FOR NEW FINISHES.
 - GENERAL INTERIOR NEW CONSTRUCTION REQUIREMENTS: BID ALTERNATE NO. ONE
DIRECTOR'S OFFICE 103 AND WORKROOM 102: CLEAN AND PREPARE EXISTING WOOD FLOORS FOR NEW CLEAR FINISH. PROVIDE NEW 1X8 WOOD BASE AND TOE MOLD. PATCH AND REPAIR EXISTING PLASTER WALLS. FOR BIDDING PURPOSES, PATCHING WILL REQUIRE REPAIR TO 20% OF THE FULL WALL AREA EVENLY DISTRIBUTED AROUND THE ENTIRE SURFACE. COST ADJUSTMENT FOR ACTUAL WORK REQUIRED WILL BE MADE USING CONTRACT UNTIL PRICES.
RECEPTION 101: PATCH AND REPAIR EXISTING WOOD FLOOR AND PREPARE FOR NEW CLEAR FINISH. PROVIDE NEW 1X8 WOOD BASE AND TOE MOLD. PATCH AND REPAIR EXISTING PLASTER WALLS. FOR BIDDING PURPOSES, PATCHING WILL REQUIRE REPAIR TO 20% OF THE FULL WALL AREA EVENLY DISTRIBUTED AROUND THE ENTIRE SURFACE. COST ADJUSTMENT FOR ACTUAL WORK REQUIRED WILL BE MADE USING CONTRACT UNTIL PRICES.
KITCHEN 104: PROVIDE NEW 25' HARBORBOARD FLOOR UNDERLAYMENT AND PREPARE FLOOR FOR NEW FINISH. PATCH AND REPAIR EXISTING PLASTER WALLS. FOR BIDDING PURPOSES, PATCHING WILL REQUIRE REPAIR TO 20% OF THE FULL WALL AREA EVENLY DISTRIBUTED AROUND THE ENTIRE SURFACE. COST ADJUSTMENT FOR ACTUAL WORK REQUIRED WILL BE MADE USING CONTRACT UNTIL PRICES. PROVIDE SKIM COAT OVER ALL SURFACES PREVIOUSLY FINISHED WITH WALL COVERING.
STAIR (ST-1): PROVIDE NEW MAPLE STAIR TREADS. CLEAN AND PREPARE EXISTING RISERS FOR NEW PAINT FINISH.
REFER TO FINISH SCHEDULE FOR NEW FINISH REQUIREMENTS IN ALL AREAS.
 - ALL EXISTING EXTERIOR PAINTED SURFACES INCLUDING BUT NOT LIMITED TO DOORS, WINDOWS, EAVES, SOFFITS AND TRIM CONTAIN LEAD. ALL CONTRACT WORK REQUIRED TO BE PERFORMED TO THESE SURFACES (FOR EXAMPLE: SCRAPING, SANDING, PRIMING, PAINTING, CUTTING, PATCHING, REMOVAL, DISPOSAL, ETC) MUST BE ACCOMPLISHED IN ACCORDANCE TO THE REQUIREMENTS OF SPECIFICATION 02 83 33.13.

CONSULTANTS:			ARCHITECT/ENGINEERS:			100% BID DOCUMENTS		
Tate•Hill•Jacobs Architects 346 East Main Street • Lexington • Kentucky • 40507 Telephone 859 • 252 • 5994 Facsimile 859 • 253 • 1607			SMITHGROUP architecture engineering interiors planning SMITHGROUP, INC. 500 GRISWOLD SUITE 1700 DETROIT, MICHIGAN 48226 T 313.983.3600 F 313.983.3636 www.smithgroup.com			Project Title Renovate Meigs Lodge Building Lebanon National Cemetery		
Revisions:		Date		Drawing Title FLOOR PLANS SCHEDULES & DETAILS		Project Number		
100% BID DOCUMENTS		4/07/11		Approved Project Director		Building Number		
95% DESIGN DOCUMENTS		1/11/11		Date APRIL 7, 2011		Location Marion County, Kentucky		
90% DESIGN DOCUMENTS		11/22/10		Checked MJ		Drawing Number A-1		
50% DESIGN DOCUMENTS		10/08/10		Drawn JES		Dwg. 3 of 12		