


ROOF FRAMING PLAN  
SCALE: 1/8" = 1'-0"

- PLAN NOTES:
1. TOP OF ROOF TO MATCH EXISTING TOP OF ROOF. DETERMINE T.O.S. BASED ON EXISTING T.O.S.
  2. FIELD VERIFY ALL EXISTING CONDITIONS AND DIMENSIONS PRIOR TO CONSTRUCTION.
  3. SPACE JOISTS EQUALLY U.N.O.
  4. PROVIDE 3/16" CLOSURE PLATES AT ALL TUBE BEAMS.
  5. REFER TO ARCHITECTURAL DRAWINGS / MEP FOR LOCATIONS OF ROOF DRAINS, OVERFLOW DRAINS AND TAPERED INSULATION.
  6. LSH = LONG SIDE HORIZONTAL
  7. LSH = LONG SIDE HORIZONTAL
  8. LSV = LONG SIDE VERTICAL

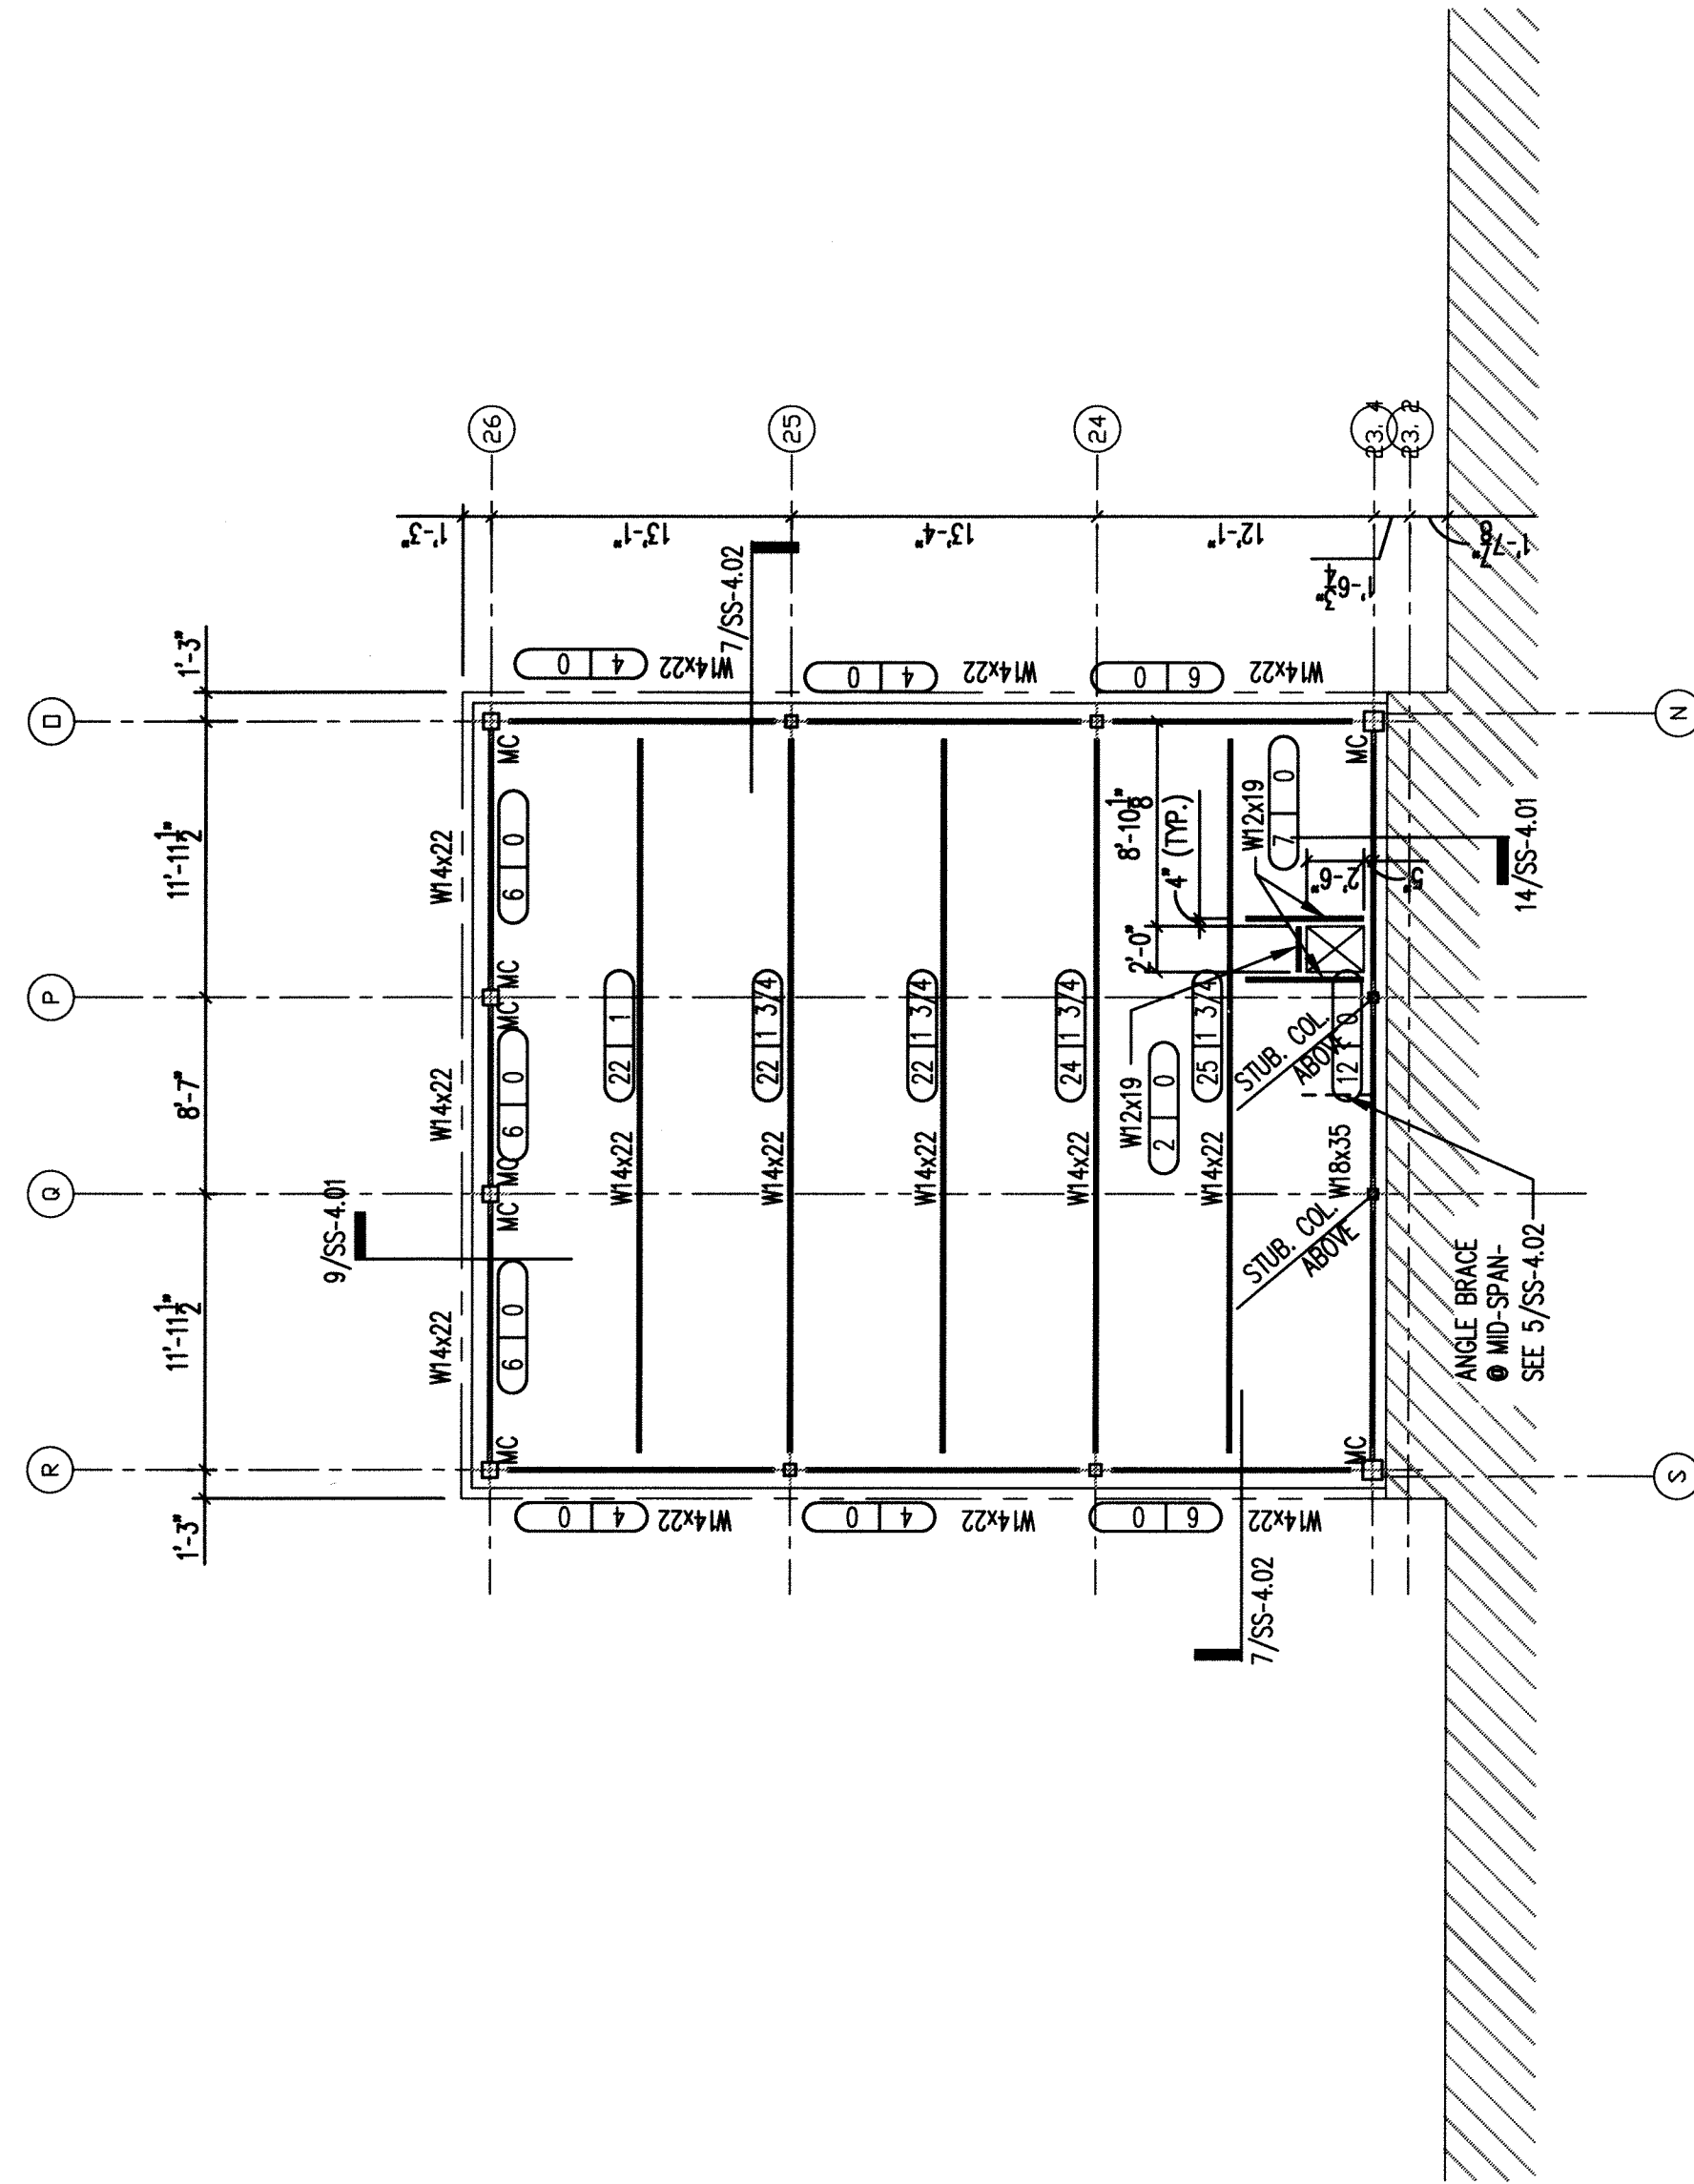

PENTHOUSE FRAMING PLAN  
SCALE: 1/8" = 1'-0"

- PLAN NOTES:
1. FINISHED FLOOR ELEVATION = 599.59 (FIELD VERIFY)
  2. LOADS SHALL BE AS SHOWN (SEE 3/2) INDICATES NUMBER OF SHEAR CONNECTIONS (S12) AND UPWARD CANTER AT MID SPAN OF BEAM AS 3/4"
  3. SPACE BEAMS EQUALLY U.N.O.
  4. PROVIDE END PLATES AT ALL TUBE BEAMS.
  5. FIELD VERIFY ALL EXISTING CONDITIONS AND DIMENSIONS PRIOR TO CONSTRUCTION.
  6. LSH = LONG SIDE HORIZONTAL
  7. LSH = LONG SIDE HORIZONTAL
  8. LSV = LONG SIDE VERTICAL

SCHEMATIC DESIGN SUBMISSION	08/02/10
DESIGN DEVELOPMENT SUBMISSION	09/03/10
CONSTRUCTION DOCUMENT SUBMISSION	11/22/10
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MEP ENGINEERS  
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PINNACLE STRUCTURAL  
PROTECTION DEVELOPMENT INC.  
BREWER AND ESCALANTE

DO NOT SCALE THESE DRAWINGS. G.C. TO FIELD VERIFY DIMENSIONS

Drawing Title <b>PENTHOUSE AND ROOF FRAMING PLAN</b>		Project Title <b>BUILDING 11 ADDITION &amp; INTERIOR RENOVATIONS</b>		ISSUED FOR BIDS* Project Number <b>674A4-CSI-516</b>	
Approved: Project Director		Location <b>WACO, TEXAS</b>		Building Number <b>11</b>	
Date <b>19 DEC 2011</b>		Checked <b>Drawn</b>		Drawing Number <b>11-SS-202</b>	
				Dwg. <b>3</b> of <b>7</b>	