



Department of Veterans Affairs

VETERANS AFFAIRS MEDICAL CENTER 1011 HONOR HEIGHTS DRIVE MUSKOGEE, OK 74401 PROJECT #623-14-103 RENOVATE STERILE PROCESSING SERVICES




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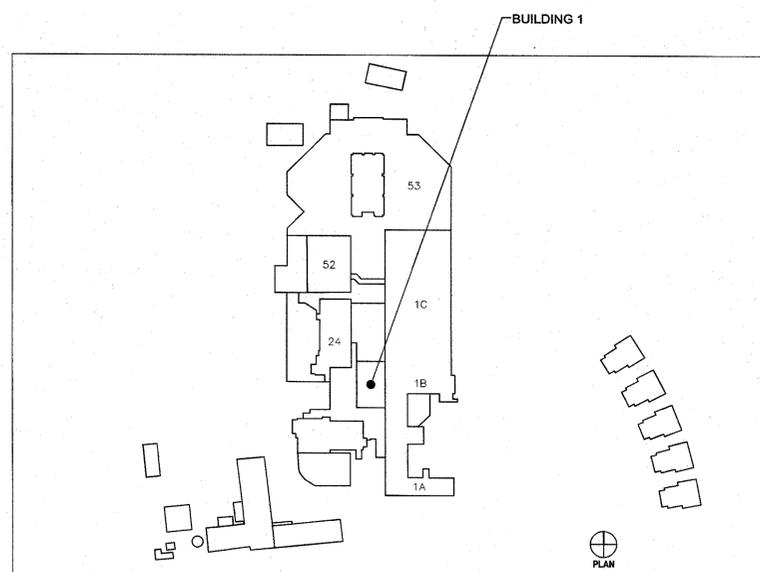
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PROJECT LOCATION MAP



PROJECT SITE MAP

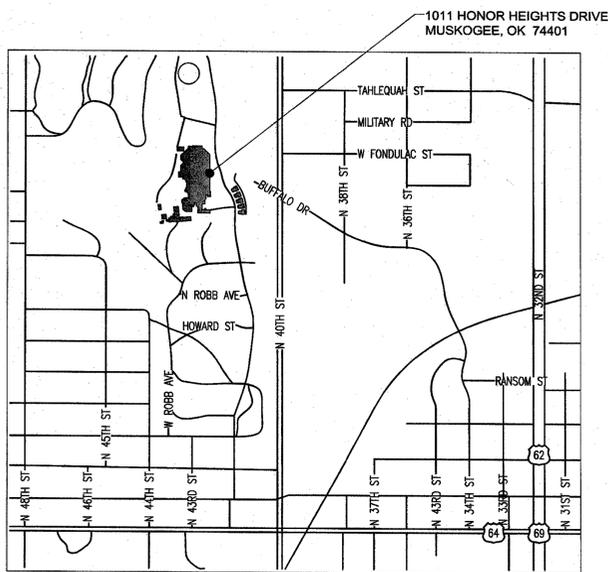

SIGNATURE BLOCK

	03/20/2015
MEDICAL CENTER DIRECTOR	DATE
	03/19/2015
ASSOCIATE MEDICAL CENTER DIRECTOR	DATE
	03/19/2015
CHIEF OF STAFF	DATE
	3-12-15
CHIEF, ENGINEERING SERVICES	DATE
	3-20-15
CHIEF, LOGISTICS SERVICES	DATE
	3-12-15
SAFETY OFFICER	DATE
	3-12-15
INDUSTRIAL HYGIENIST	DATE
	3/17/15
INFECTION CONTROL OFFICER	DATE
	3-13-15
SPS MANAGER	DATE
	3/13/15
PRESIDENT ARGE 2250	DATE
	3/13/15
ENERGY ENGINEER	DATE

CONSULTANTS:

ARCHITECT/ENGINEERS:



200 Envoy Circle #201, Louisville KY 40299 - PH: 502.339.8511 - www.paradigmusa.com



Drawing Title

COVER SHEET

Control Number
VA256-14-C-0112

Project Title

RENOVATE STERILE PROCESSING SERVICES

Location JACK C. MONTGOMERY VAMC
1011 HONOR HEIGHTS DRIVE, MUSKOGEE, OK

Date 03/10/2015

Checked WRW

Drawn BLM

Project Number

623-14-103

Building Number
1



Drawing Number
GI001

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Office of
Construction
and Facilities
Management



three inches = one foot
 one and one half inches = one foot
 one inch = one foot
 three quarters inch = one foot
 one half inch = one foot
 three eighths inch = one foot
 one quarter inch = one foot
 one eighth inch = one foot

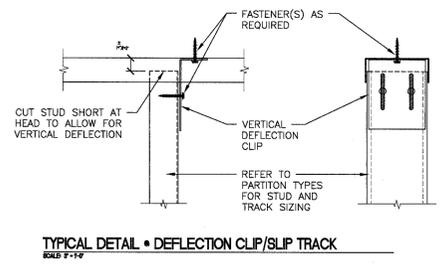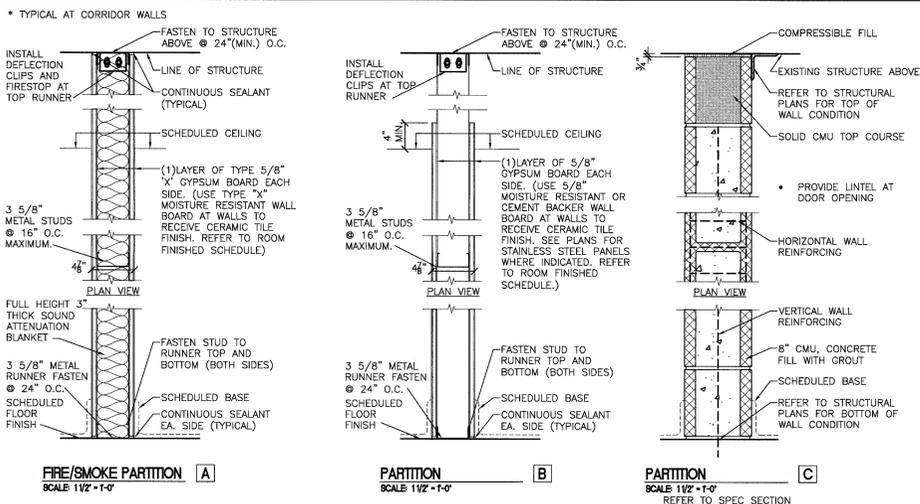

- PARTITION NOTES**
- PARTITION NOTES APPLY TO ALL INTERIOR PARTITIONS CONSTRUCTED FOR THE PROJECT.
 - PARTITION TYPE DRAWINGS INDICATE THE GENERAL RELATIONSHIP AMONG MATERIALS AND CONSTRUCTION OF PARTITIONS WITHIN THE SCOPE OF WORK.
 - CONTRACTOR SHALL PROVIDE FIRE RATED PARTITIONS IN ACCORDANCE WITH THE REFERENCED U400 SERIES U.L. DESIGN NUMBERS INDICATED. (REFER TO U.L. FIRE RESISTANCE DIRECTORY- LATEST EDITION)
 1-HR. UL RATED PARTITIONS INCLUDE THE FOLLOWING:
 - PROVIDE AND INSTALL 5/8" THICK, 4'-0" WIDE GYPSUM WALL BOARD ATTACHED TO STEEL STUDS AND FLOOR AND CEILING TRACK WITH 1" LONG, TYPE S STEEL SCREWS SPACED 8" O.C. ALONG EDGES OF BOARD AND 12" O.C. IN THE FIELD OF THE BOARD. JOINTS SHALL BE ORIENTED VERTICALLY AND STAGGERED ON OPPOSITE SIDES OF THE ASSEMBLY.
 - JOINT TAPE AND COMPOUND SHALL BE VINYL DRY OR PRE-MIXED COMPOUND APPLIED IN TWO COATES TO JOINTS AND SCREW HEADS. PAPER TAPE, 2" WIDE EMBEDDED IN FIRST LAYER OF COMPOUND OVER ALL JOINTS.
 - STEEL STUDS SHALL BE CHANNEL SHAPED AND 3-5/8" WIDE (MINIMUM), WITH 1-1/4" LEGS FORMED FROM MINIMUM NUMBER 25 MSG GALVANIZED STEEL ATTACHED TO FLOOR AND CEILING WITH FASTENERS SPACED 24" O.C. MAXIMUM.
 - PROVIDE AND INSTALL FIRE/SMOKE STOP/SEAL JOINT TREATMENT SYSTEM AT INTERSECTION OF PARTITION WITH STRUCTURE ABOVE. (REFER TO FIRE STOP NOTES, THIS SHEET.)
 - ALL CORRIDOR WALLS WITHIN THE SCOPE OF WORK ARE TO BE CONSTRUCTED AS 1-HOUR RATED WALLS THAT ARE ALSO RESISTANT TO THE PASSAGE OF SMOKE.
 - EXISTING FACILITY STRUCTURE IS CONCRETE FRAMED WITH CONCRETE PAN-JOISTS SPANNING BETWEEN (AND PERPENDICULAR TO) THE BEAMS. EXISTING CONCRETE BEAM AND PAN JOIST DEPTHS VARY.
 - WHERE PARTITION FRAMING MEETS EXISTING STRUCTURE ABOVE, CONTRACTOR SHALL UTILIZE DEFLECTION CLIPS OR SLIP TRACK TO ANCHOR STUDS. (SLIP TRACK IS APPROPRIATE ONLY WHERE A CONSISTENT LEVEL UNINTERRUPTED STRUCTURE EXISTS ABOVE. PROVIDE DEFLECTION CLIPS OF VARYING TYPE APPROPRIATE FOR THE EXISTING CONDITION ENCOUNTERED WHERE TOP OF PARTITION MEETS EXISTING CONSTRUCTION. DEFLECTION CLIPS OR SLIP TRACK SHALL PROVIDE FOR DEFLECTION OF UP TO 3/4".
 - WHERE GYPSUM BOARD IS SHOWN TO EXTEND TO STRUCTURE ABOVE, HOLD THE GYPSUM BOARD 1" BELOW THE LINE OF EXISTING STRUCTURE. (FIRE SEAL ALL SUCH VOIDS IN CONTINUOUS GYPSUM BOARD WHERE OCCURRING AT FIRE-RATED WALLS.)
 - PROVIDE FIRE RETARDANT TREATED WOOD OR STEEL BLOCKING REINFORCEMENT WITHIN PARTITIONS FOR THE SUPPORT OF ALL WALL-MOUNTED EQUIPMENT, FIXTURES, CABINETS AND ACCESSORIES INDICATED, SCHEDULED OR REFERENCED BY THE CONTRACT DOCUMENTS. REFER TO PROJECT SPECIFICATION. ALSO REFER TO MEP PLANS, EQUIPMENT PLANS AND ENLARGED FLOOR PLANS AND INTERIOR ELEVATIONS. COORDINATE FINAL PLACEMENT OF ALL EQUIPMENT WITH VAMC COR.
 - WHERE FIRE RATED PARTITIONS ABUT OR INTERSECT WITH NON-RATED PARTITIONS: CONSTRUCT FIRE-RATED PARTITIONS COMPLETE - WITH GYPSUM BOARD CONTINUOUS AND UNINTERRUPTED BY THE FRAMING OR FINISH MATERIAL OF THE NON-RATED PARTITION.


- FIRE STOP NOTES**
- REFER TO SPECIFICATION SECTION 07 84 00: FIRESTOPPING.
 - EXISTING FLOORS ARE 2-HOUR RATED.
 - FIRE STOPPING NOTES APPLY TO ALL FLOOR PENETRATIONS.
 - FIRE STOP NOTES APPLY TO ALL FIRE RATED PARTITIONS.
 - FIRE STOPPING MATERIALS SHALL BE PROVIDED AND INSTALLED BY EACH TRADE CONTRACTOR AT WALL PENETRATIONS AND VOIDS CAUSED BY PIPES, TUBING, CONDUIT, CABLE, DUCTS AND ANY OTHER MATERIAL.
 - INSTALL IN ACCORDANCE WITH THE APPROPRIATE U.L. SYSTEM DESIGN FOR THE REQUIRED FIRE RATING INDICATED. (REFER TO U.L. FIRE RESISTANCE DIRECTORY- LATEST EDITION)
 - REFER TO MECHANICAL, ELECTRICAL AND PLUMBING (MEP) PLANS FOR PENETRATIONS THROUGH RATED WALLS.
 - REFER TO SHEET GI 101 FOR 2ND FLOOR LIFE SAFETY PLAN.

FULLY SPRINKLED
 BID DOCUMENTS
 FOR CONSTRUCTION

Office of
 Construction
 and Facilities
 Management

Department of
 Veterans Affairs

Revisions Date	CONSULTANTS:	ARCHITECT/ENGINEERS: 200 Envoy Circle #201, Louisville KY 40299 - PH: 502.339.8511 - www.paradigmusa.com	Drawing Title INTERIOR PARTITION TYPES	Project Title RENOVATE STERILE PROCESSING SERVICES	Project Number 623-14-103
	Date		Control Number VA256-14-C-0112	Location JACK C. MONTGOMERY VAMC 101 HONOR HEIGHTS DRIVE, MUSKOGEE, OK	Building Number 1
Date	Date	Date	Date	Date 03/10/2015	Drawing Number GI003

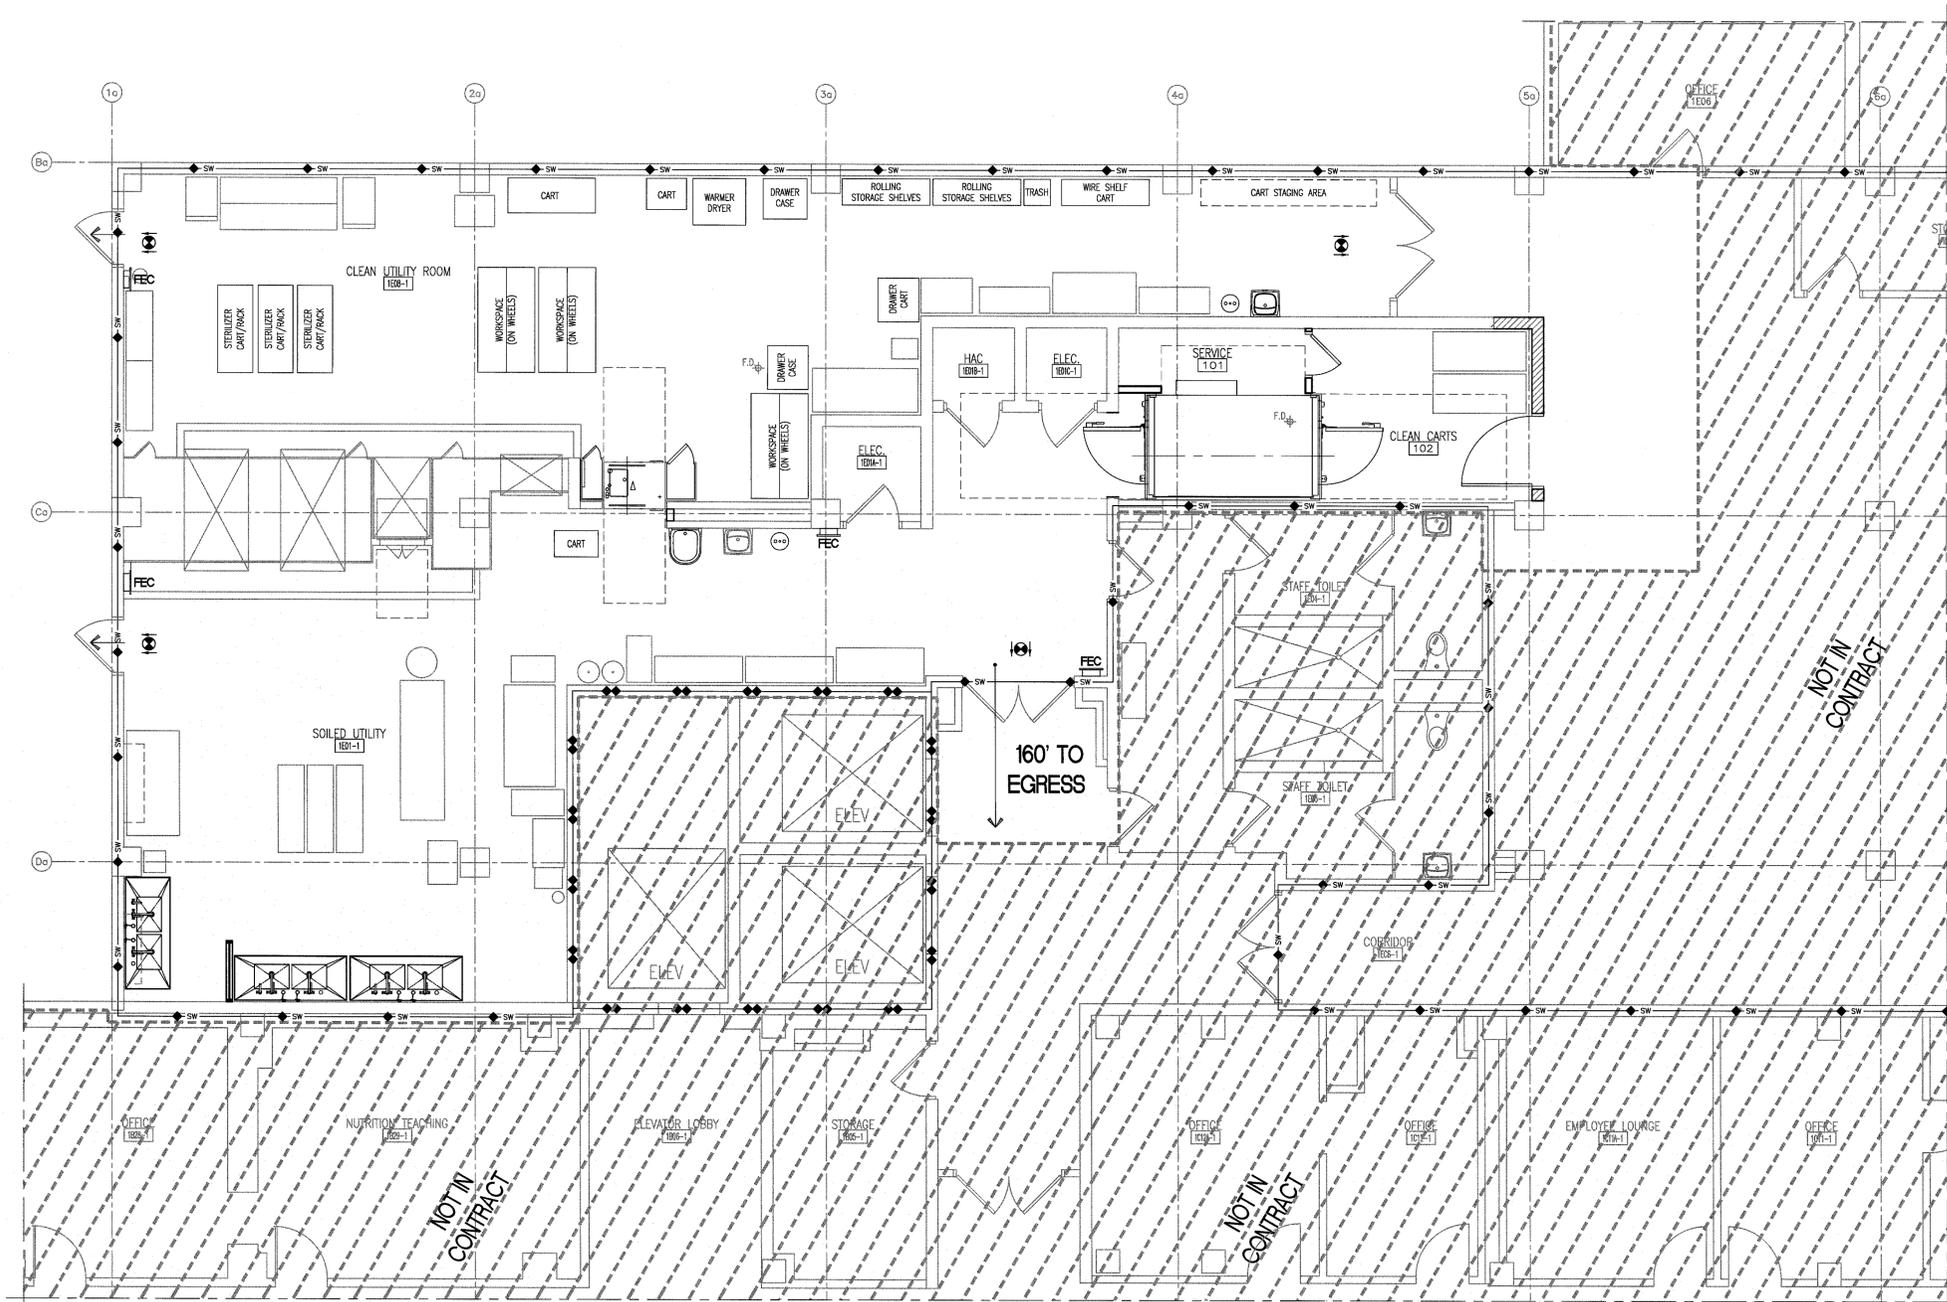


F1 FIRST FLOOR LIFE SAFETY PLAN
1/4" = 1'-0"

- CODES AND REGULATIONS**
- A. APPLICABLE CODES:
ALL WORK SHALL CONFORM TO ALL APPLICABLE CODES, STANDARDS AND GOVERNING AUTHORITIES: INCLUDING BUT NOT LIMITED TO:
- BUILDING: INTERNATIONAL BUILDING CODE, 2009 EDITION
 - LIFE SAFETY: NFPA 101 LIFE SAFETY CODE, CURRENT ADDITION
 - MECHANICAL: INTERNATIONAL MECHANICAL CODE, NFPA 90A
 - PLUMBING: INTERNATIONAL PLUMBING CODE
 - FIRE PREVENTION: NFPA NATIONAL FIRE CODES WITH THE EXCEPTION OF NFPA 5000 AND NFPA 900
 - ELECTRICAL: NATIONAL ELECTRICAL CODE (NEC)
 - ACCESSIBILITY: ABAAS INCLUDING VA SUPPLEMENT. BARRIER FREE DESIGN
 - VA PUBLICATIONS: VA DIRECTIVES, DESIGN MANUALS, AND OTHER GUIDANCE ON THE TECHNICAL INFORMATION LIBRARY (TIL)
- B. OCCUPANCY USE:
NFPA 101 2012: CHAPTER 19 EXISTING HEALTHCARE OCCUPANCIES
- C. CONSTRUCTION TYPE:
NFPA 101: TYPE II (222)
IBC: TYPE 2B

- LIFE SAFETY LINE TYPES**
- ◆— FIRE RESISTIVE RATED LINE, 1 HOUR
 - ◆◆— FIRE RESISTIVE RATED LINE, 2 HOUR
 - ◆S— FIRE-RATED, SMOKE BARRIER LINE, 1 HOUR
 - ◆S— FIRE-RATED, SMOKE BARRIER LINE, 2 HOUR
 - ◆30— FIRE-RATED, SMOKE BARRIER LINE, 30 MIN
 - ◆SW— NON-RATED, SUITE LINE, (SMOKE RESISTIVE)
 - ◆SR— NON-RATED SMOKE RESISTIVE

NOTE: ALL SYMBOLS MAY NOT BE USED

- LIFE SAFETY PLAN LEGEND**
- [FEC] FIRE EXTINGUISHER CABINET
 - [HE] HORIZONTAL EXIT
 - [EXIT SIGN] EXIT SIGN
 - [←] EXIT
- NOTE: ALL SYMBOLS MAY NOT BE USED

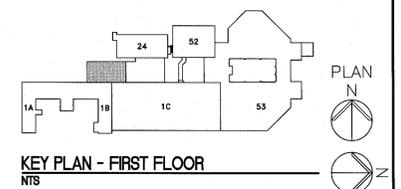

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BID DOCUMENTS
FOR CONSTRUCTION

Office of
Construction
and Facilities
Management



Revisions	Date

CONSULTANTS:

ARCHITECT/ENGINEERS:

PARADIGM
ENGINEERS AND CONSTRUCTORS

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Drawing Title
FIRST FLOOR LIFE SAFETY PLAN

Control Number
VA256-14-C-0112

Project Title
RENOVATE STERILE PROCESSING SERVICES

Project Number
623-14-103

Building Number
1

Location JACK C. MONTGOMERY VAMC
101 HONOR HEIGHTS DRIVE, MARKOCEE, OK

Date
03/10/2015

Checked
WRW

Drawn
LSS

Drawing Number
G1101

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 - VA PUBLICATIONS: VA DIRECTIVES, DESIGN MANUALS, AND OTHER GUIDANCE ON THE TECHNICAL INFORMATION LIBRARY (TIL)
- B. OCCUPANCY USE:
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- C. CONSTRUCTION TYPE:
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LIFE SAFETY LINE TYPES


- ◆— FIRE RESISTIVE RATED LINE, 1 HOUR
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- ◆30— FIRE-RATED, SMOKE BARRIER LINE, 30 MIN
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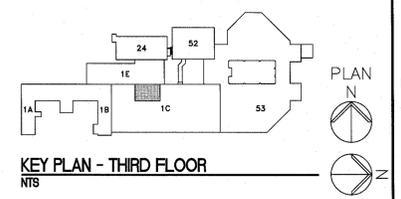
LIFE SAFETY PLAN LEGEND

- [FEC] FIRE EXTINGUISHER CABINET
- [HE] HORIZONTAL EXIT
- [EXIT SIGN] EXIT SIGN
- [EXIT] EXIT

NOTE: ALL SYMBOLS MAY NOT BE USED




F3 THIRD FLOOR LIFE SAFETY PLAN
 1/4" = 1'-0"

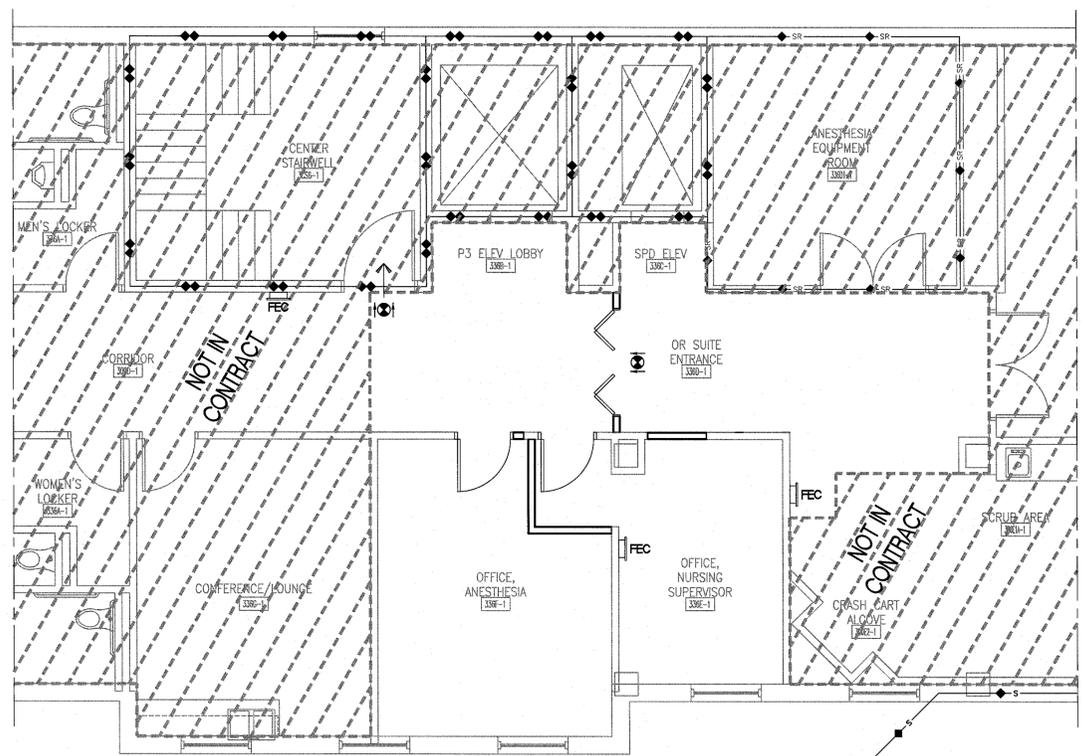

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 FOR CONSTRUCTION

Revisions Date	CONSULTANTS:	ARCHITECT/ENGINEERS: PARADIGM ENGINEERS AND CONSTRUCTORS 200 Envoy Circle #201, Louisville KY 40299 - Ph: 502.339.8511 - www.paradigmusa.com	Drawing Title THIRD FLOOR LIFE SAFETY PLAN	Project Title RENOVATE STERILE PROCESSING SERVICES	Project Number 623-14-103	Office of Construction and Facilities Management Department of Veterans Affairs
	Control Number VA256-14-C-0112	Location JACK C. MONTGOMERY VAMC 101 HONOR HEIGHTS DRIVE, MARSHOKE, OK	Date 03/10/2015	Building Number 1	Drawing Number G1102	

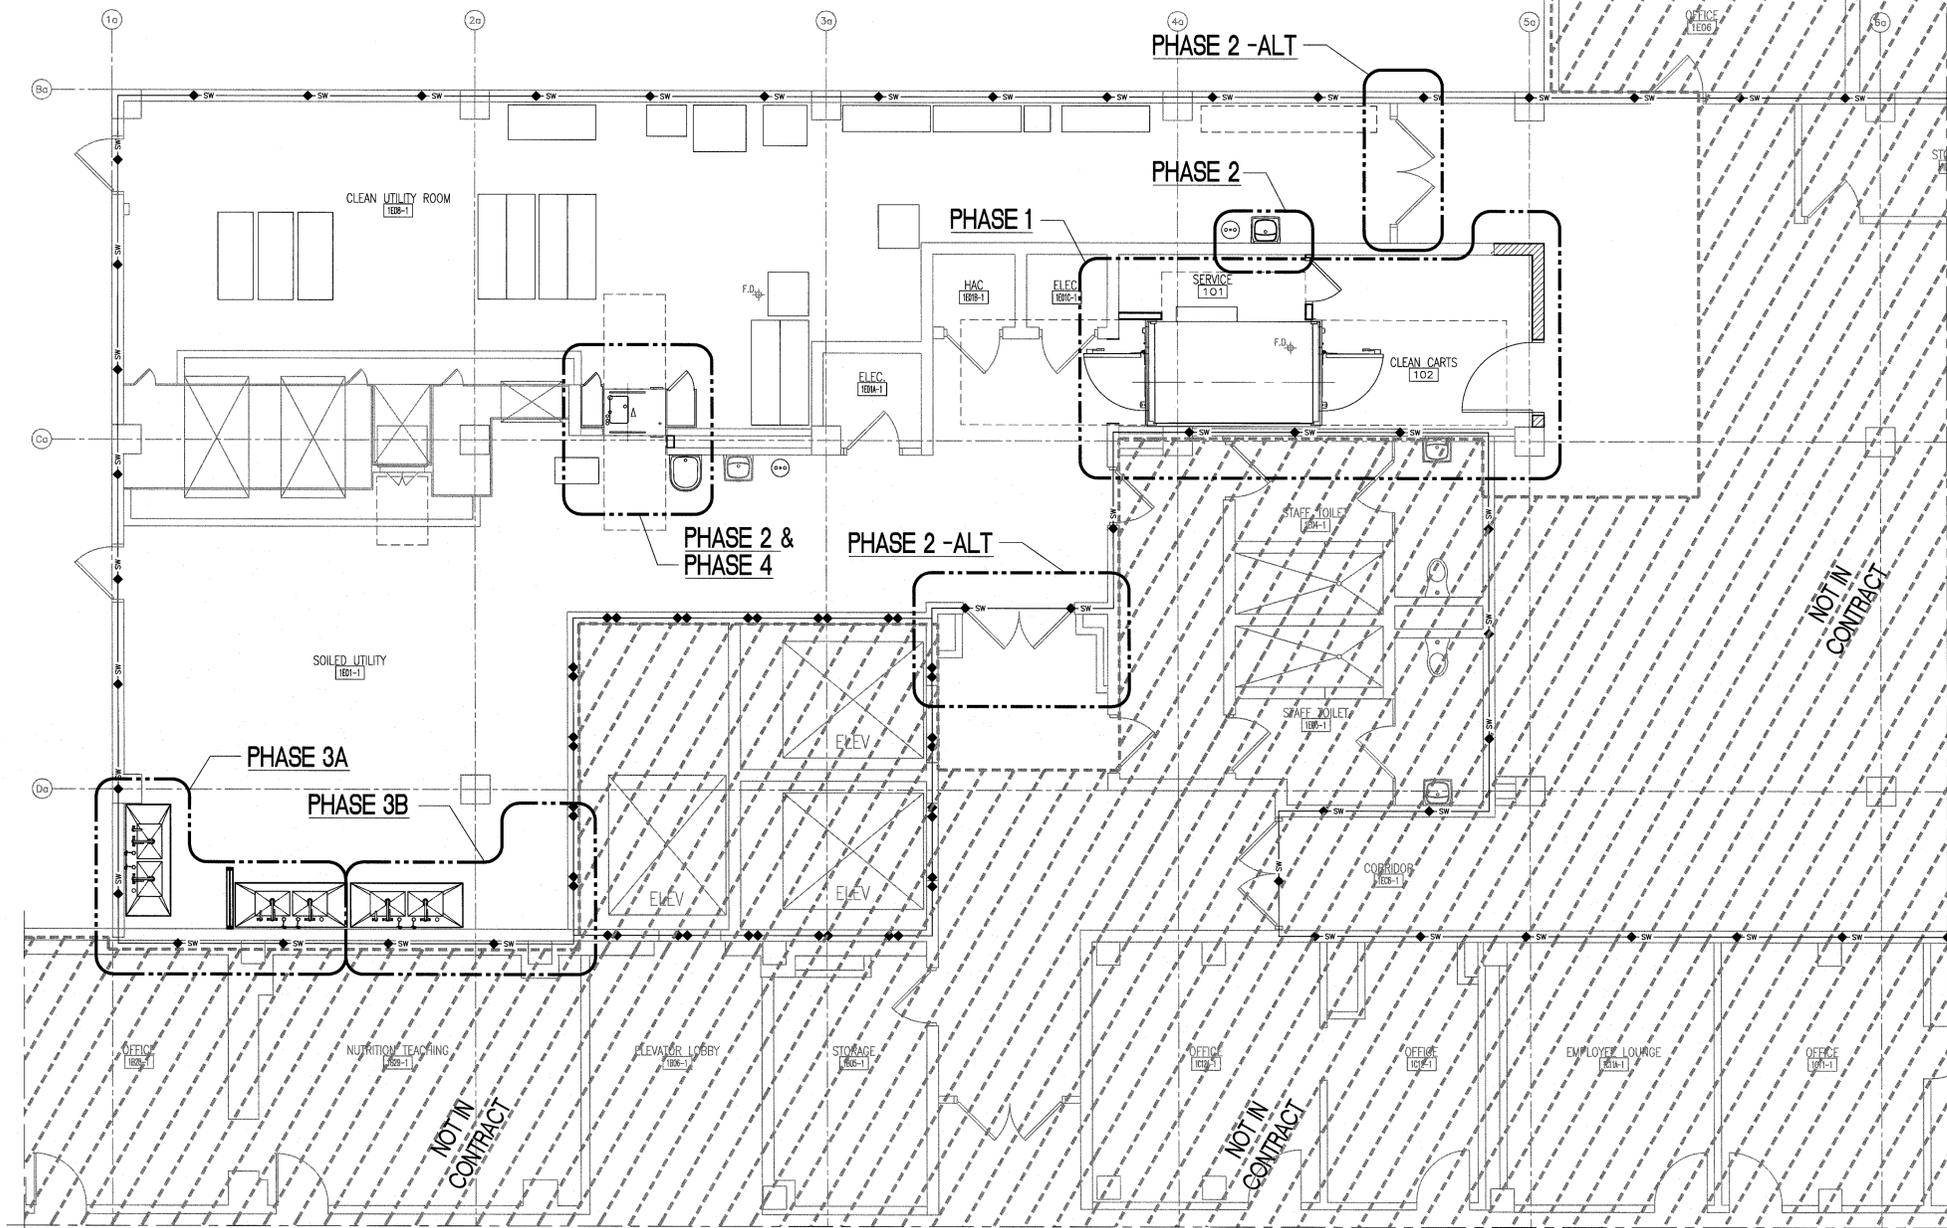


FI FIRST FLOOR PHASING PLAN (1-2)
1/4" = 1'-0"

GENERAL PHASING PLAN NOTES

- A. PHASING PLANS ARE CONCEPTUAL IN NATURE AND DO NOT RELIEVE THE CONTRACTOR OF PREPARING SITE SPECIFIC PHASING PLANS FOR IMPLEMENTATION OF THE CONTRACT DOCUMENTS. (REFER TO SPECIFICATION SECTION 01 00 00, GENERAL REQUIREMENTS.)
- B. PHASING PLANS SHOWN AFFECT WORK TO OCCUR AT THE FIRST FLOOR LEVEL ONLY. WORK INDICATED AT THE THIRD FLOOR LEVEL SHALL BE COORDINATED WITH THE COR TO MINIMIZE IMPACT ON THE VAMC OCCUPANTS AND THE CONTINUED UNINTERRUPTED FUNCTIONING OF THEIR DEPARTMENT. CONTRACTOR WORK IN OCCUPIED AREAS SHALL OCCUR OUTSIDE OF NORMAL VAMC WORKING HOURS (8AM-4:30PM M-F, EXCLUDING FEDERAL HOLIDAYS) UNLESS OTHERWISE COORDINATED WITH VAMC.
- C. CONTRACTOR SHALL ASSUME THE CONTINUED VAMC OCCUPANCY OF AREAS ON THE 1ST FLOOR (IMMEDIATELY) ADJACENT TO AREAS WHERE BOTH DEMOLITION AND NEW CONSTRUCTION WORK IS TO OCCUR.
- D. CONTRACTOR SHALL FULLY COMPLETE THE WORK RELATED AND NECESSARY FOR EACH PHASE REFERENCED AND PROVIDE FOR THE INCREMENTAL OCCUPANCY OF EACH COMPLETED PHASE BY VAMC PRIOR TO BEGINNING INTERRUPTIVE ON-SITE WORK OF THE NEXT CONSECUTIVE PHASE.
- E. COORDINATE ALL SITE PREPARATION WORK WITH EQUIPMENT SUPPLIER(S).
- F. ONCE A PHASE OF WORK HAS BEEN COMPLETED AND OCCUPIED BY VAMC, THE NEXT PHASE OF WORK MAY BEGIN IN EARNEST.
- G. PHASING SHOWN IS IN PRIORITARY ORDER FOR THE FLOOR WHERE SHOWN ONLY. COORDINATE EACH FLOOR'S PHASING WITH C.O.R. BEFORE BEGINNING WORK.
- H. CONTRACTOR SHALL COORDINATE MECHANICAL, ELECTRICAL AND PLUMBING (MEP) WORK INDICATED BY DRAWINGS AND SPECIFICATIONS TO PROVIDE THE FULL EXTENT OF ASSEMBLIES AND SYSTEMS REQUIRED TO PERMIT THE FULL OCCUPANCY OF EACH PHASE OF WORK UPON COMPLETION.
- I. CONTRACTOR IS RESPONSIBLE FOR THE TIMELY COMPLETION OF EACH PHASE OF CONSTRUCTION IN A COMPLETE AND PROFESSIONAL MANNER.
- J. REFER TO INFECTION AND DUST CONTROL PLANS FOR RECOMMENDED TEMPORARY PARTITION LOCATIONS. TEMPORARY PARTITIONS ARE TO BE PLACED ONLY PER INDIVIDUAL PHASES SHOWN.
- K. REFER TO DEMOLITION AND NEW FLOOR PLANS FOR ARCHITECTURAL, MECHANICAL AND PLUMBING WORK INVOLVED WITH EACH PHASE INDICATED UNLESS OTHERWISE NOTED.
- L. REFER TO SPECIFICATION SECTION 010000, FOR ALTERNATES.

PHASING PLAN NOTES

- EACH PHASE**
- CONSTRUCT DUST PARTITIONS REQUIRED FOR EACH PHASE INDICATED.
 - EXTEND EXISTING (ABANDONED) ETO EXHAUST TO DUST PARTITION ENCLOSURE TO PROVIDE NEGATIVE AIR PRESSURE WITHIN THE DUST PARTITION ENCLOSURE. (COORDINATE WITH MECHANICAL CONTRACTOR.)
 - INSTALL CONTINUOUS AIR PRESSURE MONITORING SYSTEM.
 - ACTIVATE EXHAUST SYSTEM.
 - COORDINATE TO PROVIDE ALL ASSOCIATED WORK REFERENCED BY MEP PLANS PER PHASE OF WORK INDICATED BY PHASING PLANS.
 - REMOVE DUST PARTITIONS AT COMPLETION OF EACH PHASE UNLESS OTHERWISE NOTED.
- PHASE 1:**
- DEMO EXISTING CONDITIONS REQUIRED AND CONSTRUCT NEW TO PROVIDE FOR INSTALLATION OF VAMC FURNISHED CART WASH EQUIPMENT.
 - MODIFY EXISTING CONCRETE SLAB TO CONSTRUCT NEW RECESSED PIT FOR CART WASH EQUIPMENT.
 - CONSTRUCT NEW CMU WALL WITH DOOR AT (PLAN) NORTH END OF 'CLEAN CARTS' - ROOM 102.
 - MODIFY EXISTING MECHANICAL ROOM (ABOVE) TO PROVIDE REQUIRED SERVICES FOR CART WASH EQUIPMENT.
 - CONSTRUCT NEW ROOF PENETRATION AND INFILL CONSTRUCTION ASSOCIATED WITH MECHANICAL ROOM MODIFICATIONS (ABOVE).
- 'PHASE 1' DUST PARTITIONS SHALL REMAIN IN PLACE UNTIL ALL WORK ASSOCIATED WITH THE PHASE, INCLUDING INSTALLATION, IS COMPLETED. MULTIPLE PARTITIONS SHALL BE REQUIRED IF PHASES ARE CONCURRENT PER VA APPROVAL.
- PHASE 2:**
- DEMO EXISTING CONDITIONS REQUIRED AND CONSTRUCT NEW TO PROVIDE FOR INSTALLATION OF RELOCATED HAND WASHING SINK AND VAMC FURNISHED ACCESSORIES (SOAP AND PAPER TOWEL DISPENSER).
 - PATCH FINISHES WHERE SINK WAS REMOVED TO MATCH EXISTING.
- PHASE 2-ALT: (DEDUCTIVE ALTERNATE 2 - REFER TO SPECIFICATION SECTION 087113, AUTOMATIC DOOR OPERATORS)**
- DEMO EXISTING CONDITIONS REQUIRED AND CONSTRUCT NEW TO PROVIDE FOR INSTALLATION OF NEW AUTOMATIC DOOR OPENERS FOR EXISTING DOORWAYS SHOWN INCLUDING ELECTRICAL POWER, MOTION DETECTORS, SAFETY SYSTEMS AND ASSOCIATED CARD READERS.
- PHASE 3A:**
- DEMO 1 OF 2 EXISTING PROCESSING SINKS, COUNTERS AND ASSOCIATED CONSTRUCTION AND ACCESSORIES. PROVIDE TEMPORARY SUPPORT AS REQUIRED FOR EXISTING PROCESSING SINK AND ACCESSORIES TO REMAIN FULLY FUNCTIONAL.
 - DEMO CONDITIONS REQUIRED AND CONSTRUCT NEW TO PROVIDE FOR INSTALLATION OF 2 NEW 2-BASIN ADJUSTABLE HEIGHT PROCESSING SINKS (FURNISHED BY CONTRACTOR).
 - PATCH FINISHES WHERE SINKS ARE REMOVED TO MATCH EXISTING.
 - INSTALL FULL HEIGHT HOLLOW METAL METAL FRAME WITH VIEW WINDOW (9/AE601).
- PHASE 3B:**
- DEMO 1 EXISTING PROCESSING SINK, COUNTERS AND ASSOCIATED CONSTRUCTION.
 - DEMO CONDITIONS REQUIRED AND CONSTRUCT NEW TO PROVIDE FOR INSTALLATION OF 1 NEW 2-BASIN ADJUSTABLE HEIGHT PROCESSING SINKS (FURNISHED BY CONTRACTOR).
 - PATCH FINISHES WHERE SINK WAS REMOVED TO MATCH EXISTING.
- PHASE 4:**
- DEMO CONDITIONS REQUIRED AND CONSTRUCT NEW TO PROVIDE FOR INSTALLATION OF NEW INSTRUMENT WASHER EQUIPMENT (FURNISHED BY VAMC) AND RELOCATE EXISTING HOPPER SINK AS INDICATED.
 - INSTALL NEW FINISHES INDICATED WITHIN THE SCOPE OF WORK UNDERTAKEN INCLUDING NEW STAINLESS STEEL WALL PANELS.

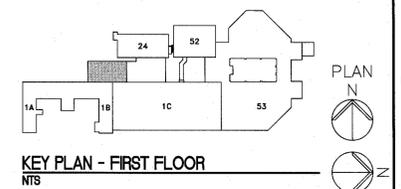

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	Location JACK C. MONTGOMERY VAMC <small>101 HONOR HEIGHTS DRIVE, MUSKOGEE, OK</small>	Building Number 1	Date 03/10/2015	Checked WFW	Drawn BLM	