











- ## VENTILATION NOTES:
- A. CONTRACTOR SHALL VERIFY ALL EXISTING CONDITIONS PRIOR TO BEGINNING WORK AND NOTIFY THE ARCHITECT/ENGINEER OF ANY DISCREPANCIES BETWEEN "AS-BUILT" CONDITIONS AND THESE DRAWINGS.
 - B. COORDINATE ALL DUCTWORK INSTALLATION WITH MECHANICAL, ELECTRICAL, AND PLUMBING INSTALLATIONS. ALL DUCTWORK AS HIGH AS POSSIBLE. PROVIDE ALL NECESSARY OFFSETS (DROPS) NEEDED TO RUN DUCTWORK TIGHT TO THE STRUCTURE ABOVE. OFFSET DUCTWORK TO AVOID BEAMS.
 - C. REFER TO AND COORDINATE WITH THE ARCHITECTURAL PLANS FOR CEILING TYPES, HEIGHTS, SOFFIT AREAS, AND ELEVATIONS FOR INSTALLATION OF NEW VENTILATION DUCTWORK, EQUIPMENT, ETC.
 - D. THIS CONTRACTOR IS RESPONSIBLE FOR REMOVAL AND RE-INSTALLING OF EXISTING CEILING TILE NOT BEING USED FOR GENERAL CEILING. PROVIDE FOR THE INSTALLATION OF NEW VENTILATION DUCTWORK, EQUIPMENT, ETC. VERIFY WITH ARCHITECTURAL PLANS FOR LOCATION FOR THE EXISTING CEILING. REMOVE ANY CEILING TILE OR GRID DAMAGED DURING CONSTRUCTION. SHALL BE REPLACED WITH NEW BY THIS CONTRACTOR.
 - E. THIS CONTRACTOR SHALL OPEN ALL EXISTING WALLS AND/OR CEILINGS FOR INSTALLATION OF NEW VENTILATION DUCTWORK, EQUIPMENT, ETC. AS REQUIRED. PATCH WALLS AND/OR CEILINGS TO MATCH EXISTING.
 - F. MAINTAIN "3" CLEAR SPACE IN FRONT OF ALL ELECTRICAL, CONTROL, AND ACCESS PANELS FOR ACCESSIBILITY.
 - G. ALL DAMPERS, ETC., SHALL BE INSTALLED IN ACCESSIBLE CEILINGS.
 - H. ALL OPEN ENDS OF DUCTS SHALL BE CAPPED AT THE END OF CONSTRUCTION EACH DAY.
 - I. MECH. CONTRACTOR TO RE-BALANCE ALL AIR TERMINALS, EXHAUSTERS, INDUCED DRAFTERS, ETC. AFTER RE-BALANCING REPORT PROVIDED PRIOR TO DEMOLITION OF (C) DIFFUSERS/GRILLES.
 - J. REPAIR ALL DUCTWORK DAMAGED DURING CONSTRUCTION & AFTER ALL TEMPORARY WORK HAS BEEN COMPLETED.
1. RE-BALANCE EXISTING VAV/FAN-CO. DIFFUSERS, & GRILLES ACCORDING TO MECHANICAL AIR FLOWS AS SCHEDULED.
 2. ROUTE 4" DUCT TO SUPPLY MAIN IN ROOM 213. BALANCE AIR FLOWS TO EACH EXISTING EXACT LOCATION OF EXISTING SUPPLY AIR DUCT.



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100	STORAGE

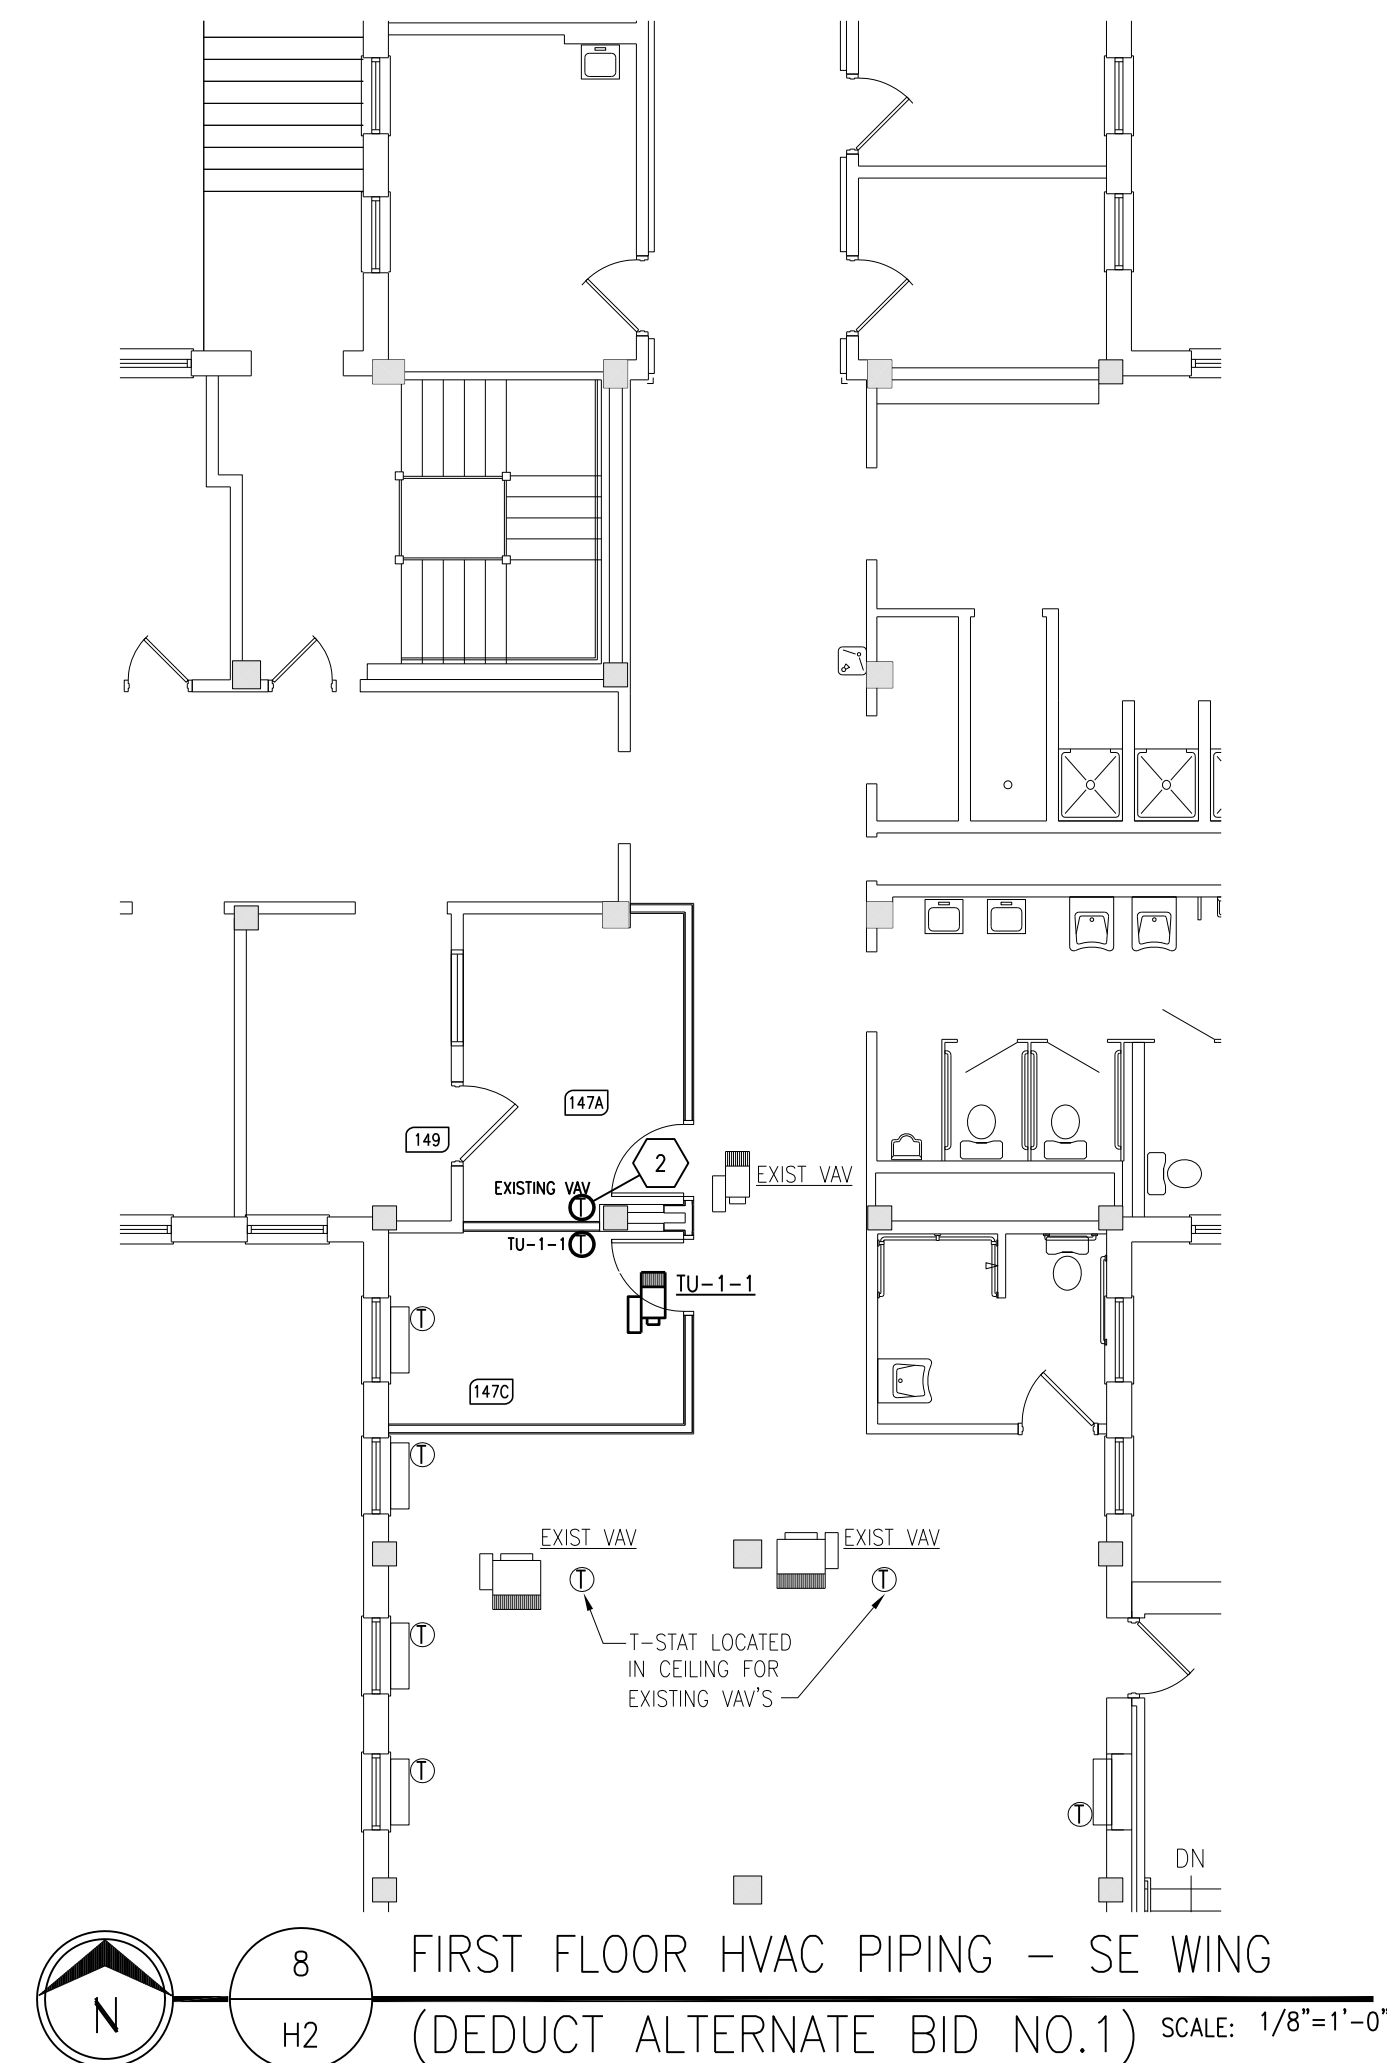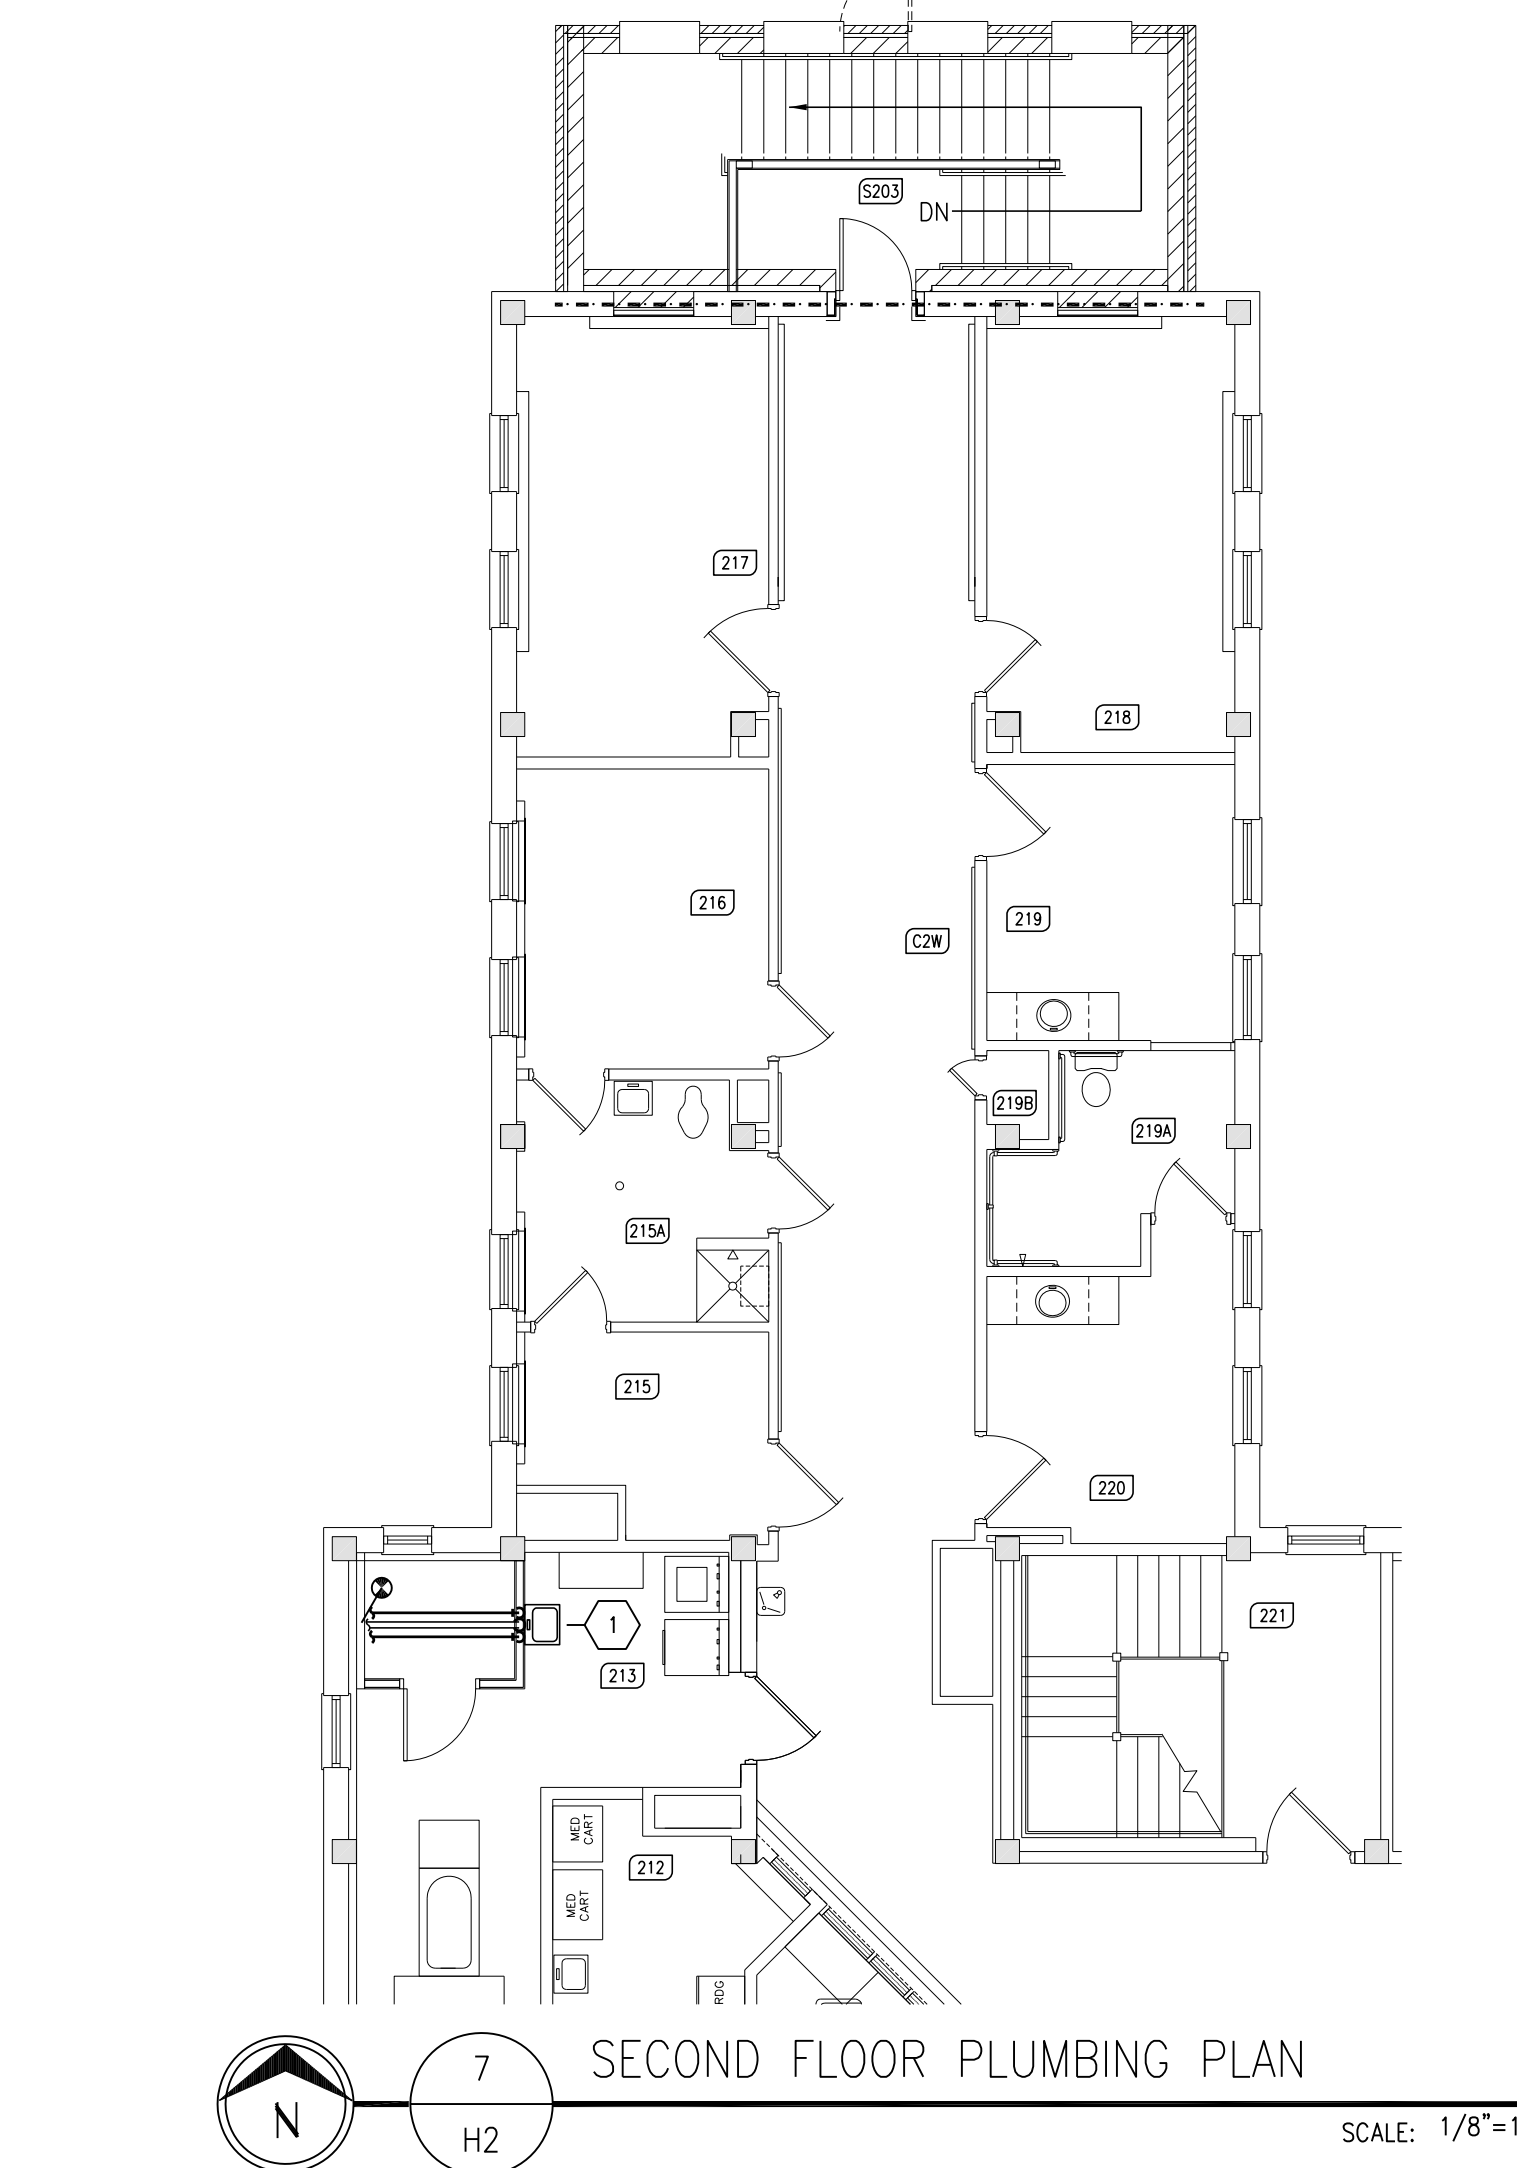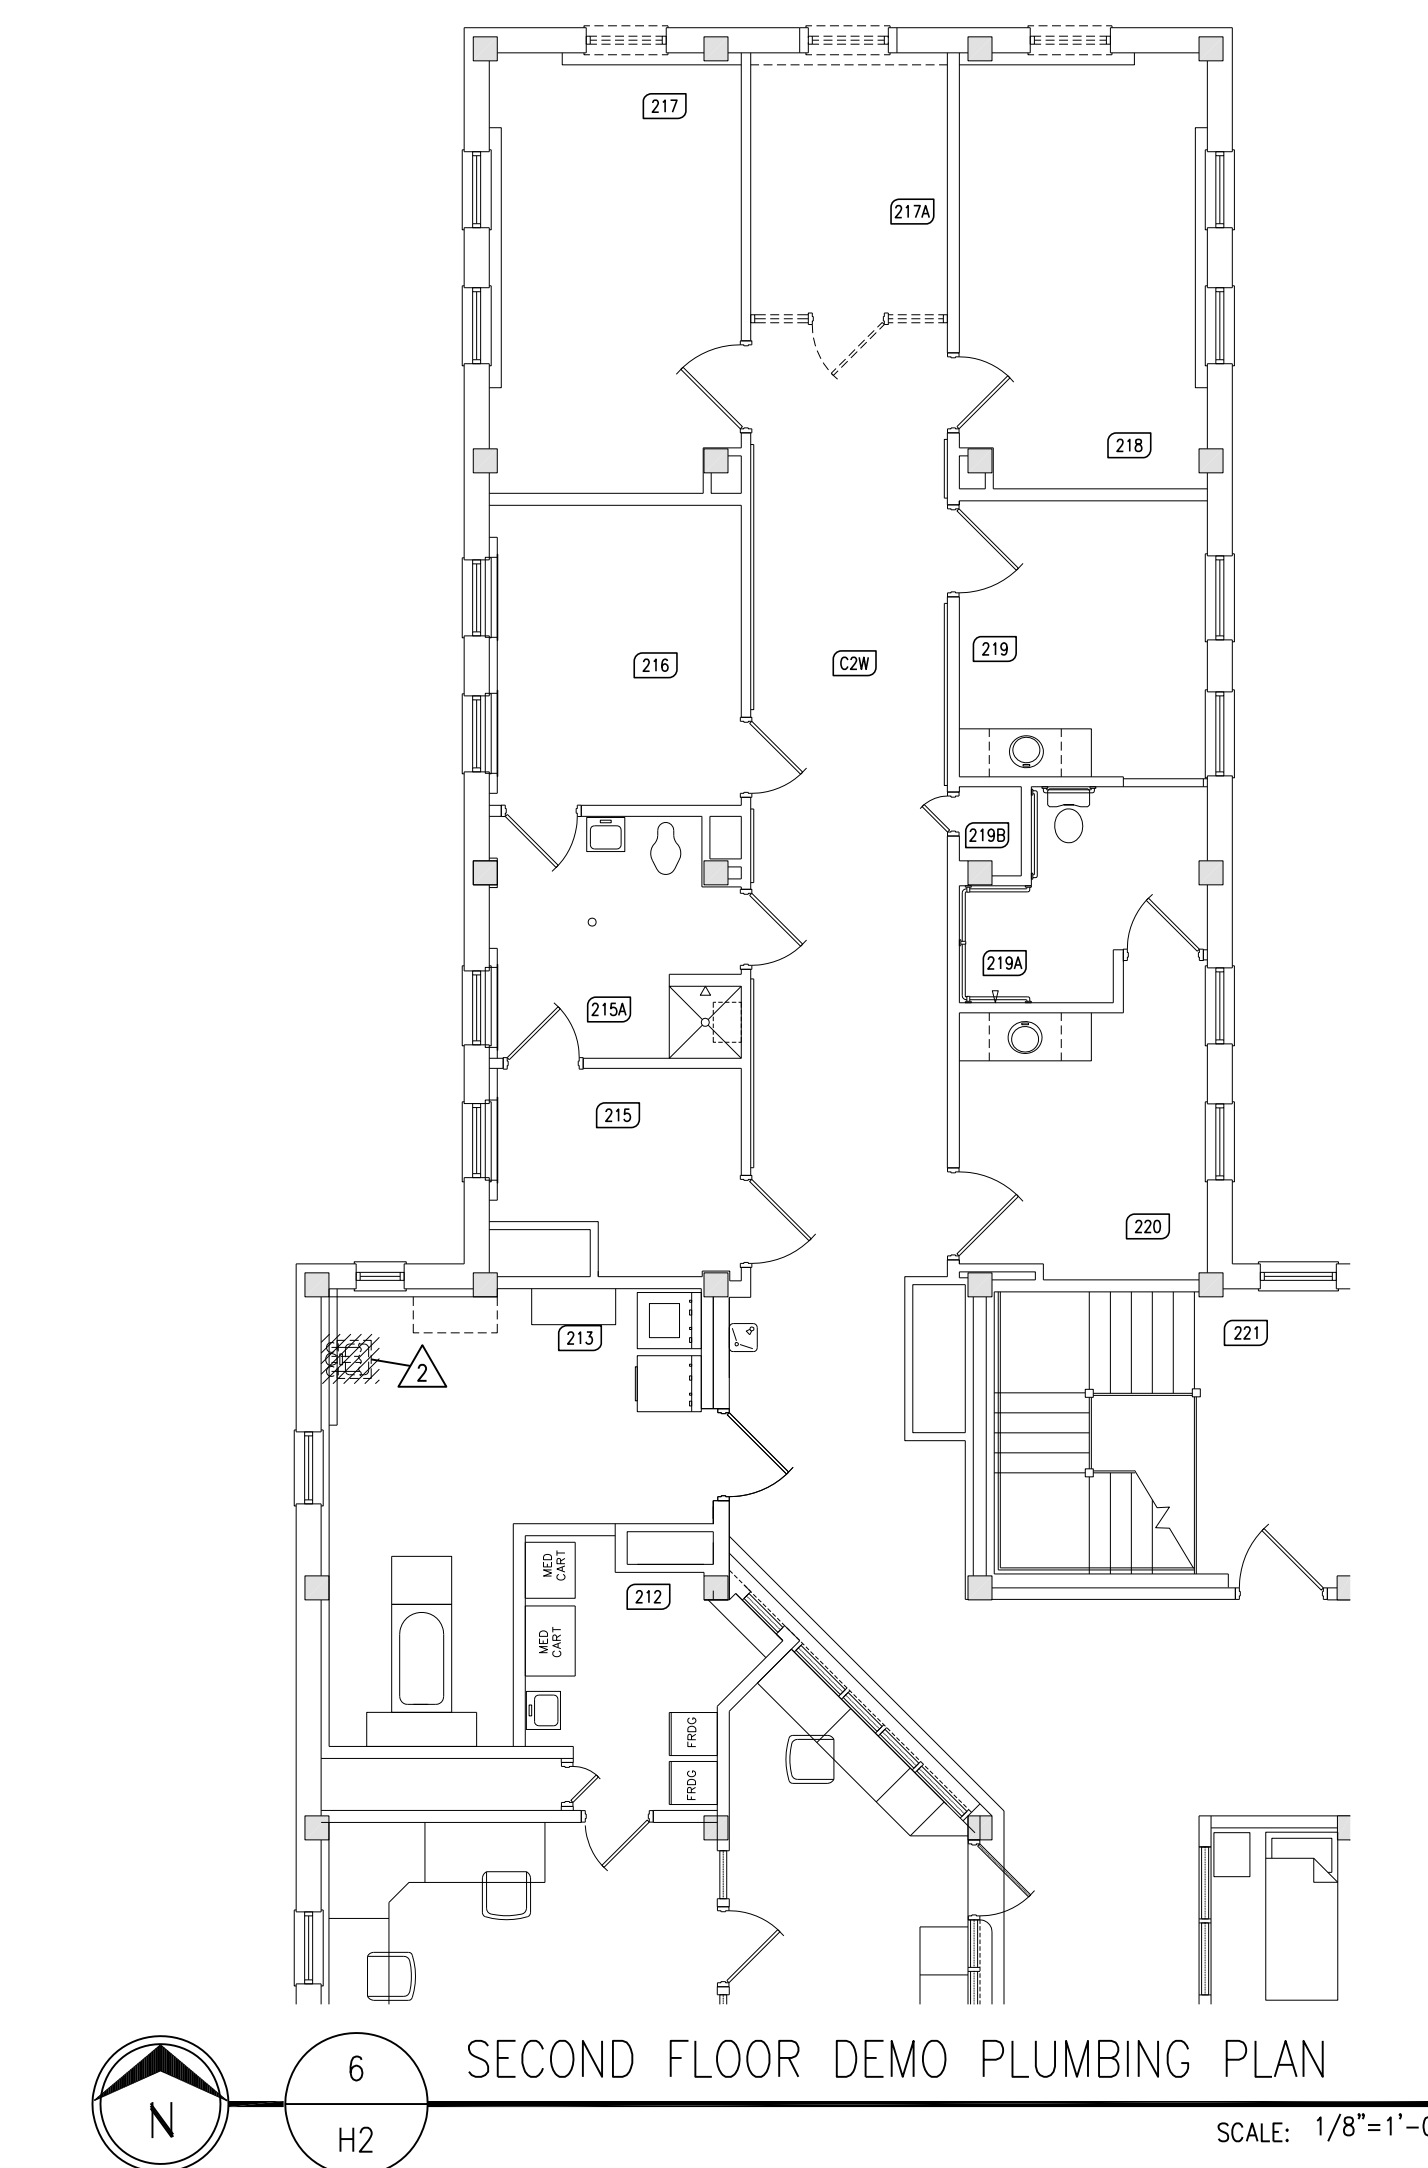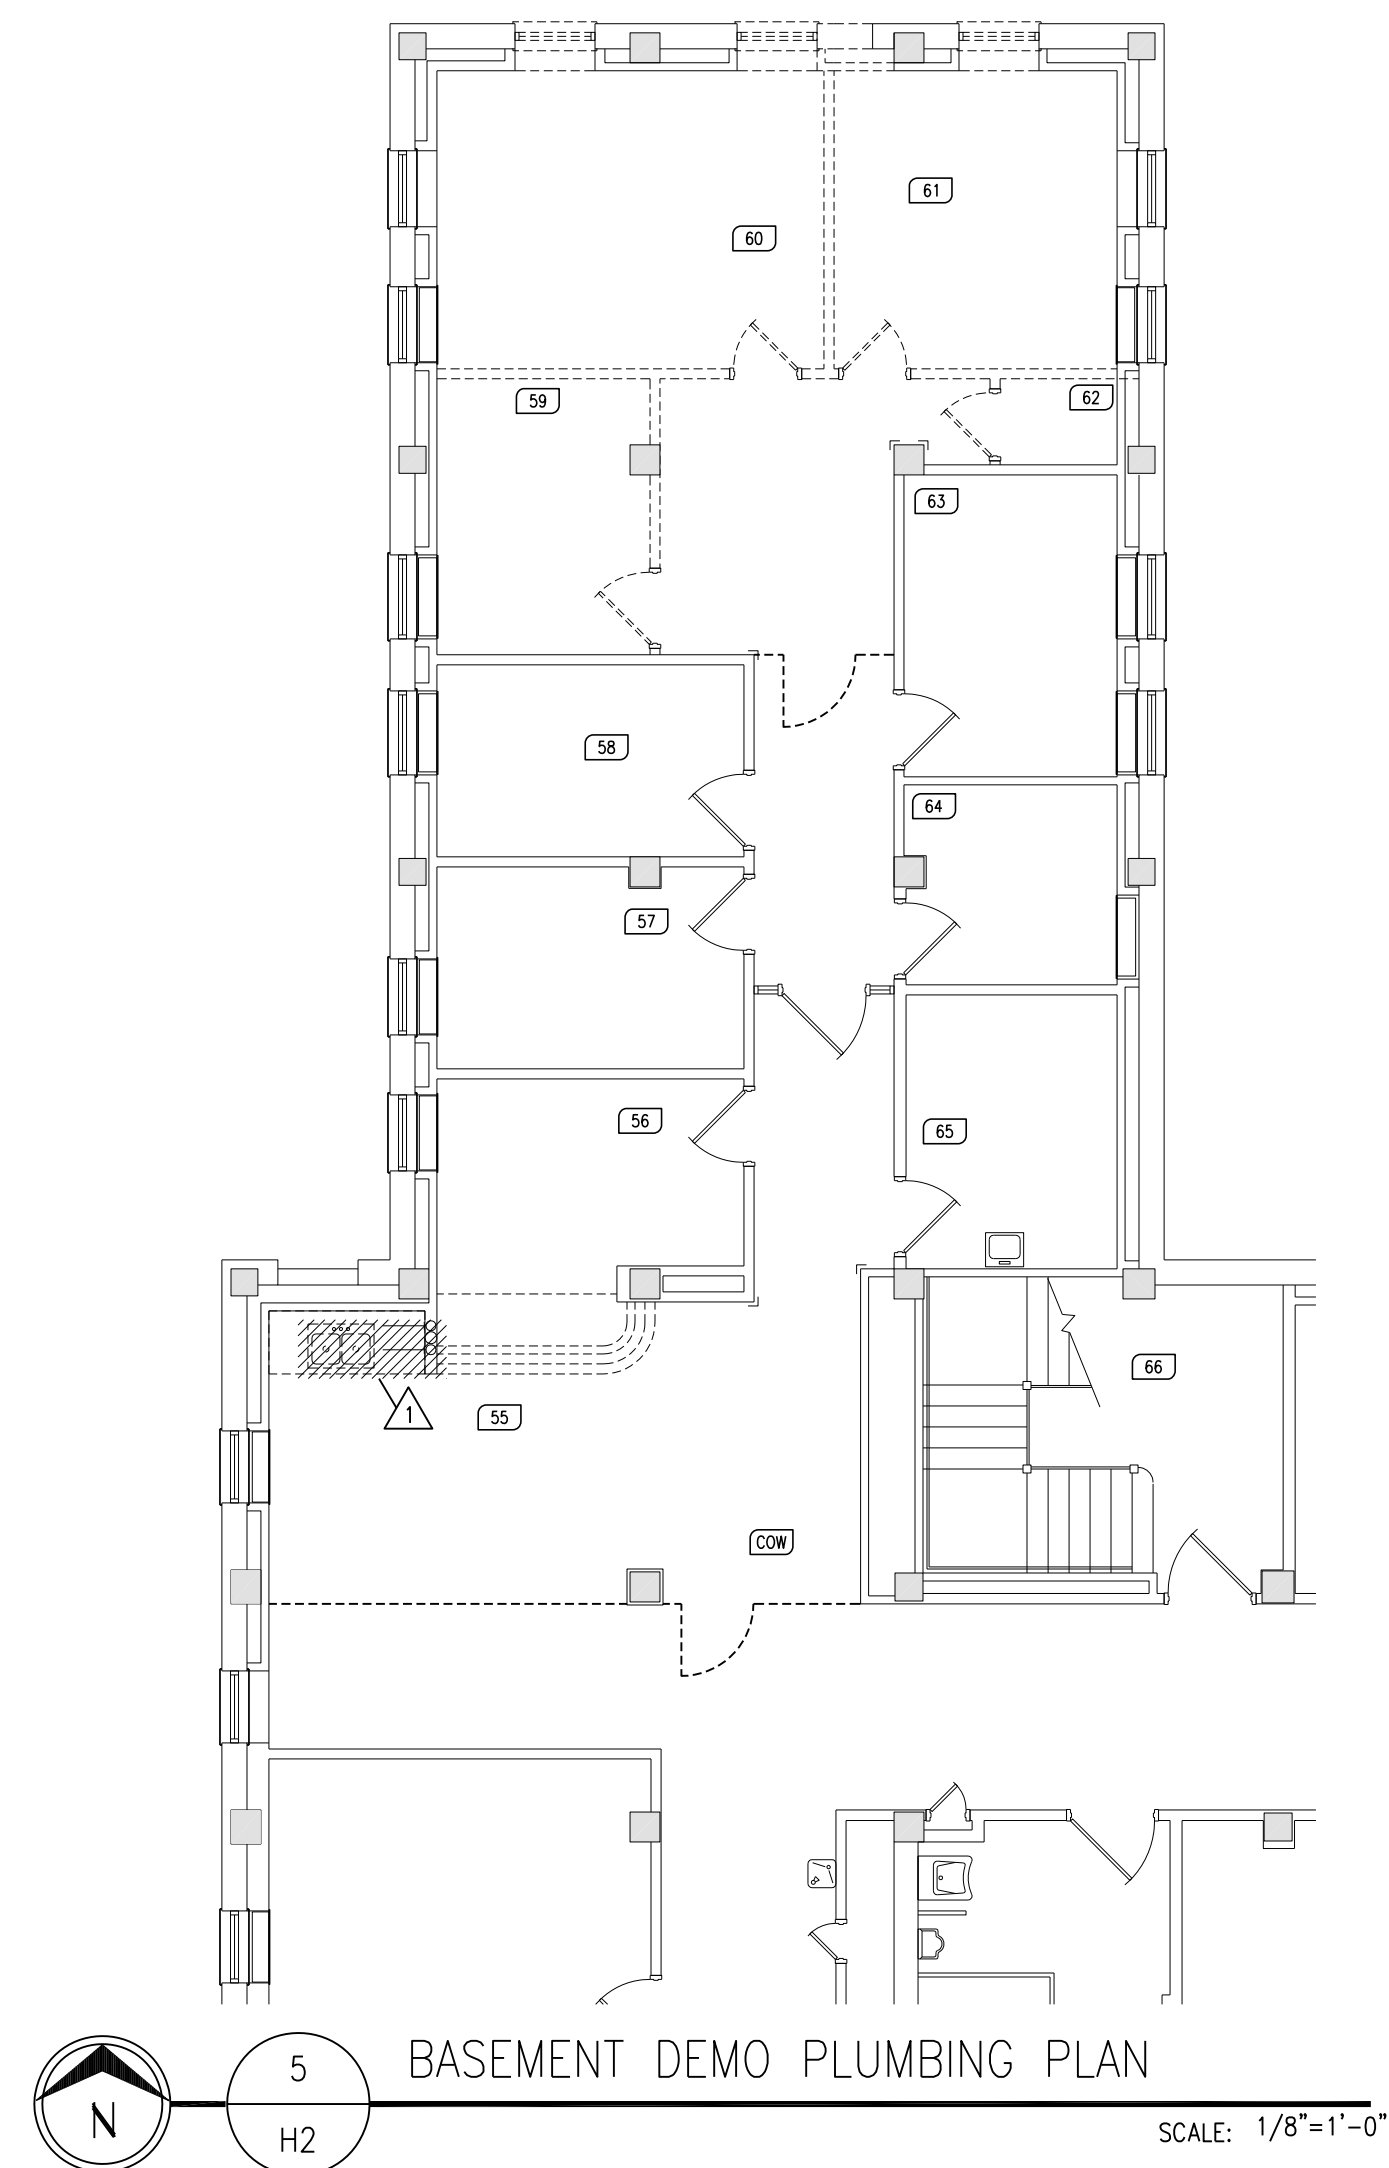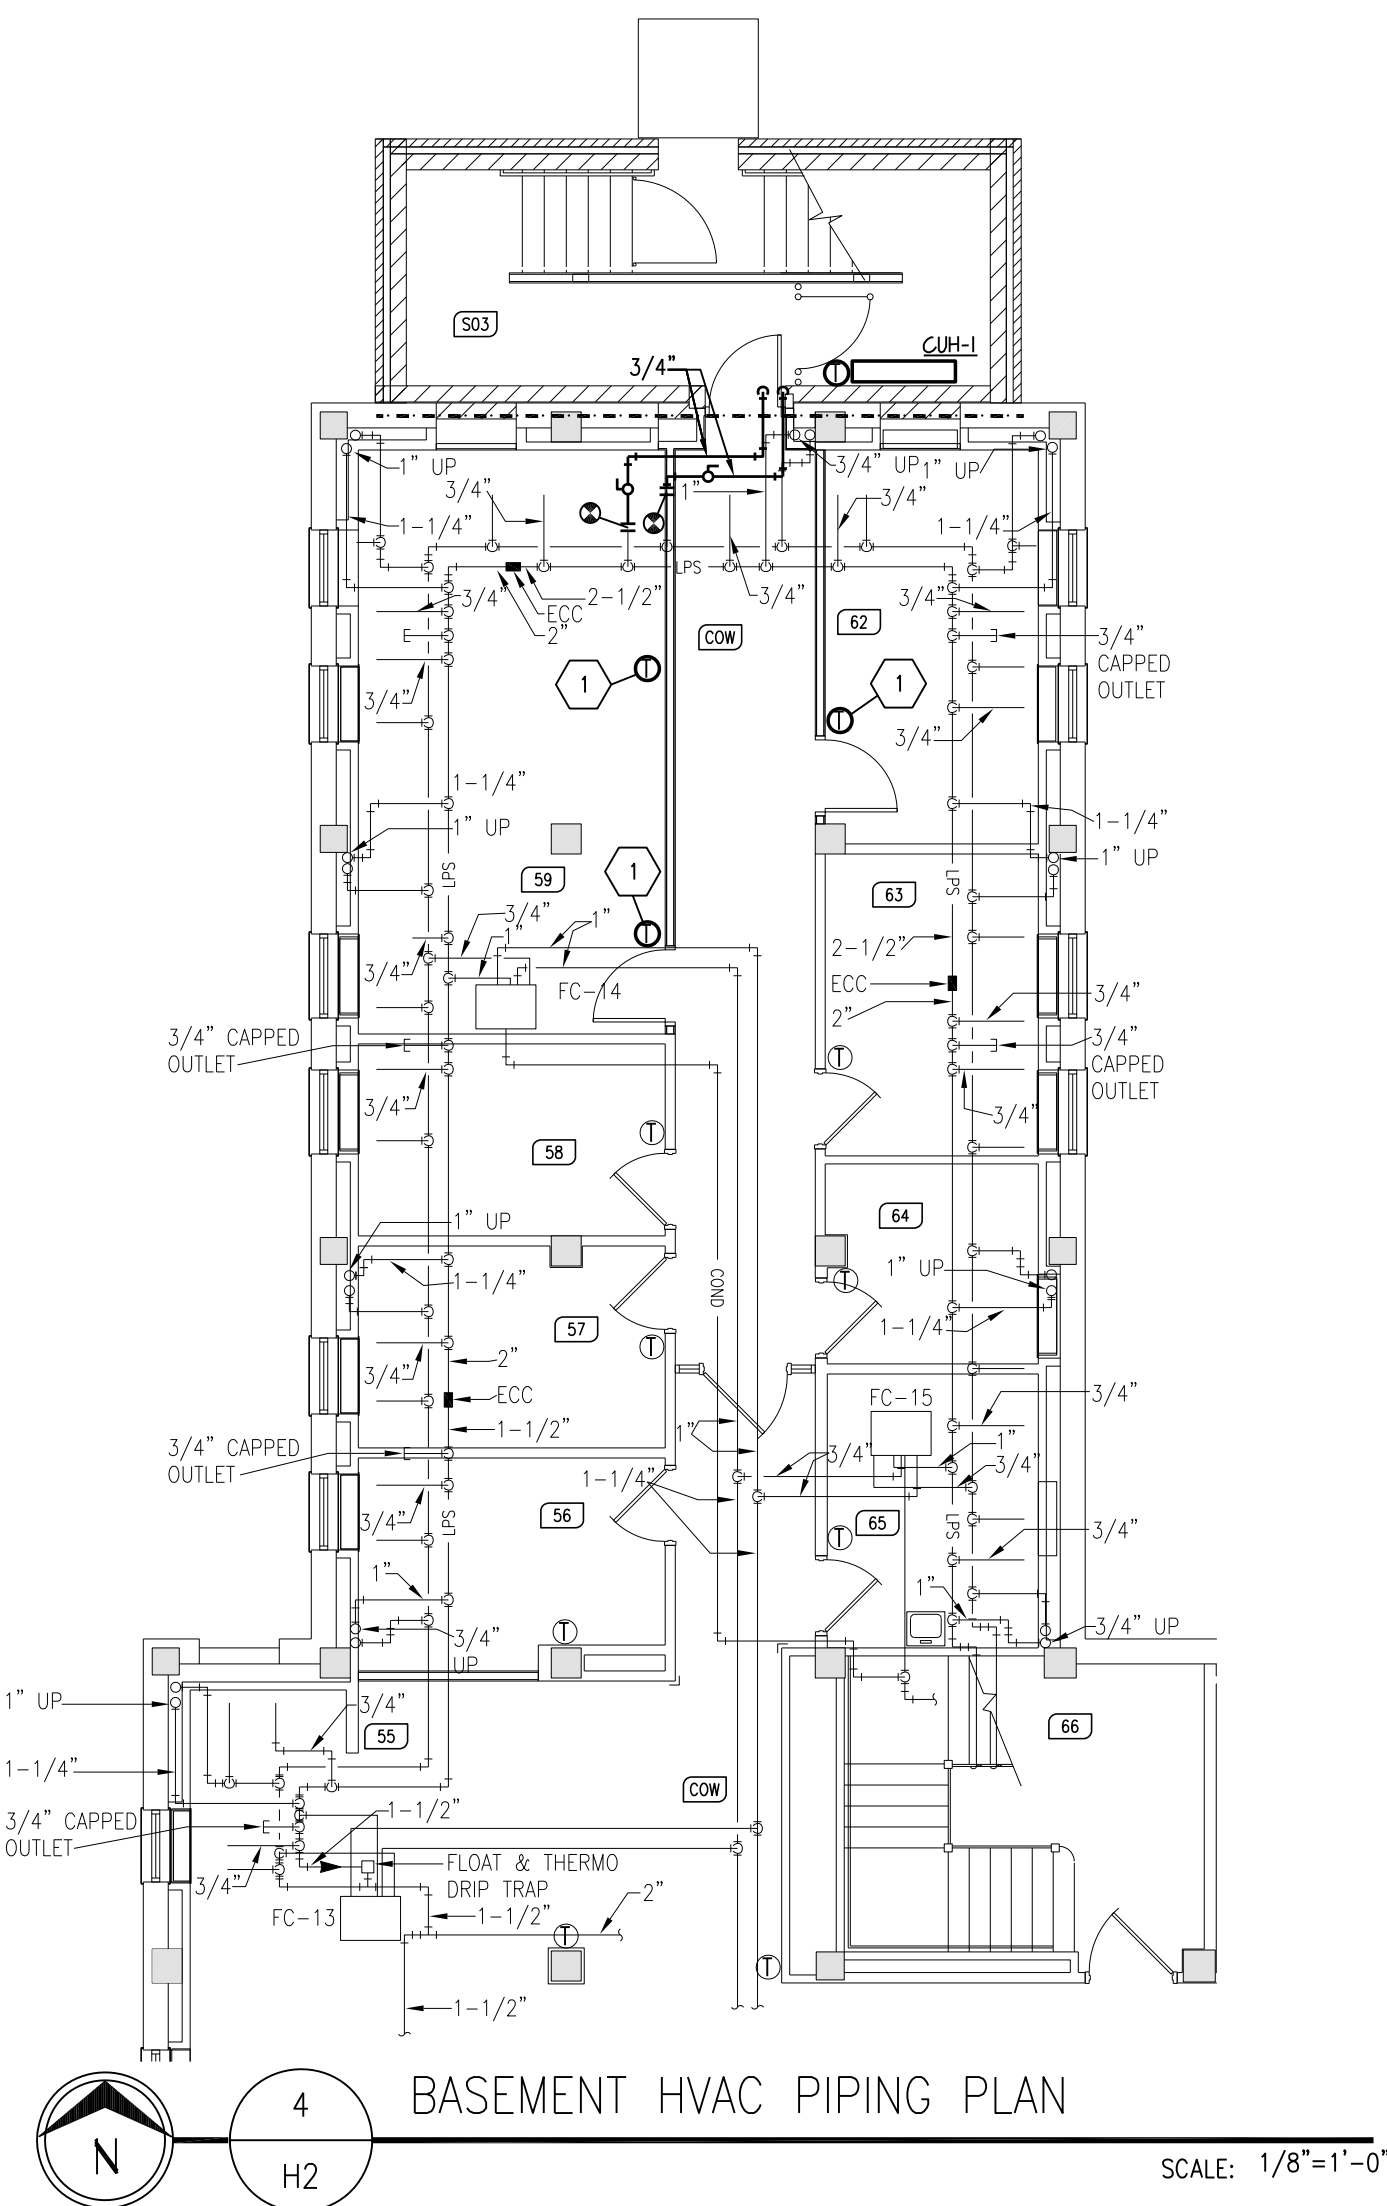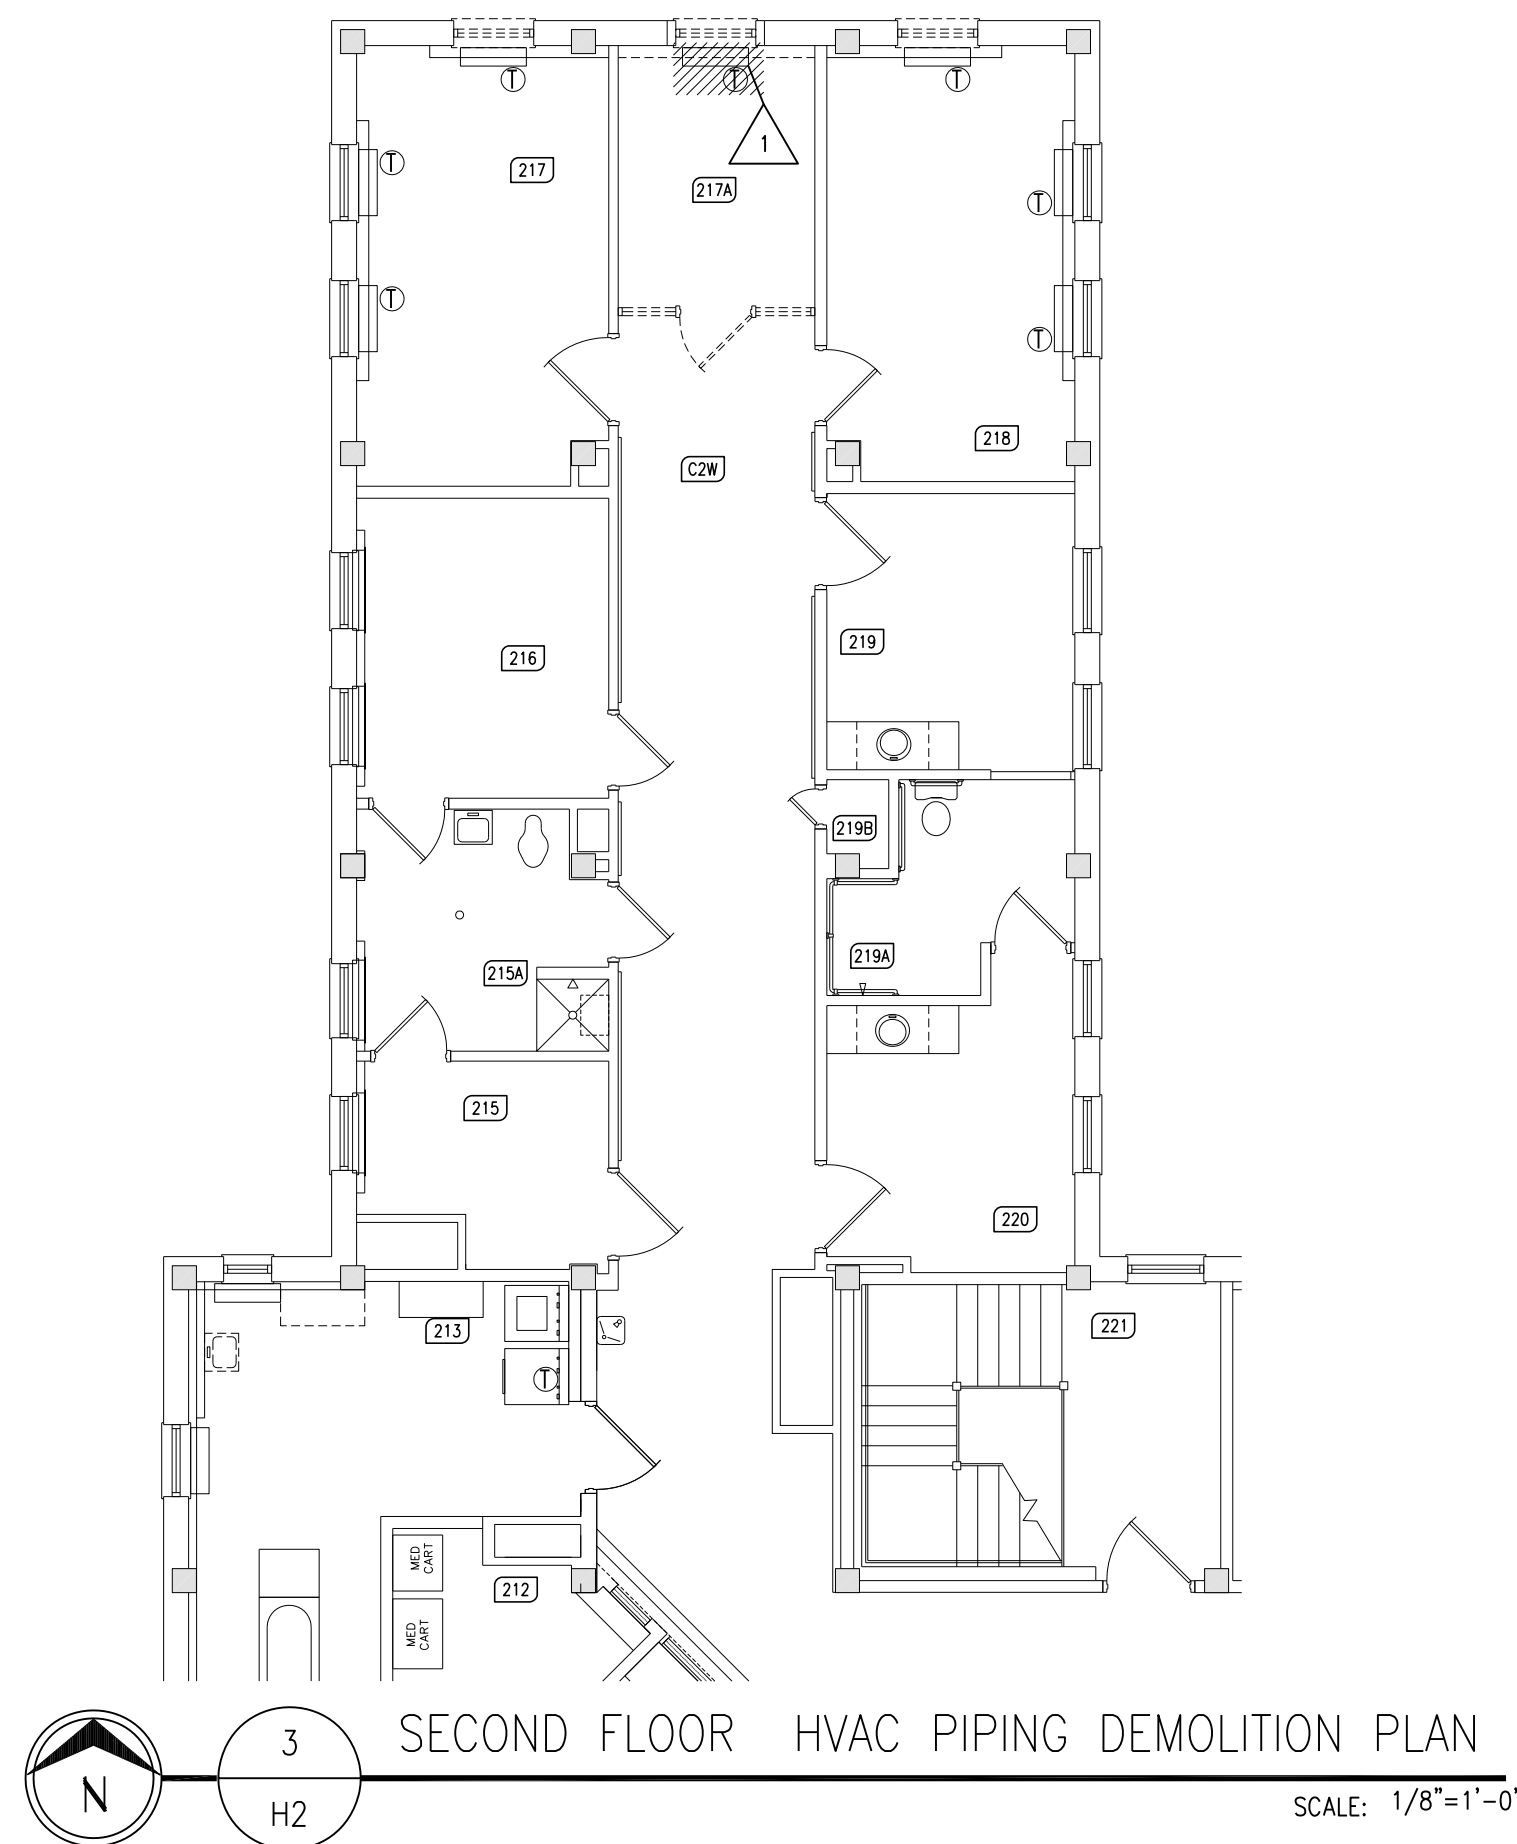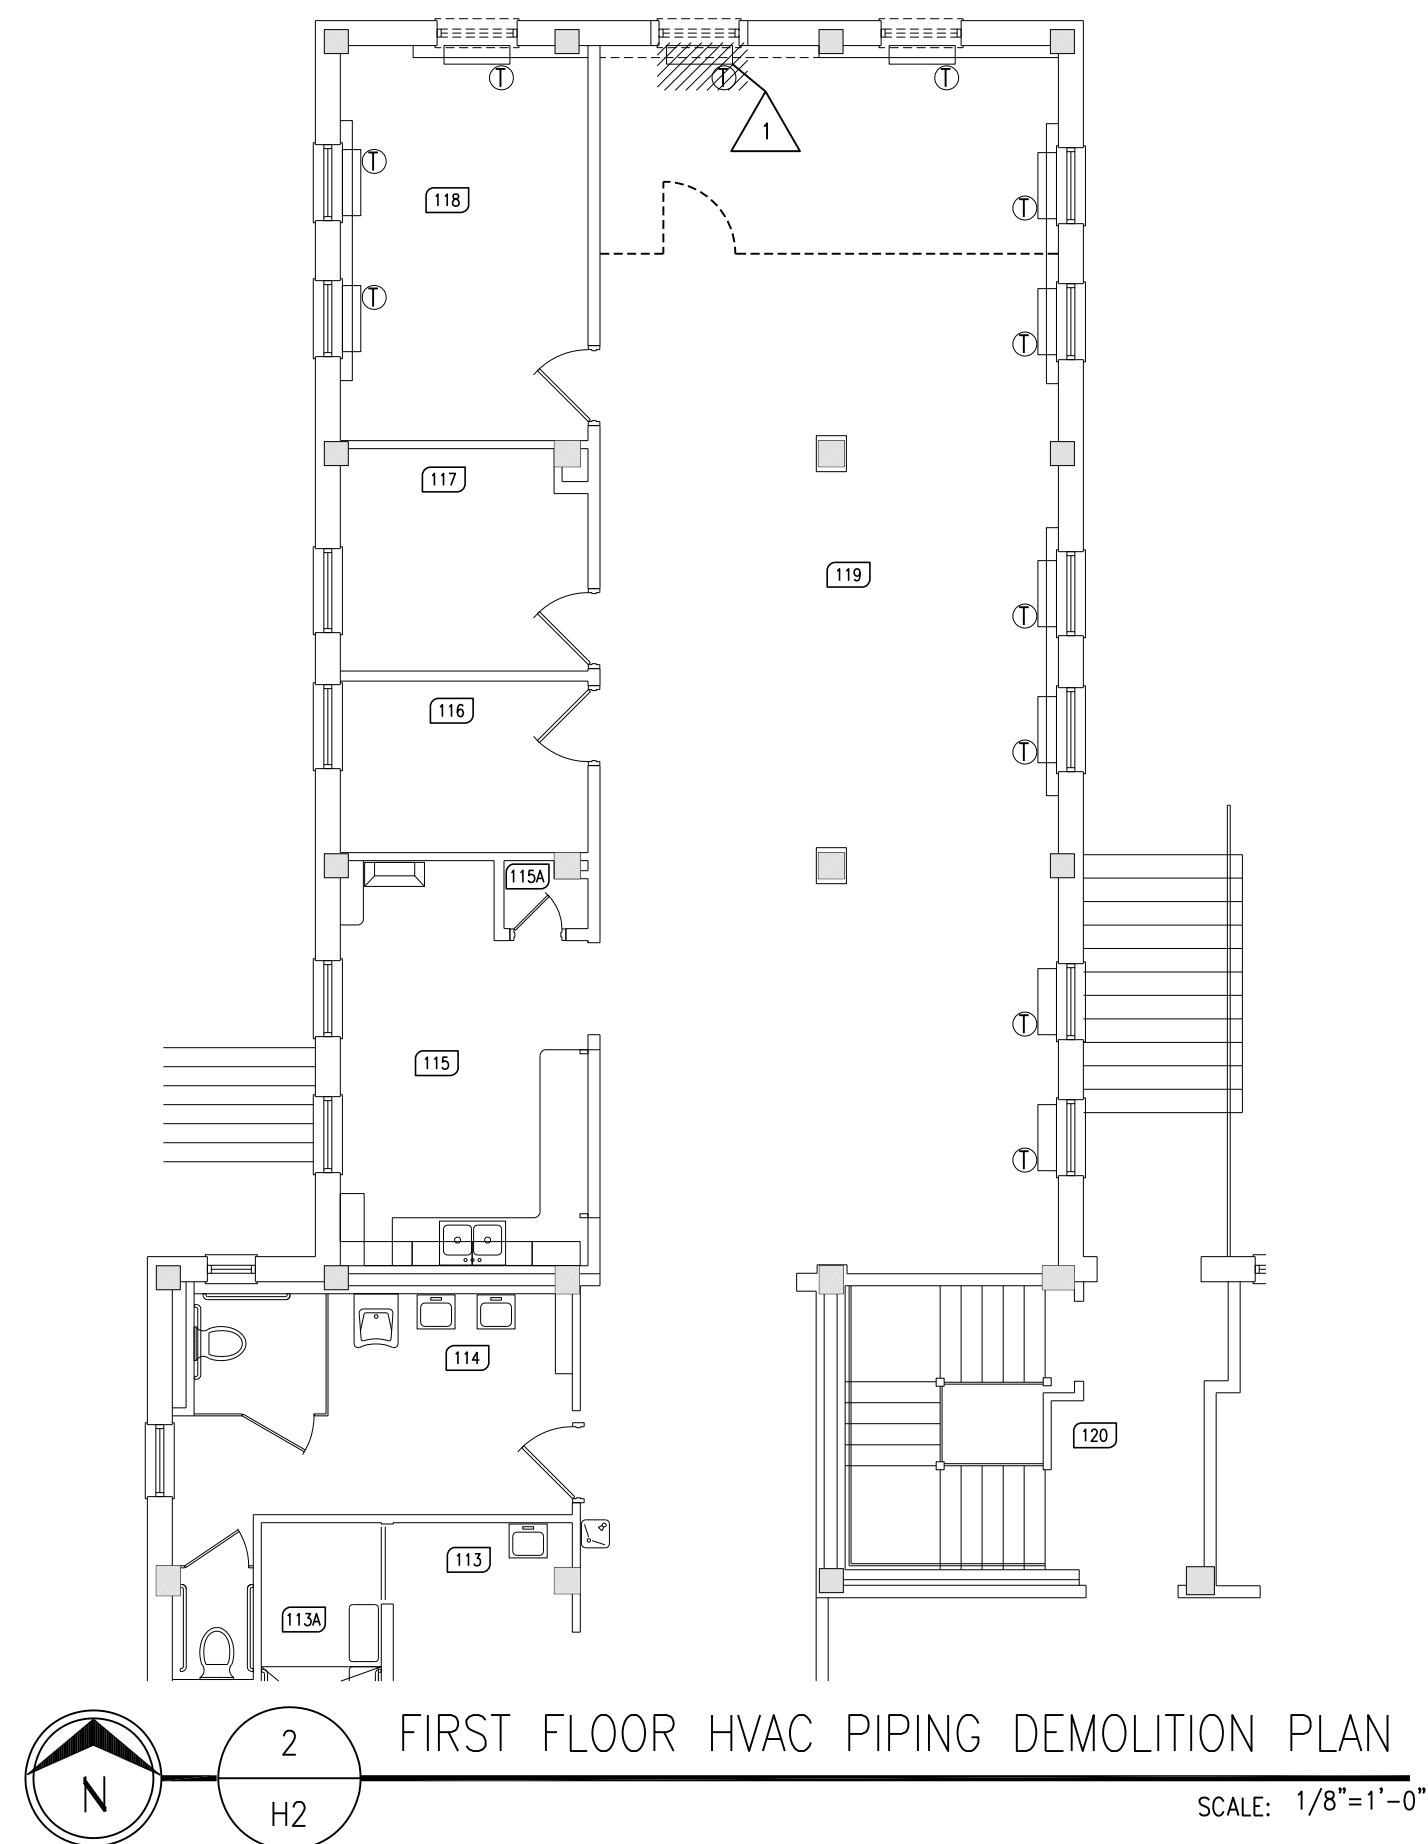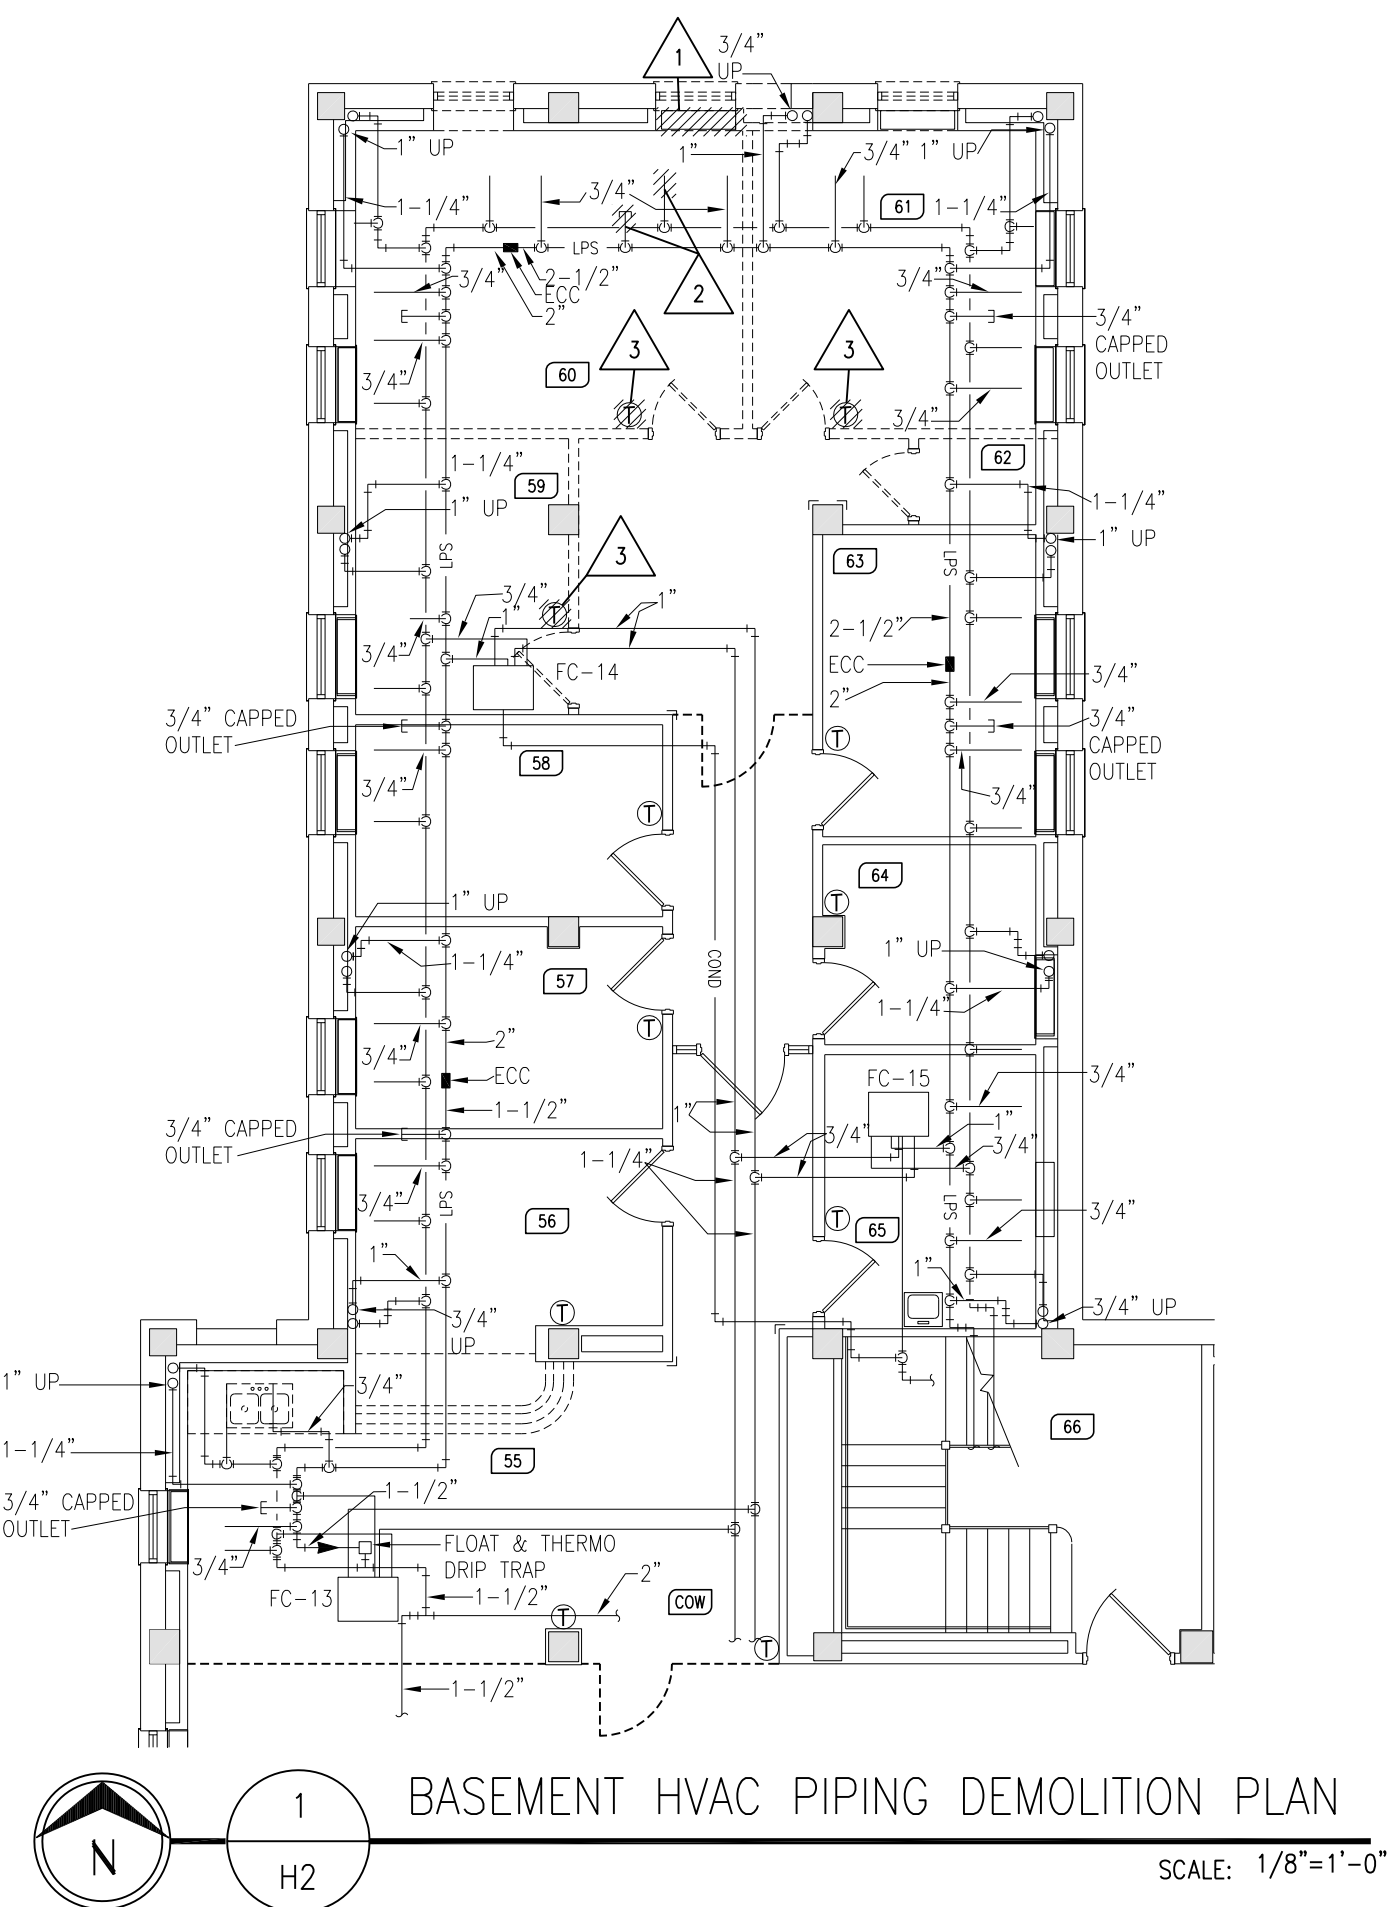

PLUMBING DEMOLITION NOTES:

- DEMOLITION DRAWINGS ARE DIAGRAMMATIC ONLY AND ARE BASED ON FIELD OBSERVATION AND EXISTING RECORD DRAWINGS. CONTRACTOR SHALL VERIFY ALL EXISTING CONDITIONS PRIOR TO BEGINNING WORK AND NOTIFY THE ARCHITECT/ ENGINEER OF ANY DISCREPANCIES BETWEEN THE "AS-BUILT" CONDITIONS AND THESE DRAWINGS.
 - THIS CONTRACTOR IS RESPONSIBLE FOR REMOVAL AND RE-INSTALLING OF EXISTING CEILING TILE NOT REMOVED BY THE GENERAL CONTRACTOR FOR THE DEMOLITION OF EXISTING PLUMBING PIPING, EQUIPMENT, ETC. VERIFY WITH ARCHITECTURAL PLANS FOR CEILING WORK BY THE GENERAL CONTRACTOR. ANY CEILING TILE OR GRID DAMAGED DURING CONSTRUCTION SHALL BE REPLACED WITH NEW BY THIS CONTRACTOR.
 - THIS CONTRACTOR SHALL OPEN ALL WALLS AND/OR CEILINGS FOR DEMOLITION OF EXISTING PLUMBING PIPING, EQUIPMENT, ETC. AS REQUIRED.
 - THIS CONTRACTOR IS RESPONSIBLE FOR PATCHING ALL HOLES/WALLS AND/OR CEILINGS FROM DEMOLISHED PLUMBING PIPING, EQUIPMENT, ETC. IN FLOORS, WALLS, AND CEILINGS TO MATCH EXISTING.
 - PLUMBING DEMOLITION FOR FLOOR CUTTING IS DIAGRAMMATIC ONLY. CONTRACTOR TO VERY EXISTING INVERTS AND DEPTH OF PIPING PRIOR TO FLOOR CUTTING AND TRENCHING.
- ⚠️ DISCONNECT AND REMOVE EXISTING SINK, CAP VENT AND DOMESTIC PIPING ABOVE CEILING, CAP WASTE BELOW FLOOR.
- ⚠️ DISCONNECT AND REMOVE EXISTING SINK, CAP VENT PIPING ABOVE CEILING, CAP WASTE AND DOMESTIC PIPING BELOW FLOOR. PREPARE PIPING TO BE EXTENDED TO NEW LOCATION.

HVAC PIPING DEMOLITION NOTES:

- DEMOLITION DRAWINGS ARE DIAGRAMMATIC ONLY AND ARE BASED ON FIELD OBSERVATION AND EXISTING RECORD DRAWINGS. CONTRACTOR SHALL VERIFY ALL EXISTING CONDITIONS PRIOR TO BEGINNING WORK AND NOTIFY THE ARCHITECT/ ENGINEER OF ANY DISCREPANCIES BETWEEN THE "AS-BUILT" CONDITIONS AND THESE DRAWINGS.
 - THIS CONTRACTOR IS RESPONSIBLE FOR REMOVAL AND RE-INSTALLING OF EXISTING CEILING TILE NOT REMOVED BY THE GENERAL CONTRACTOR FOR THE DEMOLITION OF EXISTING HVAC PIPING, EQUIPMENT, ETC. VERIFY WITH ARCHITECTURAL PLANS FOR CEILING WORK BY THE GENERAL CONTRACTOR. ANY CEILING TILE OR GRID DAMAGED DURING CONSTRUCTION SHALL BE REPLACED WITH NEW BY THIS CONTRACTOR.
 - THIS CONTRACTOR SHALL OPEN ALL WALLS AND/OR CEILINGS FOR DEMOLITION OF EXISTING HVAC PIPING, EQUIPMENT, ETC. AS REQUIRED.
 - THIS CONTRACTOR IS RESPONSIBLE FOR PATCHING ALL HOLES/WALLS AND/OR CEILINGS FROM DEMOLISHED HVAC PIPING, EQUIPMENT, ETC. IN FLOORS, WALLS, AND CEILINGS TO MATCH EXISTING.
- ⚠️ DISCONNECT AND REMOVE EXISTING CONNECTOR, ALL ASSOCIATED PIPING, PIPING ACCESSORIES, & TEMPERATURE CONTROLS.
- ⚠️ DISCONNECT AND REMOVE EXISTING STEAM AND CONDENSATE PIPING TO POINT INDICATED ON PLAN AND PREPARE FOR RECONNECTION.
- ⚠️ DISCONNECT THERMOSTAT AND PREPARE FOR RECONNECTION IN NEW LOCATION.

HVAC PIPING NOTES:

- CONTRACTOR SHALL VERIFY ALL EXISTING CONDITIONS PRIOR TO BEGINNING WORK AND NOTIFY THE ARCHITECT/ ENGINEER OF ANY DISCREPANCIES BETWEEN THE "AS-BUILT" CONDITIONS AND THESE DRAWINGS.
 - COORDINATE ALL HVAC PIPING INSTALLATION WITH GENERAL, PLUMBING, FIRE PROTECTION, VENTILATION, AND ELECTRICAL CONTRACTORS. INSTALL ALL HVAC PIPING AS HIGH AS POSSIBLE. PROVIDE ALL NECESSARY OFFSETS (DROPS AND RISES) TO KEEP HVAC PIPING TIGHT TO THE STRUCTURE OR DUCTWORK ABOVE. OFFSET HVAC PIPING TO AVOID BEAMS.
 - REFER TO AND COORDINATE WITH THE ARCHITECTURAL PLANS FOR CEILING TYPES, HEIGHTS, SOFFIT AREAS, AND ELEVATIONS FOR INSTALLATION OF NEW HVAC PIPING, EQUIPMENT, ETC.
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 - THIS CONTRACTOR SHALL OPEN ALL EXISTING WALLS AND/OR CEILINGS TO INSTALL NEW HVAC PIPING, EQUIPMENT, ETC. AS REQUIRED. PATCH WALLS AND/OR CEILINGS TO MATCH EXISTING.
 - MAINTAIN 3'-0" CLEAR SPACE IN FRONT OF ALL ELECTRICAL, CONTROL, AND ACCESS PANELS FOR ACCESSIBILITY.
 - ALL SHUT-OFF VALVES, CONTROL VALVES, STRAINERS, ETC... SHALL BE INSTALLED IN ACCESSIBLE CEILINGS.
 - PROVIDE 1/2" DRAIN VALVE AT ALL LOW POINTS OF EACH SYSTEM TO ENABLE COMPLETE DRAINAGE. PROVIDE 1/2" VENT VALVES AT ALL HIGH POINTS OF EACH SYSTEM TO ENABLE COMPLETE VENTING.
- ① INSTALL SALVAGED THERMOSTAT & ASSOCIATED WIRING/TUBING.
- ② LOCATE & DEMO EXISTING T-STAT FOR EXISTING VAV. INSTALL NEW THERMOSTAT FOR EXISTING VAV TO CONTROL ROOM 147A.


PLUMBING NOTES:

- CONTRACTOR SHALL VERIFY ALL EXISTING CONDITIONS PRIOR TO BEGINNING WORK AND NOTIFY THE ARCHITECT/ ENGINEER OF ANY DISCREPANCIES BETWEEN THE "AS-BUILT" CONDITIONS AND THESE DRAWINGS.
- COORDINATE ALL PLUMBING INSTALLATION WITH GENERAL, FIRE PROTECTION, VENTILATION, AND ELECTRICAL CONTRACTORS. INSTALL ALL PLUMBING PIPING AS HIGH AS POSSIBLE. PROVIDE ALL NECESSARY OFFSETS (DROPS AND RISES) TO KEEP PLUMBING PIPING TIGHT TO THE STRUCTURE OR DUCTWORK ABOVE. OFFSET PLUMBING PIPING TO AVOID BEAMS.
- REFER TO AND COORDINATE WITH THE ARCHITECTURAL PLANS FOR CEILING TYPES, HEIGHTS, SOFFIT AREAS, AND ELEVATIONS FOR INSTALLATION OF NEW PLUMBING PIPING, EQUIPMENT, ETC.
- THIS CONTRACTOR IS RESPONSIBLE FOR REMOVAL AND RE-INSTALLING OF EXISTING CEILING TILE NOT REMOVED BY THE GENERAL CONTRACTOR FOR THE INSTALLATION OF NEW PLUMBING PIPING, EQUIPMENT, ETC. VERIFY WITH ARCHITECTURAL PLANS FOR CEILING WORK BY THE GENERAL CONTRACTOR. ANY CEILING TILE OR GRID DAMAGED DURING CONSTRUCTION SHALL BE REPLACED WITH NEW BY THIS CONTRACTOR.
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- MAINTAIN 3'-0" CLEAR SPACE IN FRONT OF ALL ELECTRICAL, CONTROL, AND ACCESS PANELS FOR ACCESSIBILITY.
- ALL SHUT-OFF VALVES, ETC... SHALL BE INSTALLED IN ACCESSIBLE CEILINGS.
- RECONNECT SALVAGED SINK TO PREVIOUS WATER DISTRIBUTION LINES & VENT PIPING. REROUTE SANITARY LINE TO RECONNECT TO WASTE LINE.


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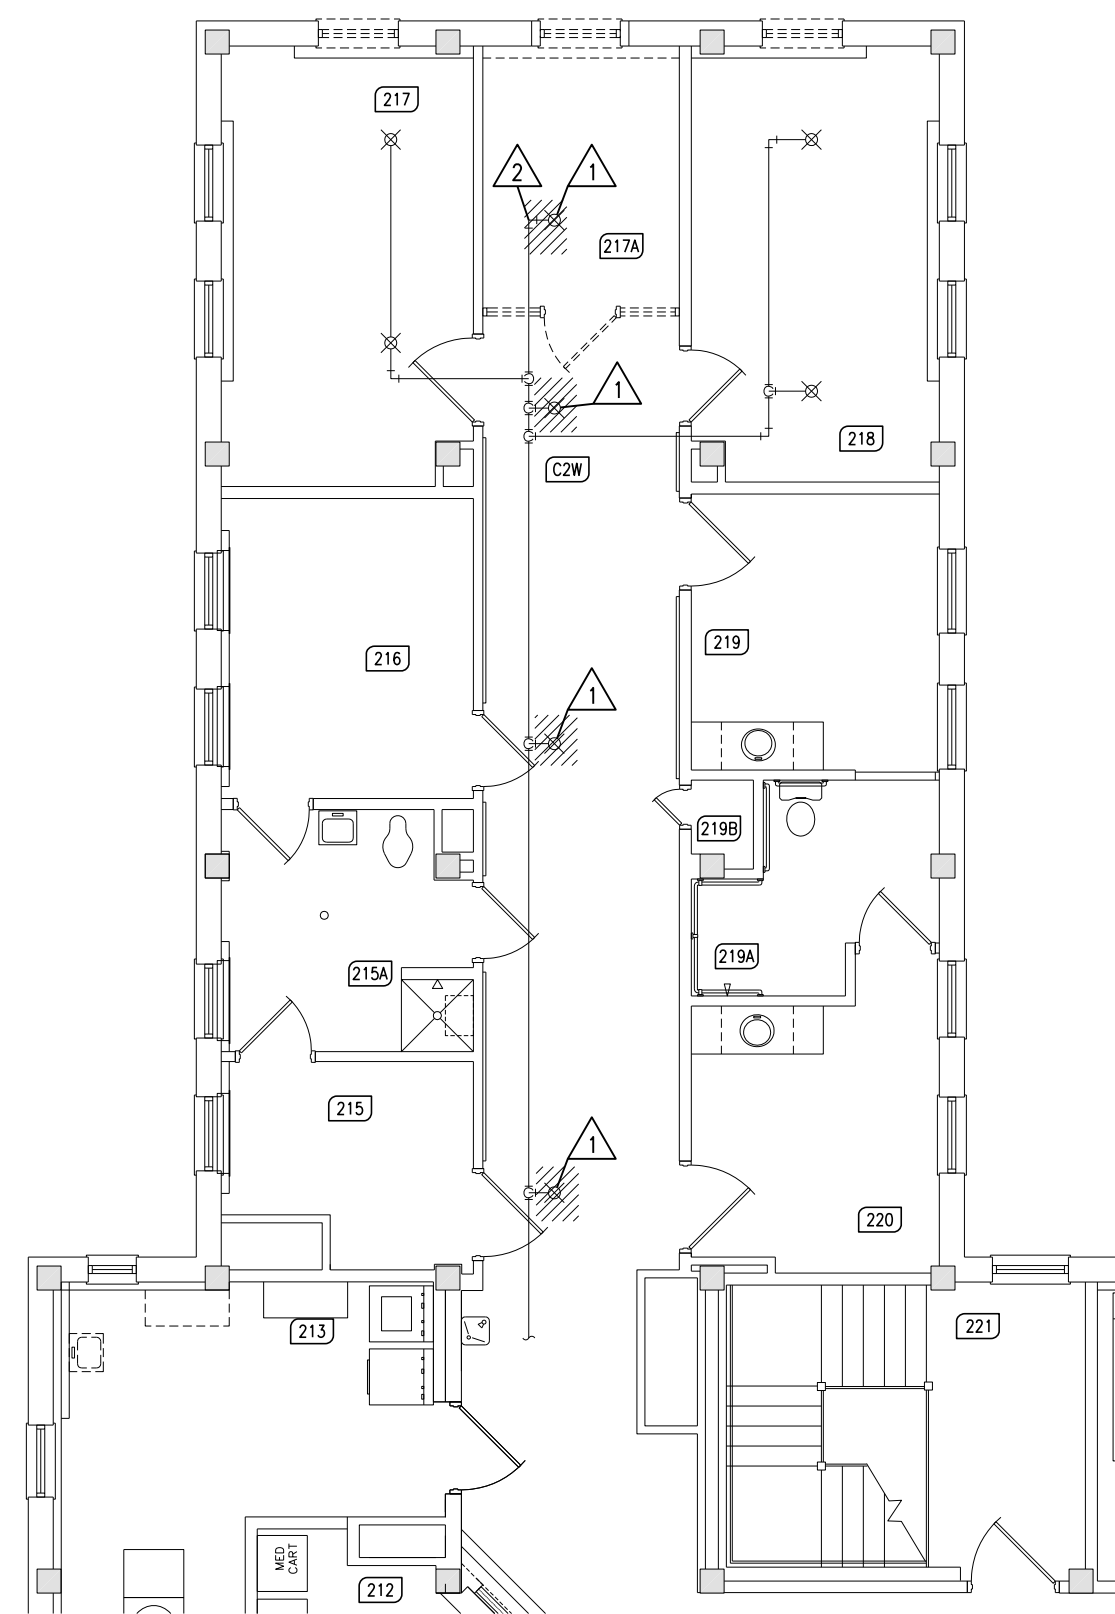





1 BASEMENT FIRE PROTECTION DEMOLITION PLAN
FP1 SCALE: 1/8"=1'-0"

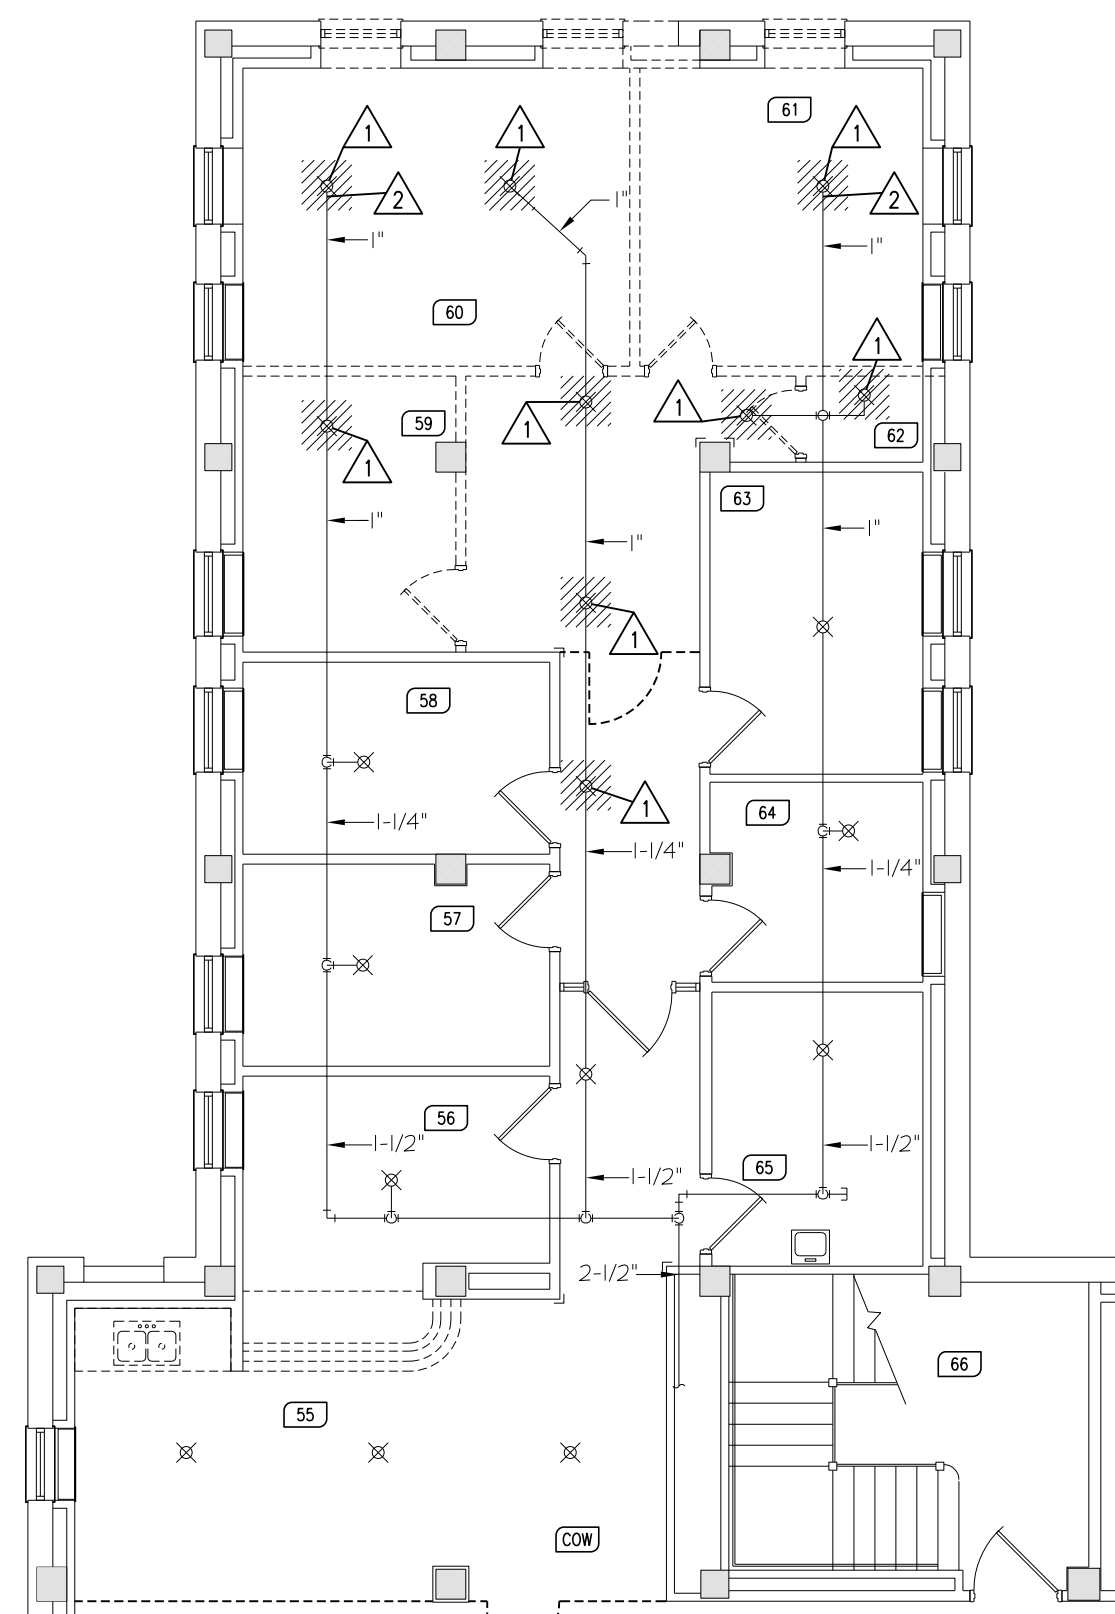


2 FIRST FLOOR FIRE PROTECTION DEMOLITION PLAN
FP1 SCALE: 1/8"=1'-0"

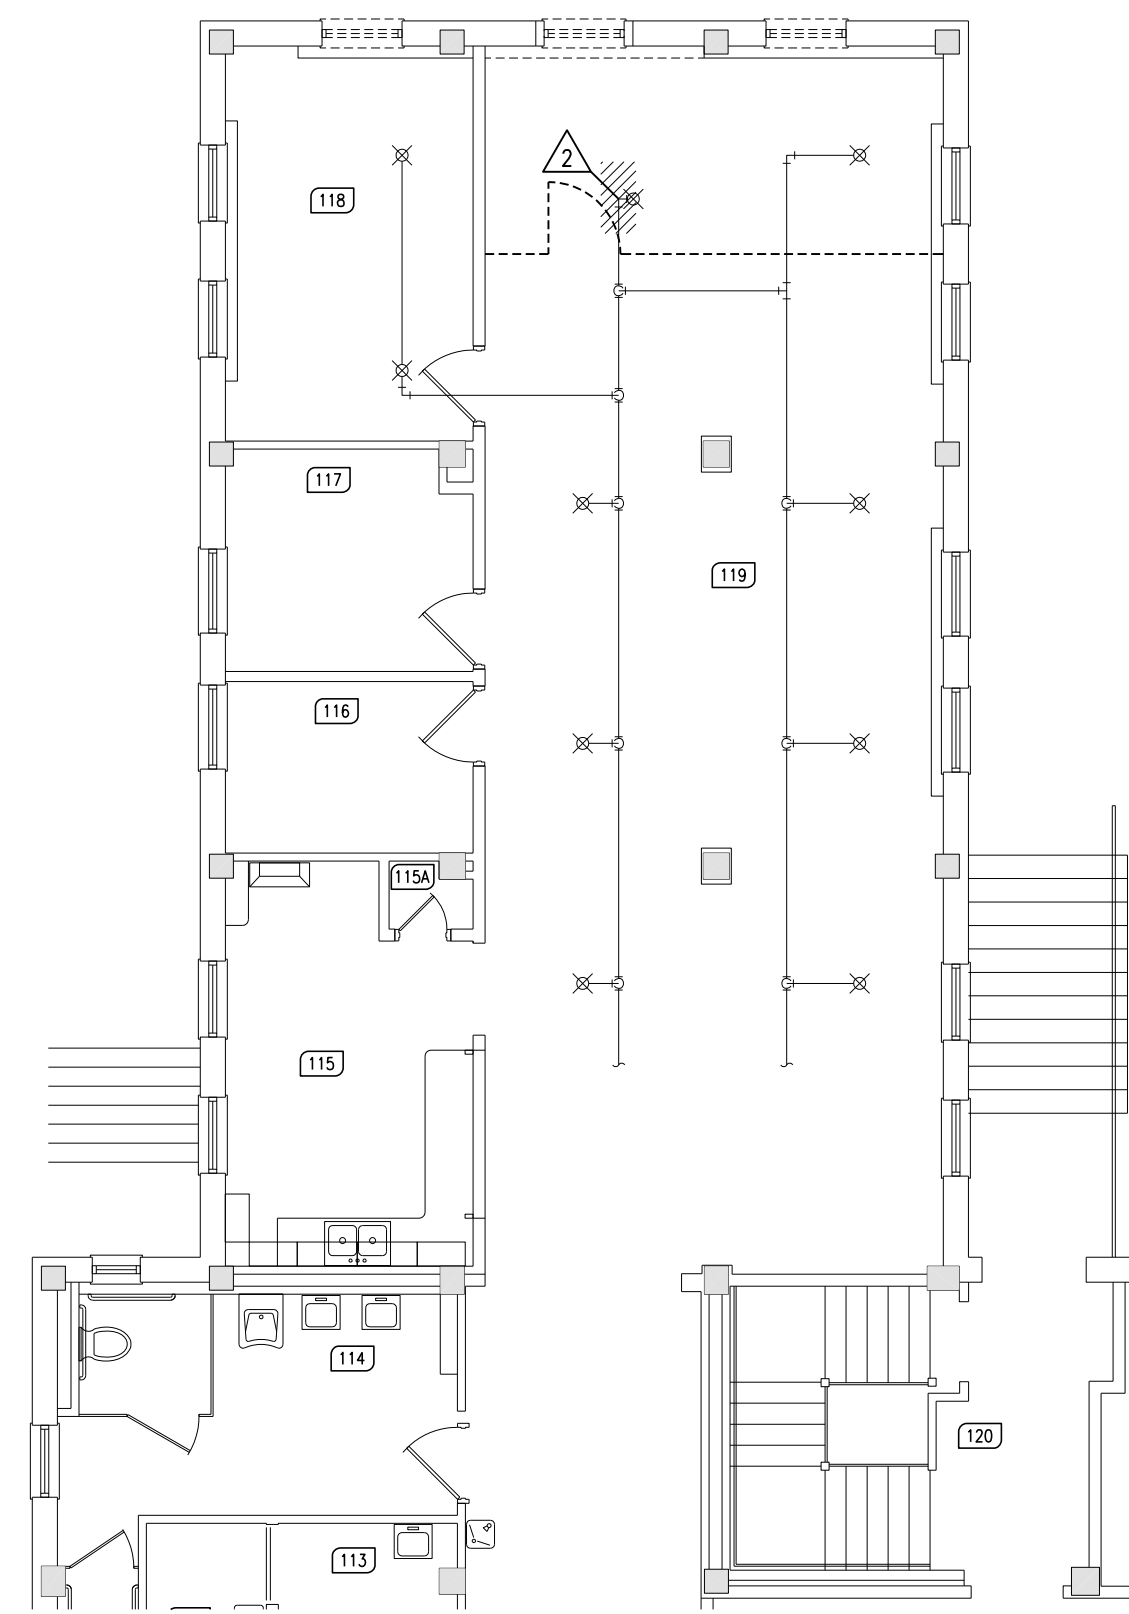


3 SECOND FLOOR FIRE PROTECTION DEMOLITION PLAN
FP1 SCALE: 1/8"=1'-0"

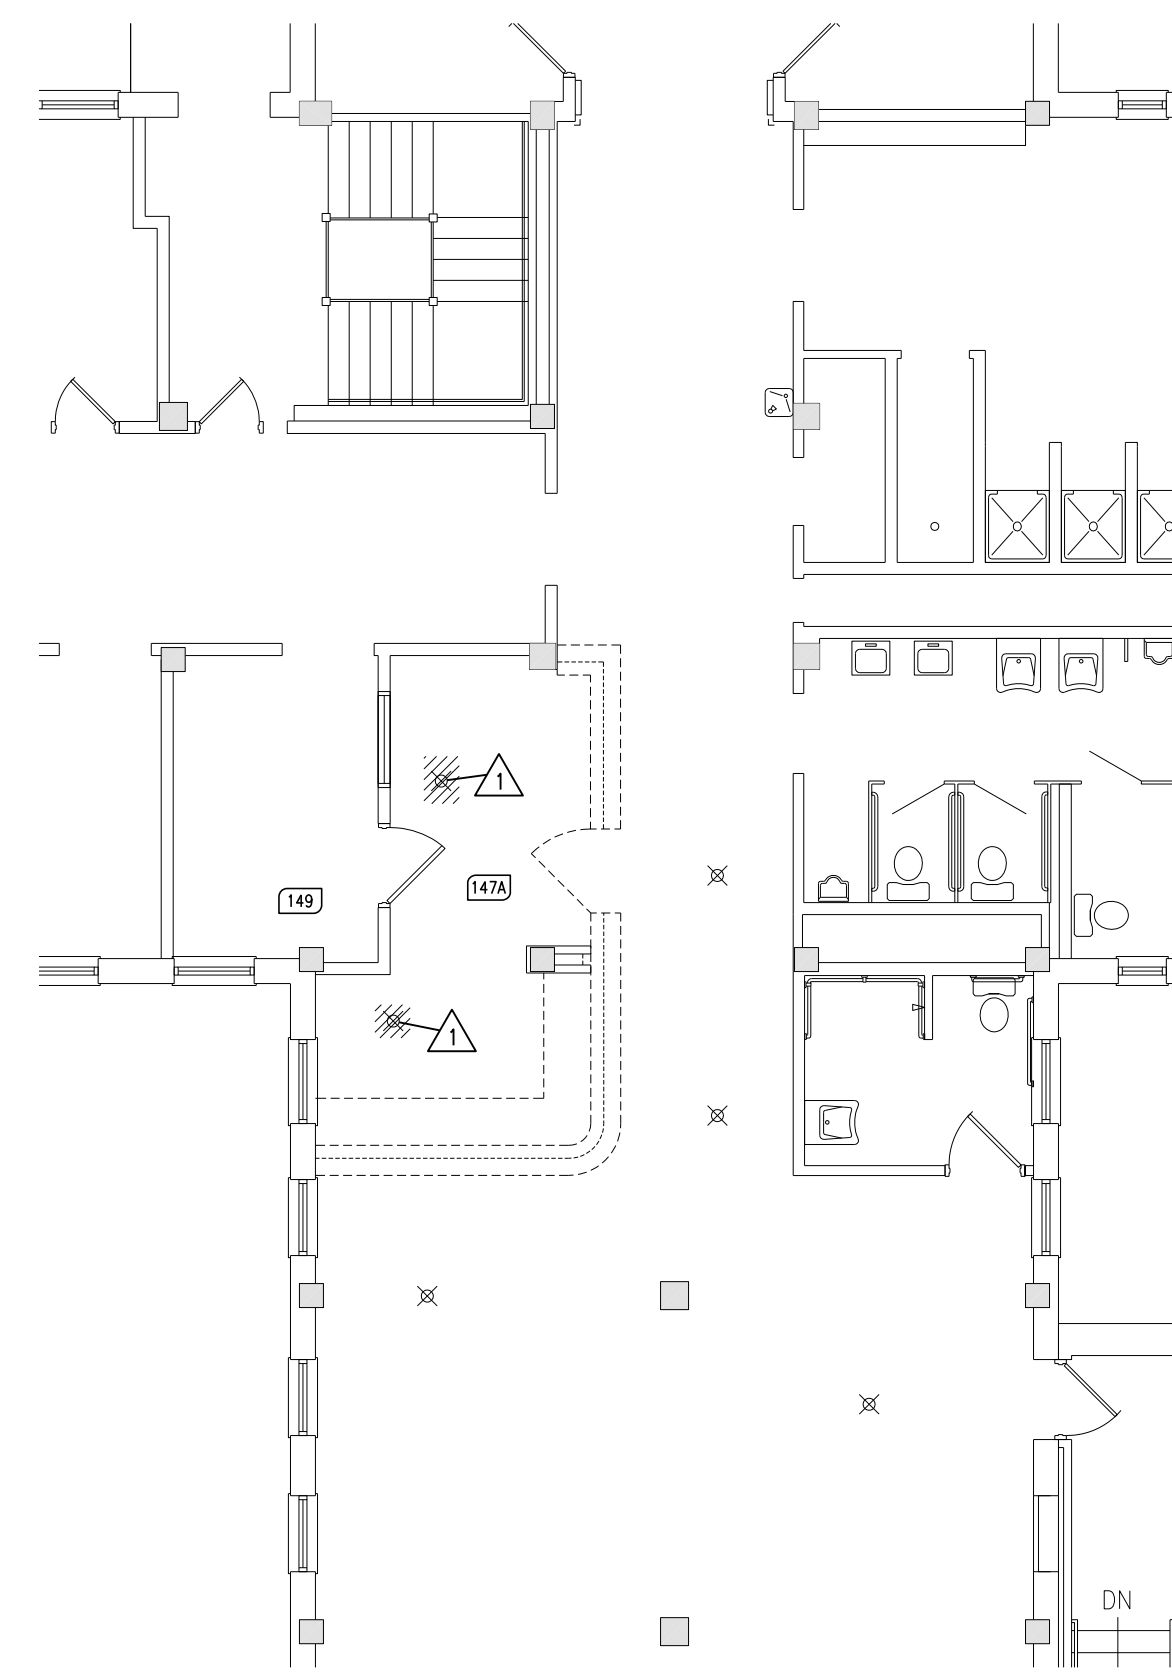


4 FIRST FLOOR FIRE PROTECTION DEMO PLAN - SE WING
(DEDUCT ALTERNATE BID NO.1) SCALE: 1/8"=1'-0"

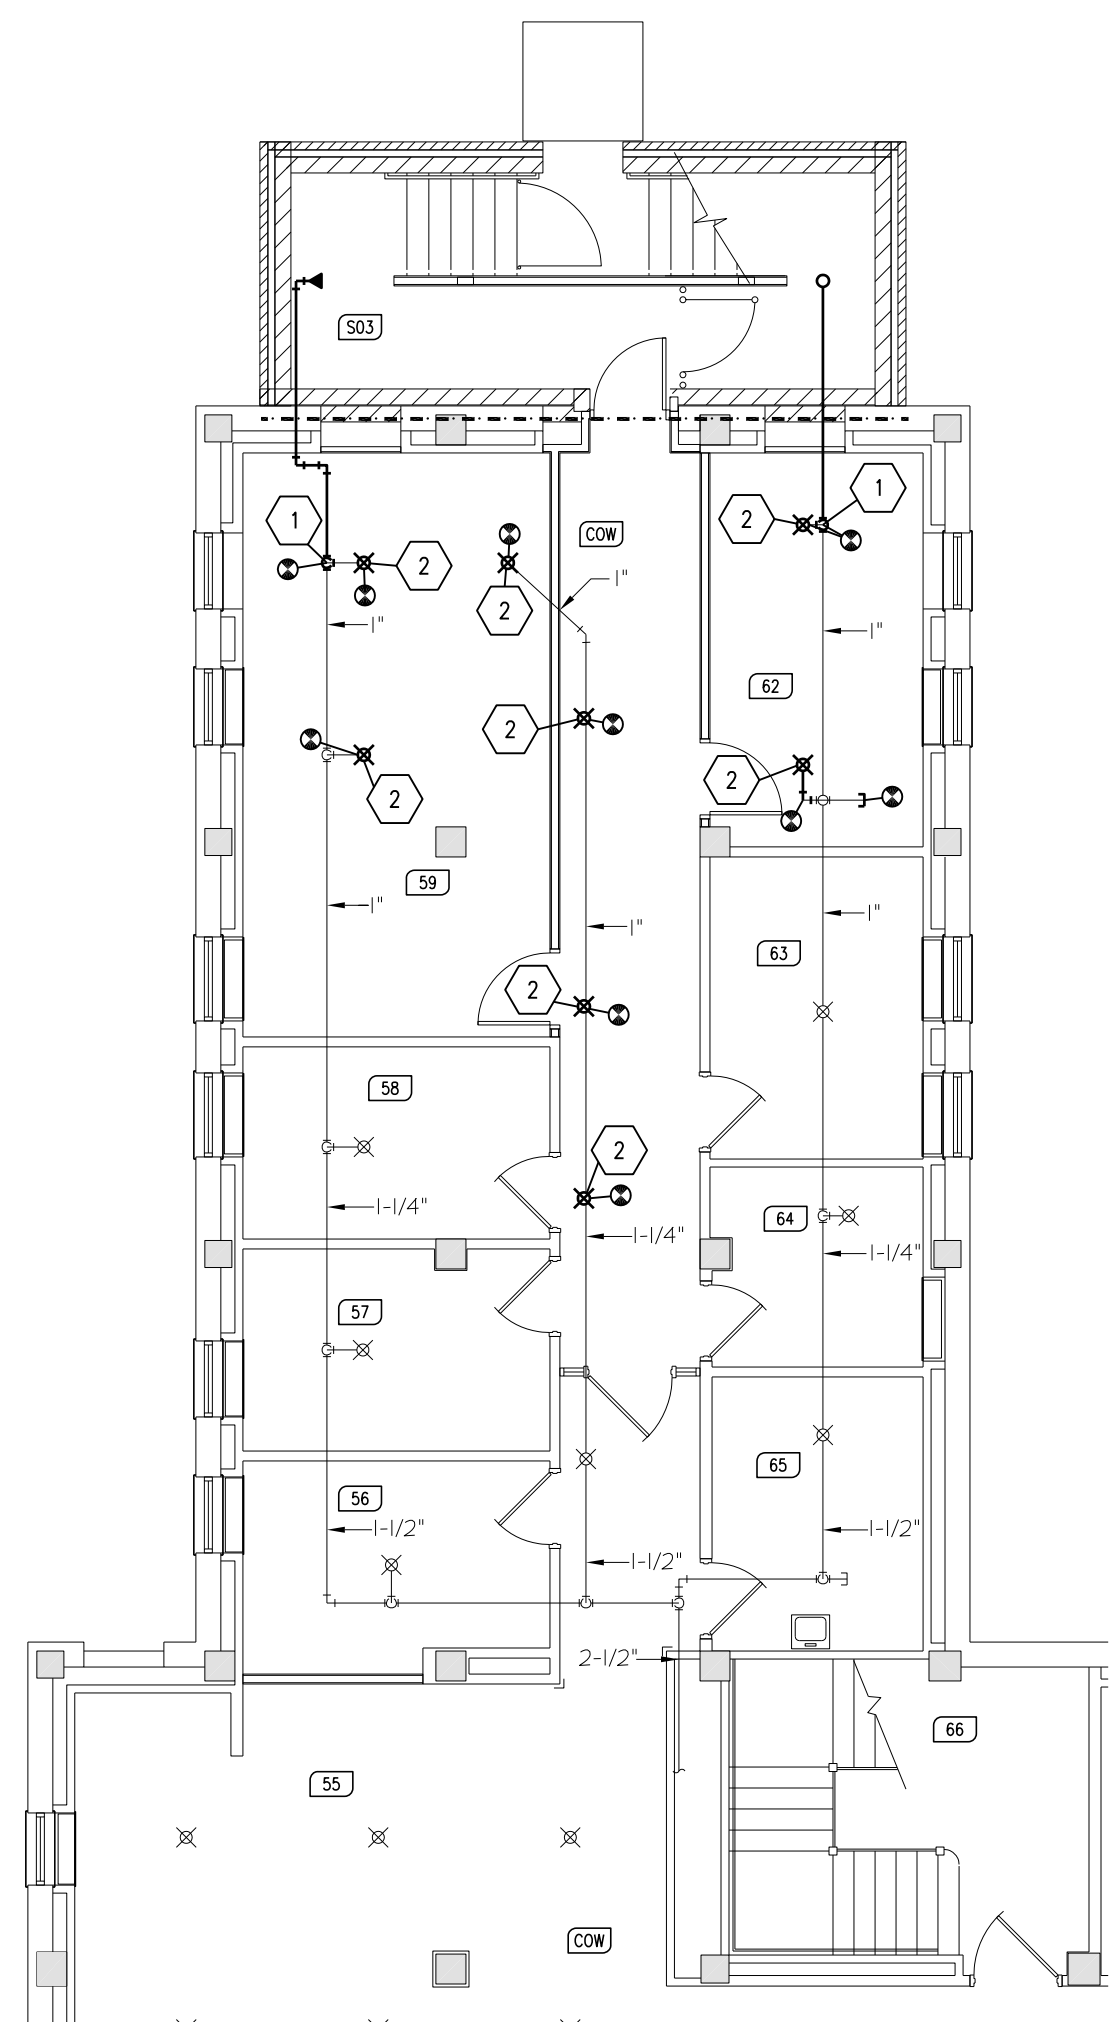


5 BASEMENT FIRE PROTECTION PLAN
FP1 SCALE: 1/8"=1'-0"

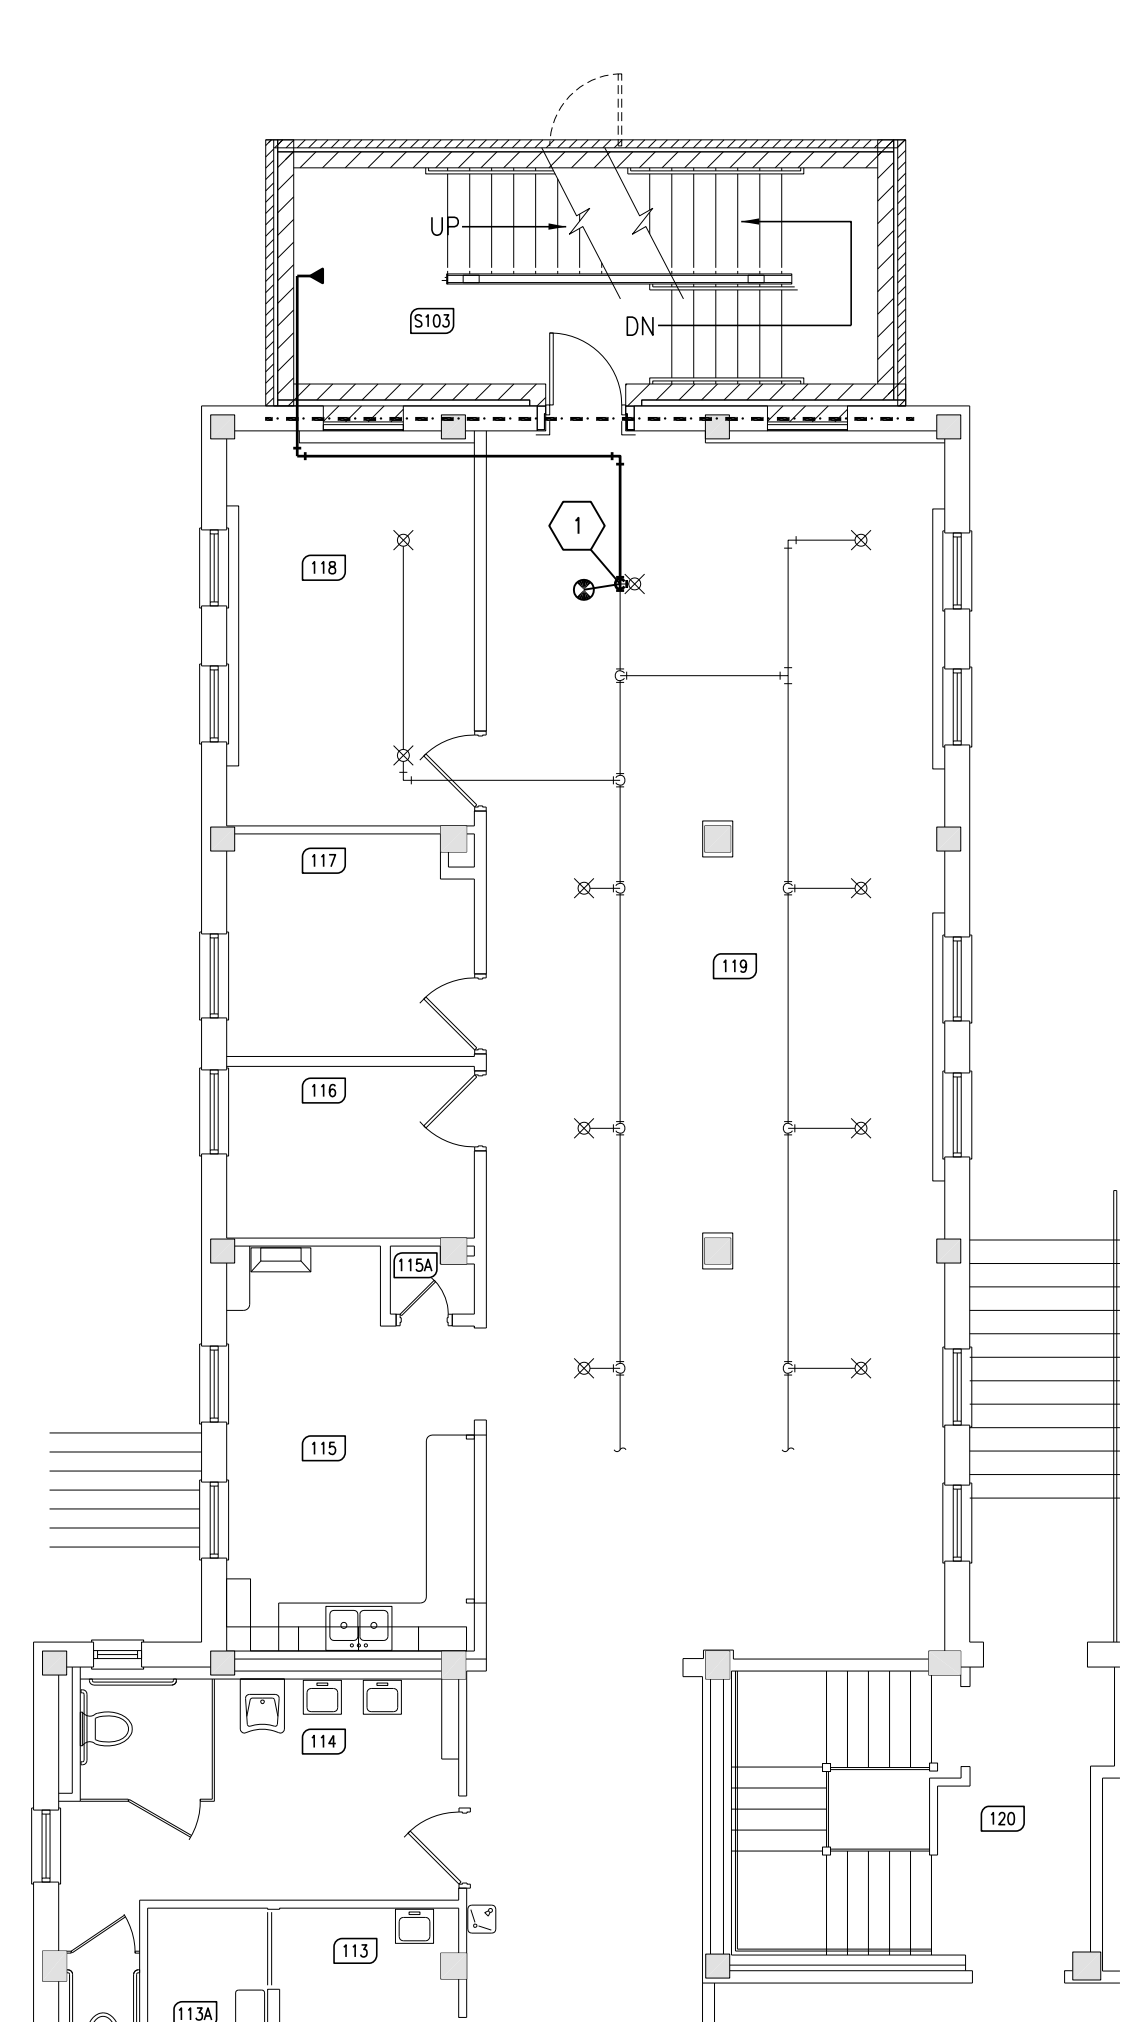

6 FIRST FLOOR FIRE PROTECTION PLAN
FP1 SCALE: 1/8"=1'-0"

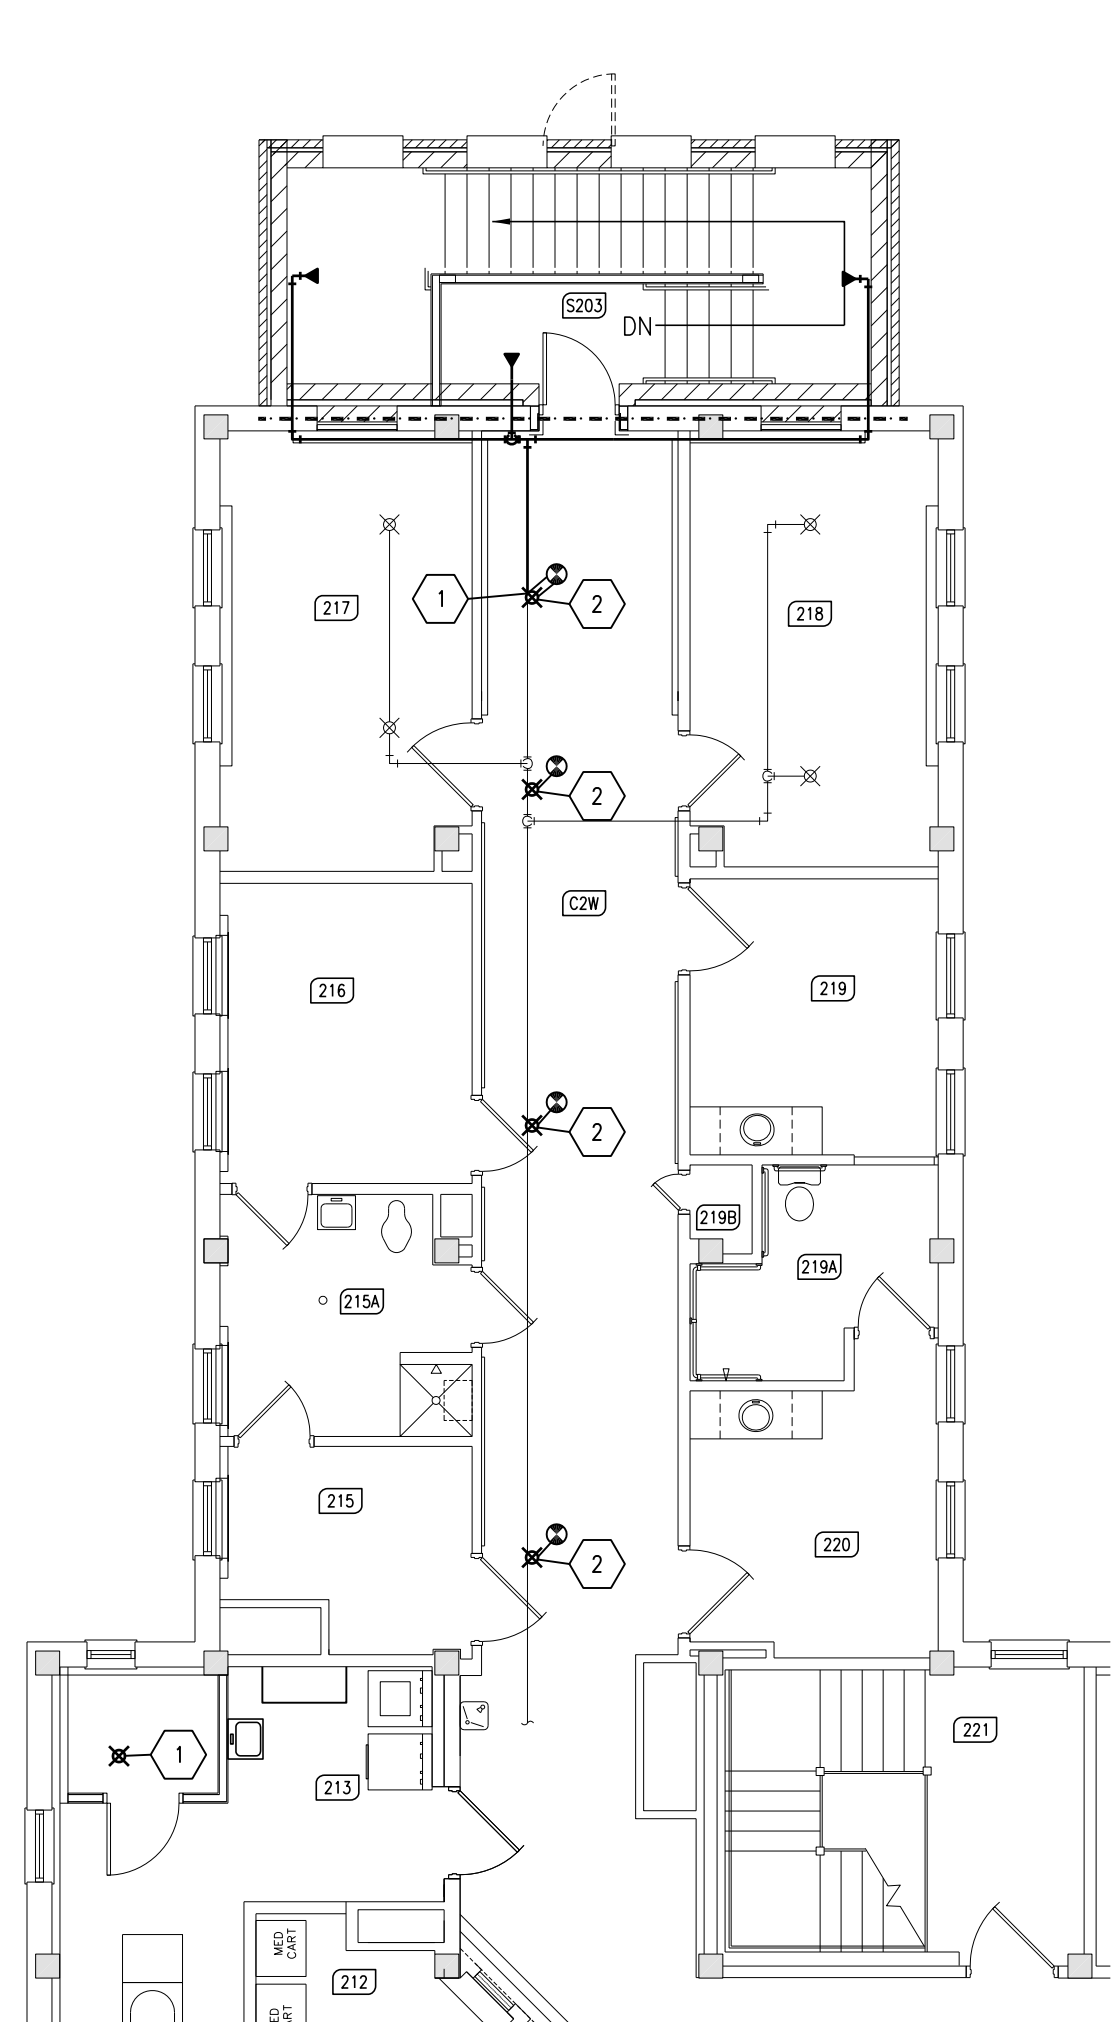

7 SECOND FLOOR FIRE PROTECTION PLAN
FP1 SCALE: 1/8"=1'-0"

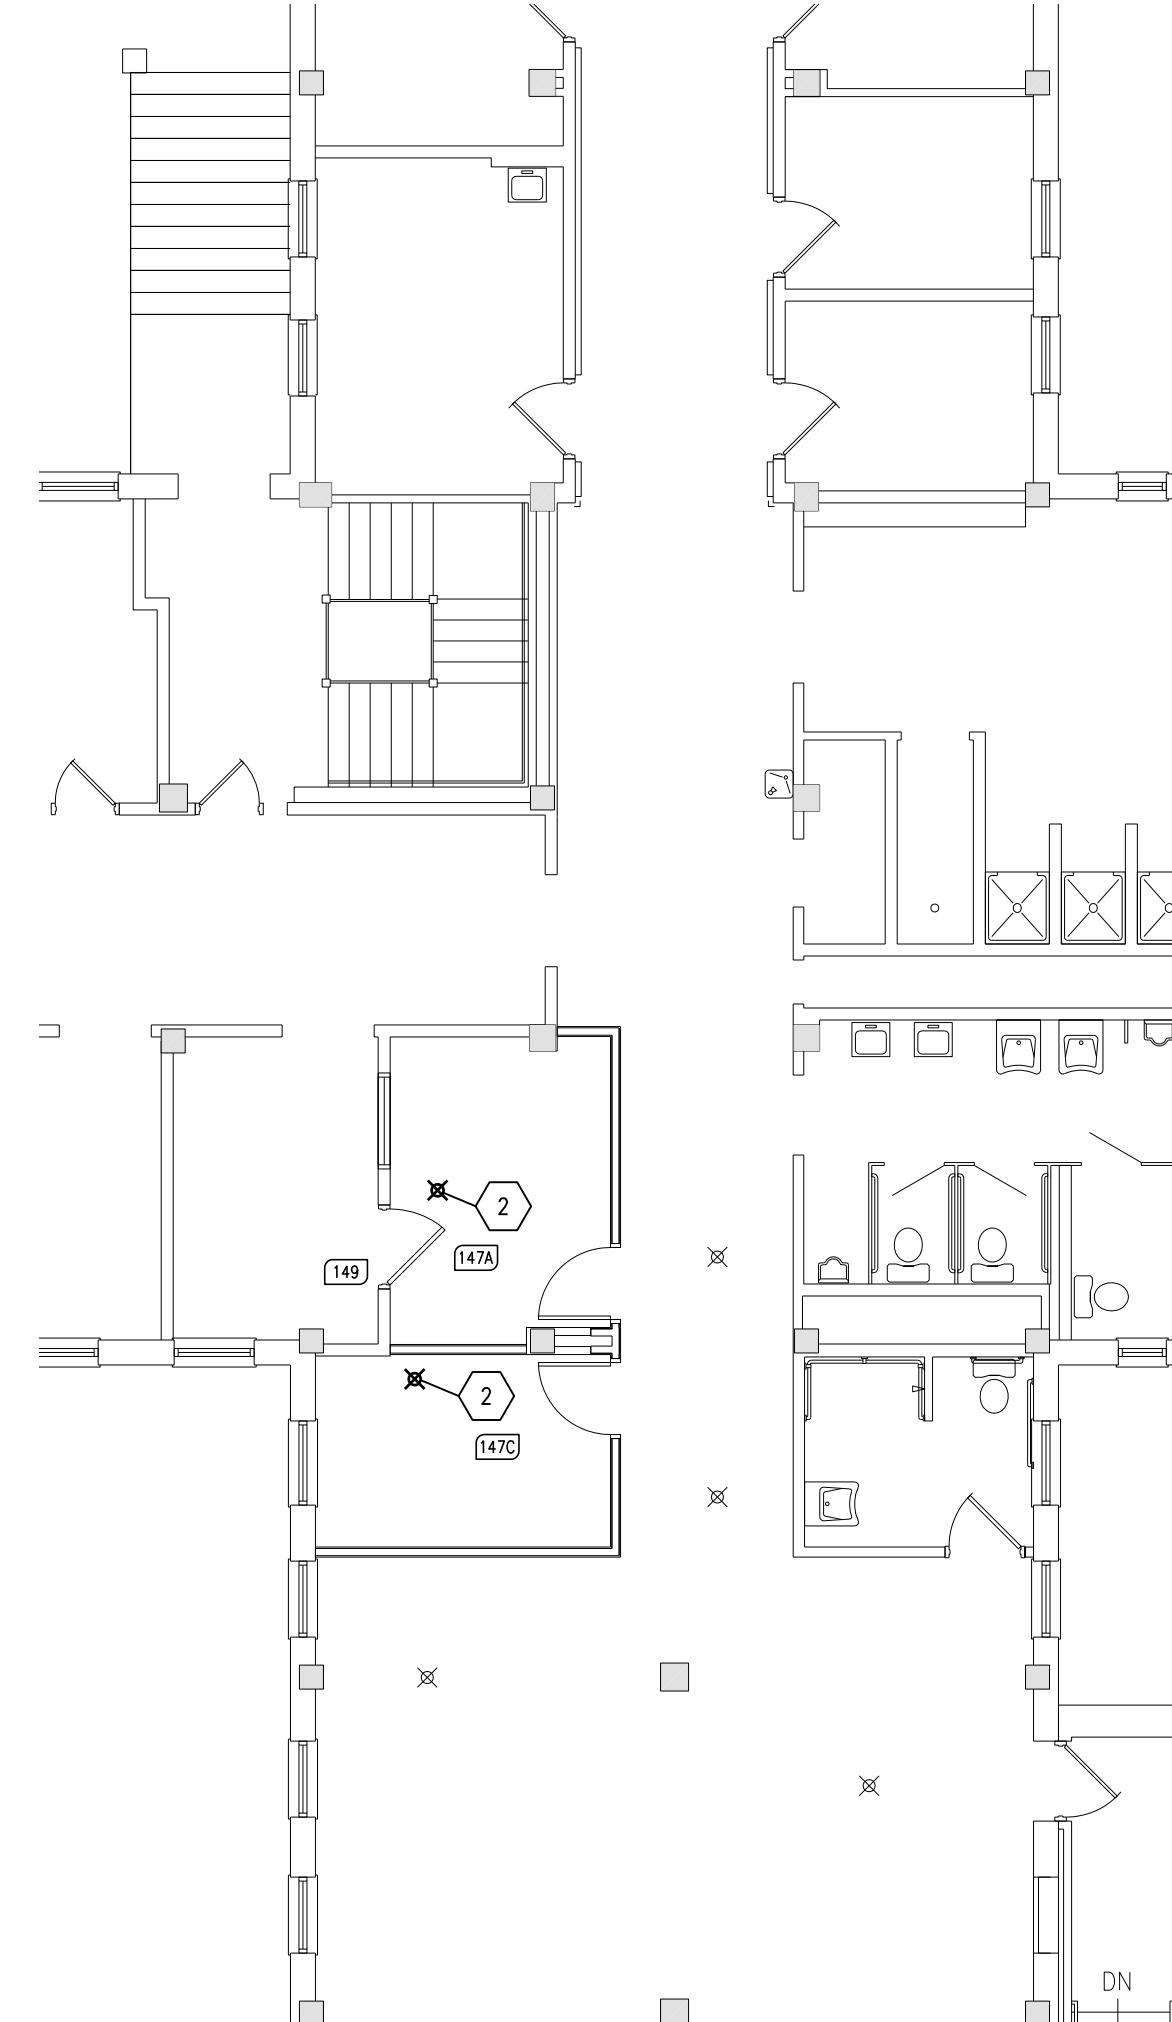

8 FIRST FLOOR FIRE PROTECTION PLAN - SE WING
(DEDUCT ALTERNATE BID NO.1) SCALE: 1/8"=1'-0"

FIRE PROTECTION DEMOLITION NOTES:

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- THIS CONTRACTOR SHALL OPEN ALL WALLS AND/OR CEILINGS FOR DEMOLITION OF EXISTING FIRE PROTECTION PIPING, SPRINKLER HEADS, EQUIPMENT, ETC. AS REQUIRED.
- THIS CONTRACTOR IS RESPONSIBLE FOR PATCHING ALL HOLES/WALLS AND/OR CEILINGS FROM DEMOLISHED FIRE PROTECTION PIPING, SPRINKLER HEADS, EQUIPMENT, ETC. IN FLOORS, WALLS, AND CEILINGS TO MATCH EXISTING.

DISCONNECT EXISTING SPRINKLER HEAD AND PIPING DROP. PREPARE PIPING FOR NEW CONNECTION.
PREPARE PIPING END FOR EXTENSION INTO NEW STAIR TOWER.

SPRINKLER HEAD LEGEND

CHROME PLATED RECESSED TYPE SPRINKLER HEAD
BRASS UPRIGHT PENDENT TYPE SPRINKLER HEAD
SIDEWALL PENDENT TYPE SPRINKLER HEAD

FIRE PROTECTION NOTES:

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- COORDINATE ALL FIRE PROTECTION INSTALLATION WITH GENERAL, PLUMBING, VENTILATION, AND ELECTRICAL CONTRACTORS. INSTALL ALL FIRE PROTECTION PIPING AS HIGH AS POSSIBLE. PROVIDE ALL NECESSARY OFFSETS (DROPS AND RISES) TO KEEP FIRE PROTECTION PIPING TIGHT TO THE STRUCTURE OR DUCTWORK ABOVE. OFFSET FIRE PROTECTION PIPING TO AVOID BEAMS.
- ALL FIRE PROTECTION WORK SHALL ADHERE TO CURRENT NFPA 13 STANDARDS.
- ENTIRE BUILDING SHALL BE SPRINKLED. VERIFY WHERE MULTIPLE FLOORS EXIST.
- FIRE PROTECTION PIPING AND SPRINKLER HEADS ARE SHOWN FOR REFERENCE ONLY.
- SPRINKLER HEADS IN LAY-IN-TILE CEILINGS SHALL BE LOCATED IN THE CENTER OF TILE.
- REFER TO AND COORDINATE WITH THE ARCHITECTURAL PLANS FOR CEILING TYPES, HEIGHTS, SOFFIT AREAS, AND ELEVATIONS FOR INSTALLATION OF NEW FIRE PROTECTION PIPING, SPRINKLER HEADS, EQUIPMENT, ETC.
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- MAINTAIN 3'-0" CLEAR SPACE IN FRONT OF ALL ELECTRICAL, CONTROL, AND ACCESS PANELS FOR ACCESSIBILITY.

EXTEND EXISTING TO ACCOMMODATE NEW SPRINKLER HEADS. INSTALL NEW SPRINKLERS ACCORDING TO NFPA STANDARDS.
INSTALL NEW SPRINKLER HEAD & EXTEND EXISTING PIPING TO NEW HEAD LOCATION.

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3350 38th Avenue South
Fargo, North Dakota 58104

I hereby certify that this plan, specification, or report was prepared by me or under my direct supervision, and that I am a duly Licensed Professional Engineer under the laws of the State of Minnesota.
Reg. No. 42719 Signature: *Brent A. Wavra*
Date: 1-31-2012 Printed Name: BRENT WAVRA

APPROVED SERVICE LINE DIRECTOR	DATE	APPROVED INJECTION CONTROL NURSE	DATE	DRAWING TITLE	PROJECT TITLE	DATE
APPROVED SERVICE LINE DIRECTOR	DATE	APPROVED PATIENT SAFETY	DATE	FIRE PROTECTION PLANS	BUILDING 28 WEST STAIR TOWER ADDITION	JANUARY 31, 2012
APPROVED PROJECTS SECTION MANAGER	DATE	APPROVED CHIEF OF POLICE	DATE	APPROVED CHIEF OF STAFF	BUILDING No. 28	FILED SCALE: 1/8"=1'-0"
APPROVED DIRECTOR FMS	DATE	APPROVED SAFETY MANAGER	DATE	APPROVED MEDICAL CENTER DIRECTOR	28	PROJECT NO. 656-12-212
					BAW/CDE	CAD FILE 201236-FPI.DWG
					DRN	DRAWING NO. FPI Dwg 11 of 16
					ST. CLOUD, MN 56303	

