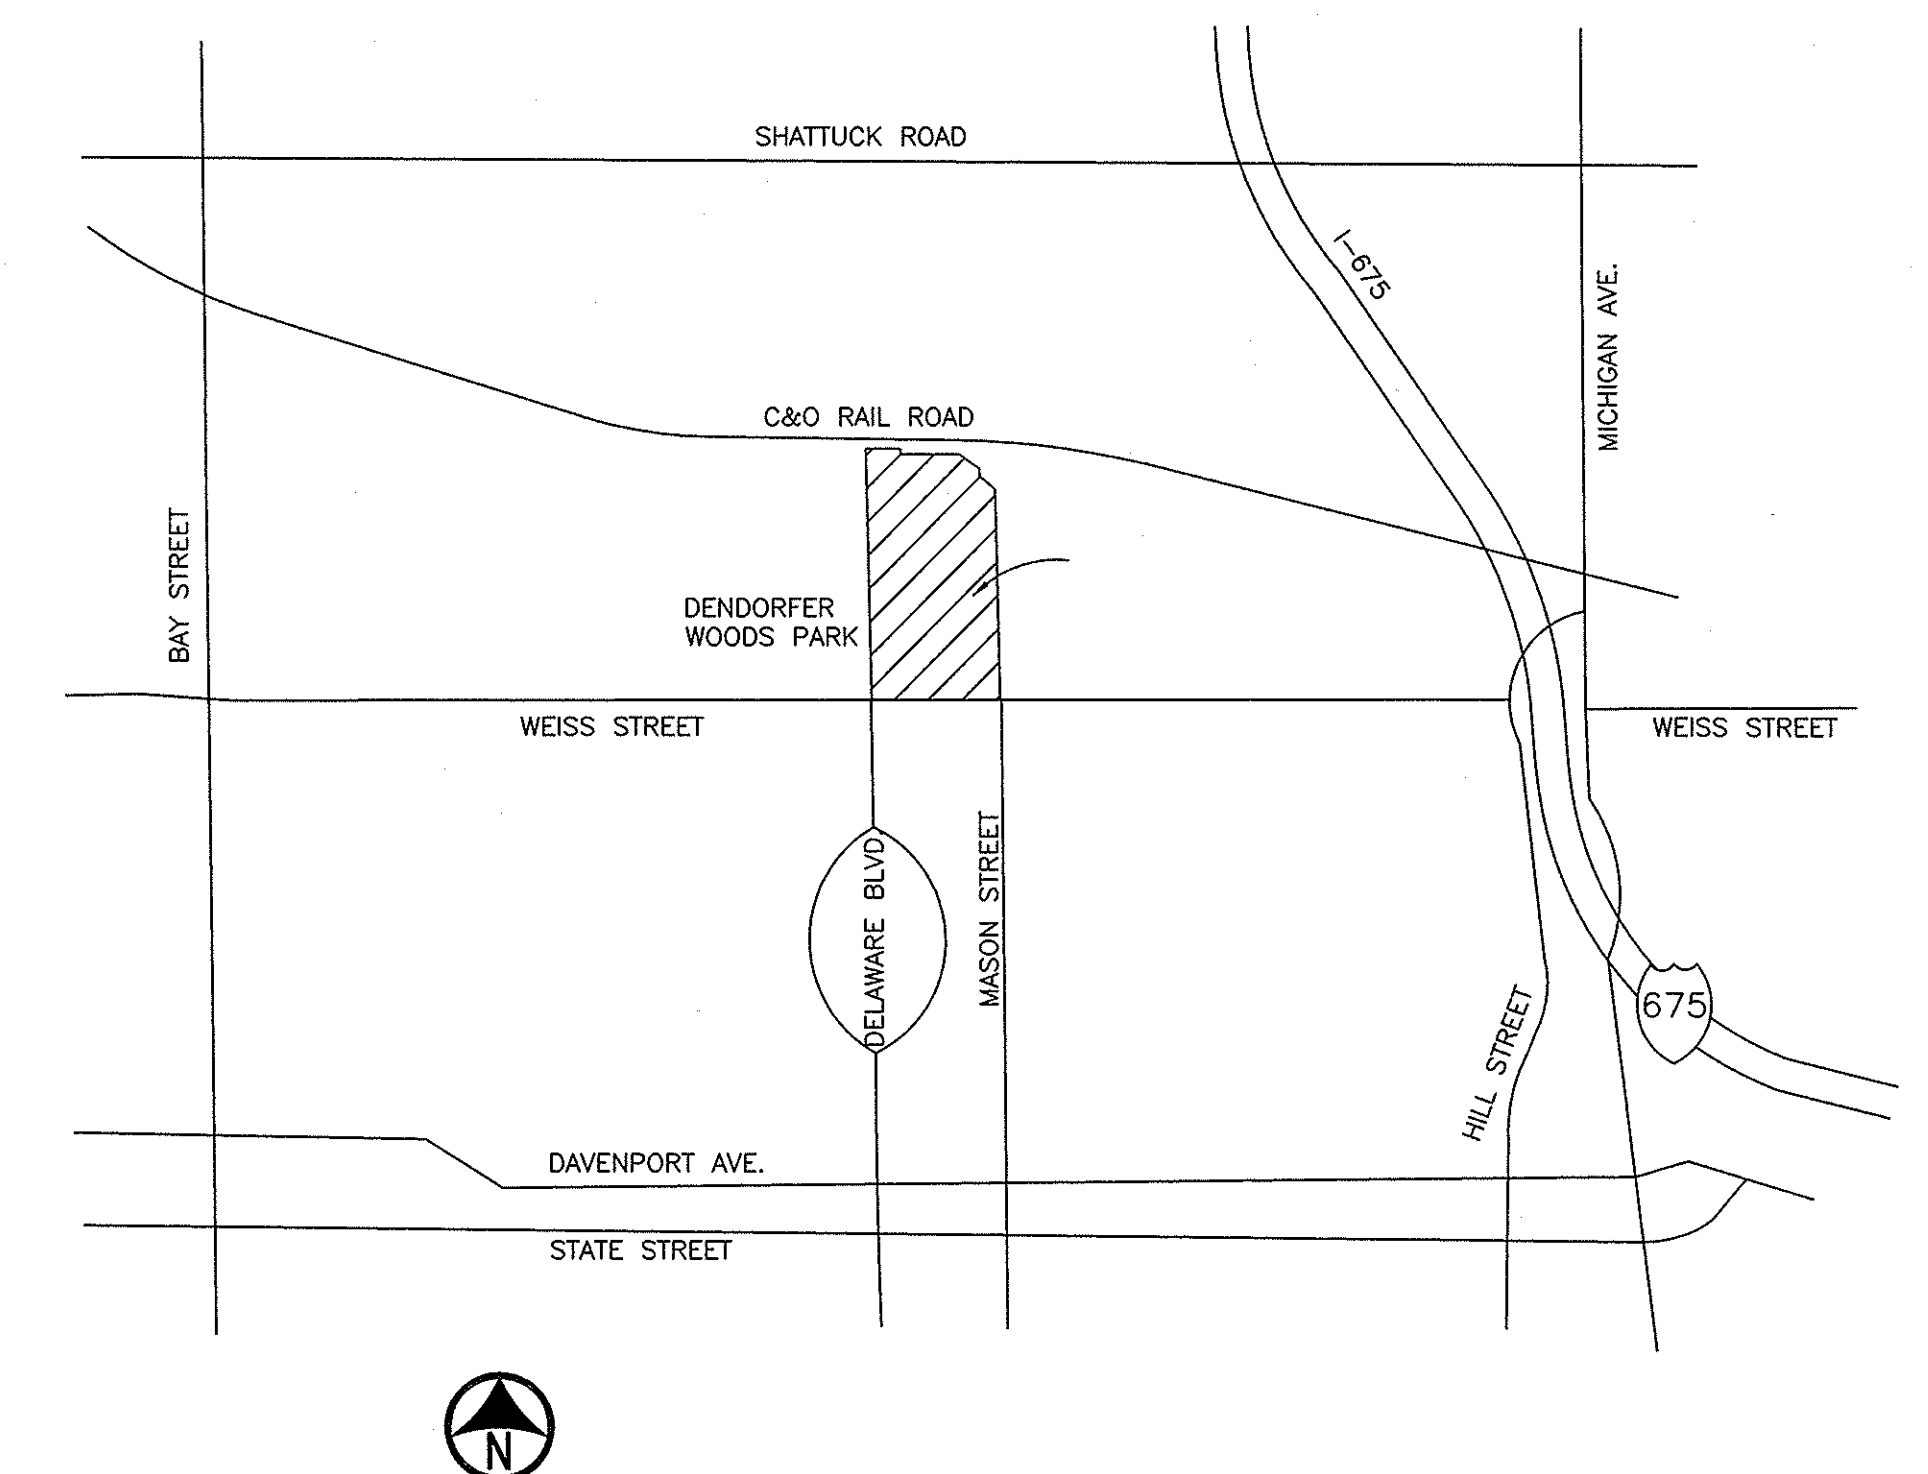
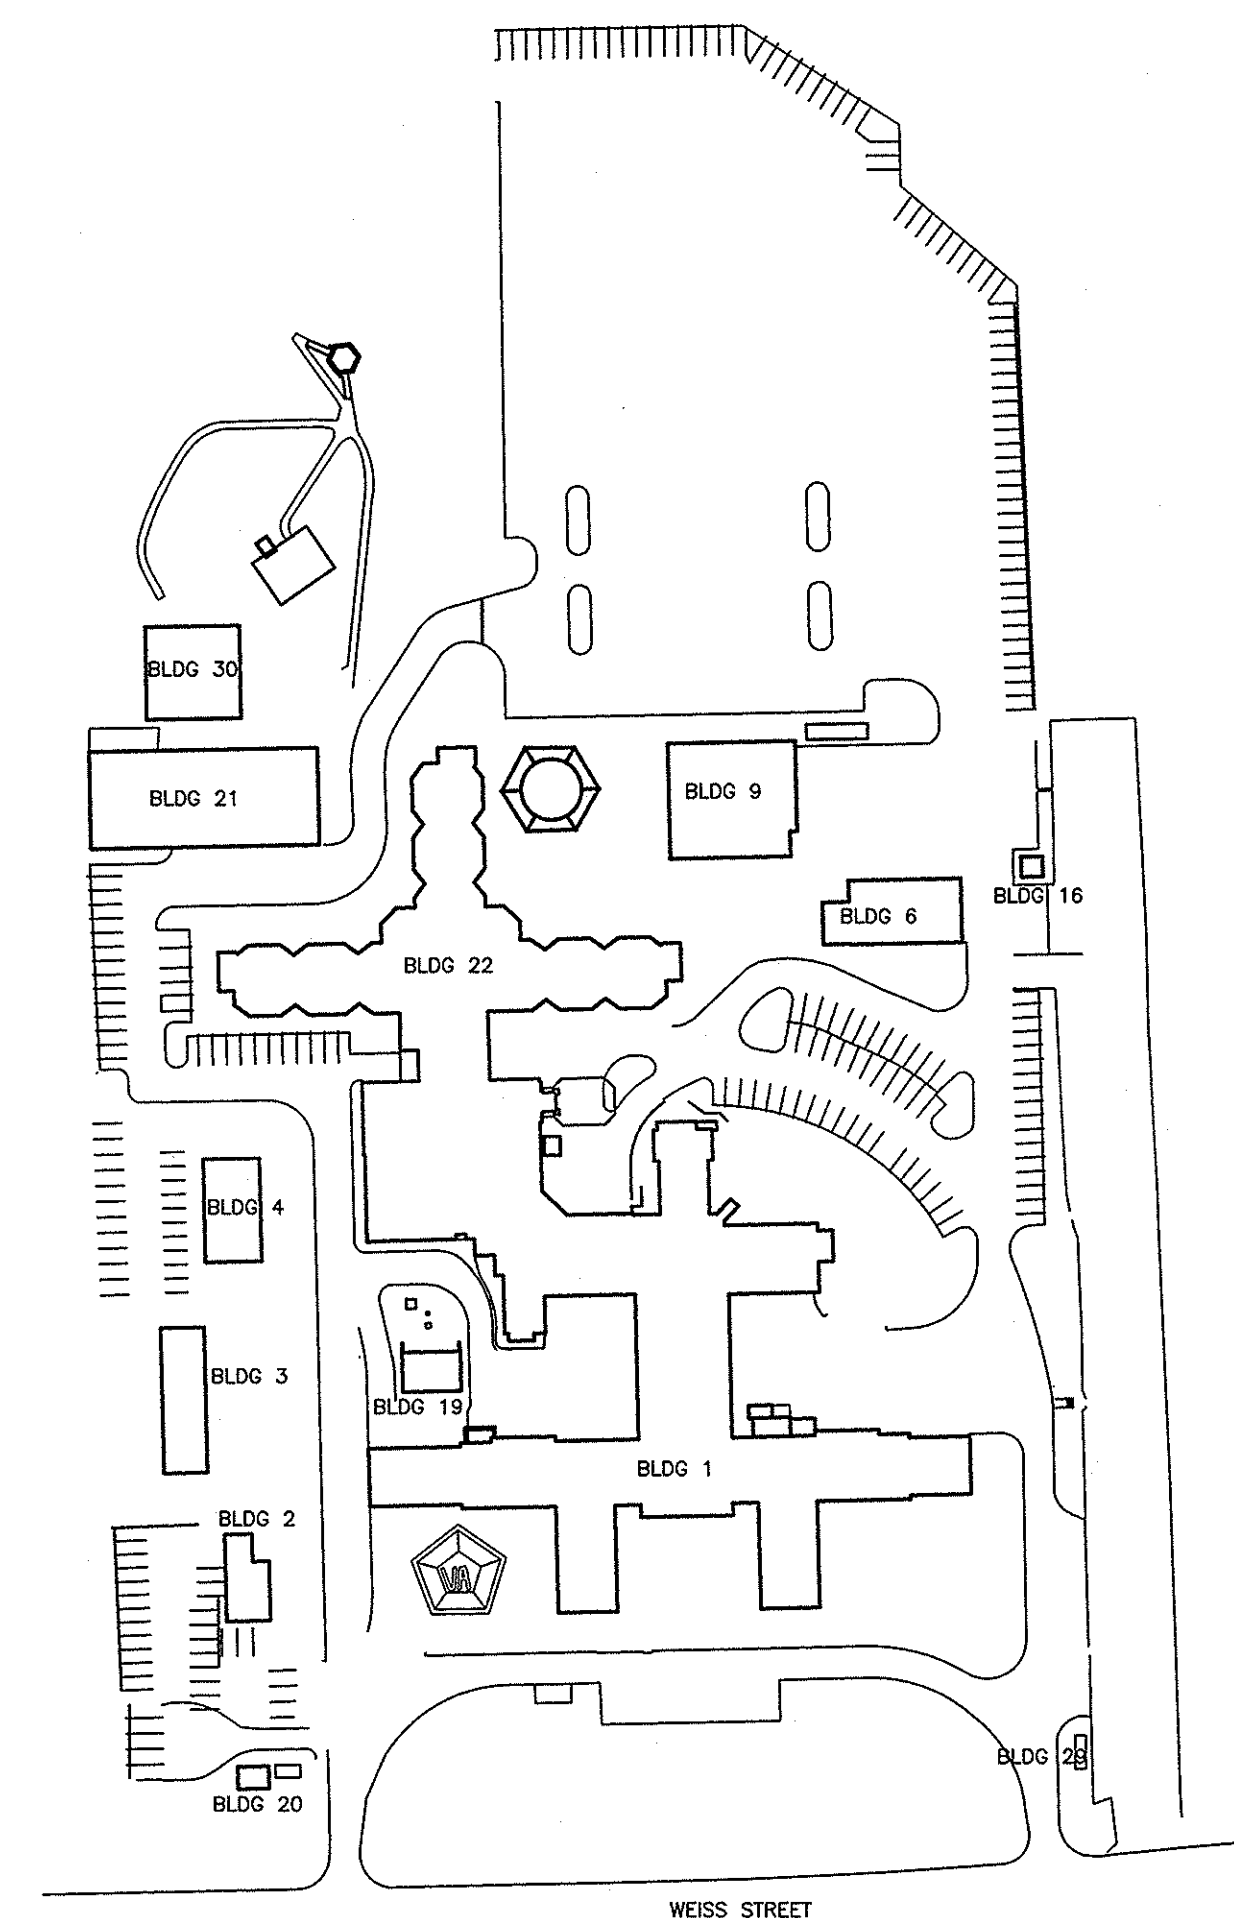





655-11-128

Drawing List	
Drawing Name	Drawing Number
Cover Sheet	G-001
Building 1 Roof Plan - Demolition	1AD101
Building 1 Roof Plan - Demolition	1AD102
Building 1 Roof Plan - Demolition	1AD103
Building 1 Roof Plan - Area 1	1A-101
Building 1 Roof Plan - Area 2	1A-102
Building 1 Roof Plan - Area 3	1A-103
Roof Details and Schedules	1A-701
Building 9 Roof Plan - Demolition	9AD101
Building 9 Roof Plan - Area 1	9A-101



		CONSULTANTS:				ARCHITECT/ENGINEERS:		Drawing Title <b>COVER SHEET</b>		Project Title <b>Roof Replacement for Building 1,9</b>		Project Number <b>655-11-128</b>		Office of Construction and Facilities Management  Department of Veterans Affairs			
						 Department of Veterans Affairs Aleda E Lutz Medical Center 1500 Weiss Street Saginaw, MI 48602		Approved Project Director  Chief, FMS		Location <b>Aleda E. Lutz Saginaw VAMC</b>		Building Number <b>1,9</b>				Drawing Number <b>G-001</b> Dwg 1 of 10	
Revisions:		Date								Date 11/14/11		Checked KSR		Drawn RDP			




(APPLIES TO ALL ROOF AREAS UNLESS NOTED OTHERWISE)



1. NOTIFY VA COTR FOR ANY UTILITY / EQUIPMENT SHUTDOWNS.
2. DISCONNECT, REMOVE AND REINSTALL EXISTING CONDUITS, ETC. AS REQUIRED TO INSTALL NEW ROOF SYSTEM AND CONDUIT SUPPORTS.
3. EXISTING CONDUIT SUPPORTS, REFER TO DETAIL ON 1A-701 FOR WEAR PAD DETAILS.
4. DISCONNECT, REMOVE AND REINSTALL EXISTING EQUIPMENT. AS REQUIRED TO INSTALL NEW ROOF SYSTEM AND FLASHING.
5. CONTRACTOR SHALL SUBMIT DETAILED INSTALLATION DRAWINGS FOR ALL ROOF REPLACEMENTS AS SHOWN AND SPECIFIED. DRAWINGS SHALL BE APPROVED BY THE MEMBRANE SUPPLIER, WARRANTY UNDERWRITER AND CONTRACTOR.
6. CONTRACTOR SHALL SUBMIT AS-BUILT DRAWINGS FOR ALL ROOF REPLACEMENTS. DETAIL SHALL BE APPROVED BY THE MEMBRANE SUPPLIER, WARRANTY UNDERWRITER AND CONTRACTOR.
7. WALKWAYS TO BE 30 INCH WIDE BY 60 INCH LONG MAX SECTION, 3mm THICK, INSTALLED PER MANUFACTURER'S SPECIFICATIONS.


(APPLIES TO ALL ROOF AREAS UNLESS NOTED OTHERWISE)

ACH	AIR COOLED CONDENSER
ALU	AIR HANDLING UNIT
CH	CHILLER
DS	DOWNSPOUT
EC	EXISTING CONDUIT
ED	EXISTING DUCTWORK
EF	EXHAUST FAN
EJ	EXPANSION JOINT
EP	ELECTRICAL PANEL
EQ	EQUAL DIMENSION
HB	HOSE BIBB
HP	HIGH POINT ON ROOF
LD	LADDER
RD	ROOF DRAIN
RECP	RECEPTACLE
SCP	SCUPPER
TD	TERRACE DRAIN
VENT	VENTILATION HOOD
VTR	VENT THRU ROOF

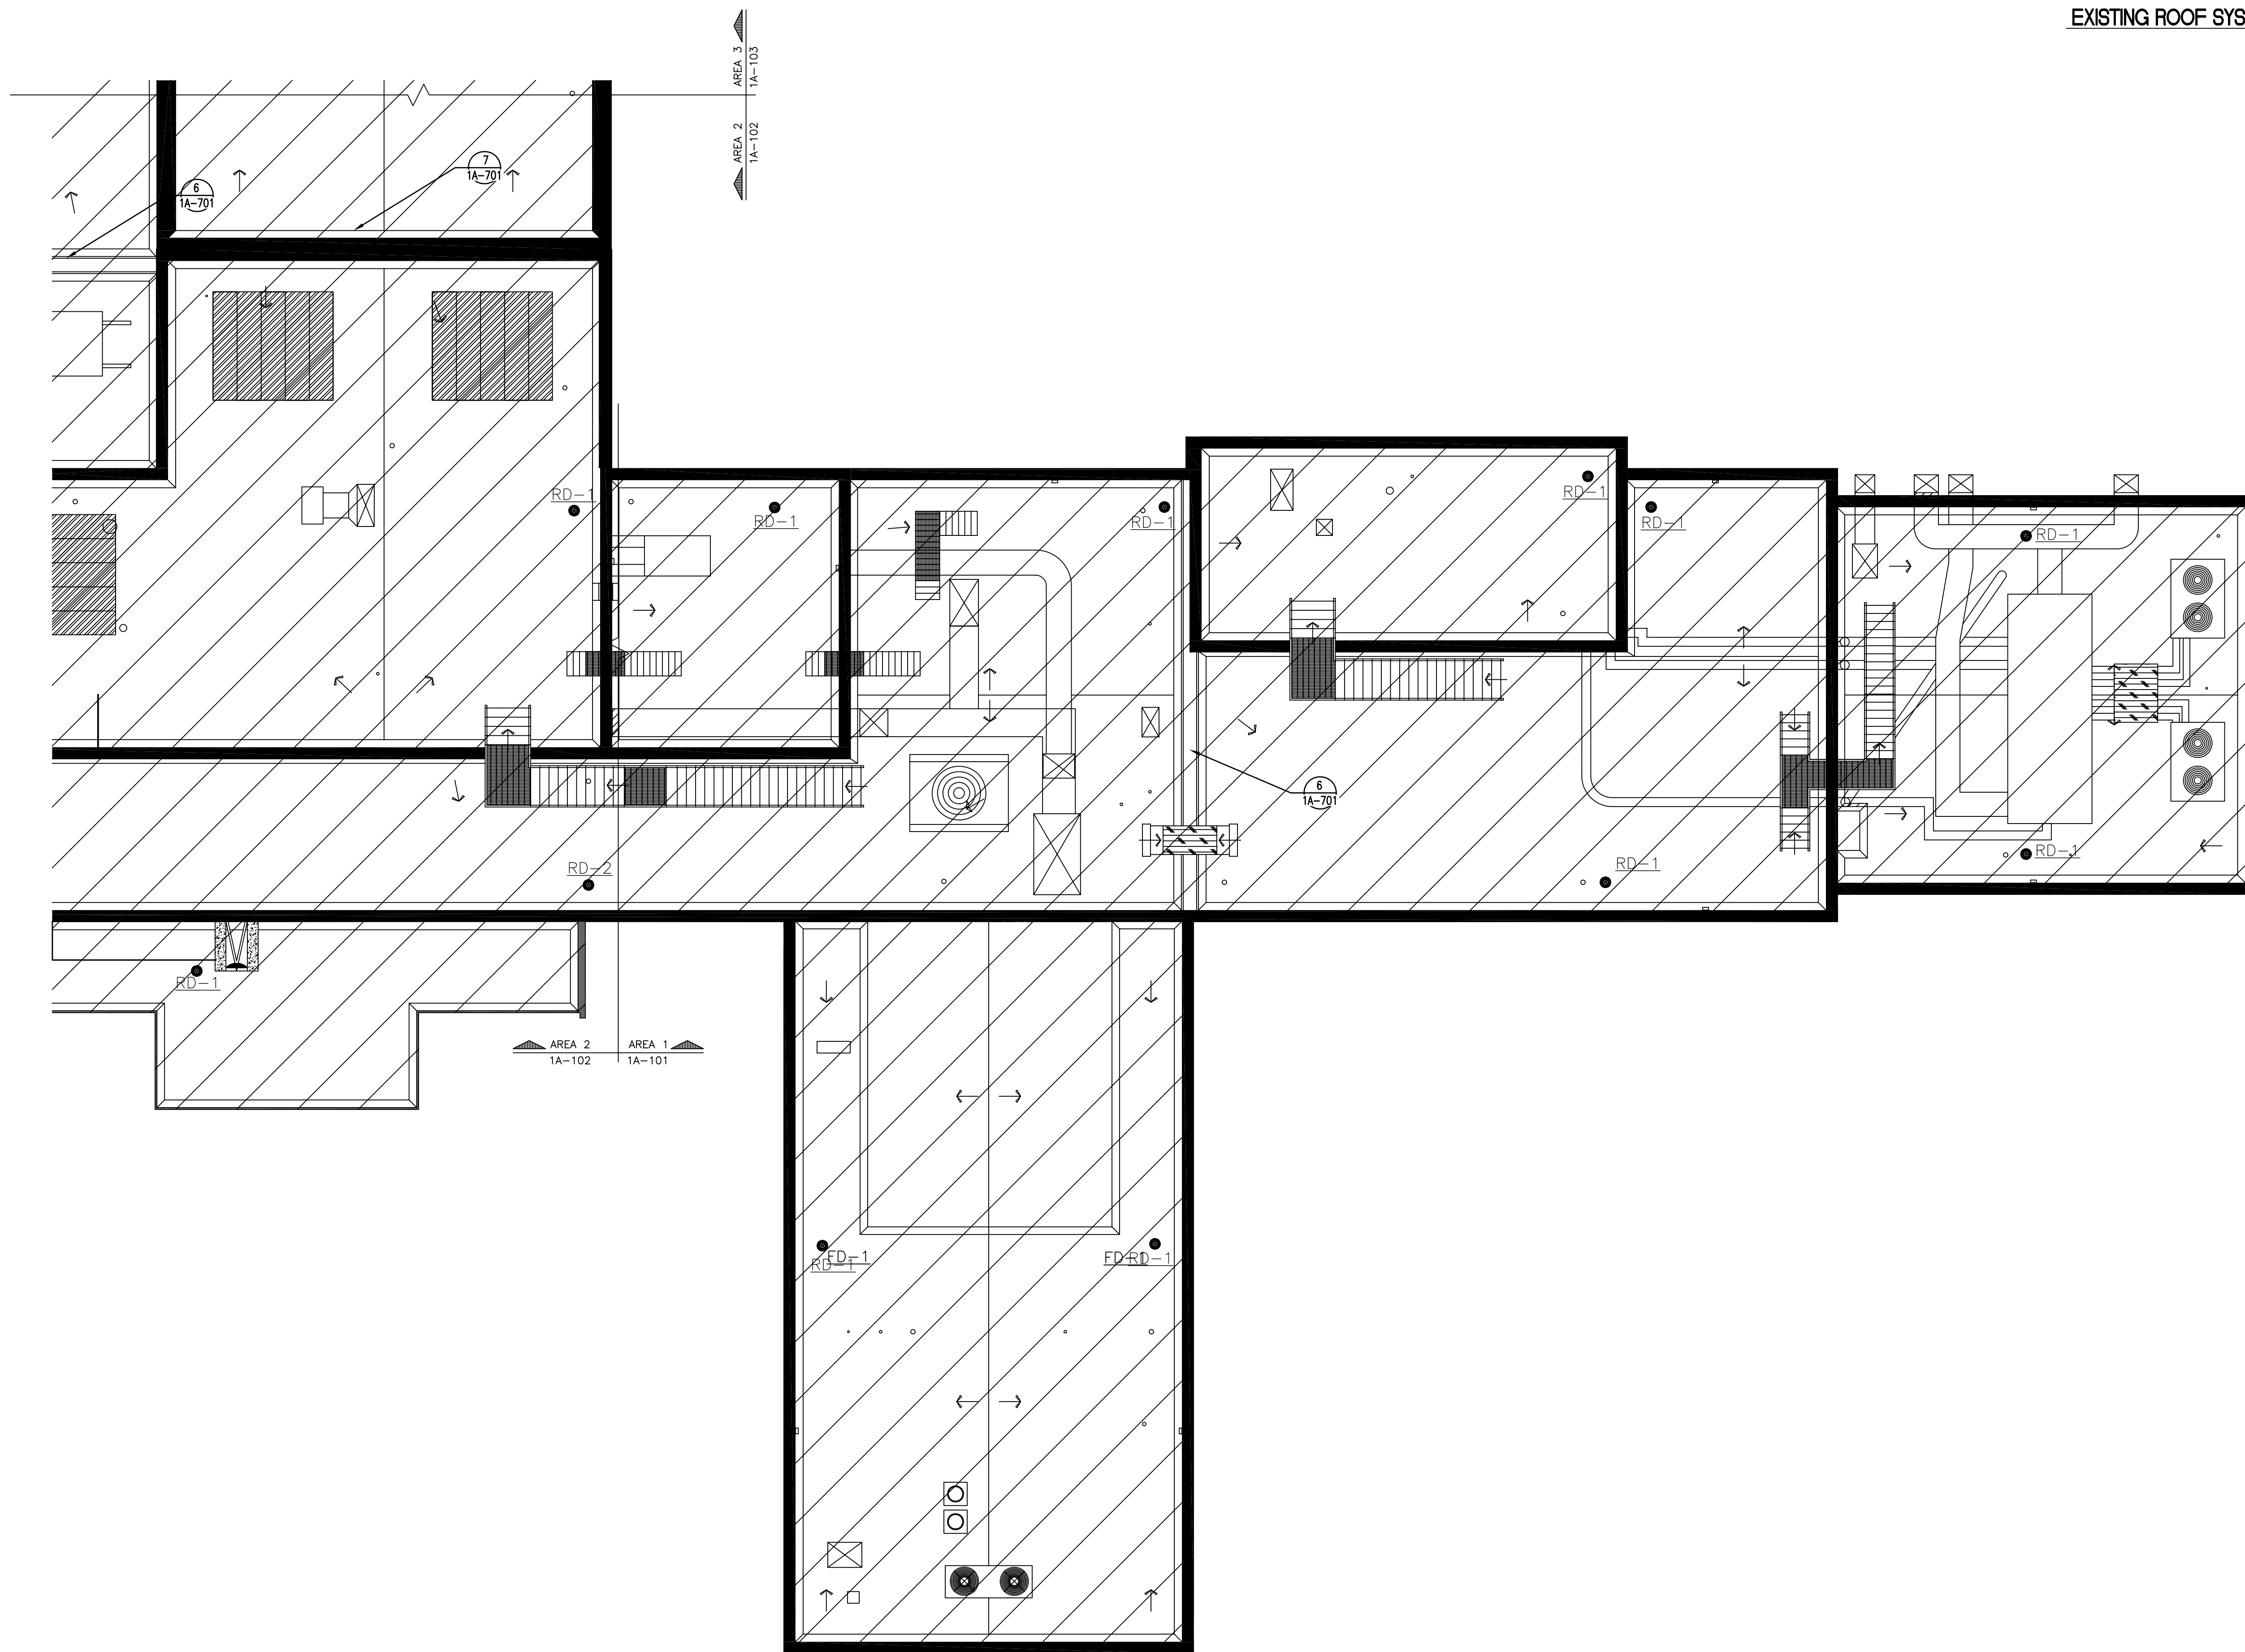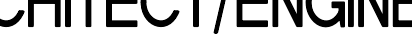1. HATCHED AREA INDICATES AREA OF ROOF SYSTEM TO BE REMOVED, ALL MATERIALS TO BE REMOVED BY CONTRACTOR FROM SITE. REFER TO SKETCH ON 1A101 FOR EXISTING ROOF SYSTEM.
2. REMOVE EXISTING AREA SUCH THAT NEW ROOF CAN BE REINSTALLED BY THE END OF THE DAY.
3. SEAL ALL WALL MASONRY WHICH IS PERPENDICULAR TO ROOF.
4. REMOVE AND REINSTALL NEW ROOF DRAINS IN HATCHED AREA.
5. VTR / PIPE PENETRATIONS SHOWN ON DRAWING, INDICATED BY CIRCLES.
6. DUCTWORK AND UNITS REPRESENTED BY CIRCLES.
7. SMALL CONDUTS (UNDER 1"), NOT SHOWN ON DRAWING.
8. WHEN ROOF IS DEMOLISHED, CONCRETE DECK SHALL BE SEAL COATED AND EPOXY COATED AND CRACKS REPAIRED.
9. REPLACEMENT OF DRAINS SHALL BE COORDINATED WITH COTR, TO ACCESS ROOM IN HOSPITAL WHICH DRAIN ENTERS.
10. SEE SHEET 1A101 FOR COORDINATION WITH NEW SCUPPERS PER DETAIL AND SPECIFICATIONS.



		CONSULTANTS:				ARCHITECT/ENGINEERS:		Drawing Title <b>BUILDING 1 ROOF PLAN AREA 1 DEMO</b>		Project Title <b>Roof Replacement for Building 19</b>		Project Number <b>655-11-128</b>		Office of Construction and Facilities Management					
						 Department of Veterans Affairs Aleda E Lutz Medical Center 1500 Weiss Street Saginaw, MI 48602		Approved: Project Director		Location <b>Aleda E. Lutz Saginaw VAMC</b>		Building Number <b>1</b>							
										Drawing Number <b>1AD-101</b>		Date 11/14/11		Checked KSR		Drawn RDP		 Department of Veterans Affairs	
Revisions:												Dwg. 2 of 10							

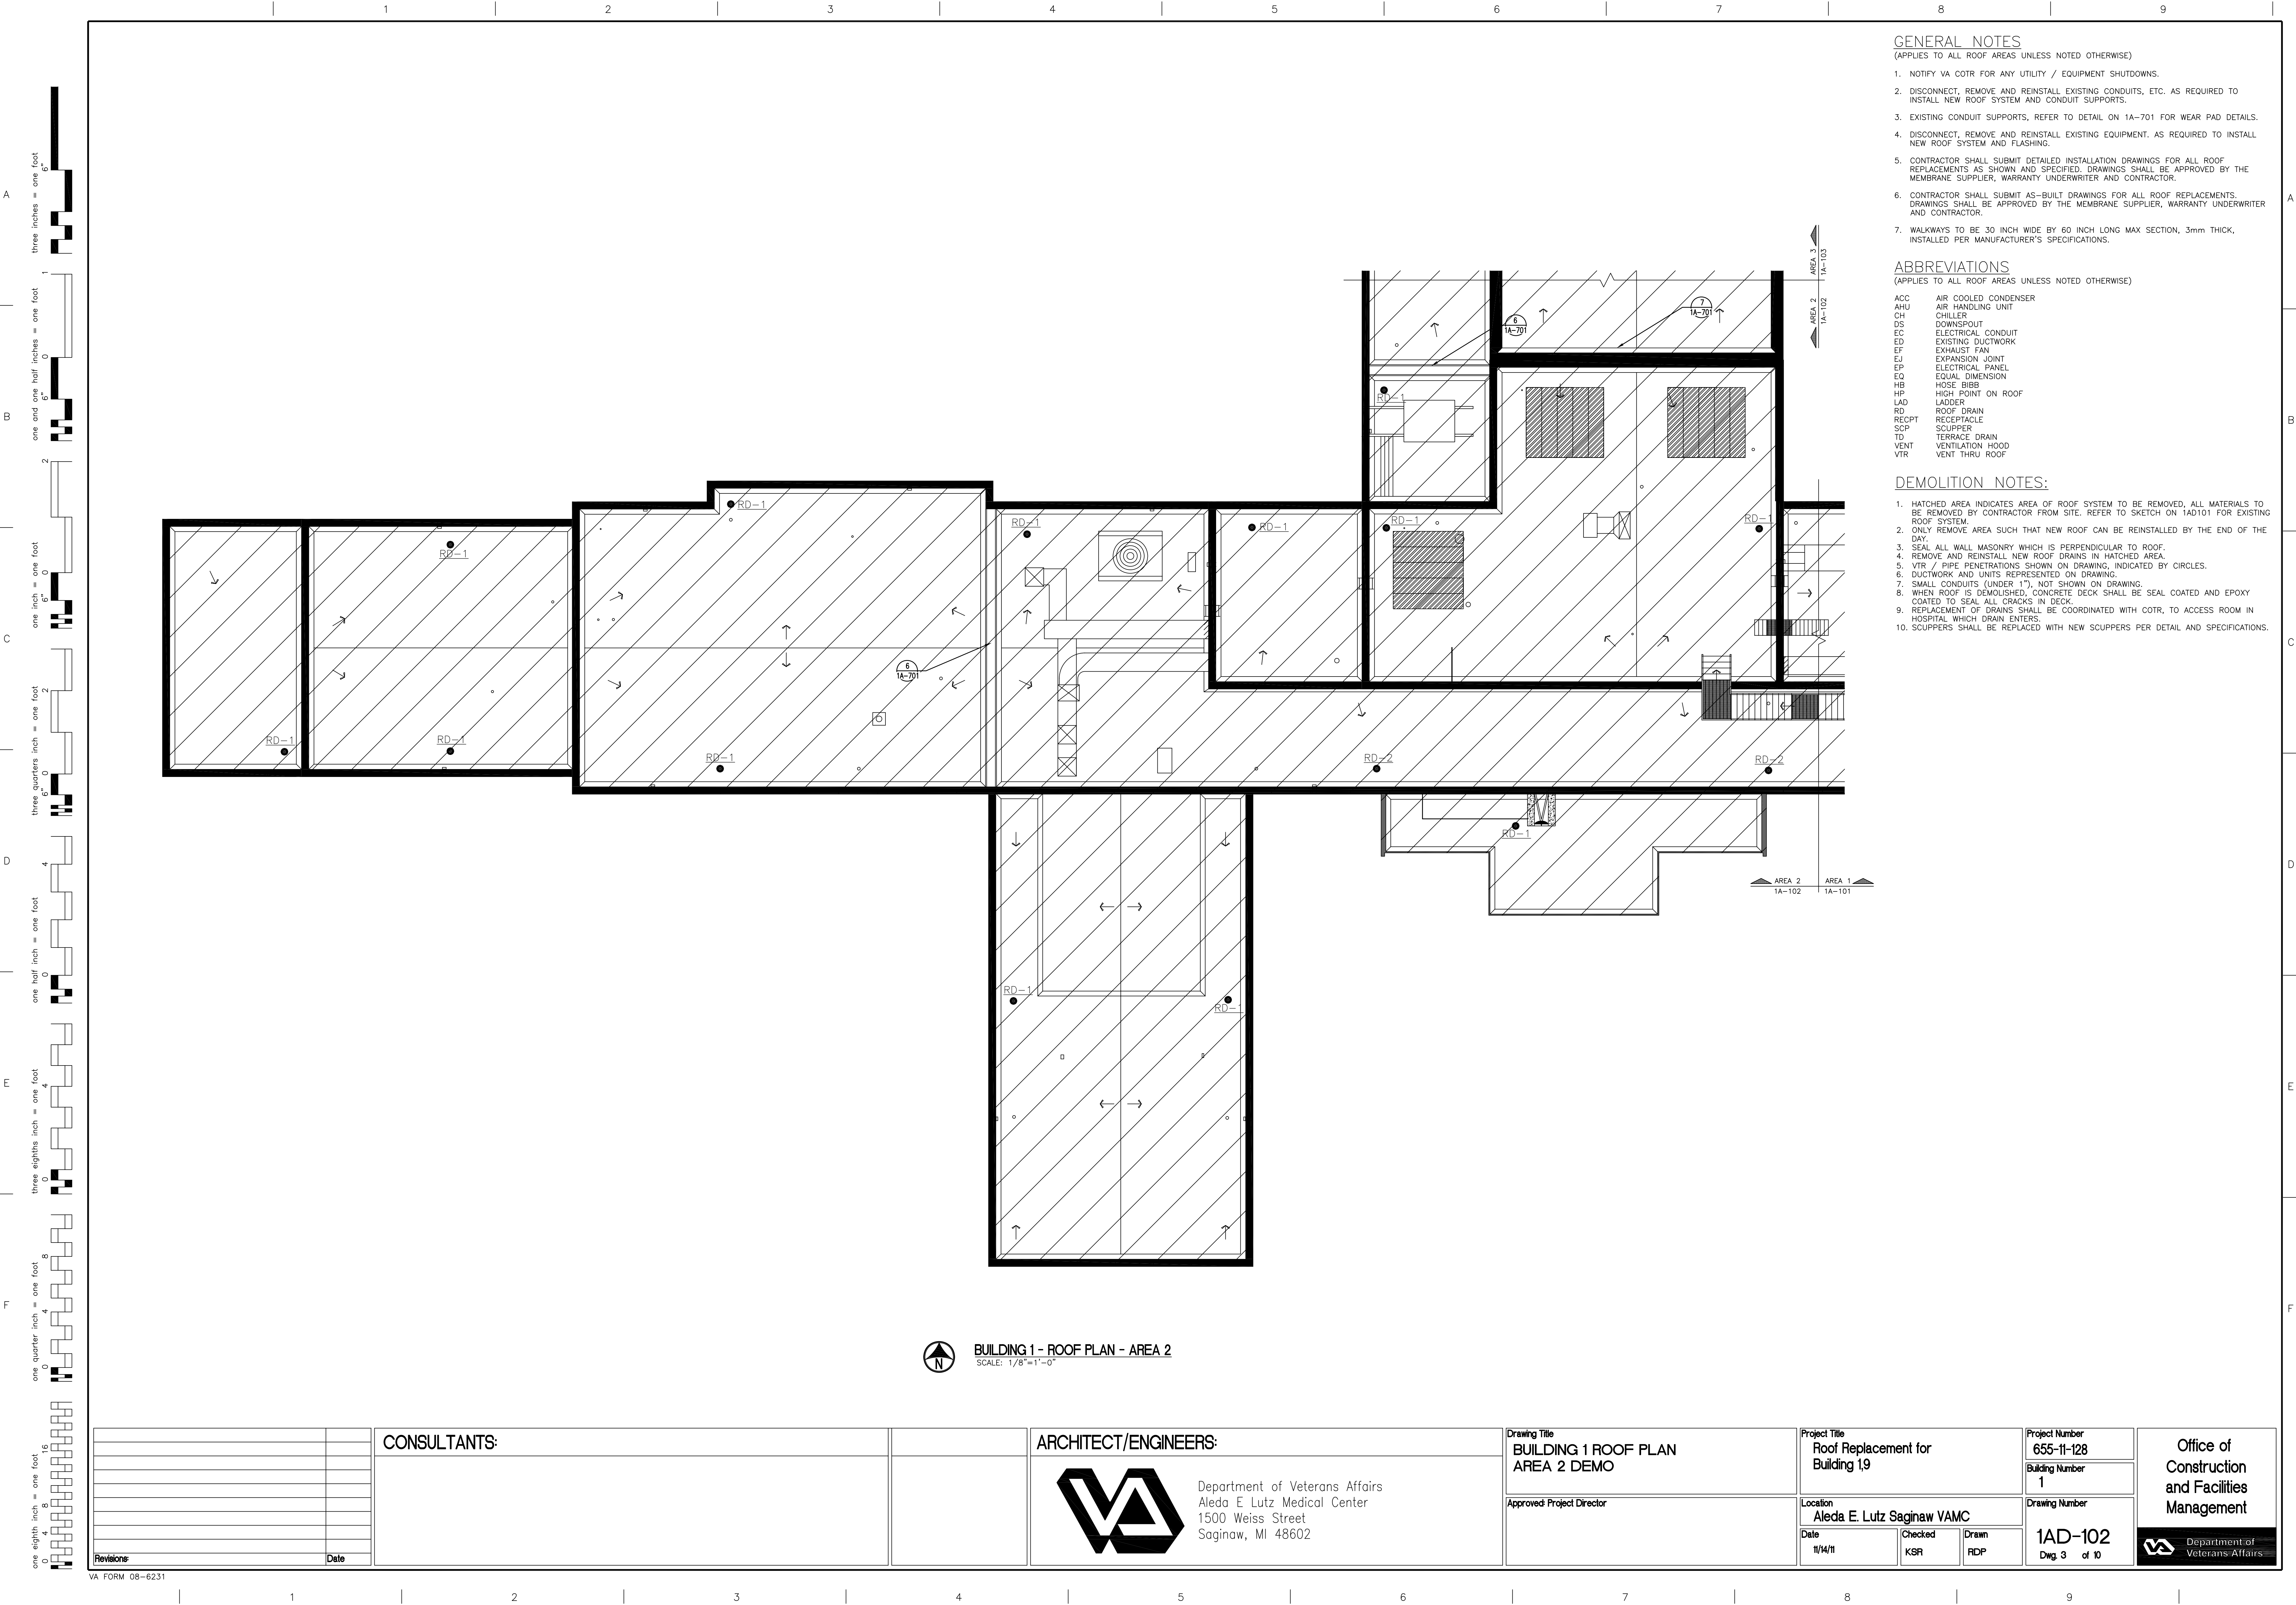



- GENERAL NOTES**  
(APPLIES TO ALL ROOF AREAS UNLESS NOTED OTHERWISE)
1. NOTIFY VA COTR FOR ANY UTILITY / EQUIPMENT SHUTDOWNS.
  2. DISCONNECT, REMOVE AND REINSTALL EXISTING CONDUITS, ETC. AS REQUIRED TO INSTALL NEW ROOF SYSTEM AND CONDUIT SUPPORTS.
  3. EXISTING CONDUIT SUPPORTS, REFER TO DETAIL ON 1A-701 FOR WEAR PAD DETAILS.
  4. DISCONNECT, REMOVE AND REINSTALL EXISTING EQUIPMENT. AS REQUIRED TO INSTALL NEW ROOF SYSTEM AND FLASHING.
  5. CONTRACTOR SHALL SUBMIT DETAILED INSTALLATION DRAWINGS FOR ALL ROOF REPLACEMENTS AS SHOWN AND SPECIFIED. DRAWINGS SHALL BE APPROVED BY THE MEMBRANE SUPPLIER, WARRANTY UNDERWRITER AND CONTRACTOR.
  6. CONTRACTOR SHALL SUBMIT AS-BUILT DRAWINGS FOR ALL ROOF REPLACEMENTS. DRAWINGS SHALL BE APPROVED BY THE MEMBRANE SUPPLIER, WARRANTY UNDERWRITER AND CONTRACTOR.
  7. WALKWAYS TO BE 30 INCH WIDE BY 60 INCH LONG MAX SECTION, 3mm THICK, INSTALLED PER MANUFACTURER'S SPECIFICATIONS.

- ABBREVIATIONS**  
(APPLIES TO ALL ROOF AREAS UNLESS NOTED OTHERWISE)
- |       |                      |
|-------|----------------------|
| ACC   | AIR COOLED CONDENSER |
| AHU   | AIR HANDLING UNIT    |
| CH    | CHILLER              |
| DS    | DOWNSPOUT            |
| EC    | ELECTRICAL CONDUIT   |
| ED    | EXISTING DUCTWORK    |
| EF    | EXHAUST FAN          |
| EJ    | EXPANSION JOINT      |
| EP    | ELECTRICAL PANEL     |
| EQ    | EQUAL DIMENSION      |
| HB    | HOSE BIBB            |
| HP    | HIGH POINT ON ROOF   |
| LAD   | LADDER               |
| RD    | ROOF DRAIN           |
| RECPT | RECEPTACLE           |
| SCP   | SCUPPER              |
| TD    | TERRACE DRAIN        |
| VENT  | VENTILATION HOOD     |
| VTR   | VENT THRU ROOF       |


- DEMOLITION NOTES:**
1. HATCHED AREA INDICATES AREA OF ROOF SYSTEM TO BE REMOVED. ALL MATERIALS TO BE REMOVED BY CONTRACTOR FROM SITE. REFER TO SKETCH ON 1AD101 FOR EXISTING ROOF SYSTEM.
  2. ONLY REMOVE AREA SUCH THAT NEW ROOF CAN BE REINSTALLED BY THE END OF THE DAY.
  3. SEAL ALL WALL MASONRY WHICH IS PERPENDICULAR TO ROOF.
  4. REMOVE AND REINSTALL NEW ROOF DRAINS IN HATCHED AREA.
  5. VTR / PIPE PENETRATIONS SHOWN ON DRAWING, INDICATED BY CIRCLES.
  6. DUCTWORK AND UNITS REPRESENTED ON DRAWING.
  7. SMALL CONDUITS (UNDER 1"), NOT SHOWN ON DRAWING.
  8. WHEN ROOF IS DEMOLISHED, CONCRETE DECK SHALL BE SEAL COATED AND EPOXY COATED TO SEAL ALL CRACKS IN DECK.
  9. REPLACEMENT OF DRAINS SHALL BE COORDINATED WITH COTR, TO ACCESS ROOM IN HOSPITAL WHICH DRAIN ENTERS.
  10. SCUPPERS SHALL BE REPLACED WITH NEW SCUPPERS PER DETAIL AND SPECIFICATIONS.

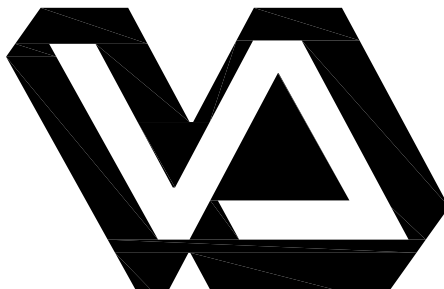
**BUILDING 1 - ROOF PLAN - AREA 2**  
SCALE: 1/8"=1'-0"

		<b>CONSULTANTS:</b>		<b>ARCHITECT/ENGINEERS:</b>   Department of Veterans Affairs Aleda E Lutz Medical Center 1500 Weiss Street Saginaw, MI 48602		Drawing Title <b>BUILDING 1 ROOF PLAN AREA 2 DEMO</b>		Project Title <b>Roof Replacement for Building 1,9</b>		Project Number <b>655-11-128</b>		<b>Office of Construction and Facilities Management</b>			
								Building Number <b>1</b>							
						Approved Project Director		Location <b>Aleda E. Lutz Saginaw VAMC</b>		Drawing Number <b>1AD-102</b>					
						Date <b>1/14/11</b>		Checked <b>KSR</b>		Drawn <b>RDP</b>				Dwg. 3 of 10	
<b>Revisions:</b>		<b>Date</b>										 Department of Veterans Affairs			





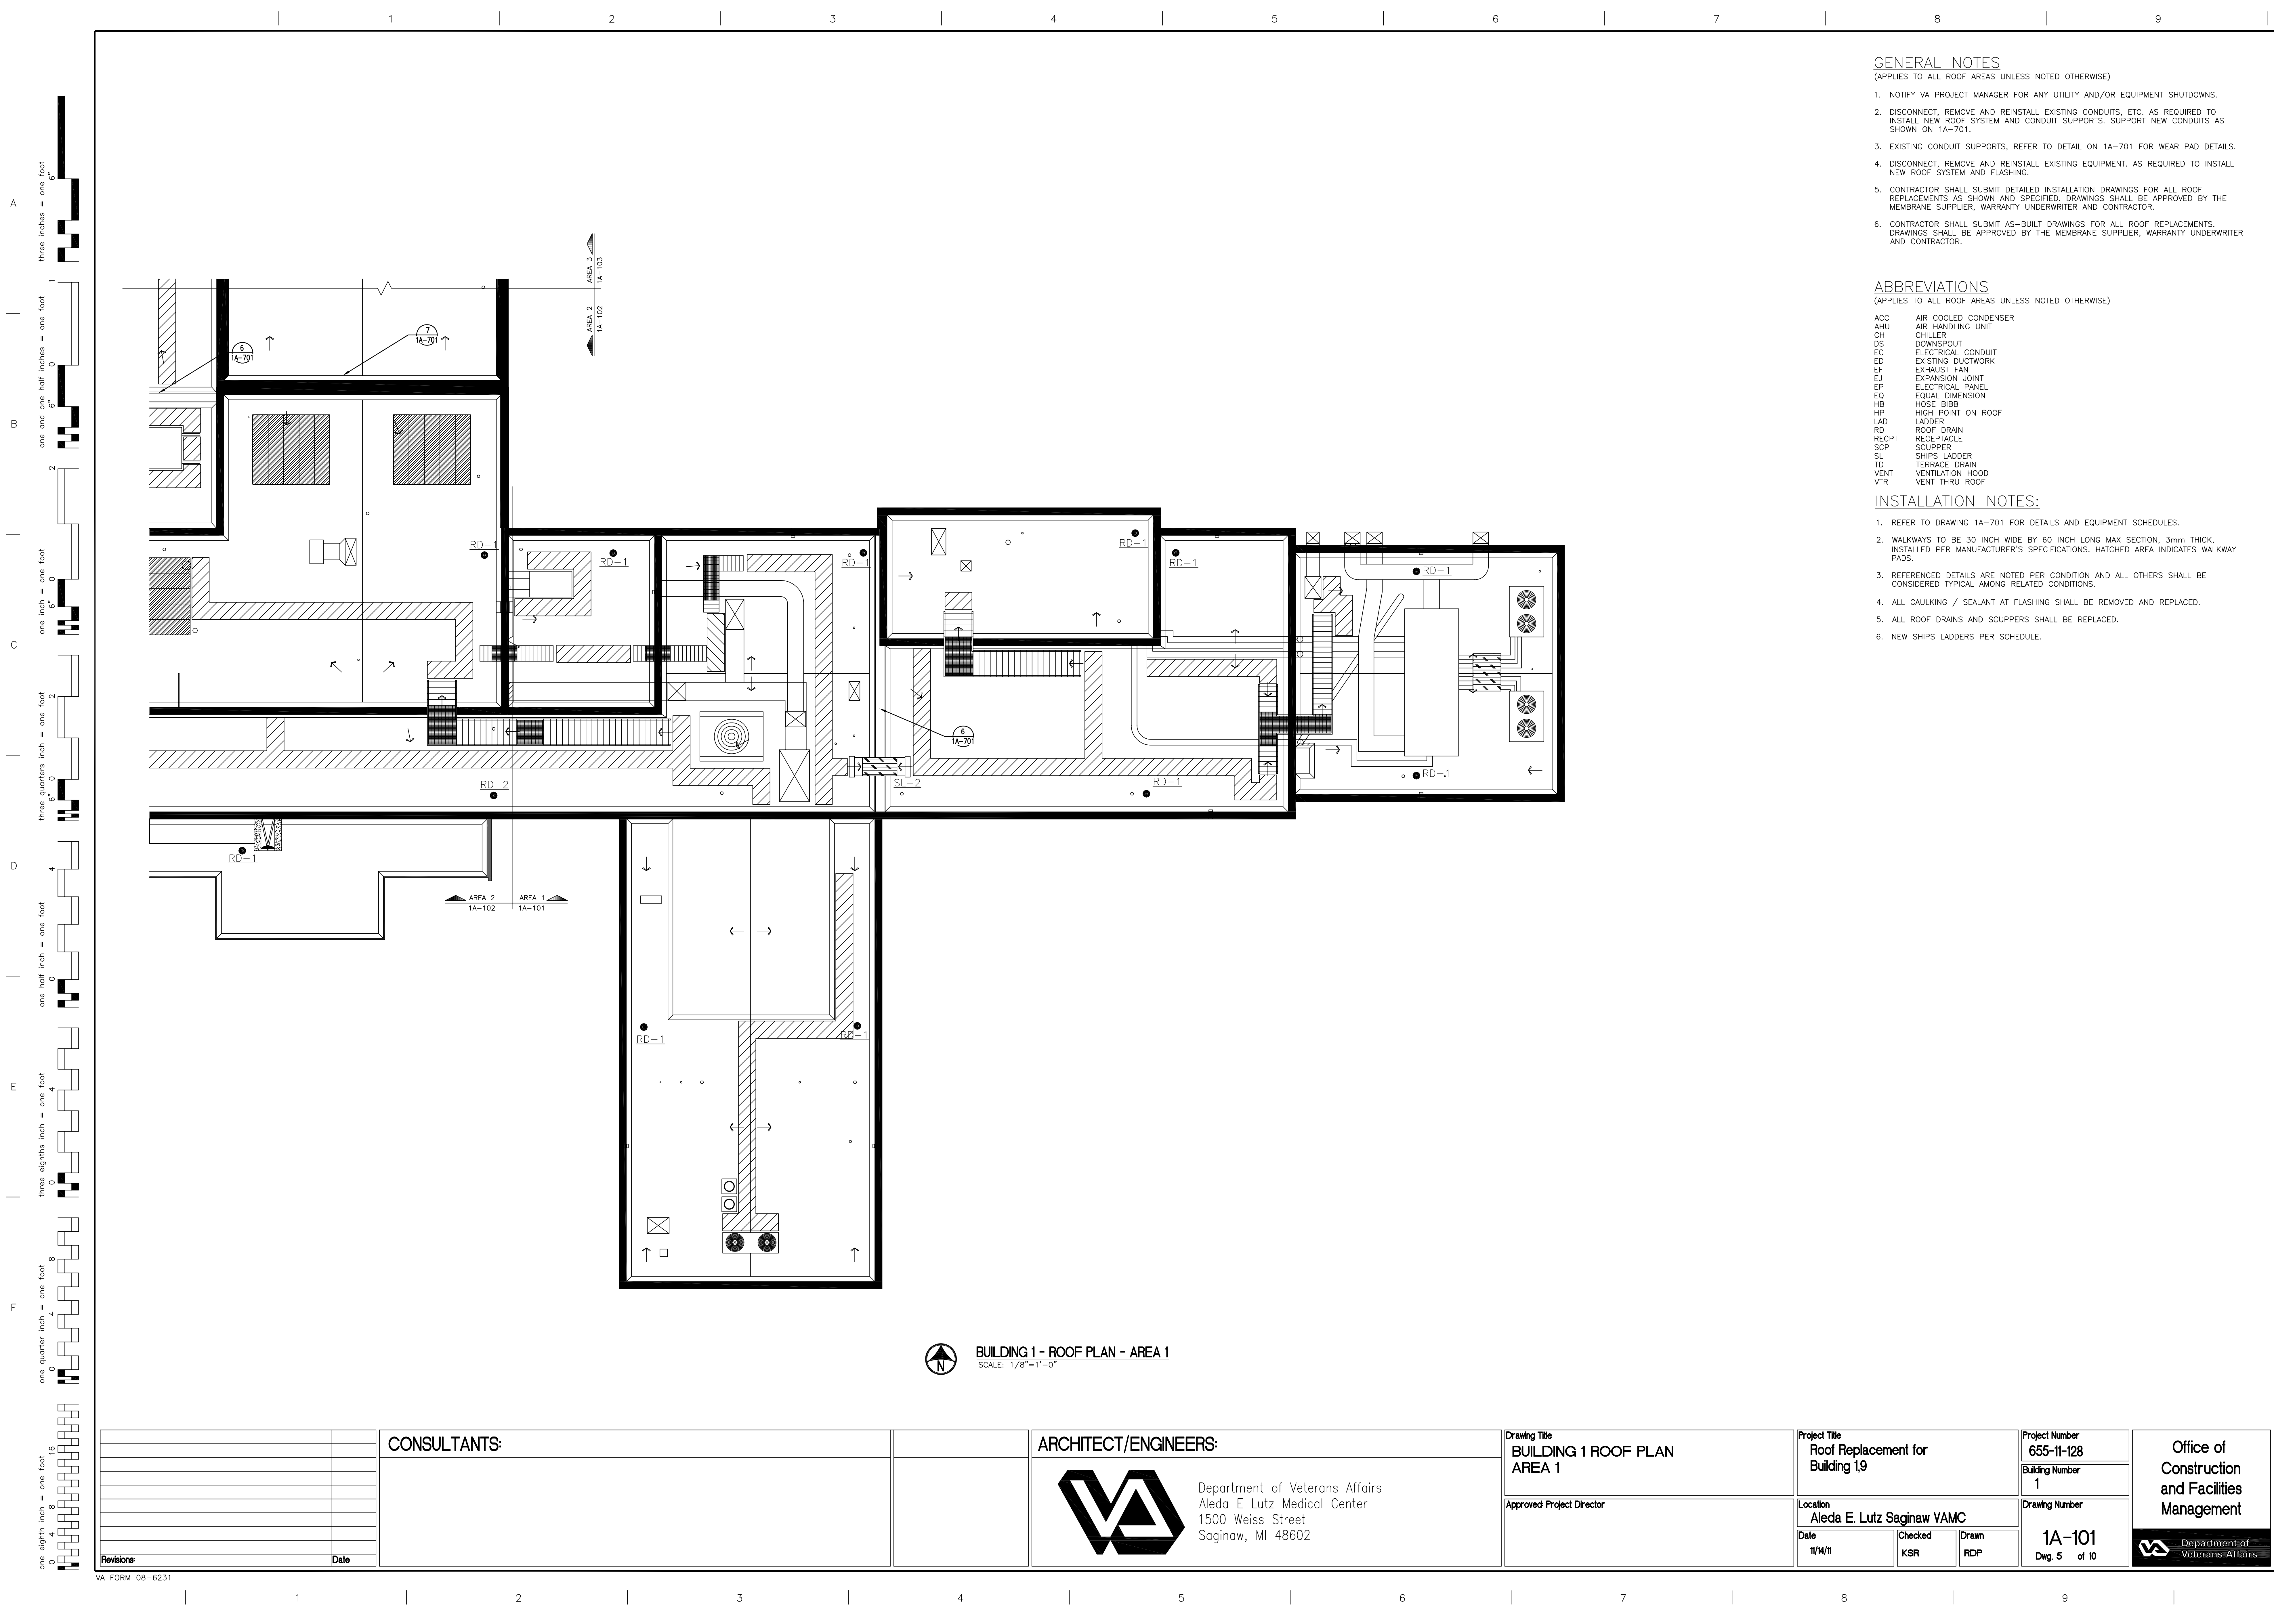

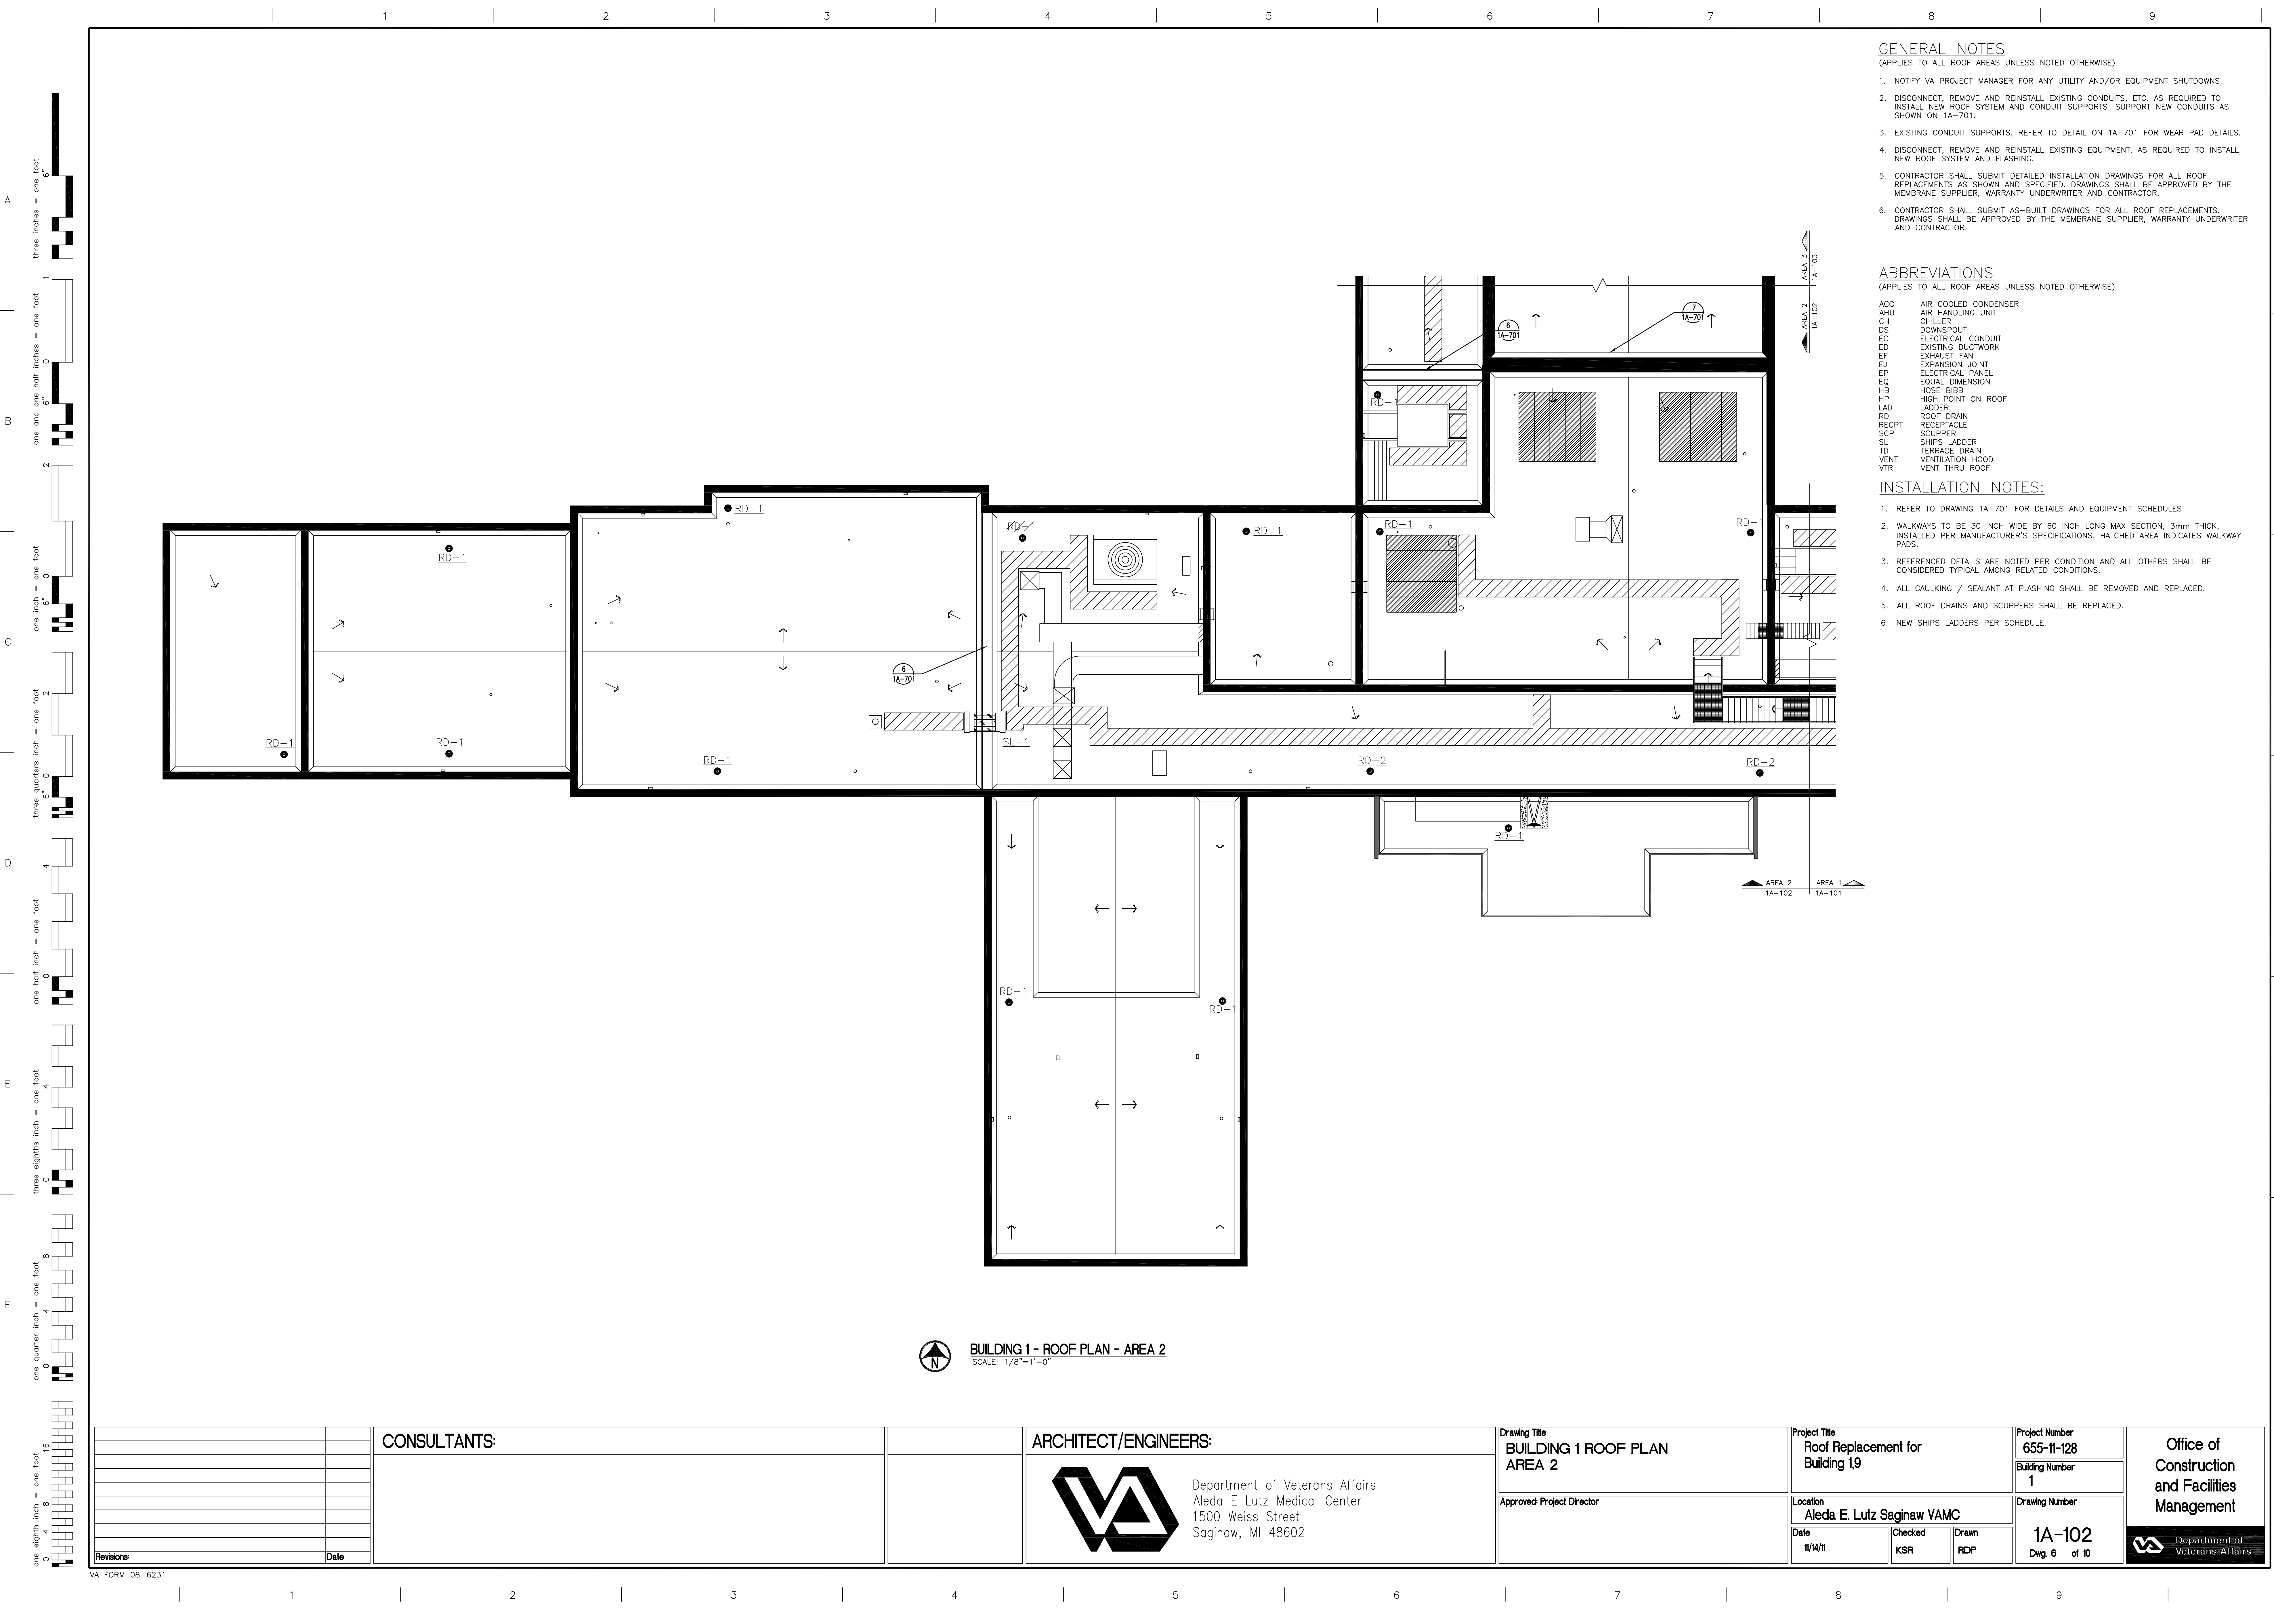

GENERAL NOTES

(APPLIES TO ALL ROOF AREAS UNLESS NOTED OTHERWISE)

1. NOTIFY VA PROJECT MANAGER FOR ANY UTILITY AND/OR EQUIPMENT SHUTDOWNS.
2. DISCONNECT, REMOVE AND REINSTALL EXISTING CONDUITS, ETC. AS REQUIRED TO INSTALL NEW ROOF SYSTEM AND CONDUIT SUPPORTS. SUPPORT NEW CONDUITS AS SHOWN ON 1A-701.
3. EXISTING CONDUIT SUPPORTS, REFER TO DETAIL ON 1A-701 FOR WEAR PAD DETAILS.
4. DISCONNECT, REMOVE AND REINSTALL EXISTING EQUIPMENT. AS REQUIRED TO INSTALL NEW ROOF SYSTEM AND FLASHING.
5. CONTRACTOR SHALL SUBMIT DETAILED INSTALLATION DRAWINGS FOR ALL ROOF REPLACEMENTS AS SHOWN AND SPECIFIED. DRAWINGS SHALL BE APPROVED BY THE MEMBRANE SUPPLIER, WARRANTY UNDERWRITER AND CONTRACTOR.
6. CONTRACTOR SHALL SUBMIT AS-BUILT DRAWINGS FOR ALL ROOF REPLACEMENTS. DRAWINGS SHALL BE APPROVED BY THE MEMBRANE SUPPLIER, WARRANTY UNDERWRITER AND CONTRACTOR.

ABBREVIATIONS

(APPLIES TO ALL ROOF AREAS UNLESS NOTED OTHERWISE)

- ACC AIR COOLED CONDENSER  
AHU AIR HANDLING UNIT  
CH CHILLER  
DS DOWNSPOUT  
EC ELECTRICAL CONDUIT  
ED EXISTING DUCTWORK  
EF EXHAUST FAN  
EJ EXPANSION JOINT  
EP ELECTRICAL PANEL  
EQ EQUAL DIMENSION  
HB HOSE BIBB  
HP HIGH POINT ON ROOF  
LAD LADDER  
RD ROOF DRAIN  
RECPT RECEPTACLE  
SCP SCUPPER  
SL SHIPS LADDER  
TD TERRACE DRAIN  
VENT VENTILATION HOOD  
VTR VENT THRU ROOF

INSTALLATION NOTES:

1. REFER TO DRAWING 1A-701 FOR DETAILS AND EQUIPMENT SCHEDULES.
2. WALKWAYS TO BE 30 INCH WIDE BY 60 INCH LONG MAX SECTION, 3mm THICK, INSTALLED PER MANUFACTURER'S SPECIFICATIONS. HATCHED AREA INDICATES WALKWAY PADS.
3. REFERENCED DETAILS ARE NOTED PER CONDITION AND ALL OTHERS SHALL BE CONSIDERED TYPICAL AMONG RELATED CONDITIONS.
4. ALL CAULKING / SEALANT AT FLASHING SHALL BE REMOVED AND REPLACED.
5. ALL ROOF DRAINS AND SCUPPERS SHALL BE REPLACED.
6. NEW SHIPS LADDERS PER SCHEDULE.



BUILDING 1 - ROOF PLAN - AREA 2  
SCALE: 1/8"=1'-0"

CONSULTANTS:

ARCHITECT/ENGINEERS:



Department of Veterans Affairs  
Aleda E Lutz Medical Center  
1500 Weiss Street  
Saginaw, MI 48602

Drawing Title  
BUILDING 1 ROOF PLAN  
AREA 2

Approved Project Director

Project Title  
Roof Replacement for  
Building 19

Location  
Aleda E. Lutz Saginaw VAMC

Project Number  
655-11-128

Building Number  
1

Drawing Number  
1A-102

Dwg 6 of 10

Office of  
Construction  
and Facilities  
Management




- GENERAL NOTES**  
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  3. EXISTING CONDUIT SUPPORTS, REFER TO DETAIL ON 1A-701 FOR WEAR PAD DETAILS.
  4. DISCONNECT, REMOVE AND REINSTALL EXISTING EQUIPMENT. AS REQUIRED TO INSTALL NEW ROOF SYSTEM AND FLASHING.
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**ABBREVIATIONS**  
(APPLIES TO ALL ROOF AREAS UNLESS NOTED OTHERWISE)


ACC AIR COOLED CONDENSER  
AHU AIR HANDLING UNIT  
CH CHILLER  
DS DOWNSPOUT  
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RECPT RECEPTACLE  
SCP SCUPPER  
SL SHIPS LADDER  
TD TERRACE DRAIN  
VENT VENTILATION HOOD  
VTR VENT THRU ROOF

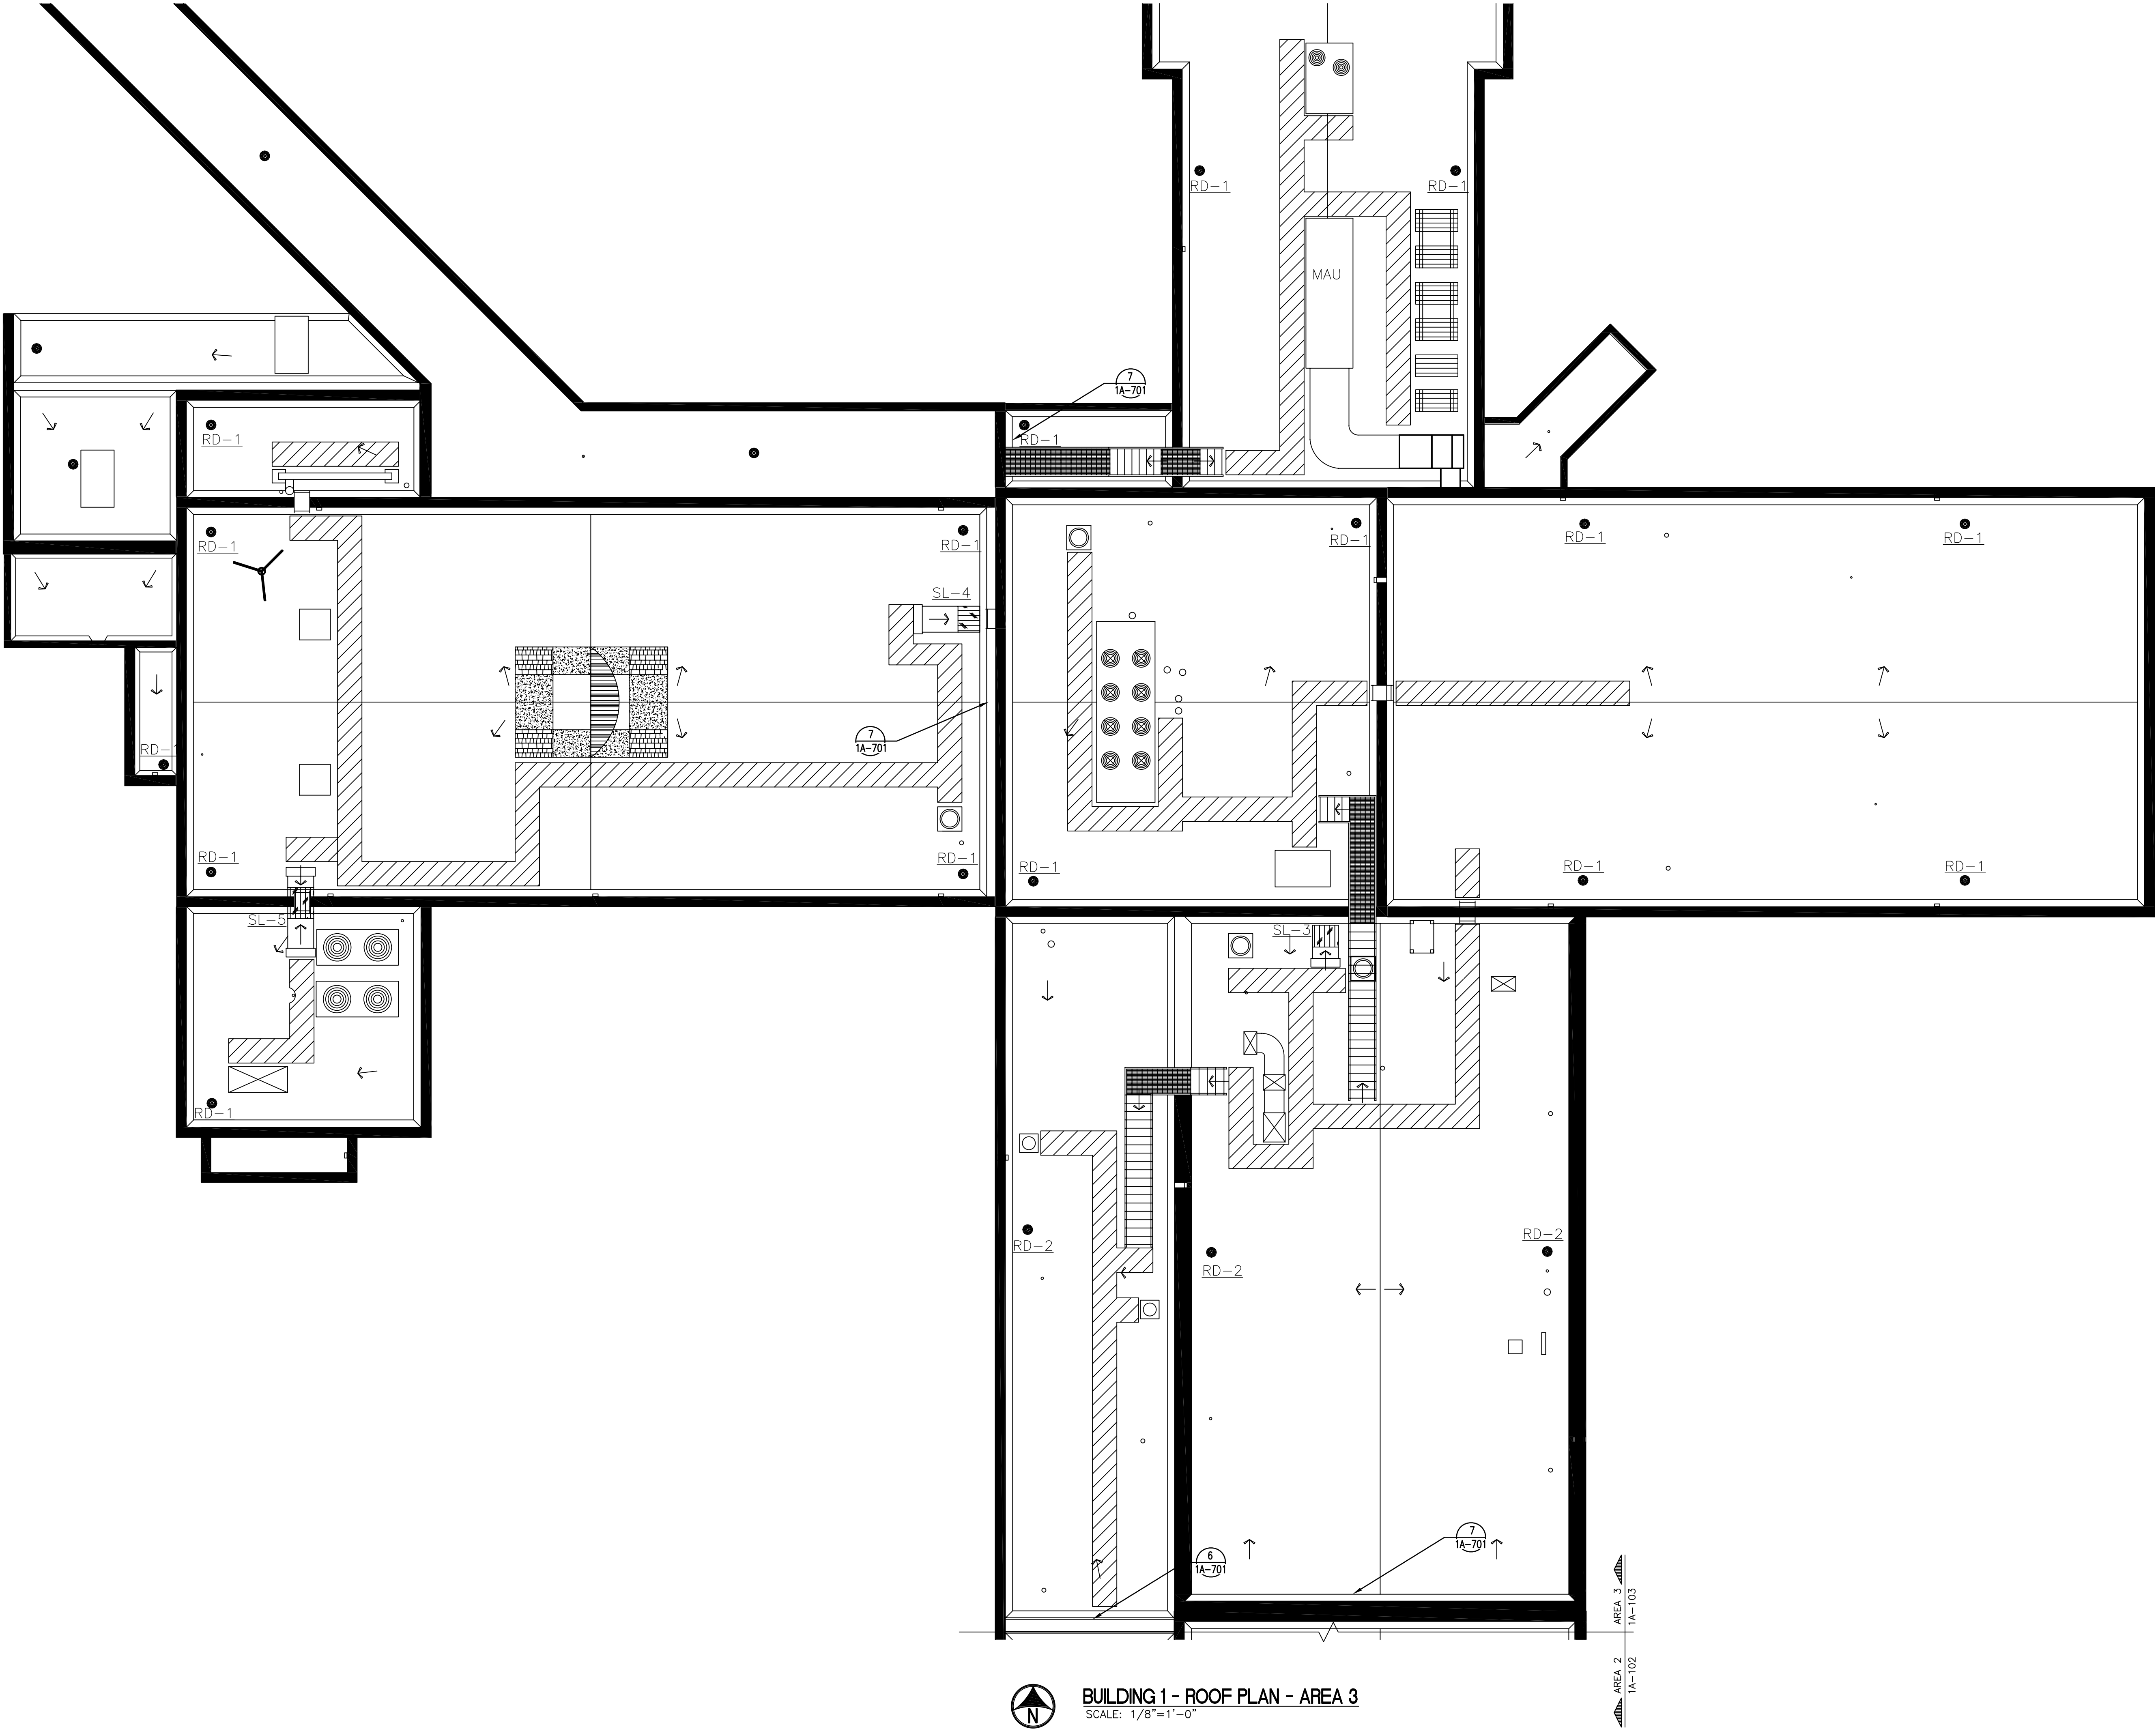- INSTALLATION NOTES:**
1. REFER TO DRAWING 1A-701 FOR DETAILS AND EQUIPMENT SCHEDULES.
  2. WALKWAYS TO BE 30 INCH WIDE BY 60 INCH LONG MAX SECTION, 3mm THICK, INSTALLED PER MANUFACTURER'S SPECIFICATIONS. HATCHED AREA INDICATES WALKWAY PADS.
  3. REFERENCED DETAILS ARE NOTED PER CONDITION AND ALL OTHERS SHALL BE CONSIDERED TYPICAL AMONG RELATED CONDITIONS.
  4. ALL CAULKING / SEALANT AT FLASHING SHALL BE REMOVED AND REPLACED.
  5. ALL ROOF DRAINS AND SCUPPERS SHALL BE REPLACED.
  6. NEW SHIPS LADDERS PER SCHEDULE.



**BUILDING 1 - ROOF PLAN - AREA 3**  
SCALE: 1/8"=1'-0"

<b>CONSULTANTS:</b>		<b>ARCHITECT/ENGINEERS:</b>		<b>Drawing Title</b> BUILDING 1 ROOF PLAN AREA 3		<b>Project Title</b> Roof Replacement for Building 1,9		<b>Project Number</b> 655-11-128		<b>Office of Construction and Facilities Management</b>  Department of Veterans Affairs
				<b>Approved: Project Director</b>		<b>Location</b> Aleda E. Lutz Saginaw VAMC		<b>Building Number</b> 1		
						<b>Date</b> 11/14/11		<b>Checked</b> KSR		
						<b>Drawn</b> RDP		<b>Drawing Number</b> 1A-103 Dwg 7 of 10		

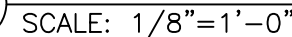



1. TABS THAT ARE PARALLEL TO THE EXPANSION JOINT MUST BE MECHANICALLY FASTENED WITH THE SAME FASTENING PATTERN USED ON THE MEMBRANE IN THE FIELD AREA.
2. LEAVE THE MEMBRANE COVERING THE EXPANSION JOINT LOOSE ENOUGH TO ALLOW FOR MOVEMENT OF THE BUILDING ON EITHER SIDE OF THE JOINT.

RD-1 JOSAM 22010 ROOF DRAIN, CAST IRON, 12" DIAMETER ROOF DRAIN, 4" CONNECTION, NO HUB CONNECTION, UNDERDECK CLAMP, CAST IRON DOME STRAINER, ADJ. DRAINAGE COLLAR, VERIFY SIZE OF DRAIN LINE.

303AM 22010 ROOF DRAIN, CAST IRON, 12" DIAMETER ROOF DRAIN, 3" CONNECTION, NO HUB CONNECTION, UNDERDECK CLAMP, CAST IRON DOME STRAINER, ADJ. DRAINAGE COLLAR, VERIFY SIZE OF DRAIN LINE.

LAD-1 LADDER SIDE MEMBERS ARE 1/4"x2"x2" STEEL ANGLE. 3/4" CORRUGATED STEEL ROUND CLIMBING RUNGS ON 12"CENTERS. STAND-OFF BRACKETS ARE 7". WALK-THRU HANDRAILS EXTEND 42" ABOVE LANDING SURFACE. SAFETY CAGES ARE DESIGNED TO OSHA SPECIFICATIONS WITH FLARED BOTTOM OPENING FOR EASY ENTRY. CAGE BEGINS 6' 9" FROM BOTTOM RUNG. WELDED ONE-PIECE TO MEET OR EXCEED ANSI A14.3, OSHA 1910.27 AND 1926.1053 STANDARDS.

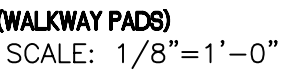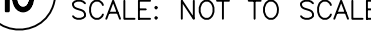SL-1 THRU SL-7  
SHIPS LADDER: HEAVY DUTY BAR GRATING STAIR TREADS.  
1.1 1/2" X 14" SQUARE  
TUBING. 10" STRUCTURAL CHANNEL STRINGERS. STANDARD 24"  
WIDE TREADS, 27" OVERALL STAIR WIDTH. TREAD DEPTH IS 6".  
WELDED ONE-PIECE TO MEET OR EXCEED ANSI A14.3, OSHA  
1910.27 AND 1926.1053 STANDARDS. CONTRACTOR TO  
VERIFY NUMBER OF TREADS NEEDED FOR EACH LOCATION.



1. FLANGES OF ADJACENT FLASHINGS SHALL NOT BE CUT OR OVERLAPPED.
2. COORDINATE FLASHING INSTALLATION TO ENSURE PROPER METHODS & MATERIALS ARE USED TO MAINTAIN ROOF WARRANTY.

VA FORM 08-6231






- GENERAL NOTES  
(APPLIES TO ALL ROOF AREAS UNLESS NOTED OTHERWISE)
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ACC AIR COOLED CONDENSER  
AHU AIR HANDLING UNIT  
CH CHILLER  
DS DOWNSPOUT  
EC ELECTRICAL CONDUIT  
ED EXISTING DUCTWORK  
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EP ELECTRICAL PANEL  
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SL SHIPS LADDER  
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VENT VENTILATION HOOD  
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- INSTALLATION NOTES:
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  2. WALKWAYS TO BE 30 INCH WIDE BY 60 INCH LONG MAX SECTION, 3mm THICK, INSTALLED PER MANUFACTURER'S SPECIFICATIONS. HATCHED AREA INDICATES WALKWAY PADS.
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  5. ALL ROOF DRAINS AND SCUPPERS SHALL BE REPLACED.
  6. NEW SHIPS LADDERS PER SCHEDULE.



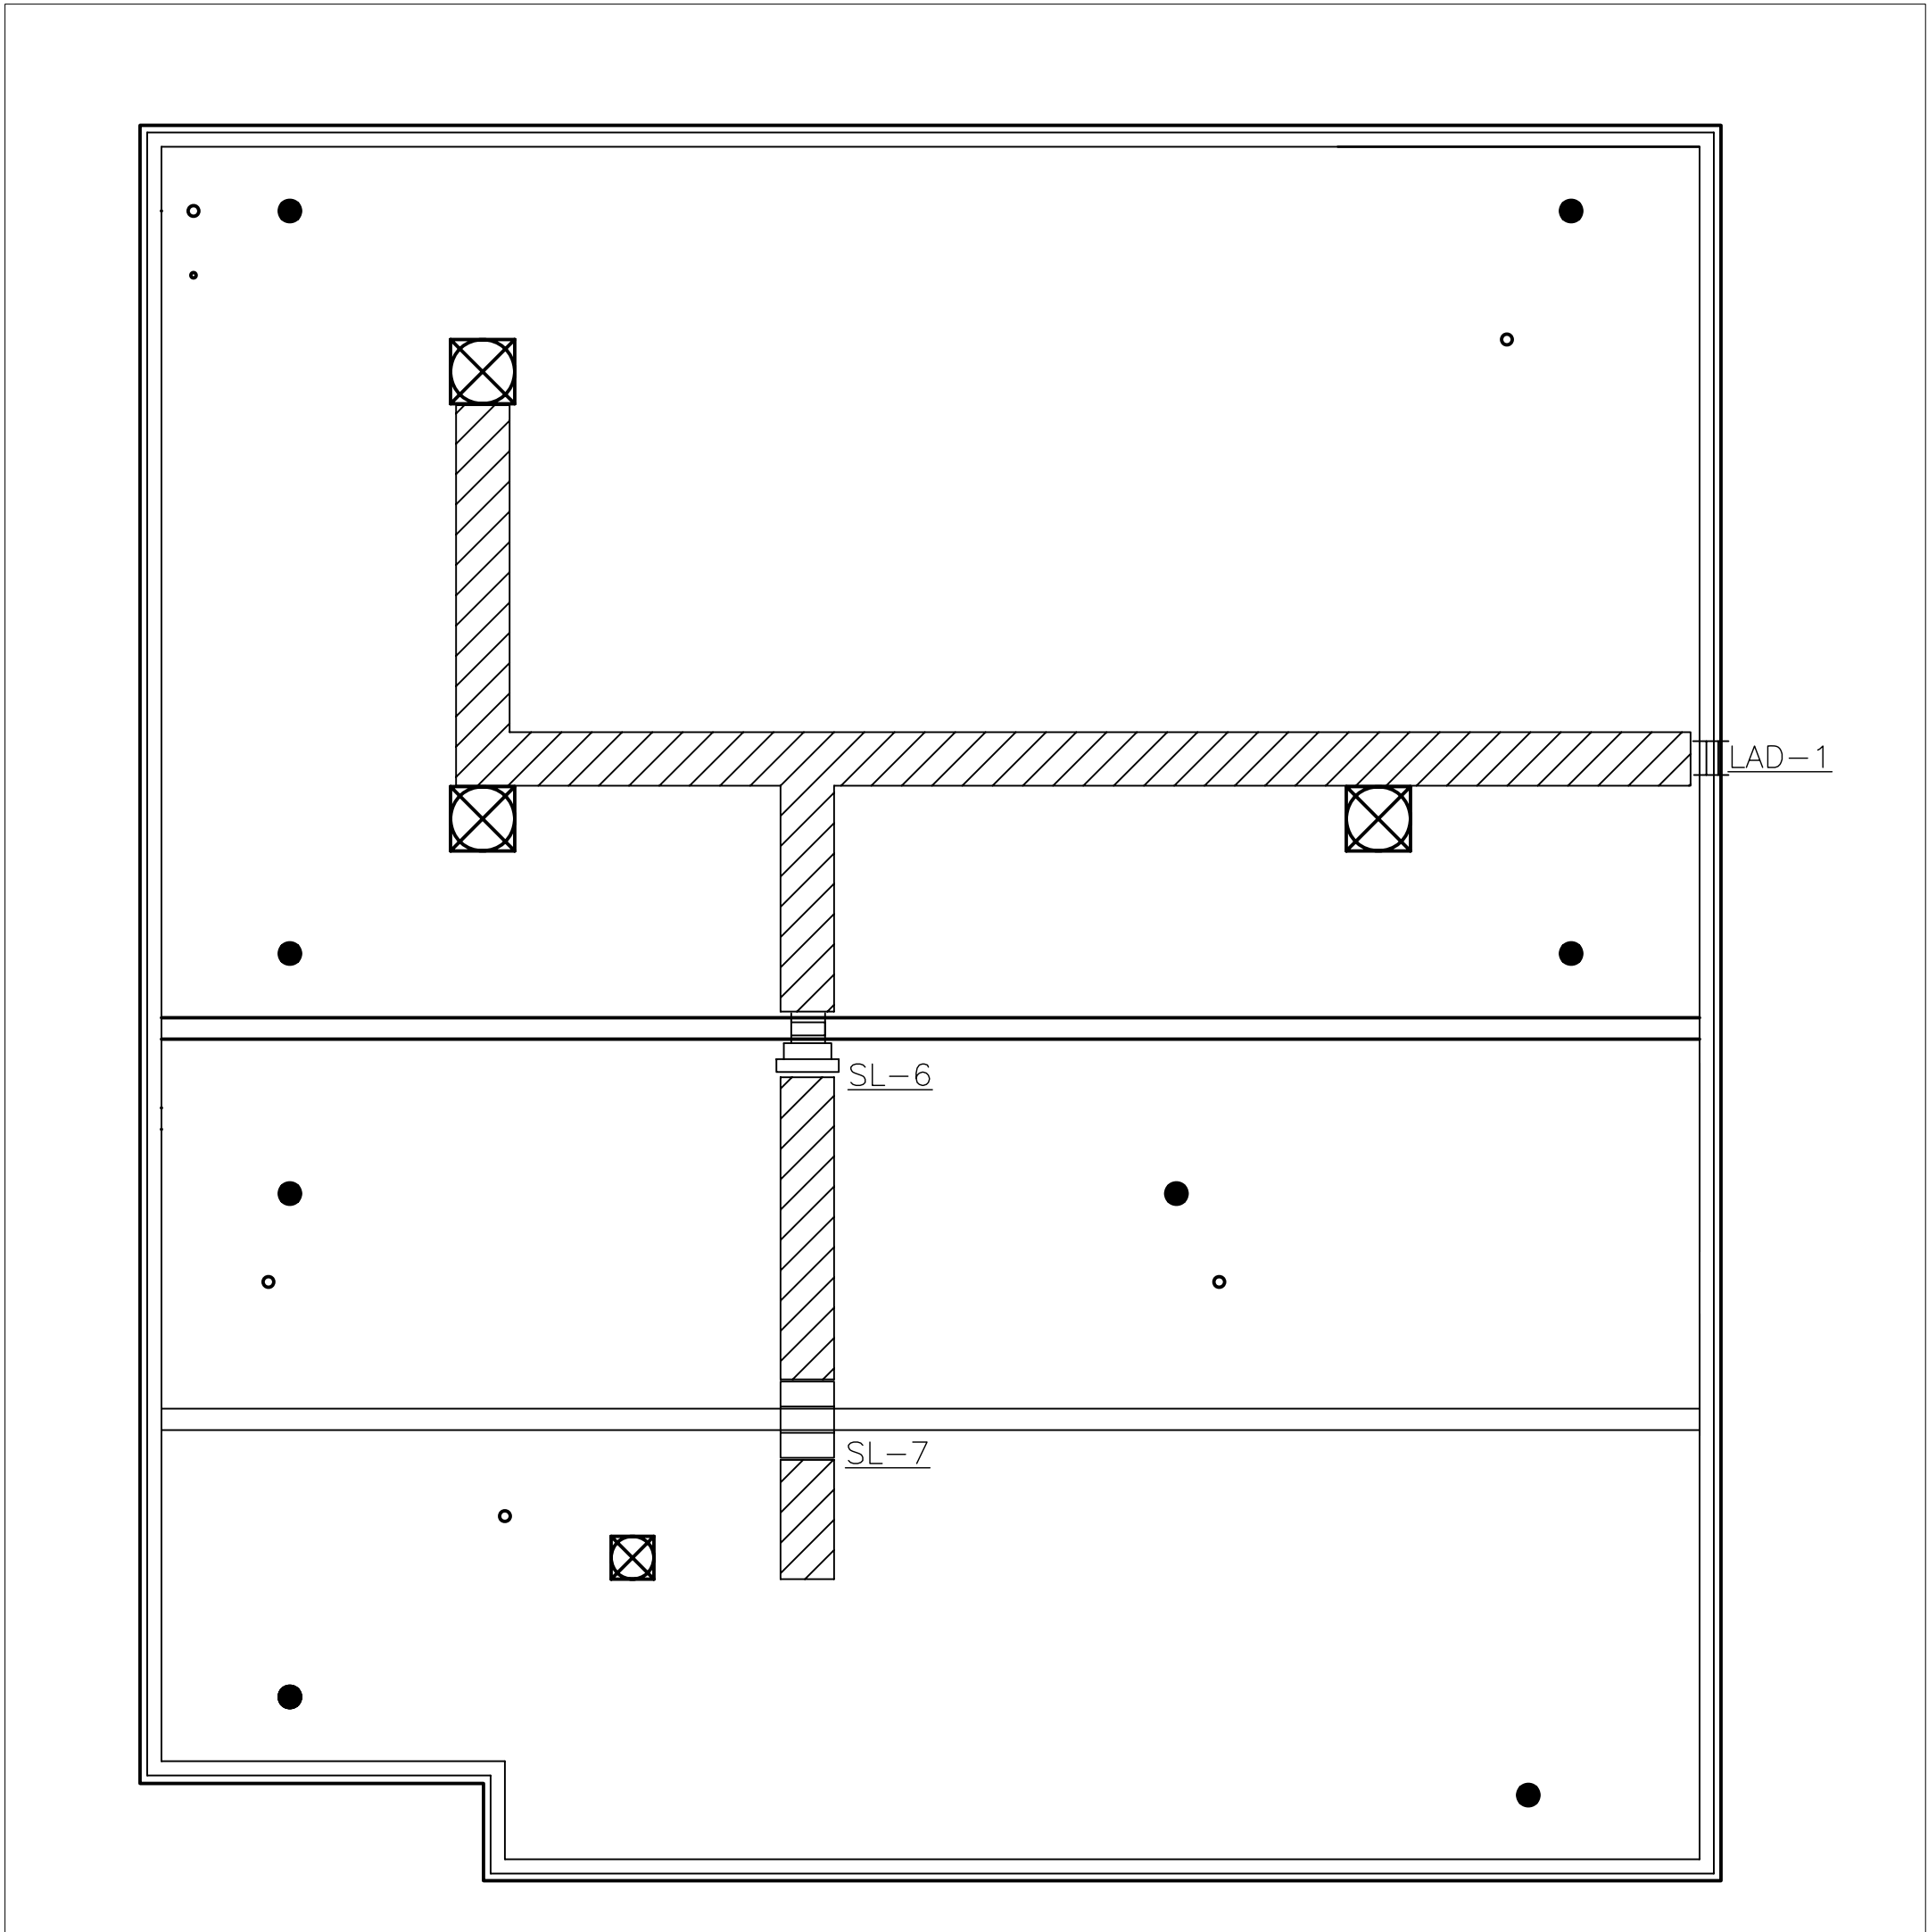BUILDING 9 - ROOF PLAN AREA 1  
SCALE: 1/8"=1'-0"

		CONSULTANTS:				ARCHITECT/ENGINEERS:		Drawing Title BUILDING 9 ROOF PLAN AREA 1		Project Title Roof Replacement for Building 19		Project Number 655-11-128		Office of Construction and Facilities Management 			
						Department of Veterans Affairs Aleda E Lutz Medical Center 1500 Weiss Street Saginaw, MI 48602		Approved: Project Director		Location Aleda E. Lutz Saginaw VAMC		Building Number 9					
								Date 11/14/11		Checked KSR		Drawn RDP				Drawing Number 9A-101	
																Dwg. 10 of 10	
Revisions		Date															