

three eighths inch = one foot
one and one half inches = one foot
one inch = one foot
three quarters inch = one foot
one half inch = one foot
three eighths inch = one foot
one quarter inch = one foot
one eighth inch = one foot


GENERAL NOTES

- COORDINATE EXACT LOCATION OF THE STREAM LINE PLUMBING CONNECTIONS WITH EQUIPMENT INSTRUCTIONS PRIOR TO ROUGH-IN.
- MATCH EXISTING LAB FIXTURES, BRAND, AND MODEL NUMBER FOR INSTALLATION OF NEW OR RELOCATION OF EXISTING LAB EQUIPMENT AND CONNECTIONS.
- CONTRACTOR IS RESPONSIBLE TO PATCH AND REPAIR ALL FLOORS, WALLS, AND CEILING DAMAGE CAUSED BY INSTALLING OR MOVING EQUIPMENT.
- ALL DEVICES AND EQUIPMENT EXISTING WITHIN THE AREA OF WORK WHICH ARE NOT SHOWN ARE EXISTING TO REMAIN.
- ALL EQUIPMENT AND FIXTURES REMAIN THE PROPERTY OF THE GOVERNMENT. THE CONTRACTOR IS RESPONSIBLE TO MOVE ALL EXCESS EQUIPMENT AND FIXTURES TO THE HOSPITAL LOADING DOCK.


- THE CONTRACTOR IS RESPONSIBLE TO PROTECT ALL EXISTING EQUIPMENT DURING THE RENOVATION.
- STREAM LAB EQUIPMENT TO BE FURNISH AND INSTALLED BY OTHERS.

KEYED NOTES

- RUN VENT LINE IN UTILITY CABINET CAVITY.
- CAP FLOOR DRAIN.
- PROVIDE AIR COCK AND 3/4" COPPER LINE FOR CENTRIFUGE.
- REMOVE SINK, HARDWARE AND ASSOCIATED PIPING AS INDICATED. SINK HARDWARE TO BE PRESERVED AND REINSTALLED AT LOCATION 7.
- (X) INDICATES EQUIPMENT AND MATERIAL TO BE REMOVED AND LINES TO BE CAPPED.
- FURNISH AND INSTALL NEW FLOOR DRAIN FIXTURE AND PIPING, MAKE CONNECTIONS AS SHOWN.
- INSTALL SINK, FAUCET, HARDWARE AND TABLE. USE MATERIAL FROM REMOVED FIXTURE AT ITEM 4.
- FURNISH AND INSTALL BALL VALVES, 1/2" NPT MALE FITTINGS AT TERMINATION CONNECTION END AND COPPER WATER LINES FOR VISTA ANALYZERS AT STREAM LAB.
- FURNISH AND INSTALL 1/2" COPPER AIR LINE WITH MOUNTING HARDWARE, 3/8" FEMALE THREADED FITTING (STREAM LAB END), VALVE, FILTER, AND ADJUSTABLE PRESSURE GAUGE FROM AIR COMPRESSOR IN RM 215 TO STREAM LAB LOCATION OF VALVE. AIR COMPRESSOR FURNISHED BY OTHERS.
- CONTRACTOR TO FIELD VERIFY LOCATION OF ALL FIXTURES AND PIPING PRIOR TO ROUGH-IN.

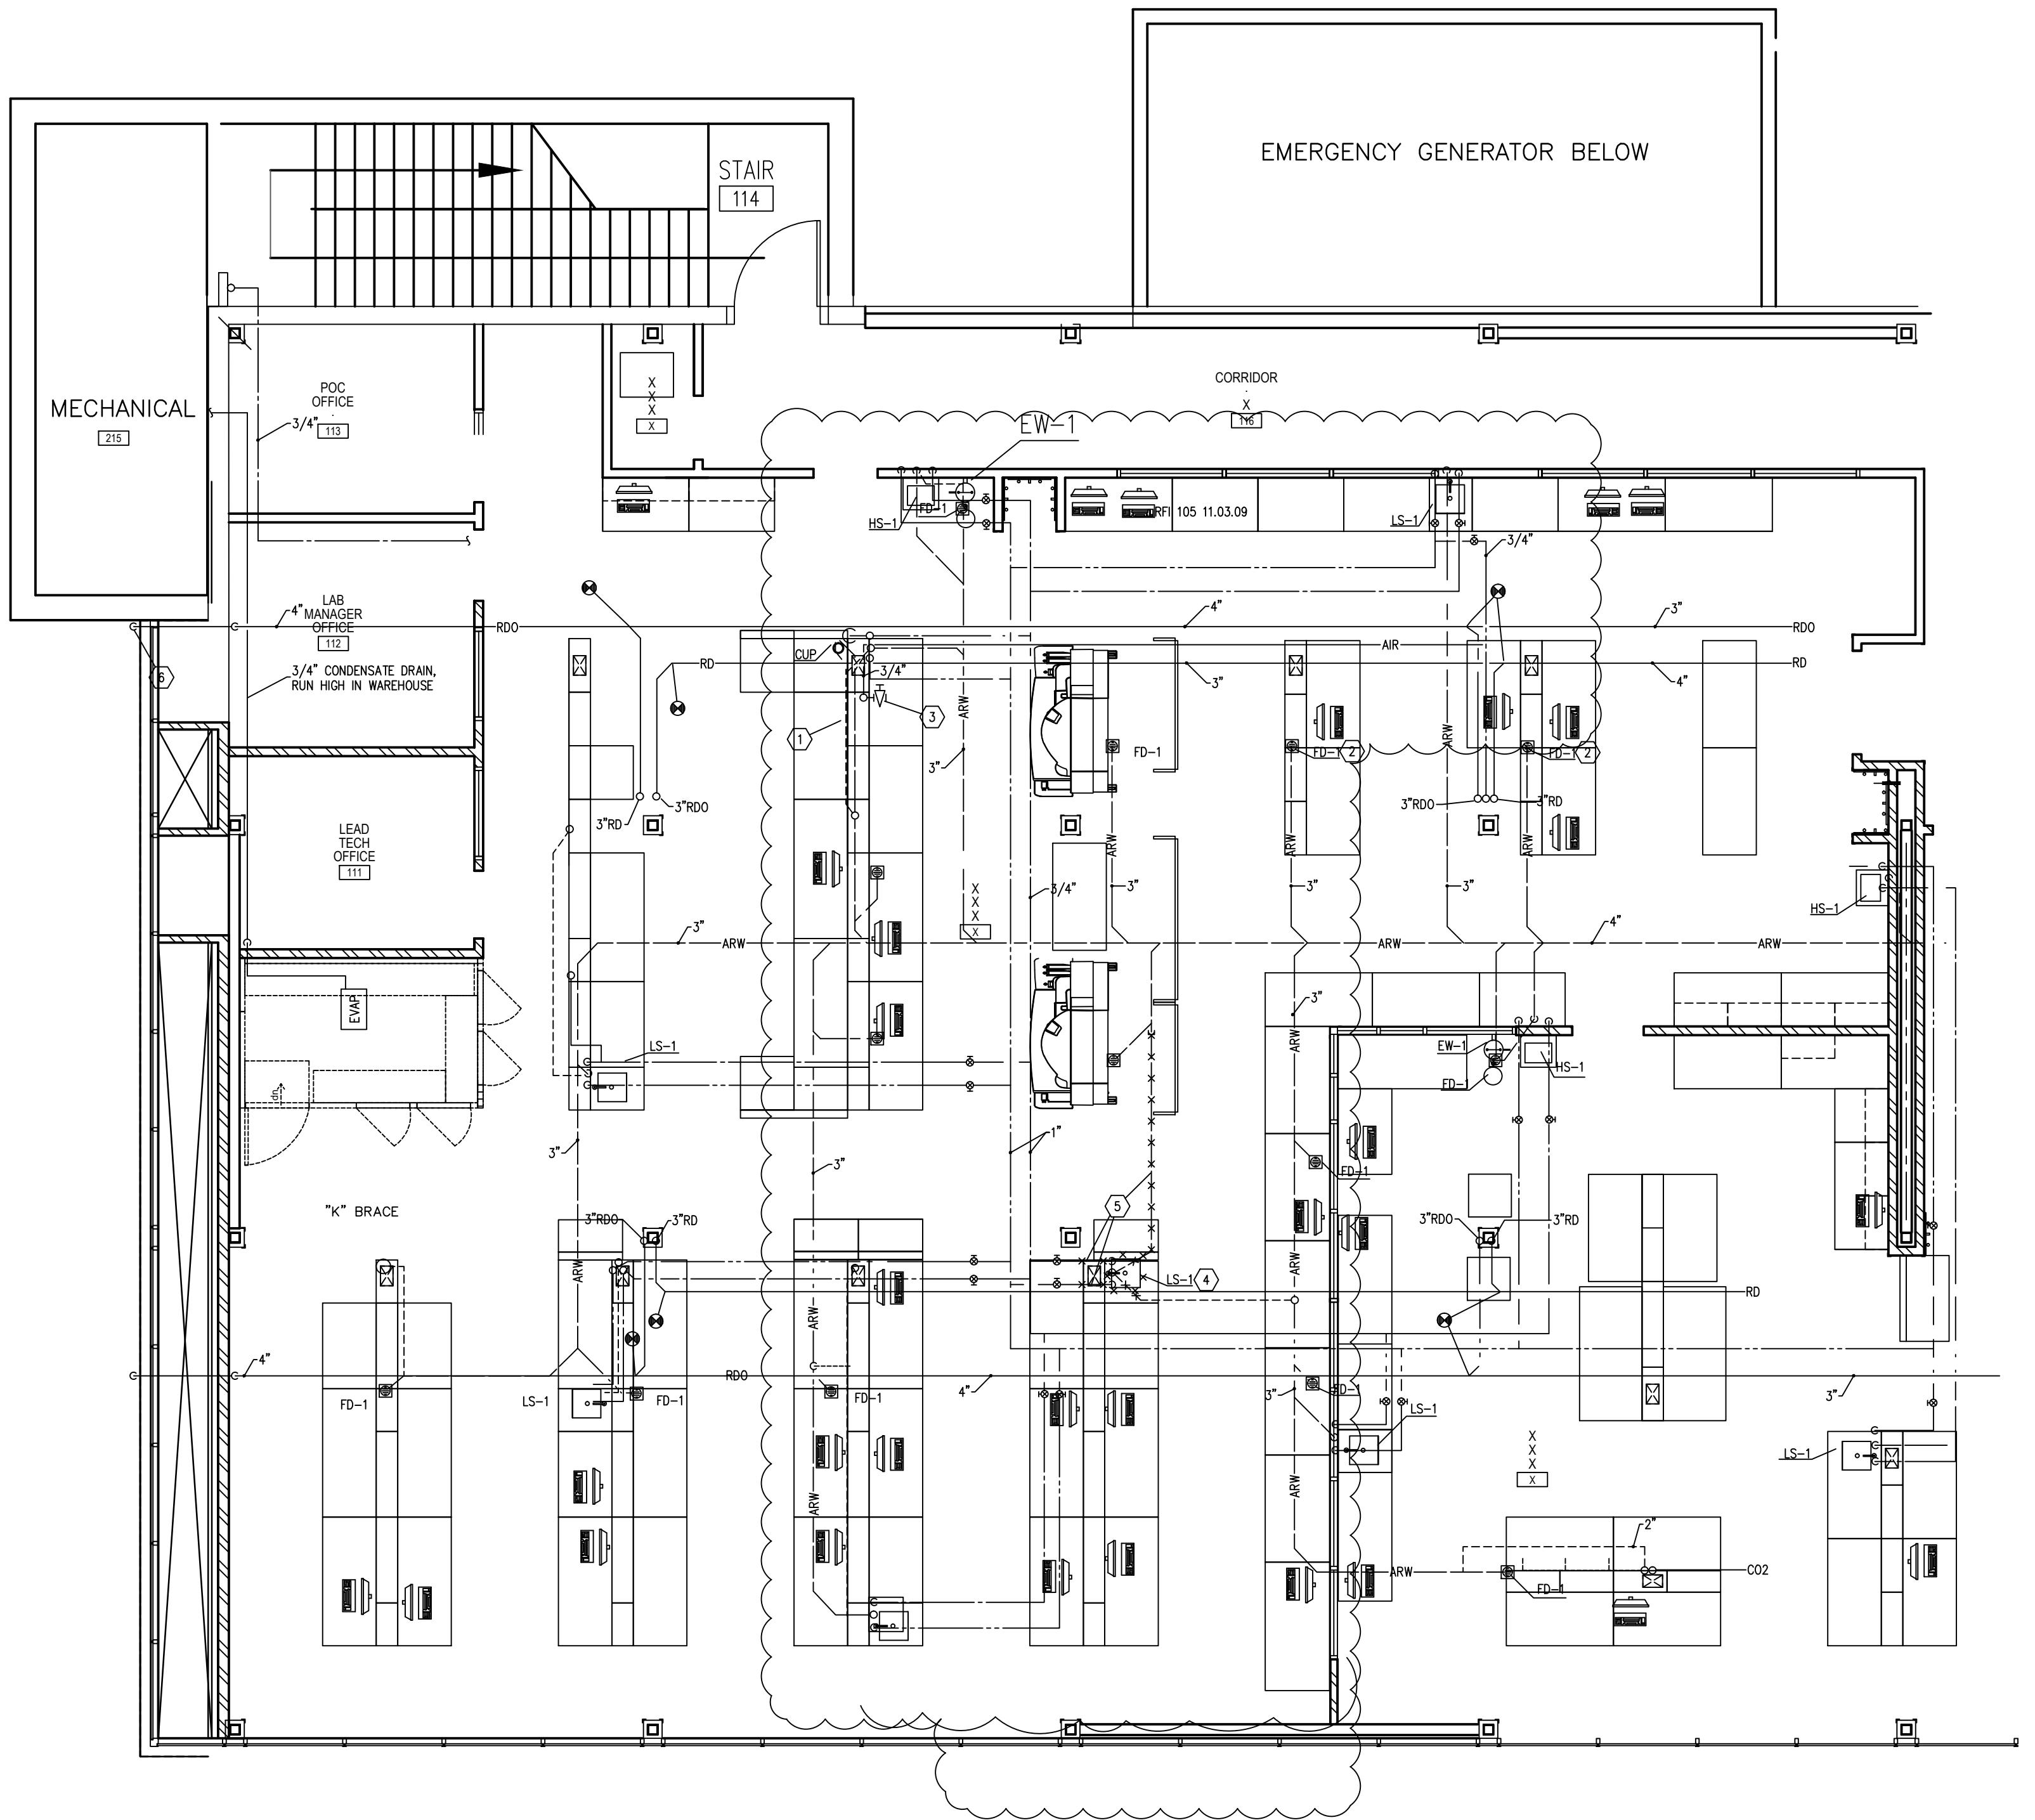

LABORATORY PLUMBING DEMOLITION PLAN
1/4"=1'-0"

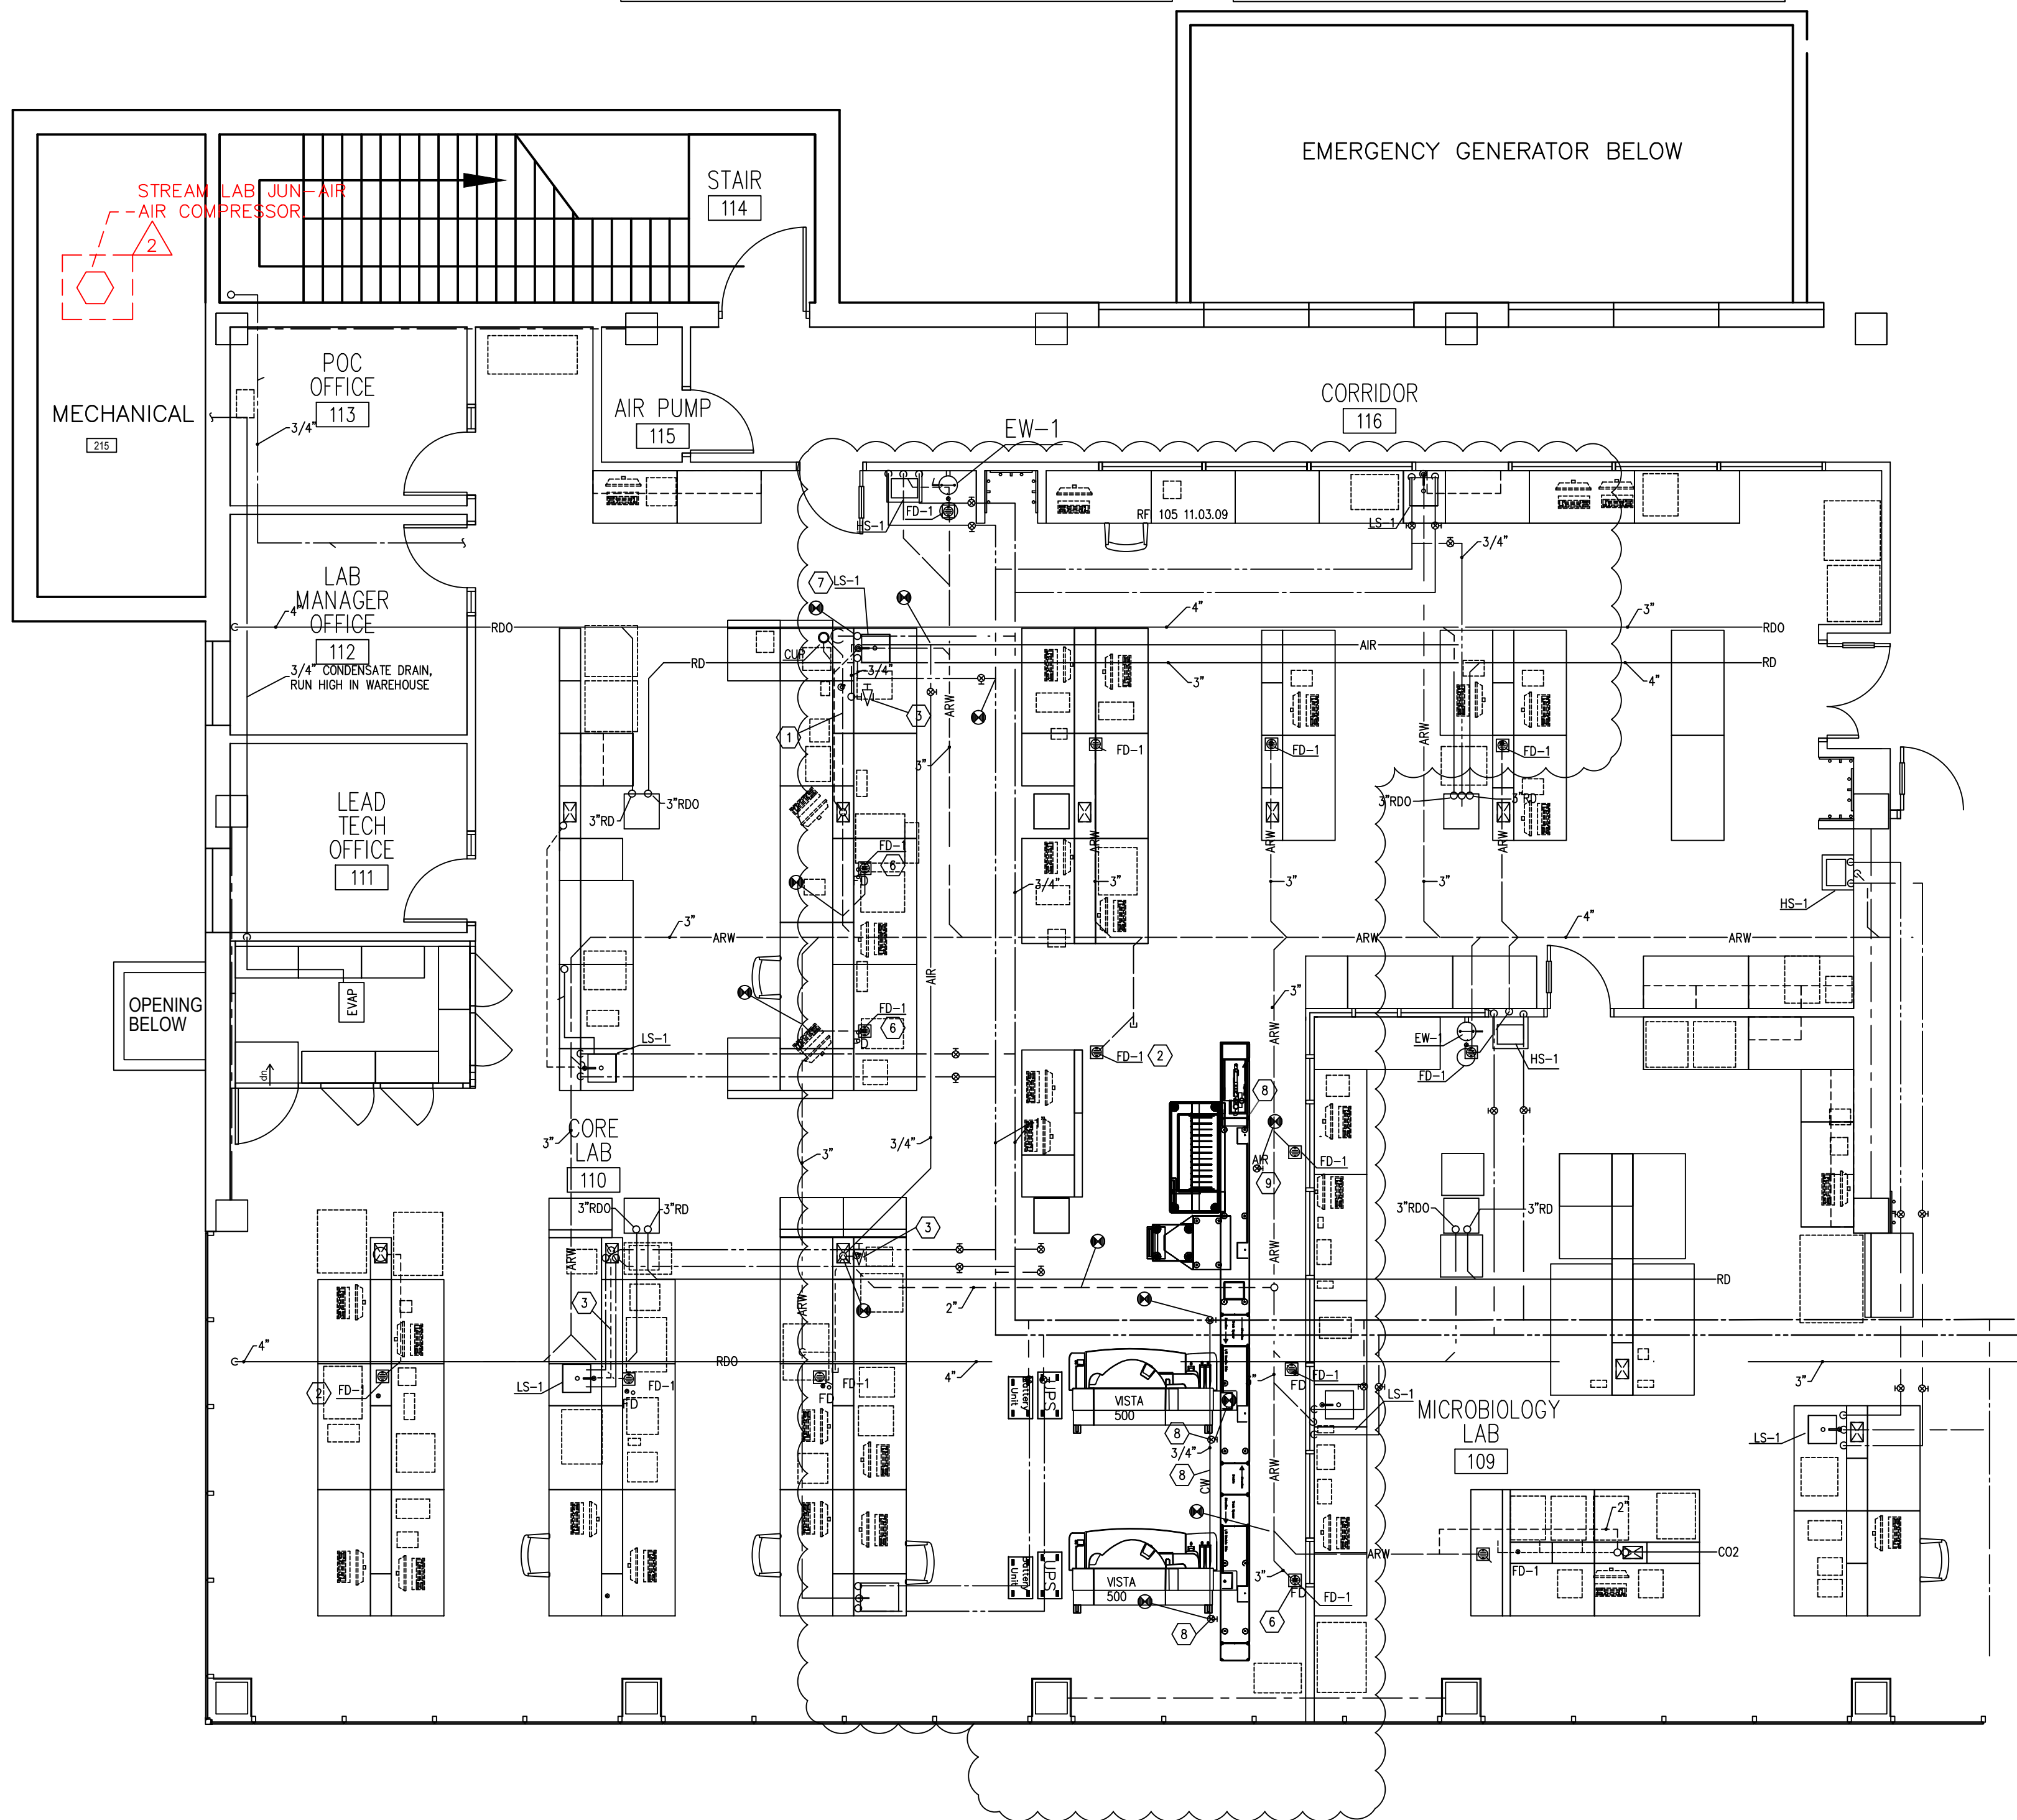

LABORATORY PLUMBING PLAN
1/4"=1'-0"

Revisions

REV-DATE-2

VA MONTANA HEALTHCARE SYSTEM
FT HARRISON, MT

Drawing Title
LABORATORY PLUMBING PLAN

Project Title
LABORATORY TRACK SYSTEM SITE PREPARATION

Date
8.19.2011

Project No.
436-12-SLP-101

Approved: Division Chief

Building Number
154

Checked

Drawn
RJS

DRAWING NO.
P 3.1

Approved: Service Director

Location
FORT HARRISON, MONTANA

Dwg 8 of 8

DEPARTMENT OF
VETERANS AFFAIRS