


GROUND FLOOR & FOUNDATION PLAN
SCALE: 3/8"=1'-0"


ESTIMATED NUMBER OF PILES 165
ESTIMATED LENGTH OF PILING 3320

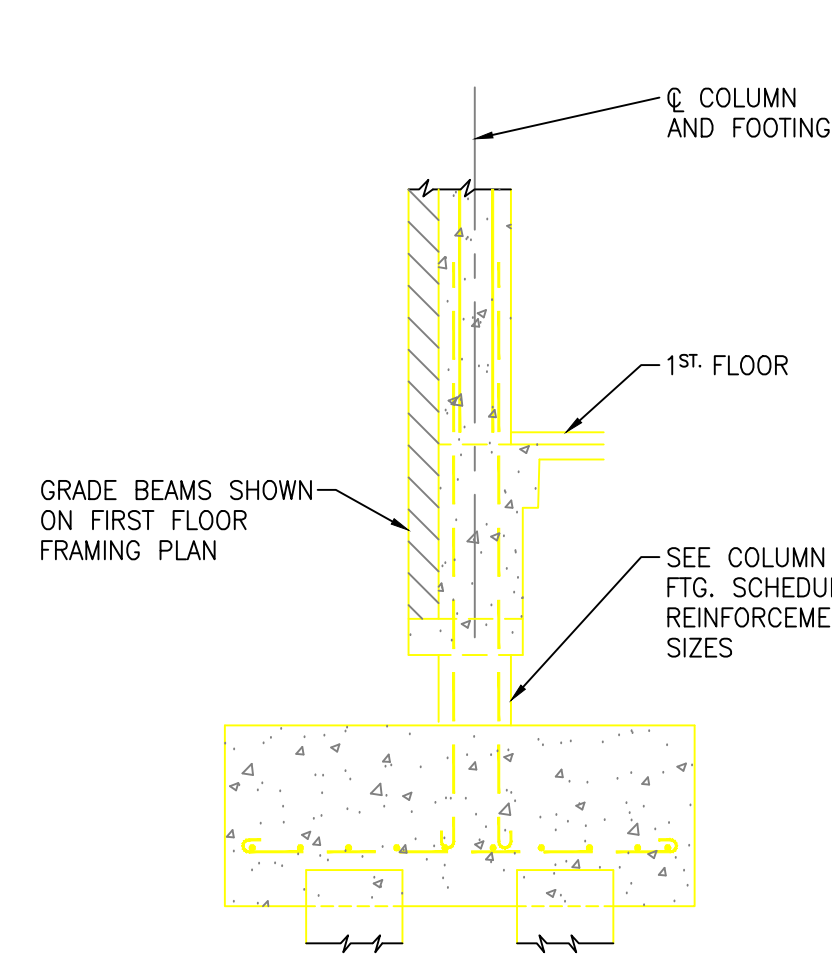

TYPICAL EXTERIOR COLUMN FOOTING DETAIL
GRADE BEAM FRAMES INTO COLUMN


SCALE: 3/8"=1'-0"

TYPICAL EXTERIOR COLUMN FOOTING DETAIL
FOR COLUMNS 9, 10, 11, 12, 14, 15, 16,
17, 18, 19, 20, 21, 22, 23

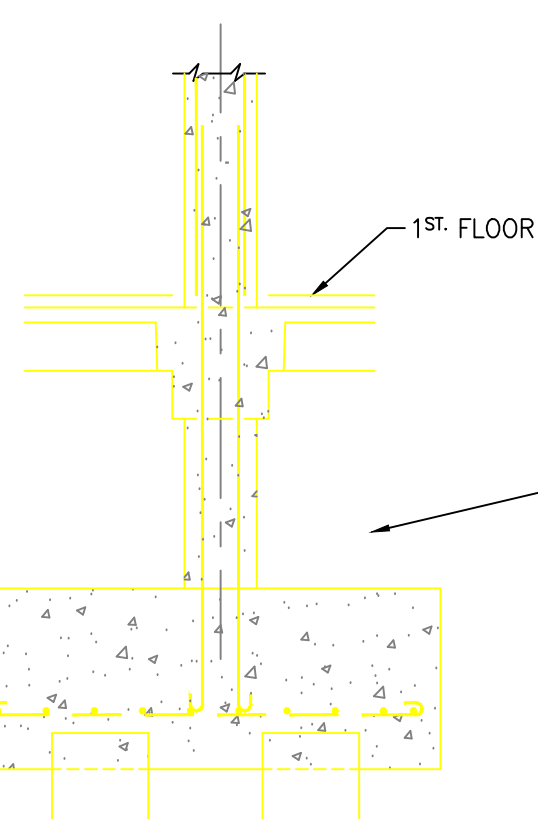

TYPICAL INTERIOR COLUMN FOOTING DETAILS


SCALE: 3/8"=1'-0"

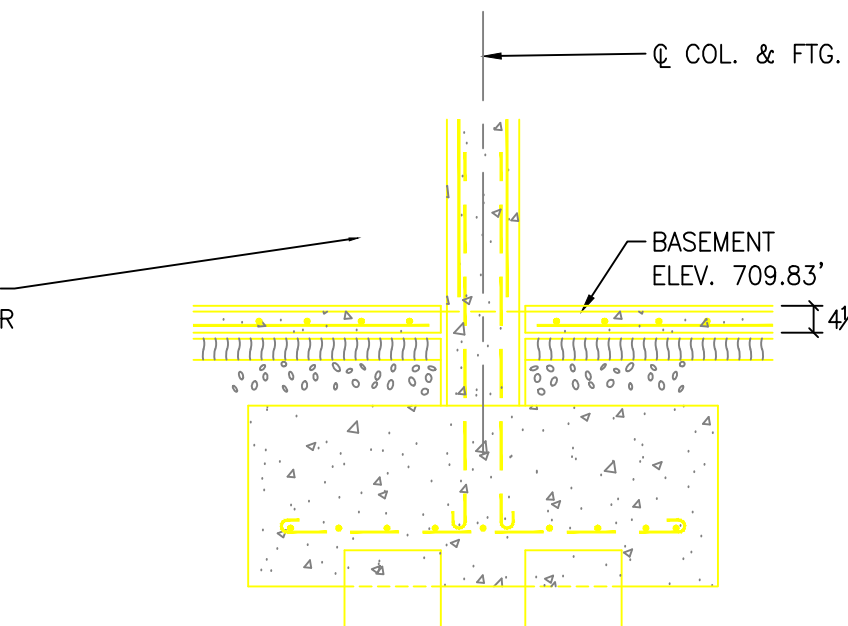


TYPICAL EXTERIOR COLUMN FOOTING DETAIL

SCALE: 3/8"=1'-0"


SECTION B-B
POST OFFICE PLATFORM DETAILS
SCALE: 3/8"=1'-0"

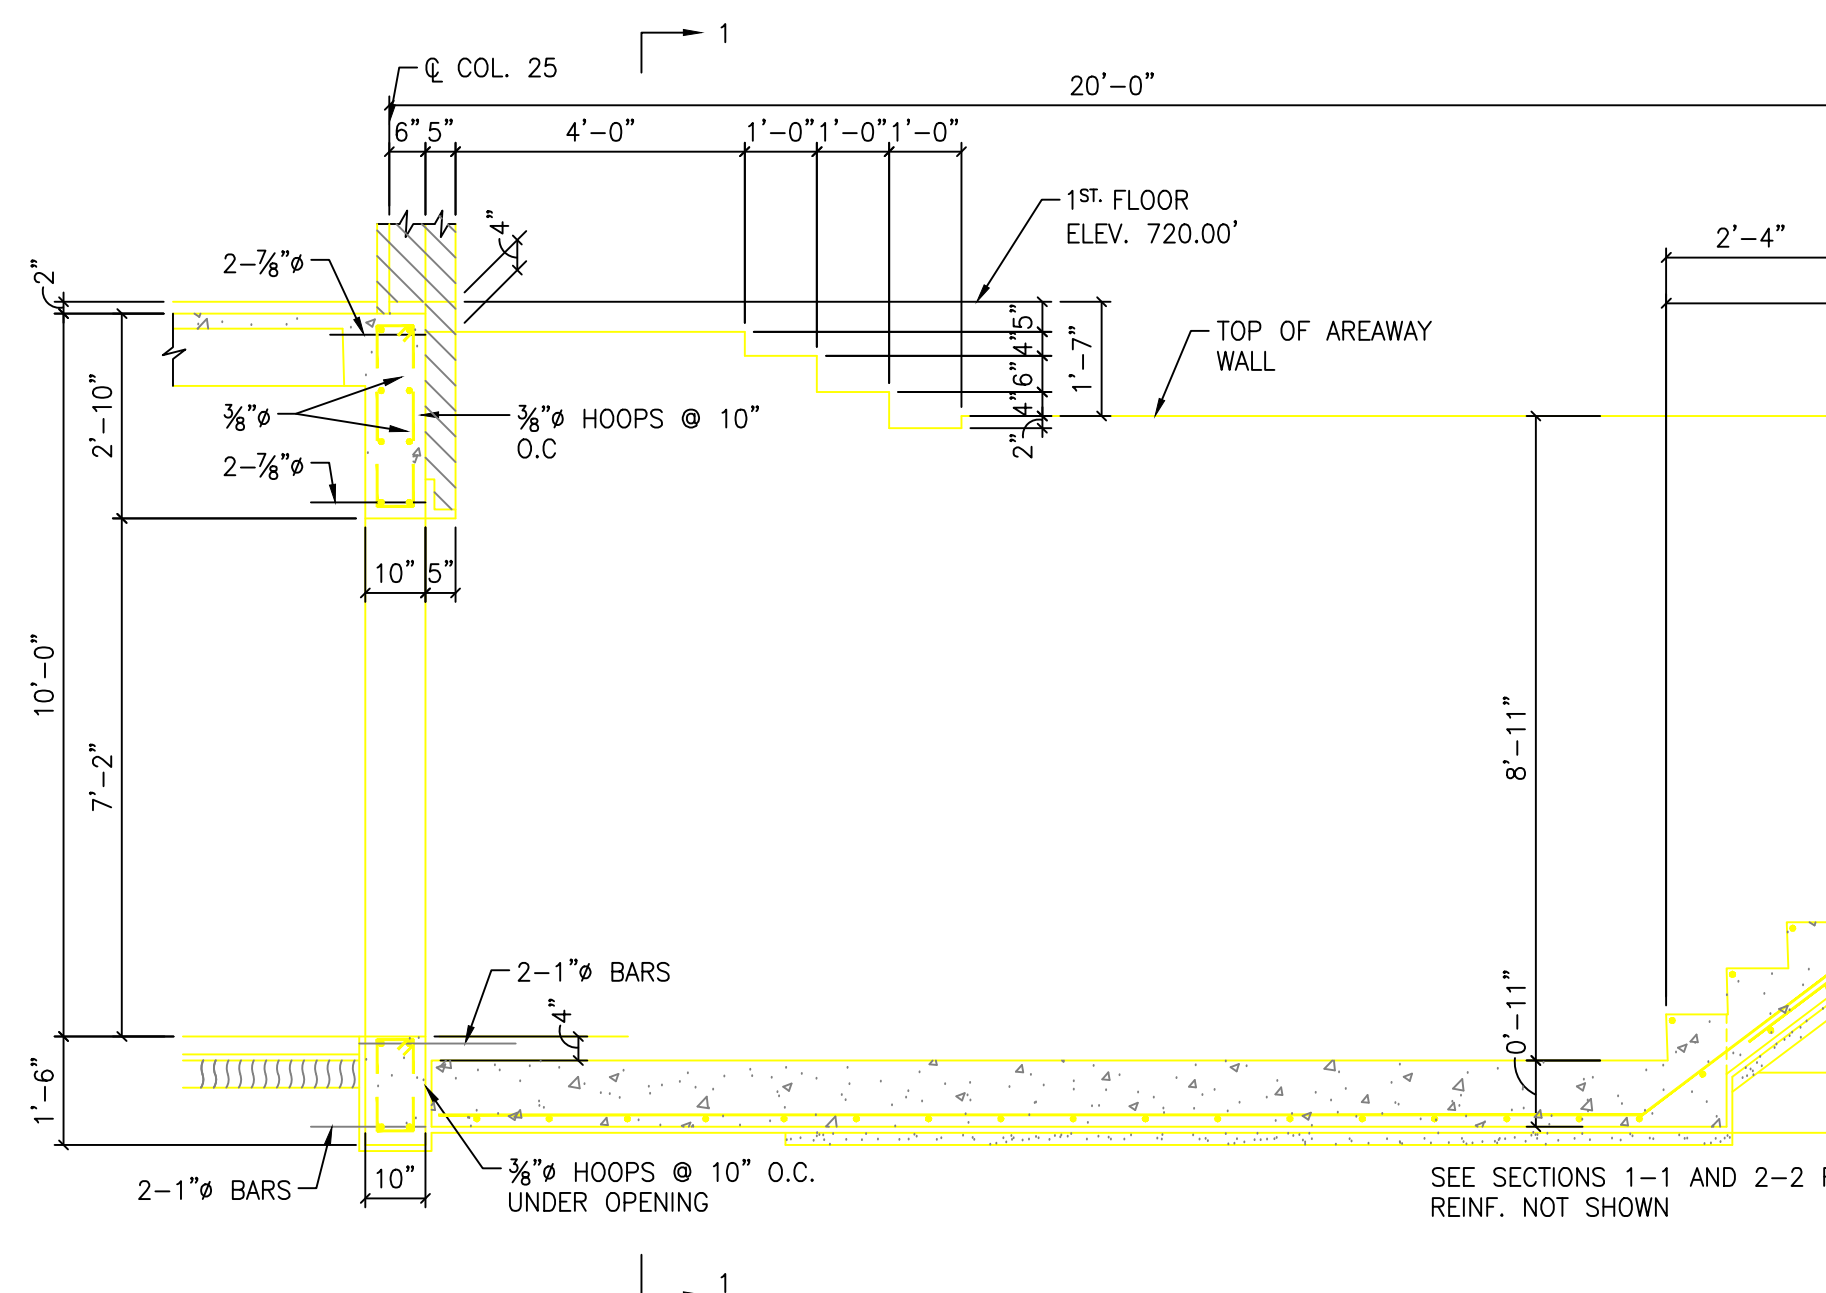


SECTION A-A
SCALE: 3/8"=1'-0"

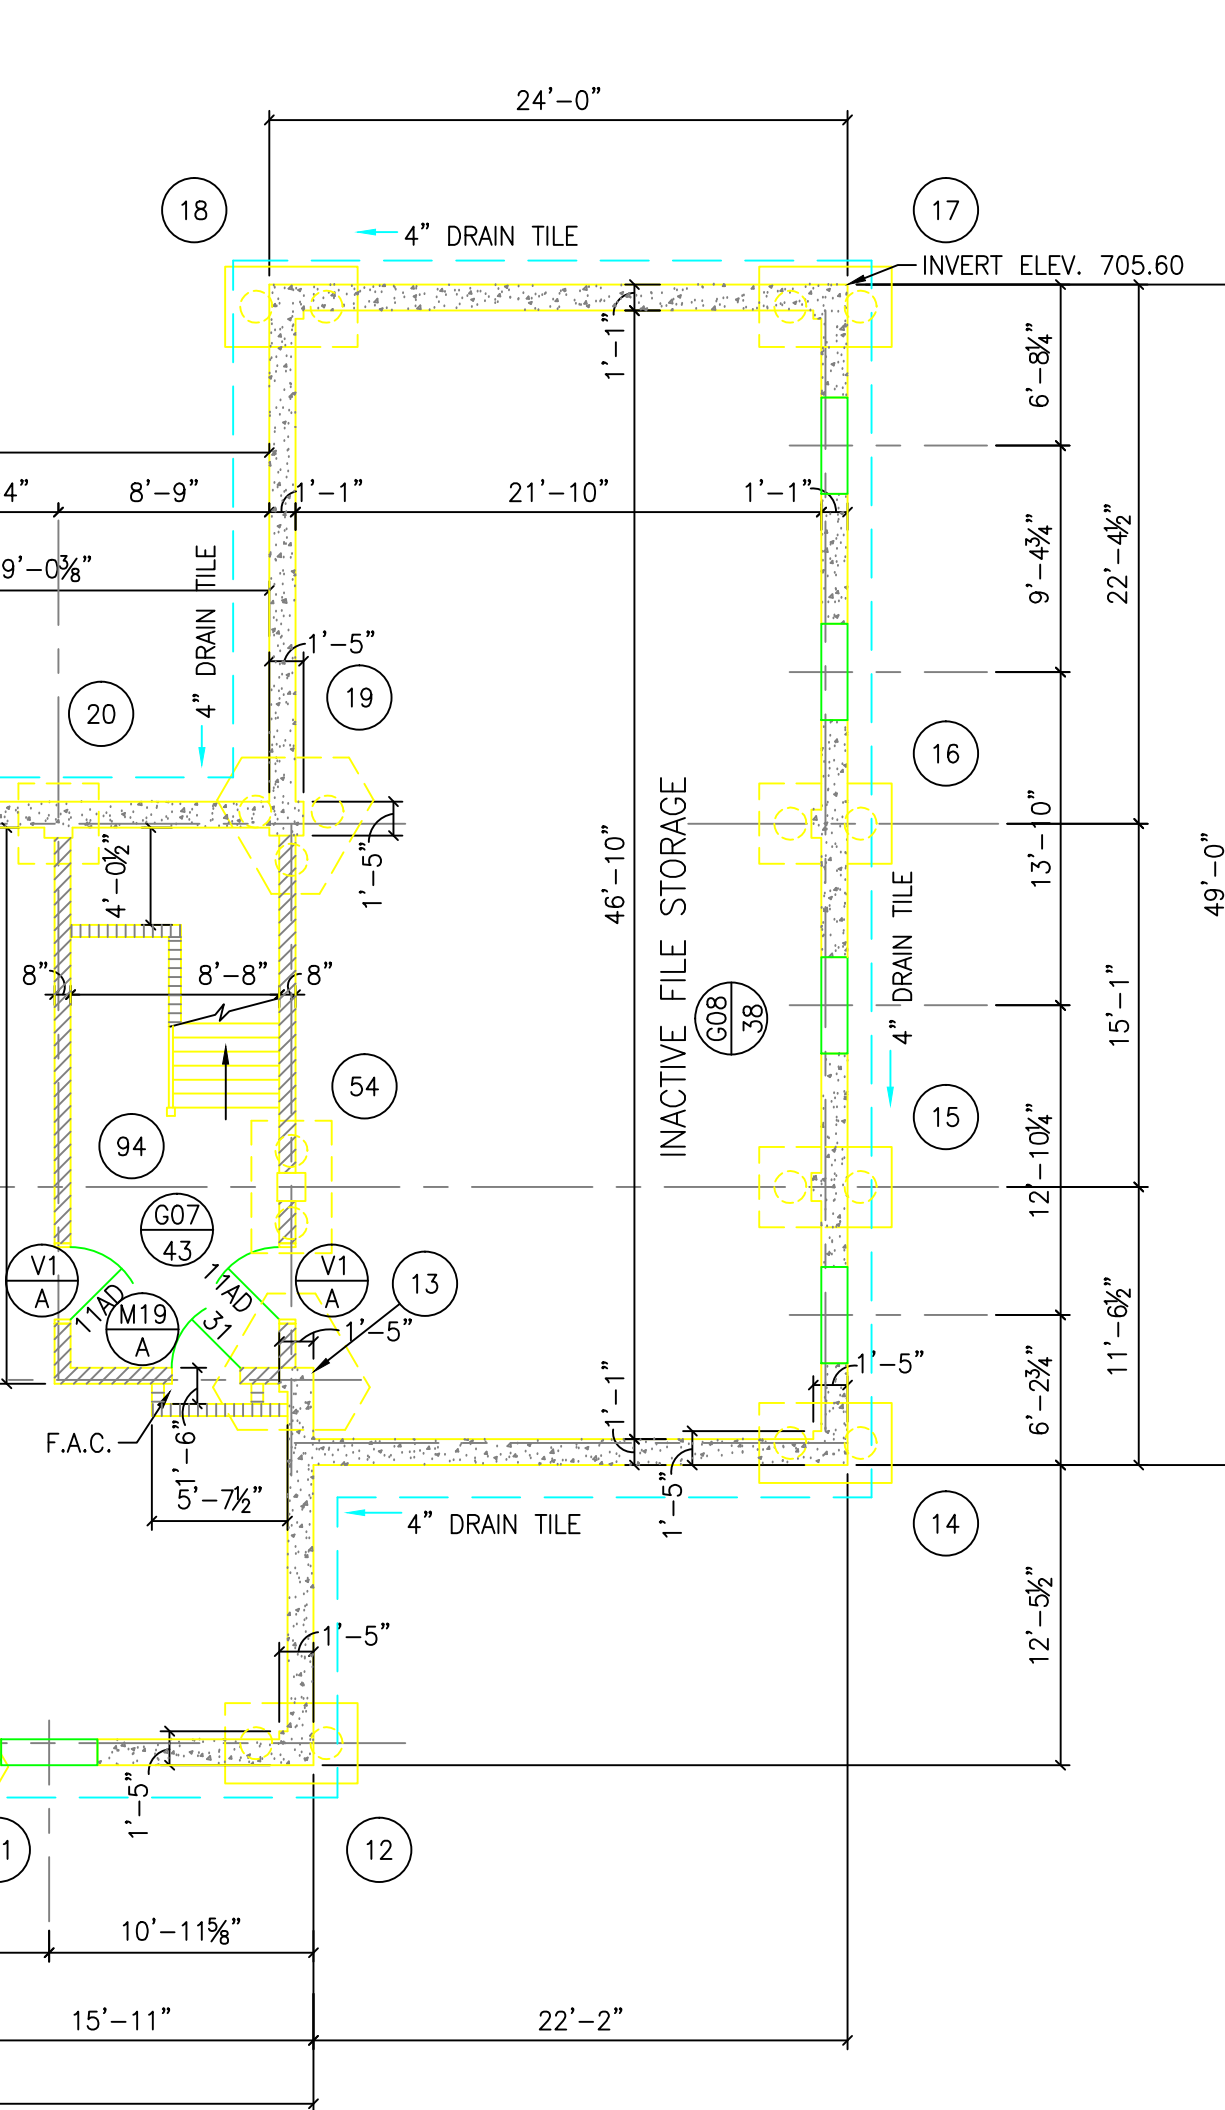


SECTION C-C
SCALE: 3/8"=1'-0"

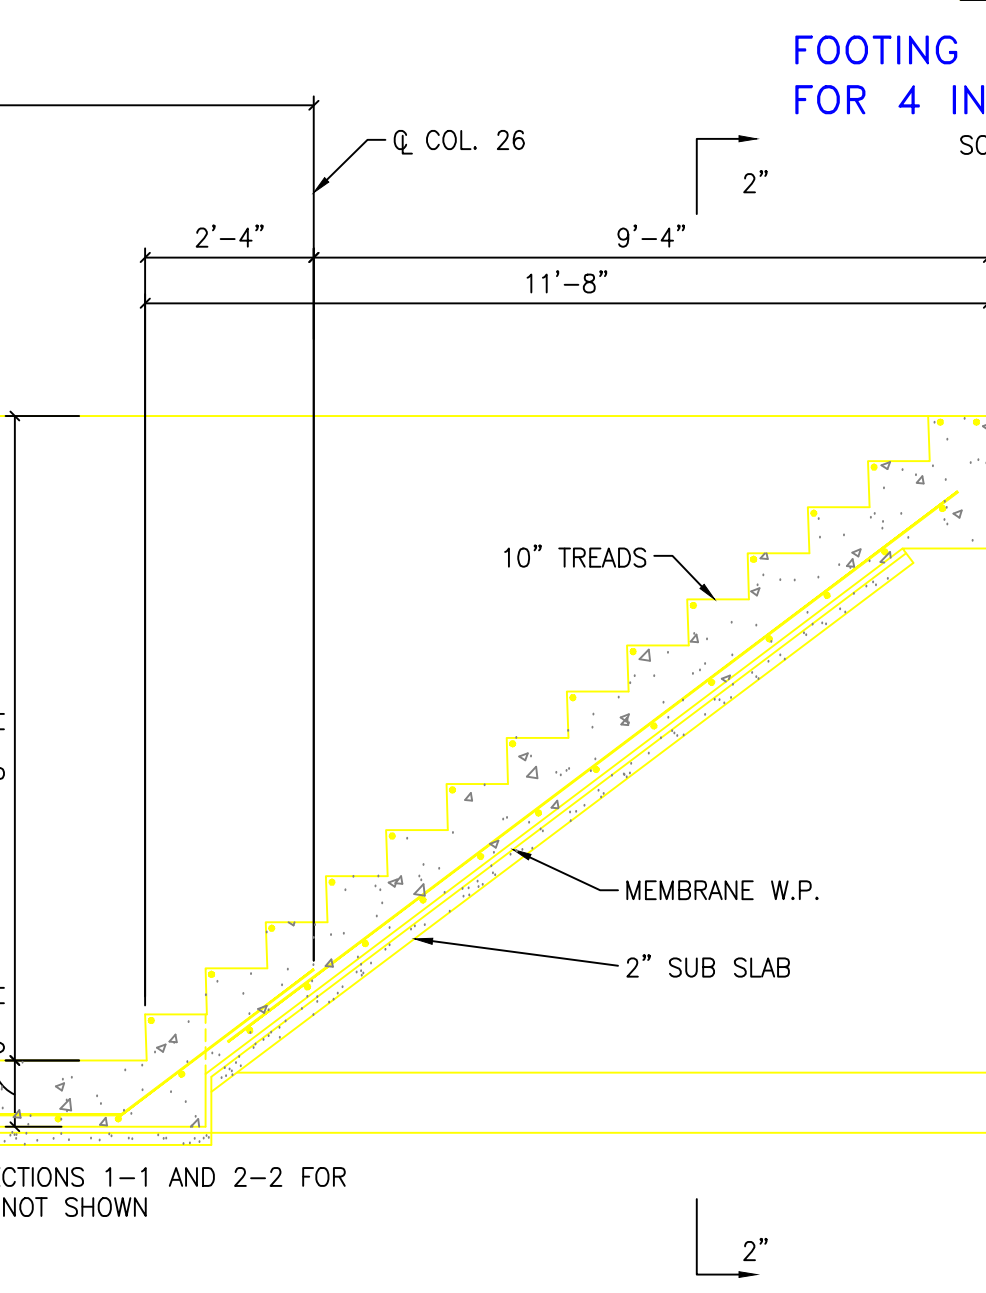


FOOTING AND PIER DETAIL
FOR 4 INCH PIPE COLUMN
SCALE: 3/8"=1'-0"

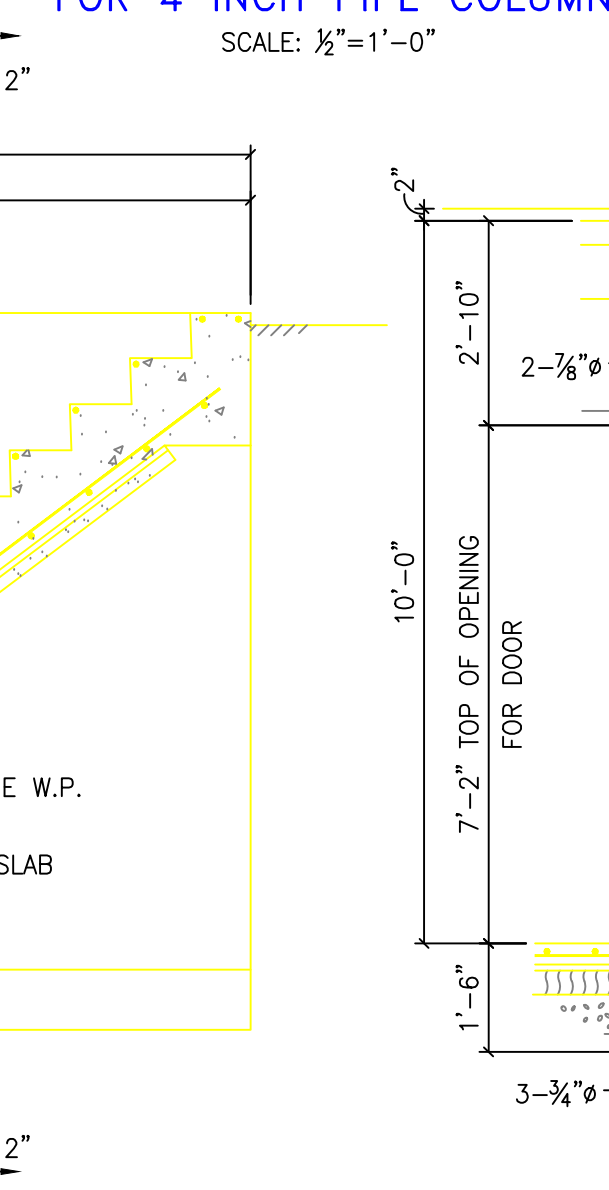


SECTION J-J
SCALE: 3/8"=1'-0"

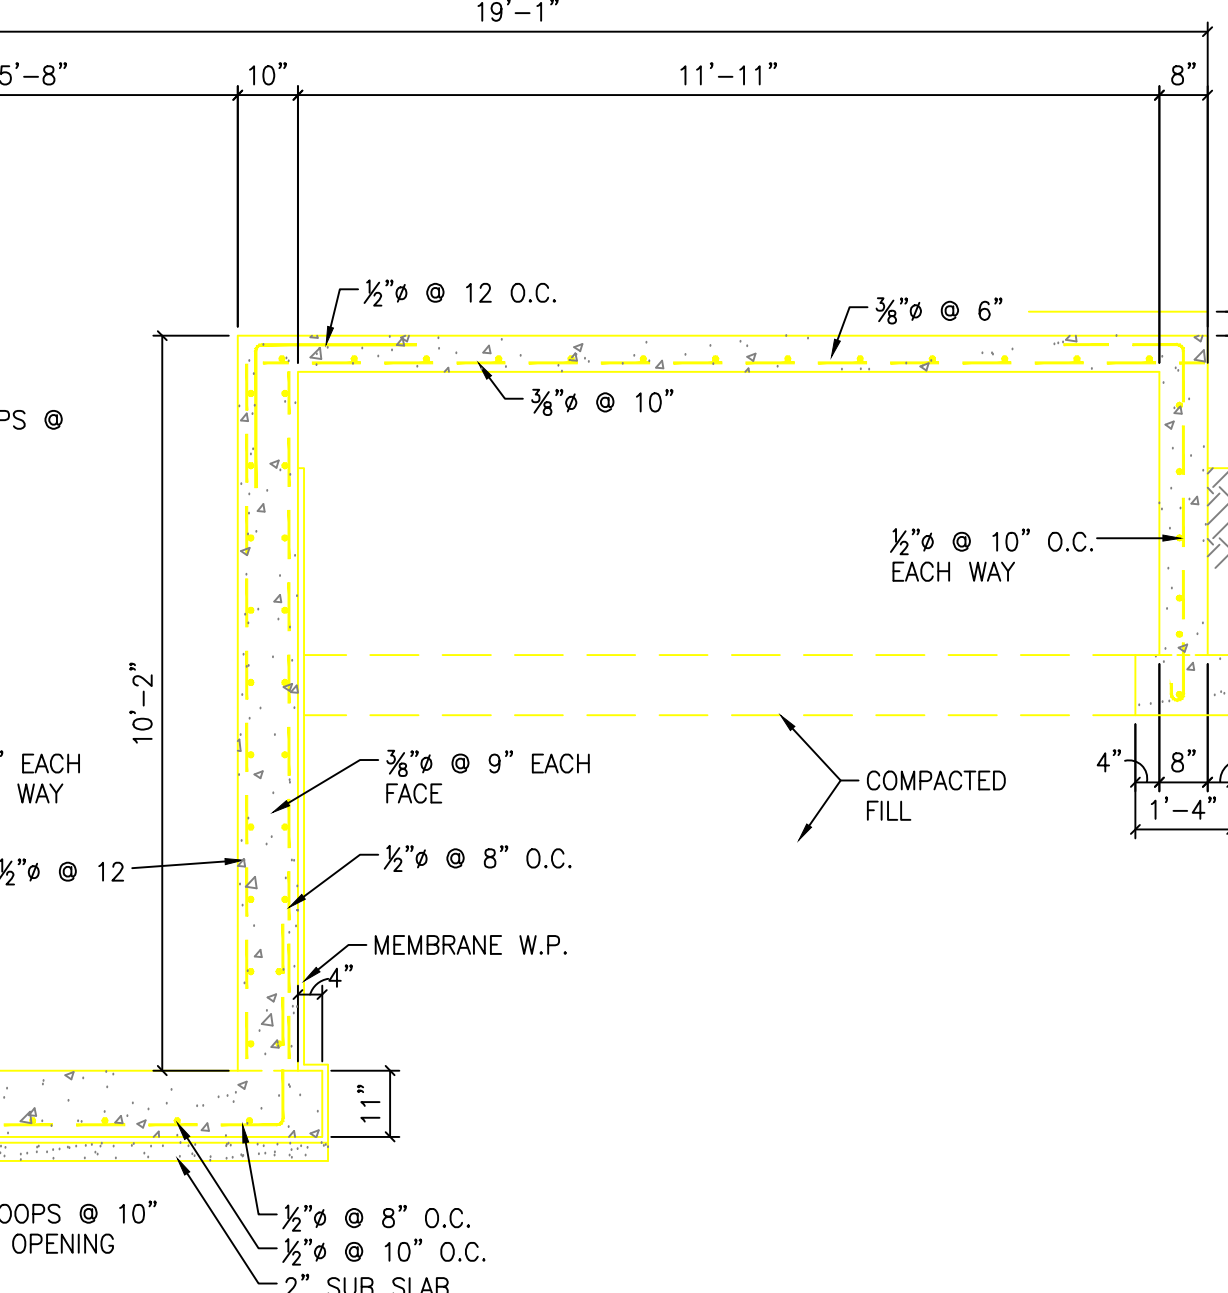

SECTION 1-1
SCALE: 3/8"=1'-0"

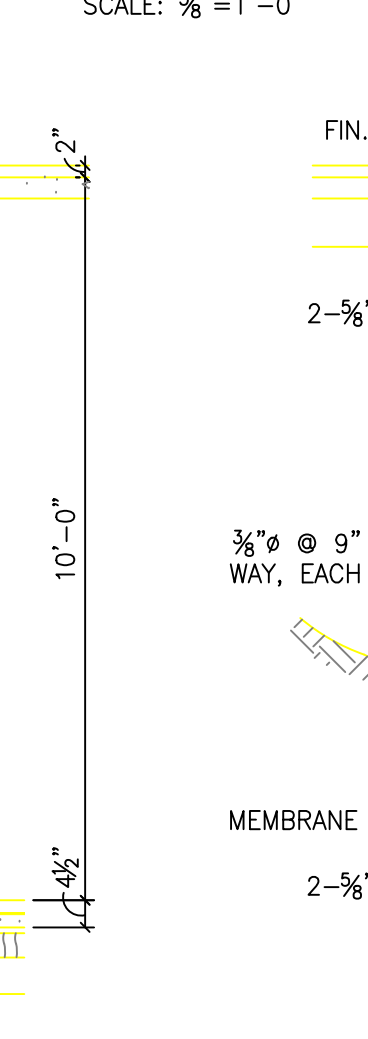

SECTION E-E

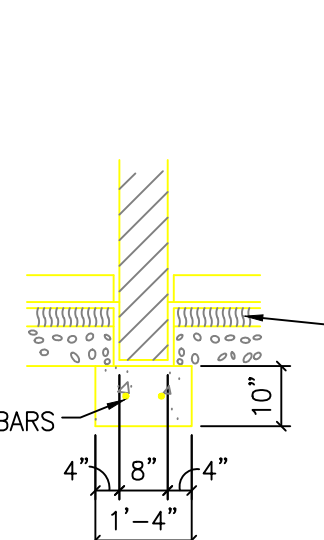

FOOTING DETAIL FOR 8" BRICK
INTERIOR WALL
SCALE: 3/8"=1'-0"



SECTION F-F
SCALE: 3/8"=1'-0"



SECTION G-G



SECTION 2-2
SCALE: 3/8"=1'-0"




SECTION H-H



NOTES

1. CONC. FOR WALLS TYPE "A" (3000 PSI) - CONC. FOR PILE CAPS & SLABS ON GRADE TYPE "B" (2200 PSI)
2. SEE SHEET #458 FOR PILE CAP DETAILS
3. REINF. FOR SLABS ON GRADE 4 X 4 #6/6 MESH

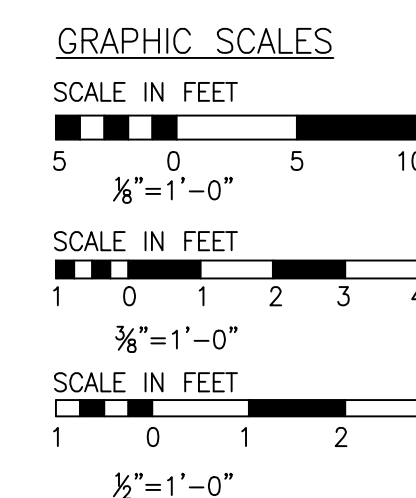

BLDG #1

REVISION	DATE	DESCRIPTION	BY
3-8-50	ADDED ESTIMATE OF NUMBER & LENGTH OF PILING		G.G.B.
1	WALTER HOOK & ASSOCIATES, INC.		
2	WM. HENLEY DETTRICK, INC.		
3	WALTON, NORTH CAROLINA		
4	WM. C. OLSEN		
5	ARCHITECTS, ENGINEERS		
6	IN ASSOCIATION WITH		
7	NEERGAARD, CRAIG & McCAGG		
8	HOSPITAL CONSULTANTS-NEW YORK, N.Y.		
9	TRACED BY: B.M. & M.E.R.		
10	CHECKED BY: B.M. & M.E.R.		
11	SUBMITTED: M.R.		
12	APPROVED:		
13	CHIEF ENGINEER		
14	LT. COL. C. E. DISTRICT ENGINEER		
15	SCALE		
16	DRAWING NUMBER		
17	V.A. PROJECT NO.2448		
18	NO. OF SHEETS		
19	76R		
20	471		