


SHEET KEYNOTES


1. NEW STANDING SEAM METAL ROOF ON SINGLE PLY EPDM
2. NEW BRICK VENEER
3. NEW PRE-FINISHED ALUMINUM CANOPY ROOF.
4. ACOUSTICAL LAY-IN CEILING
5. 4" CONCRETE SLAB - SEE STRUCTURAL DRAWINGS
6. NEW PRE-FINISHED ALUMINUM CANOPY FRAMING
7. 4" CONCRETE RAMP - SEE STRUCTURAL DRAWINGS.
8. NEW 1 1/2" STAINLESS STEEL HANDRAIL.
9. NEW GUTTER.
10. EXISTING CONCRETE BEAM.
11. NEW STEEL BEAM - SEE STRUCTURAL DRAWINGS.
12. NEW STEEL JOIST - SEE STRUCTURAL DRAWINGS.
13. GYPSUM BOARD BULKHEAD.
14. EXISTING BRICK.
15. LIGHT, SEE ELECTRICAL DRAWINGS.
16. PIPING TO COORDINATE WITH MECHANICAL DUCT, SEE PLUMBING DRAWINGS.
17. J-HOOK FOR ELECTRICAL WIRING, SEE ELECTRICAL DRAWINGS.
18. MECHANICAL DUCTWORK, COORDINATE WITH OTHER TRADES, SEE MECHANICAL DRAWINGS.
19. FIRE SPRINKLER LINE TO COORDINATE WITH OTHER MECHANICAL DUCTWORK, SEE FIRE PROTECTION DRAWINGS.
20. RUN ELECTRICAL CONDUIT AS CLOSE TO STRUCTURE AS POSSIBLE - COORDINATE WITH MECHANICAL DUCTWORK.
21. HOLD GYPSUM BOARD SOFFIT TIGHT TO BOTTOM OF EXHAUST DUCT.
22. MEDICAL EQUIPMENT ROOM, LIGHT, AND MONITOR, SEE EQUIPMENT PLAN AND REFER TO STRUCTURAL FOR ATTACHMENT TO EXISTING STRUCTURE ABOVE. REFER TO CEILING DETAILS.
23. SUSPENDED GYPSUM BOARD ON FURRING STRIPS AND STEEL CHANNELS, REFER TO CEILING DETAILS.
24. CASEWORK, REFER TO CASEWORK PLANS, ELEVATIONS AND SECTIONS.
25. GYPSUM BOARD AND METAL STUD PARTITION, REFER TO FLOOR PLAN FOR PARTITION TYPE.
26. GYPSUM BOARD SOFFIT, REFER TO ENLARGED REFLECTED CEILING PLAN FOR ELEVATION.

COORDINATION DRAWINGS


THE MECHANICAL CONTRACTOR SHALL TAKE THE LEAD IN PREPARATION OF COORDINATION DRAWINGS. SUCH DRAWINGS SHALL BE ARRANGED AND DESIGNED THROUGH AND FROM COORDINATION WITH ALL OTHER MAJOR AND MINOR SUBCONTRACTORS AND THE GENERAL CONTRACTOR. PROVIDE PLAN VIEWS, SECTIONS AND ELEVATIONS AS REQUIRED TO FULLY COORDINATE ALL NEW WORK WITH ITSELF AND EXISTING CONDITIONS. DRAW TO SCALE (4" NOT LESS THAN 3/8" = 1'-0"). DRAWINGS SHALL SHOW, BUT NOT BE LIMITED TO: ALL WALL RATINGS; ALL DUCTWORK; ALL AIR DISTRIBUTION; MECHANICAL EQUIPMENT; MECHANICAL PIPING; FIRE PROTECTION PIPING; ALL PLUMBING PIPING; CABLE TRAYS (WITH ELEVATIONS NOTED); LIGHTING FIXTURES (WHEN CEILING MOUNTED); CEILING GRID AND CEILING HEIGHT; MAJOR BEAMS AND JOISTS (WITH ELEVATIONS MARKED); FIRE ALARM DEVICES AND SPEAKERS (WHERE CEILING MOUNTED); ELECTRICAL CONDUITS LARGER THAN 2-INCH DIAMETER; ELECTRICAL BUSWAY AND REQUIRED CLEARANCES; EQUIPMENT PROVIDED BY OTHERS THAT PROTRUDE INTO CEILING CAVITIES OR IMPEDE THE LOCATION OR ACCESS TO ABOVE CEILING PIPING, DUCTWORK OF OTHER EQUIPMENT. SECTIONS SHALL BE CUT THROUGH AREAS SHOWING MATERIALS AND SYSTEMS OF ALL CONTRACTS. IF THERE ARE ANY OUTSTANDING ISSUES THAT CANNOT BE RESOLVED, CONSULT WITH THE ARCHITECT AND/OR ENGINEER (THROUGH THE VA COTR) FOR GUIDANCE AND MAKE CORRECTIONS IN ACCORDANCE WITH DIRECTIONS GIVEN. IT IS IMPORTANT TO NOTE THAT FABRICATION CANNOT BEGIN UNTIL COORDINATION DRAWINGS HAVE BEEN APPROVED. ANY MATERIAL, EQUIPMENT, SYSTEMS, ETC., PROCUREMENT OR INSTALLATION COMMENCED PRIOR TO APPROVAL IS TAKEN AT THE CONTRACTORS OWN RISK AND MAY HAVE TO BE MODIFIED, MOVED AND/OR RECONFIGURED AT THE CONTRACTORS COST.

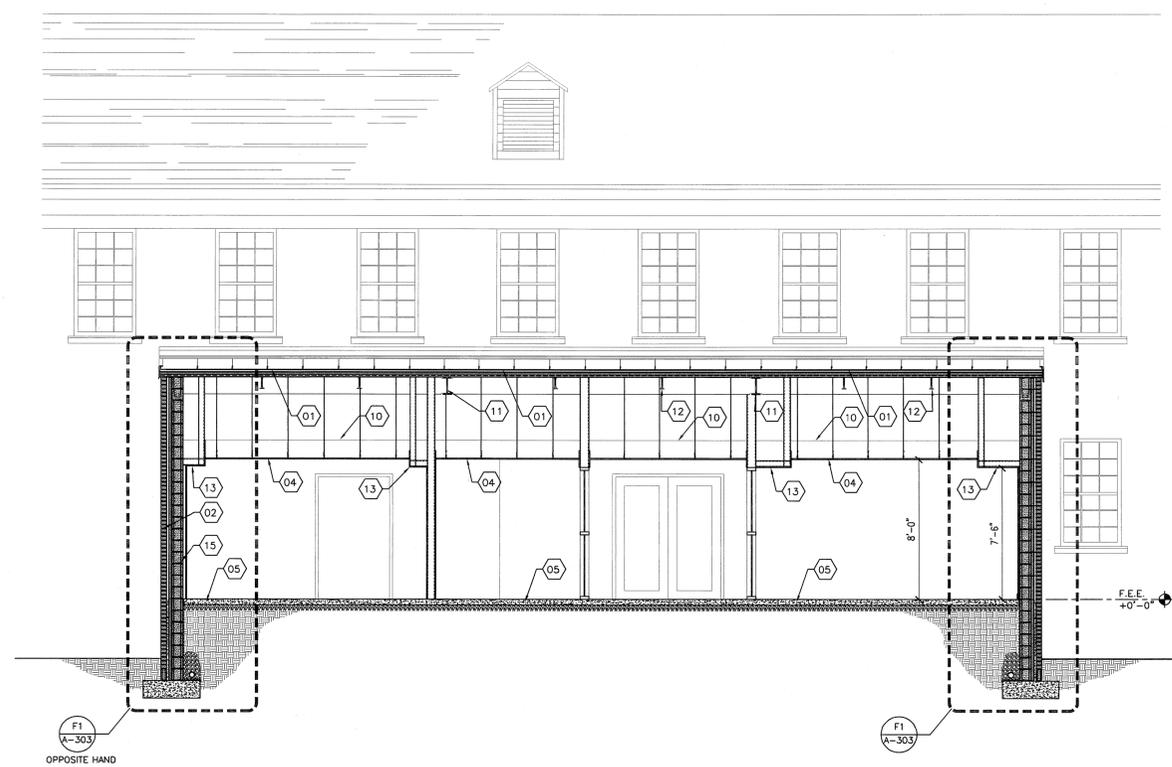


D1 BUILDING SECTION AT NEW ENTRANCE
1/4" = 1'-0"

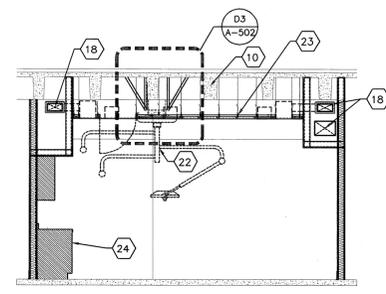


C1 BUILDING SECTION AT PROCEDURE ROOM
1/4" = 1'-0"

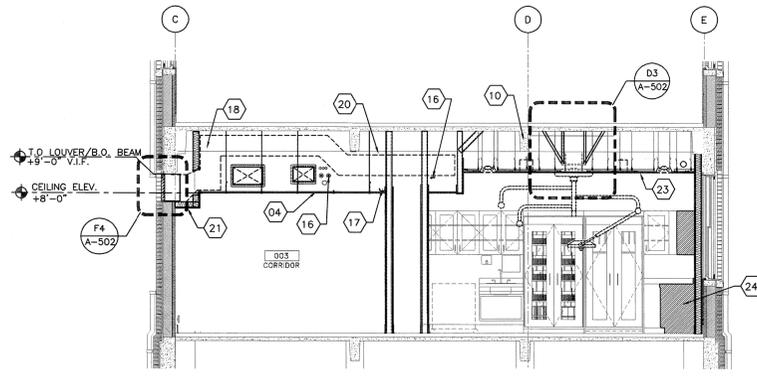

D1 BUILDING SECTION AT CORRIDOR
1/4" = 1'-0"

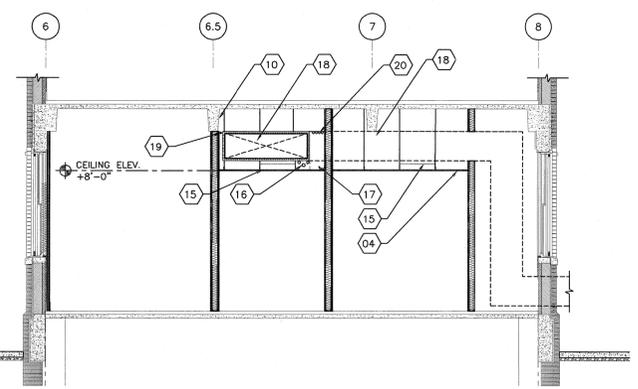

F1 BUILDING SECTION AT CORRIDOR
1/4" = 1'-0"

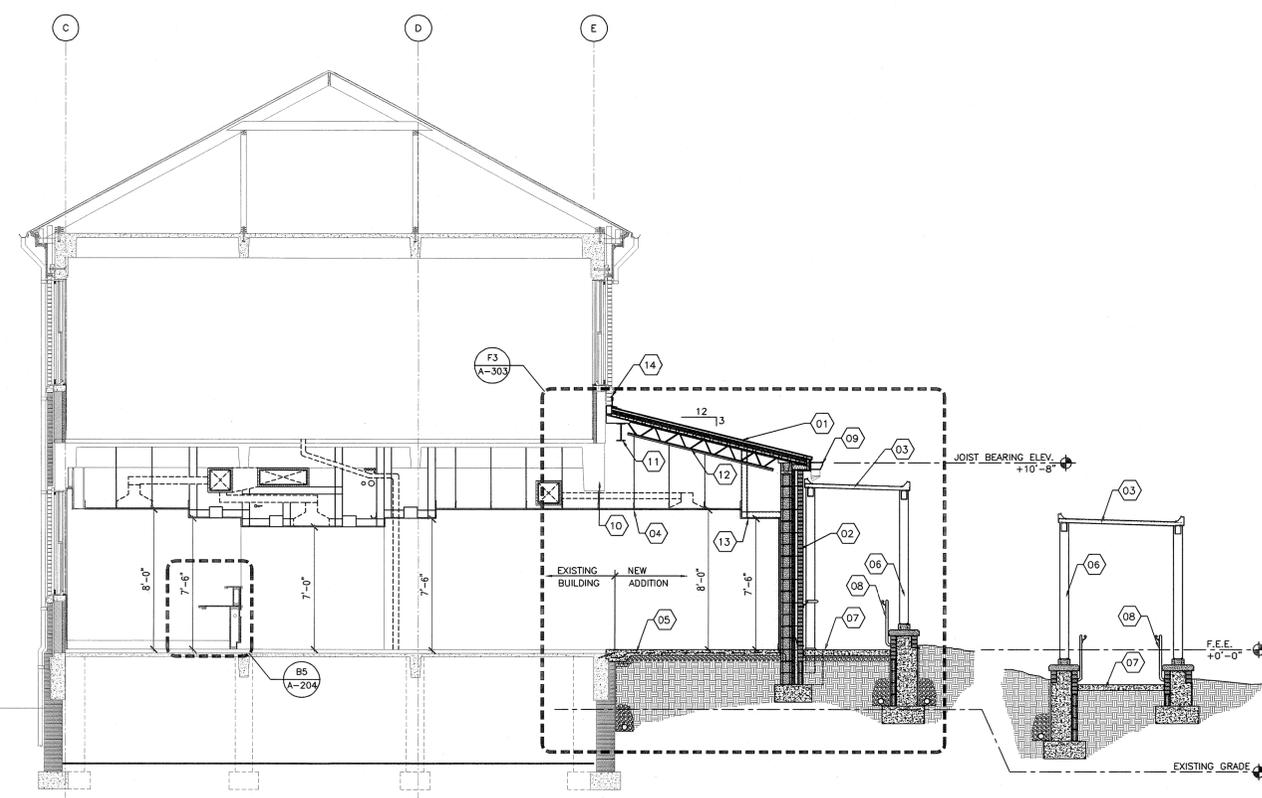

F5 BUILDING SECTION AT NEW ENTRANCE
1/4" = 1'-0"

100% SUBMITTAL

REVISION NO.	REVISION DESCRIPTION	By	Date

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Recommended Approvals:	
1. MEDICAL DIRECTOR	6. OPERATIONS SERVICE LINE MANAGER
2. ASSOCIATE DIRECTOR	7. INFECTION CONTROL SAFETY MANAGER
3. CHIEF OF STAFF	8. SAFETY MANAGER
4. ASSOC. DIRECTOR	9. GENERAL ENGINEER
5. SERVICE LINE MGRS.	10. COTR

Drawing Title BUILDING SECTIONS
FULLY SPRINKLERED
Checked

Project Title RENOVATE 13A FOR ENDOSCOPY SUITE	Drawn M/J	Building Number M/J	AutoCAD File Name
Date June 10, 2011	Project Number 557-10-108	Const. Contract No.	DRAWING No. A-301

Date
June 10, 2011
 Project Number
557-10-108
 DRAWING No.
A-301

