

SHEET KEYNOTES

- NEW 4" WASTE STACK DOWN IN WALL.
- EXISTING 3" STACK FROM 2ND FLOOR.
- EXISTING 4" STACK FROM 2ND FLOOR.
- REWORK EXISTING STORM SEWER MANHOLE AS REQUIRED TO RAISE MANHOLE COVER TO BE FLUSH WITH NEW EQUIPMENT AREA PAD.
- CONNECT NEW 4" SANITARY SEWER TO EXISTING SANITARY SEWER MANHOLE. VERIFY EXISTING INVERT ELEVATION AT MANHOLE PRIOR TO INSTALLING PIPE.
- CONNECT NEW 6" STORM LINE TO EXISTING STORM MANHOLE. VERIFY INVERT ELEVATION AT MANHOLE PRIOR TO STARTING WORK.
- CONNECT NEW 6" STORM LINE TO EXISTING STORM SEWER LINE. VERIFY EXACT LOCATION, ELEVATION, AND SIZE PRIOR TO STARTING WORK.
- EXISTING SANITARY SEWER MAIN IS LOCATED IN THE CRAWLSPACE. VERIFY EXACT SIZE, LOCATION, AND ELEVATION IN FIELD.
- COORDINATE LOCATION OF DRAIN BOXES WITH SCOPE WASH EQUIPMENT PROVIDED.
- CONNECT NEW 2" WASTE TO EXISTING 4" VERTICAL WASTE STACK AND CONNECT TO EXISTING 2" WASTE SERVING LAVATORY. CONNECT NEW 2" WASTE TO STACK TO SERVE EXISTING 2ND FLOOR BATHTUB. SEE WASTE RISER DIAGRAM SHEET P105.
- NEW 4" VENT STACK UP IN NEW CHASE ON 2ND FLOOR. COORDINATE VENT LOCATION WITH MECHANICAL DUCTWORK AND CHASE ON 2ND FLOOR.
- CONNECT NEW 3" WASTE TO EXISTING 4" STACK SERVING 2ND FLOOR TOILET AREA. COORDINATE WITH NEW MECHANICAL DUCTWORK IN NEW CHASE.
- 4" WASTE DN INTO CRAWL SPACE. CONNECT TO EXISTING 4" WASTE. VERIFY EXACT SIZE AND LOCATION IN FIELD.
- COORDINATE EXACT LOCATION OF FLOOR DRAIN WITH WATER SOFTENER EQUIPMENT PROVIDED.
- NO PIPING SHALL BE ROUTED IN OR THRU ELECTRICAL ROOMS OR I.T. CLOSETS.
- NEW WASTE PIPE TO BE RUN IN STRUCTURAL PAN SPACE. COORDINATE WITH MECHANICAL DUCTWORK.

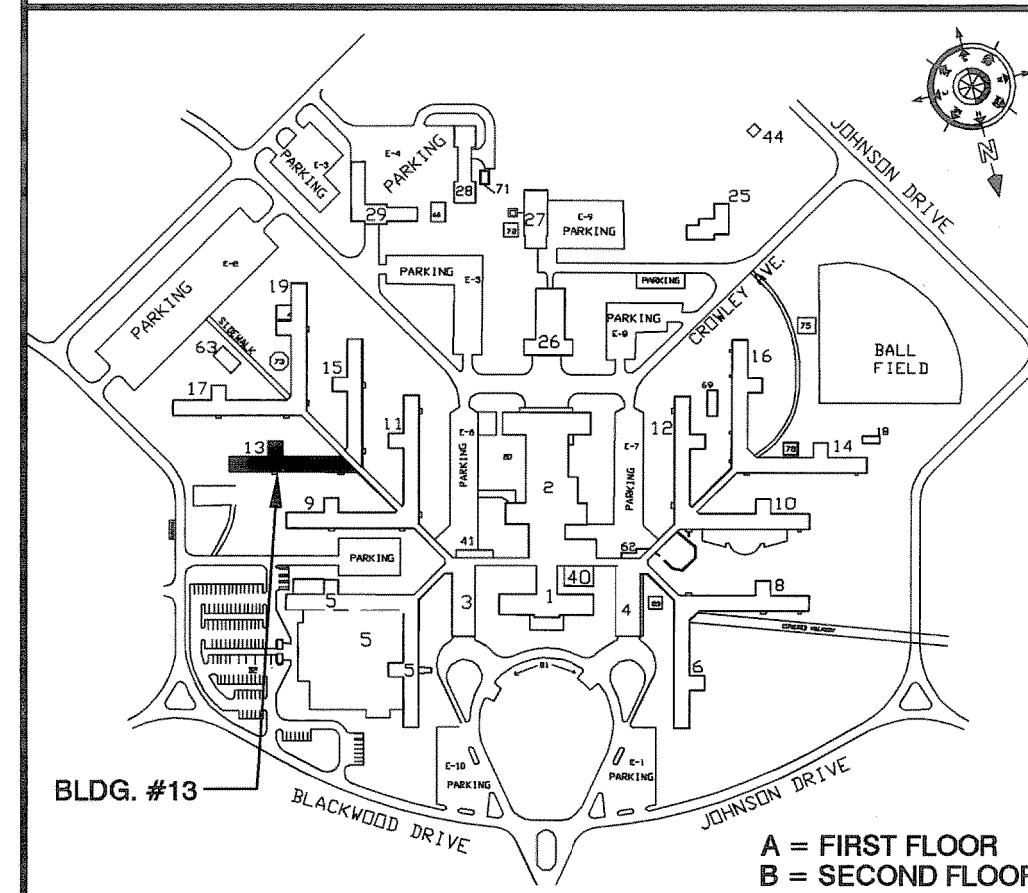
COORDINATION DRAWINGS

THE MECHANICAL CONTRACTOR SHALL TAKE THE LEAD IN PREPARATION OF COORDINATION DRAWINGS. SUCH DRAWINGS SHALL BE ARRANGED AND DESIGNED THROUGH AND FROM COORDINATION WITH ALL OTHER MAJOR AND MINOR SUBCONTRACTORS AND THE GENERAL CONTRACTOR. PROVIDE PLAN VIEWS, SECTIONS AND ELEVATIONS AS REQUIRED TO FULLY COORDINATE ALL NEW WORK WITH ITSELF AND EXISTING CONDITIONS. DRAW TO SCALE (AT NOT LESS THAN 3/8" = 1'-0"). DRAWINGS SHALL SHOW, BUT NOT BE LIMITED TO: ALL WALL RATINGS; ALL DUCTWORK; ALL AIR DISTRIBUTION; MECHANICAL EQUIPMENT; MECHANICAL PIPING; FIRE PROTECTION PIPING; ALL PLUMBING PIPING; CABLE TRAYS (WITH ELEVATIONS NOTED); LIGHTING FIXTURES (WHEN CEILING MOUNTED); CEILING GRID AND CEILING HEIGHT; MAJOR BEAMS AND JOISTS (WITH ELEVATIONS MARKED); FIRE ALARM DEVICES AND SPEAKERS (WHERE CEILING MOUNTED); ELECTRICAL CONDUITS LARGER THAN 2-INCH DIAMETER; ELECTRICAL BUSWAY AND REQUIRED CLEARANCES; EQUIPMENT PROVIDED BY OTHERS THAT PROTRUDE INTO CEILING CAVITIES OR IMPEDE THE LOCATION OR ACCESS TO ABOVE CEILING PIPING, DUCTWORK OF OTHER EQUIPMENT. SECTIONS SHALL BE CUT THROUGH AREAS SHOWING MATERIALS AND SYSTEMS OF ALL CONTRACTS. IF THERE ARE ANY OUTSTANDING ISSUES THAT CANNOT BE RESOLVED, CONSULT WITH THE ARCHITECT AND/OR ENGINEER (THROUGH THE VA COTR) FOR GUIDANCE AND MAKE CORRECTIONS IN ACCORDANCE WITH DIRECTIONS GIVEN. IT IS IMPORTANT TO NOTE THAT FABRICATION CANNOT BEGIN UNTIL COORDINATION DRAWINGS HAVE BEEN APPROVED. ANY MATERIAL, EQUIPMENT, SYSTEMS, ETC., PROCUREMENT OR INSTALLATION COMMENCED PRIOR TO APPROVAL IS TAKEN AT THE CONTRACTORS OWN RISK AND MAY HAVE TO BE MODIFIED, MOVED AND/OR RECONFIGURED AT THE CONTRACTORS COST.

TYPICAL SYMBOLS

- EXISTING WALL, DOOR, WINDOW, MILLWORK, FIXTURE OR OTHER FEATURE OR ASSEMBLY TO BE REMOVED.
- EXISTING WALL, DOOR, WINDOW, MILLWORK, FIXTURE OR OTHER FEATURE OR ASSEMBLY TO REMAIN.
- NEW WALL
- SMOKE TIGHT WALL
- 1-HOUR FIRE RATED WALL
- 2-HOUR FIRE RATED WALL
- 1 HOUR FIRE SMOKE RATED WALL
- PROJECT LIMITS OF WORK
- NO PIPING OR DUCTWORK SHALL BE ROUTED THROUGH ELECTRICAL AND/OR DATA ROOMS.

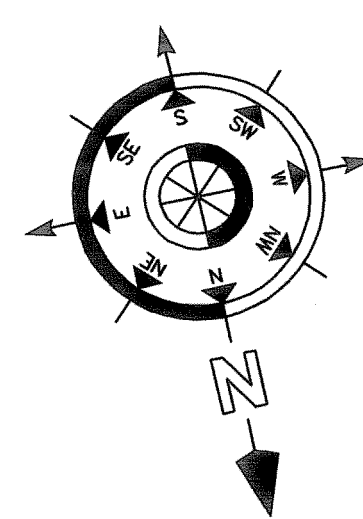
KEY PLAN



PLUMBING FLOOR PLAN - DWV

1/8" = 1'-0"

0 4' 8' 16'



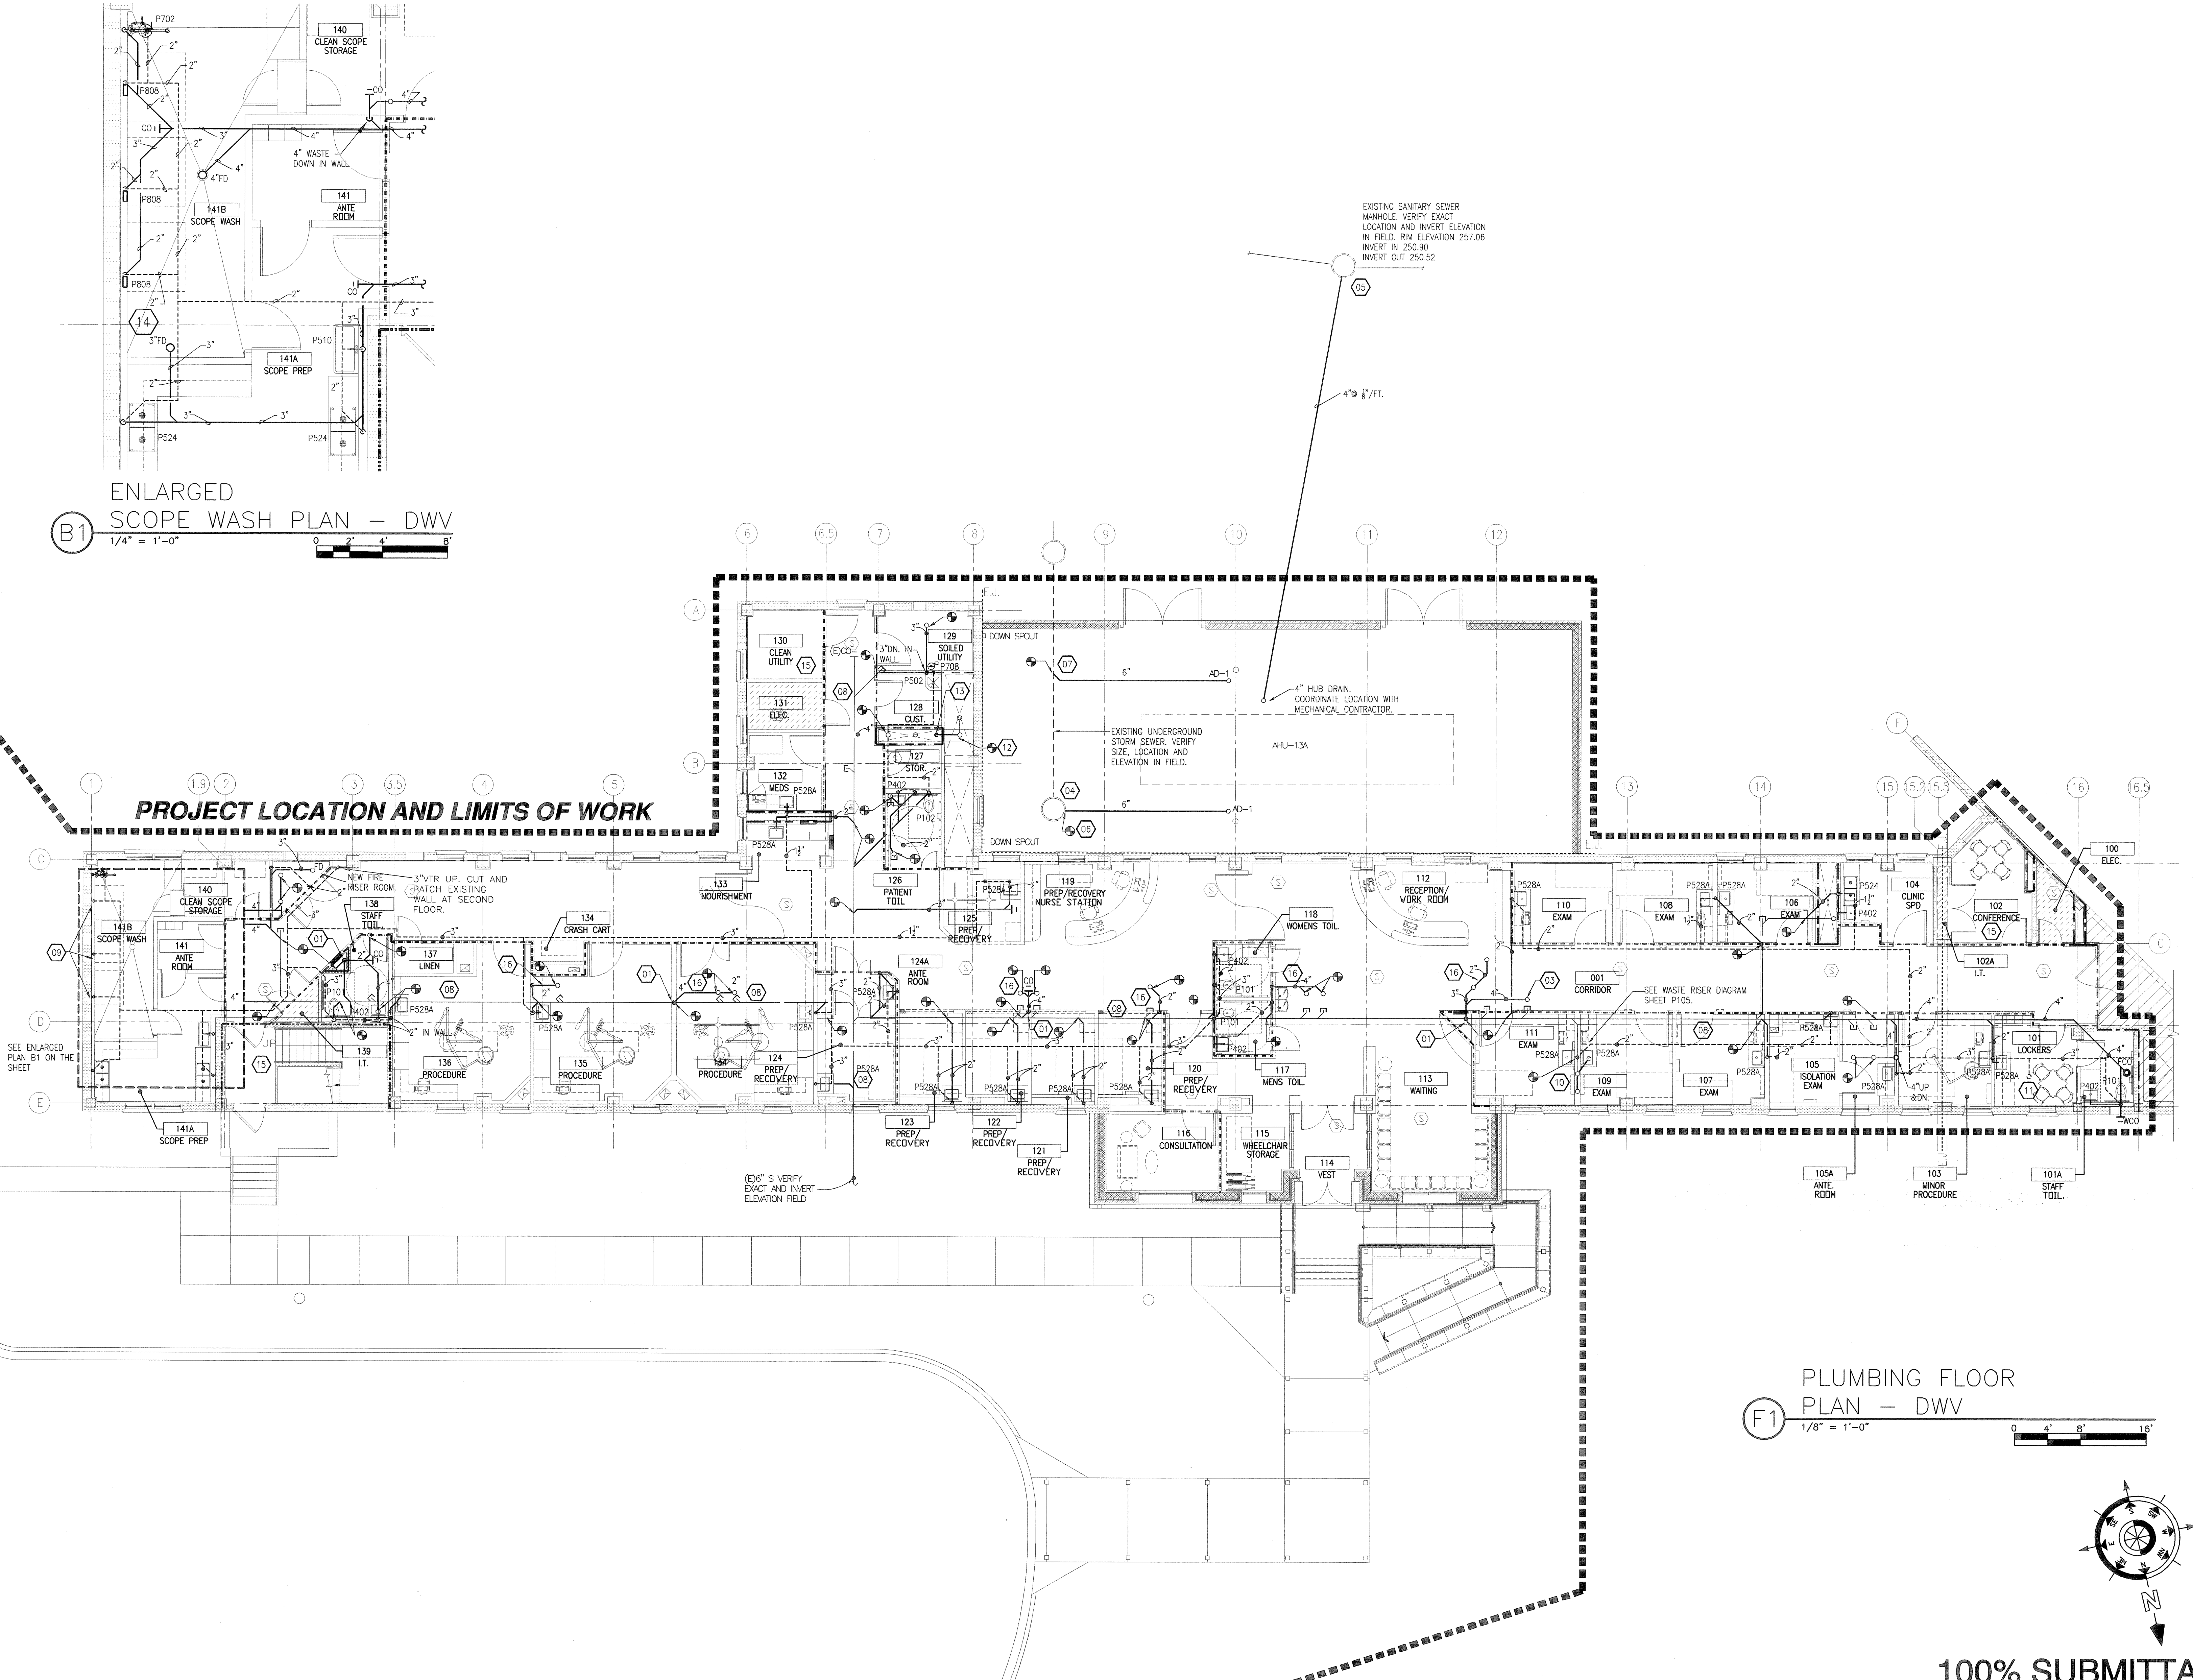
100% SUBMITTAL

ENLARGED SCOPE WASH PLAN - DWV

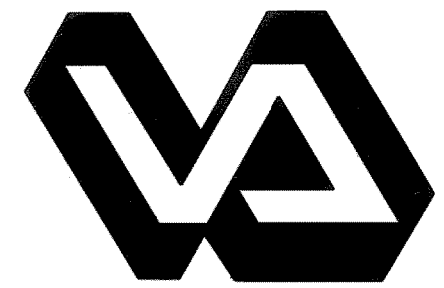
1/4" = 1'-0"

0 2' 4' 8'

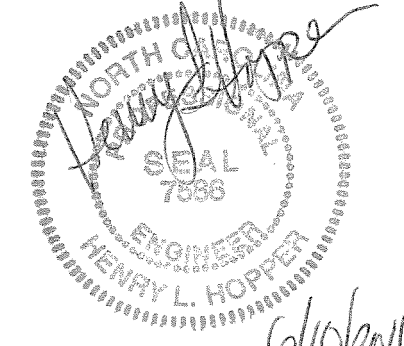
PROJECT LOCATION AND LIMITS OF WORK



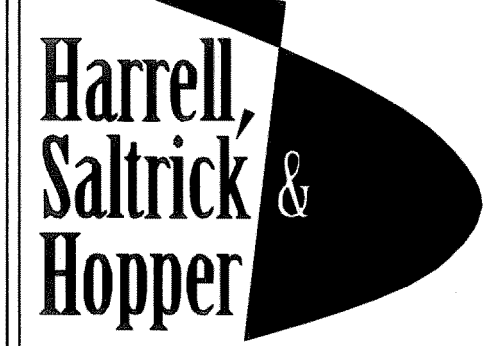
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Recommended Approvals:	
1. MEDICAL DIRECTOR	6. OPERATIONS SERVICE LINE MANAGER
2. ASSOCIATE DIRECTOR	7. INFECTION CONTROL SAFETY MANAGER
3. CHIEF OF STAFF	8. SAFETY MANAGER
4. ASSOC. DIRECTOR	9. GENERAL ENGINEER
5. SERVICE LINE MGRS.	10. COTR

Drawing Title PLUMBING FLOOR PLAN - DWV
FULLY SPRINKLERED

Project Title RENOVATE 13A FOR ENDOSCOPY SUITE		
Drawn	Building Number	AutoCAD File Name
Checked	Reviewed	Const. Contract No.

Date June 10, 2011
Project Number 557-10-108
DRAWING No. P-101

