




GENERAL DEMOLITION NOTES

1. PRIOR TO SUBMITTING PROPOSALS, BIDDERS SHALL EXAMINE DRAWINGS AND SPECIFICATIONS AND CONDUCT A PERSONAL EXAMINATION OF THE SITE AND BECOME AWARE OF ALL EXISTING CONDITIONS AND LIMITATIONS AFFECTING THE WORK AND THEIR PROPOSAL.
2. ALL DEMOLITION AND MATERIAL REMOVAL OPERATIONS SHALL BE CAREFULLY AND SAFELY CARRIED OUT TO ACCOMMODATE FUTURE NEW CONSTRUCTION. THE DEMOLITION CONTRACTOR SHALL BE TOTALLY RESPONSIBLE FOR SAFE PROCEDURES, PRACTICES AND OPERATION. CONTRACTOR SHALL PROVIDE AND LOCATE ALL BARRICADES, WARNING LIGHTS, DANGER SIGNS, OVERHEAD PROTECTION, AND ALL OTHER RELATED SAFETY PRECAUTIONS TO PROTECT ALL PERSONS AND PROPERTY EITHER DIRECTLY RELATED OR INCIDENTAL TO THE PROJECT FROM INJURY OR DAMAGE FROM ANY CAUSE. PROTECT ALL STRUCTURAL COMPONENTS AND IN-USE BUILDING SERVICE FROM DAMAGE.
3. ALL DEMOLISHED ITEMS SHALL BE THE PROPERTY OF THE C.O.R. ANY ITEMS NOT CLAIMED AND STORED BY THE C.O.R. SHALL BE DISCARDED BY THE CONTRACTOR.
4. CONTRACTOR SHALL PROVIDE SAFETY AND DUST PROOF BARRIERS FROM ALL PUBLIC OCCUPIED AREAS DURING THE ENTIRE CONSTRUCTION PERIOD.
5. CONTRACTOR SHALL PROPERLY DISPOSE OF ALL DEBRIS DAILY.
6. REFER TO THE ARCHITECTURAL PLANS FOR THE PATCHING AND REPAIRING OF THE EXISTING FLOOR AFTER THE REMOVAL OF PLUMBING PIPING.
7. PRIOR TO PERFORMING DEMOLITION WORK, ALL PIPING REQUIRING DEMOLITION SHALL BE INSPECTED TO CONFIRM IT IS FOR SERVICE INDICATED ON DRAWINGS AND SERVES EQUIPMENT NOTED ON THESE DRAWINGS.


DEMOLITION KEYED NOTES

- D-1 REMOVE PIPING DOWNSTREAM OF POINT OF DISCONNECTION.
- D-2 EXISTING PIPING SHALL REMAIN AS IS.
- D-3 REMOVE EXISTING PIPING UP TO FIRST FLOOR.

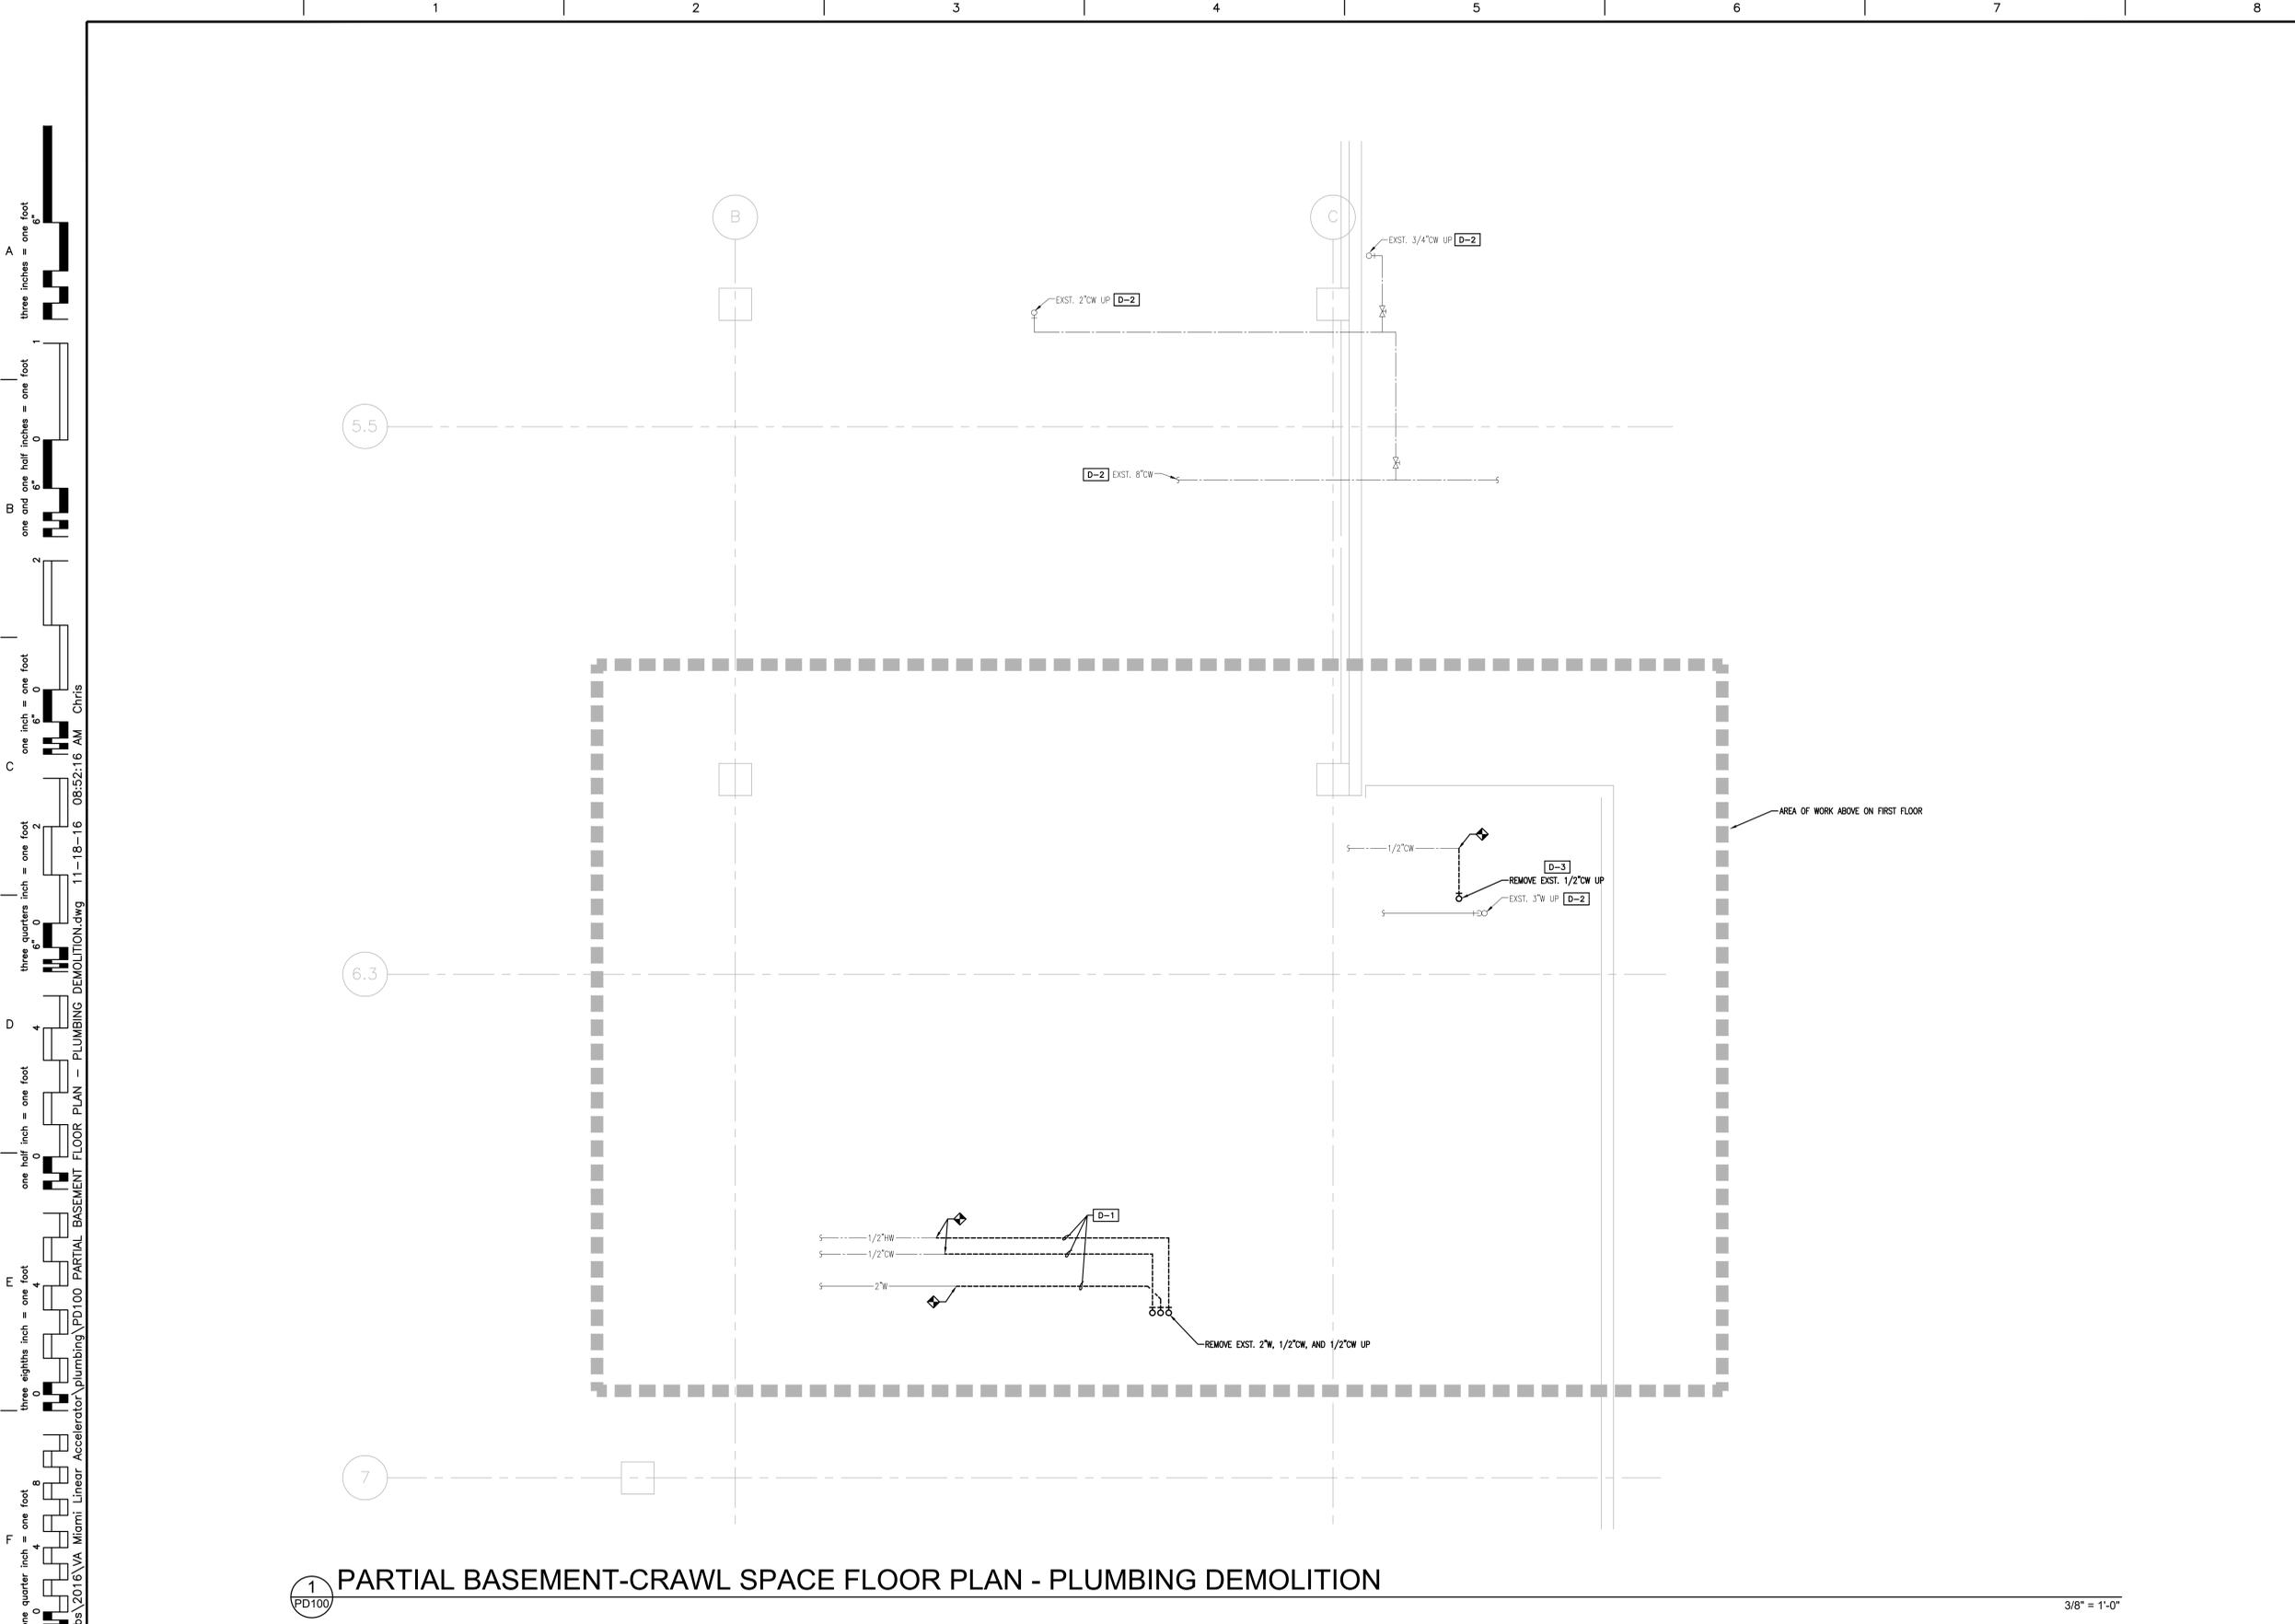

1 PARTIAL BASEMENT-CRAWL SPACE FLOOR PLAN - PLUMBING DEMOLITION

3/8" = 1'-0"

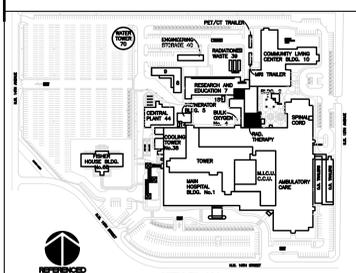

KEY PLAN N.T.S.

CONSTRUCTION DOCUMENT FINAL SUBMISSION

Revisions	Date

CONSULTANTS:



ARCHITECT/ENGINEERS:
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 T: (407) 808-8344 F: (407) 540-9403

Drawing Title
 PARTIAL BASEMENT-CRAWL SPACE FLOOR PLAN - PLUMBING DEMOLITION

Approved Project Director

Project Title
 SITE PREP FOR LINEAR ACCELERATOR

Location
 1201 NW 16th ST, MIAMI, FL.

Date
 NOVEMBER 18, 2016

Checked
 BE


Drawn
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Project Number
 546-CSI-10

Building Number
 1

Drawing Number
PD100

Dwg. of 38

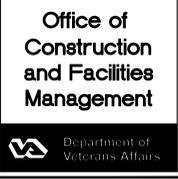


one eighth inch = one foot
 one quarter inch = one foot
 one half inch = one foot
 three eighths inch = one foot
 one inch = one foot
 one and one eighth inch = one foot
 one and one quarter inch = one foot
 one and one half inch = one foot
 one and three quarters inch = one foot
 two inches = one foot
 three inches = one foot
 four inches = one foot
 five inches = one foot
 six inches = one foot
 seven inches = one foot
 eight inches = one foot
 nine inches = one foot
 ten inches = one foot
 eleven inches = one foot
 twelve inches = one foot
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PLUMBING EQUIPMENT SCHEDULE				
SYMBOL	DESCRIPTION	MANUFACTURER	MODEL NUMBER	SPECIFICATION
WCO	WALL CLEANOUT	ZURN	Z1446	CLEANOUT TEE, DURA-COATED CAST IRON BODY, GAS AND WATERTIGHT ABS TAPERED THREAD PLUG, AND ROUND, SMOOTH STAINLESS STEEL WALL ACCESS COVER WITH SECURING SCREW.
FD-C	FLOOR SINK	ZURN	ZN415-TP	MEDIUM DUTY (NON-TRAFFIC) FLOOR DRAIN SHALL COMPLY WITH ASME A112.6.3 AND HAVE A CAST IRON BODY, DOUBLE DRAINAGE PATTERN, CLAMPING DEVICE, LIGHT DUTY NICKEL BRONZE ADJUSTABLE STRAINER WITH ROUND OR SQUARE GRATE OF 150 MM (6 INCHES) WIDTH OR DIAMETER MINIMUM.


PLUMBING FIXTURE SCHEDULE								
SYMBOL	DESCRIPTION	MANUFACTURER	MODEL NUMBER	SPECIFICATION	FIXTURE CONNECTIONS			
					CW	HW	WASTE	VENT
P-528	SINK	ELKAY	LRAO LK0A2445BH	CRS, SINGLE COMPARTMENT, COUNTER TOP ASME/ANSI A112.19.2M, KITCHEN SINKS, FIGURE 5, SELF RIMMING, BACK FAUCET LEDGE, APPROXIMATELY 533 MM BY 559 MM (21 INCHES BY 22 INCHES) WITH SINGLE COMPARTMENT INSIDE DIMENSIONS APPROXIMATELY 406 MM BY 483 MM BY 191 MM (16 INCHES BY 19 INCHES BY 7 1/2 INCHES) DEEP, SHALL BE MINIMUM OF 1.3 MM THICK (18 GAUGE) CRS. CORNERS AND EDGES SHALL BE WELL ROUNDED: 1. FAUCET: SOLID BRASS CONSTRUCTION, DECK MOUNTED COMBINATION FAUCET WITH MODEL OR CERAMIC SEATS, REMOVABLE REPLACEMENT UNIT CONTAINING ALL PARTS SUBJECT TO WARE, SWIVEL GOOSENECK SPOUT WITH APPROXIMATELY 203 MM (8 INCHES) REACH WITH SPOUT OUTLET 152 MM (6 INCHES) ABOVE DECK AND 102 MM (4 INCHES) WRIST BLADES WITH HOSE SPRAY. FAUCET SHALL BE POLISHED CHROME PLATED. 2. DRAIN: DRAIN PLUG WITH CUP STRAINER, STAINLESS STEEL. 3. TRAP: CAST COPPER ALLOY 38 MM (1 1/2 INCHES) P-TRAP WITH CLEANOUT PLUG. PROVIDE WALL CONNECTION AND ESCUTCHEON.	1/2"	1/2"	2"	1 1/2"

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11-18-16 08:52:36 AM Chris
 PLUMBING SCHEDULES AND DETAILS.dwg



1 PIPE THROUGH ROOF PENETRATION DETAIL
NTS

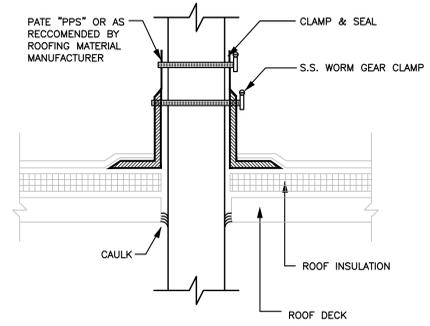

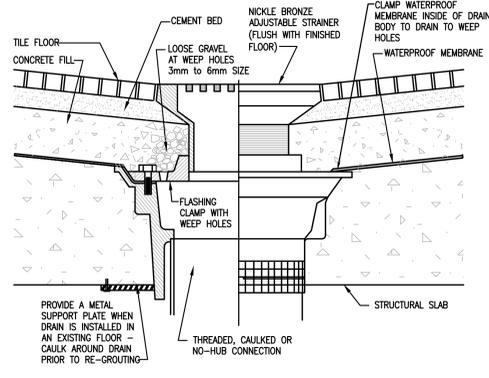2 TYPE 'C' FLOOR DRAIN DETAIL
NTS

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PLUMBING SCHEDULES AND DETAILS

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Building Number
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PL301

Dwg. of 38

