


one eighth inch = one foot
one quarter inch = one foot
one half inch = one foot
three eighths inch = one foot
one inch = one foot
one and one half inches = one foot
two inches = one foot
three inches = one foot
four inches = one foot
five inches = one foot
six inches = one foot
seven inches = one foot
eight inches = one foot
nine inches = one foot
ten inches = one foot
eleven inches = one foot
twelve inches = one foot
thirteen inches = one foot
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fifteen inches = one foot
sixteen inches = one foot
seventeen inches = one foot
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nineteen inches = one foot
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eighty seven inches = one foot
eighty eight inches = one foot
eighty nine inches = one foot
ninety inches = one foot
ninety one inches = one foot
ninety two inches = one foot
ninety three inches = one foot
ninety four inches = one foot
ninety five inches = one foot
ninety six inches = one foot
ninety seven inches = one foot
ninety eight inches = one foot
ninety nine inches = one foot
one hundred inches = one foot

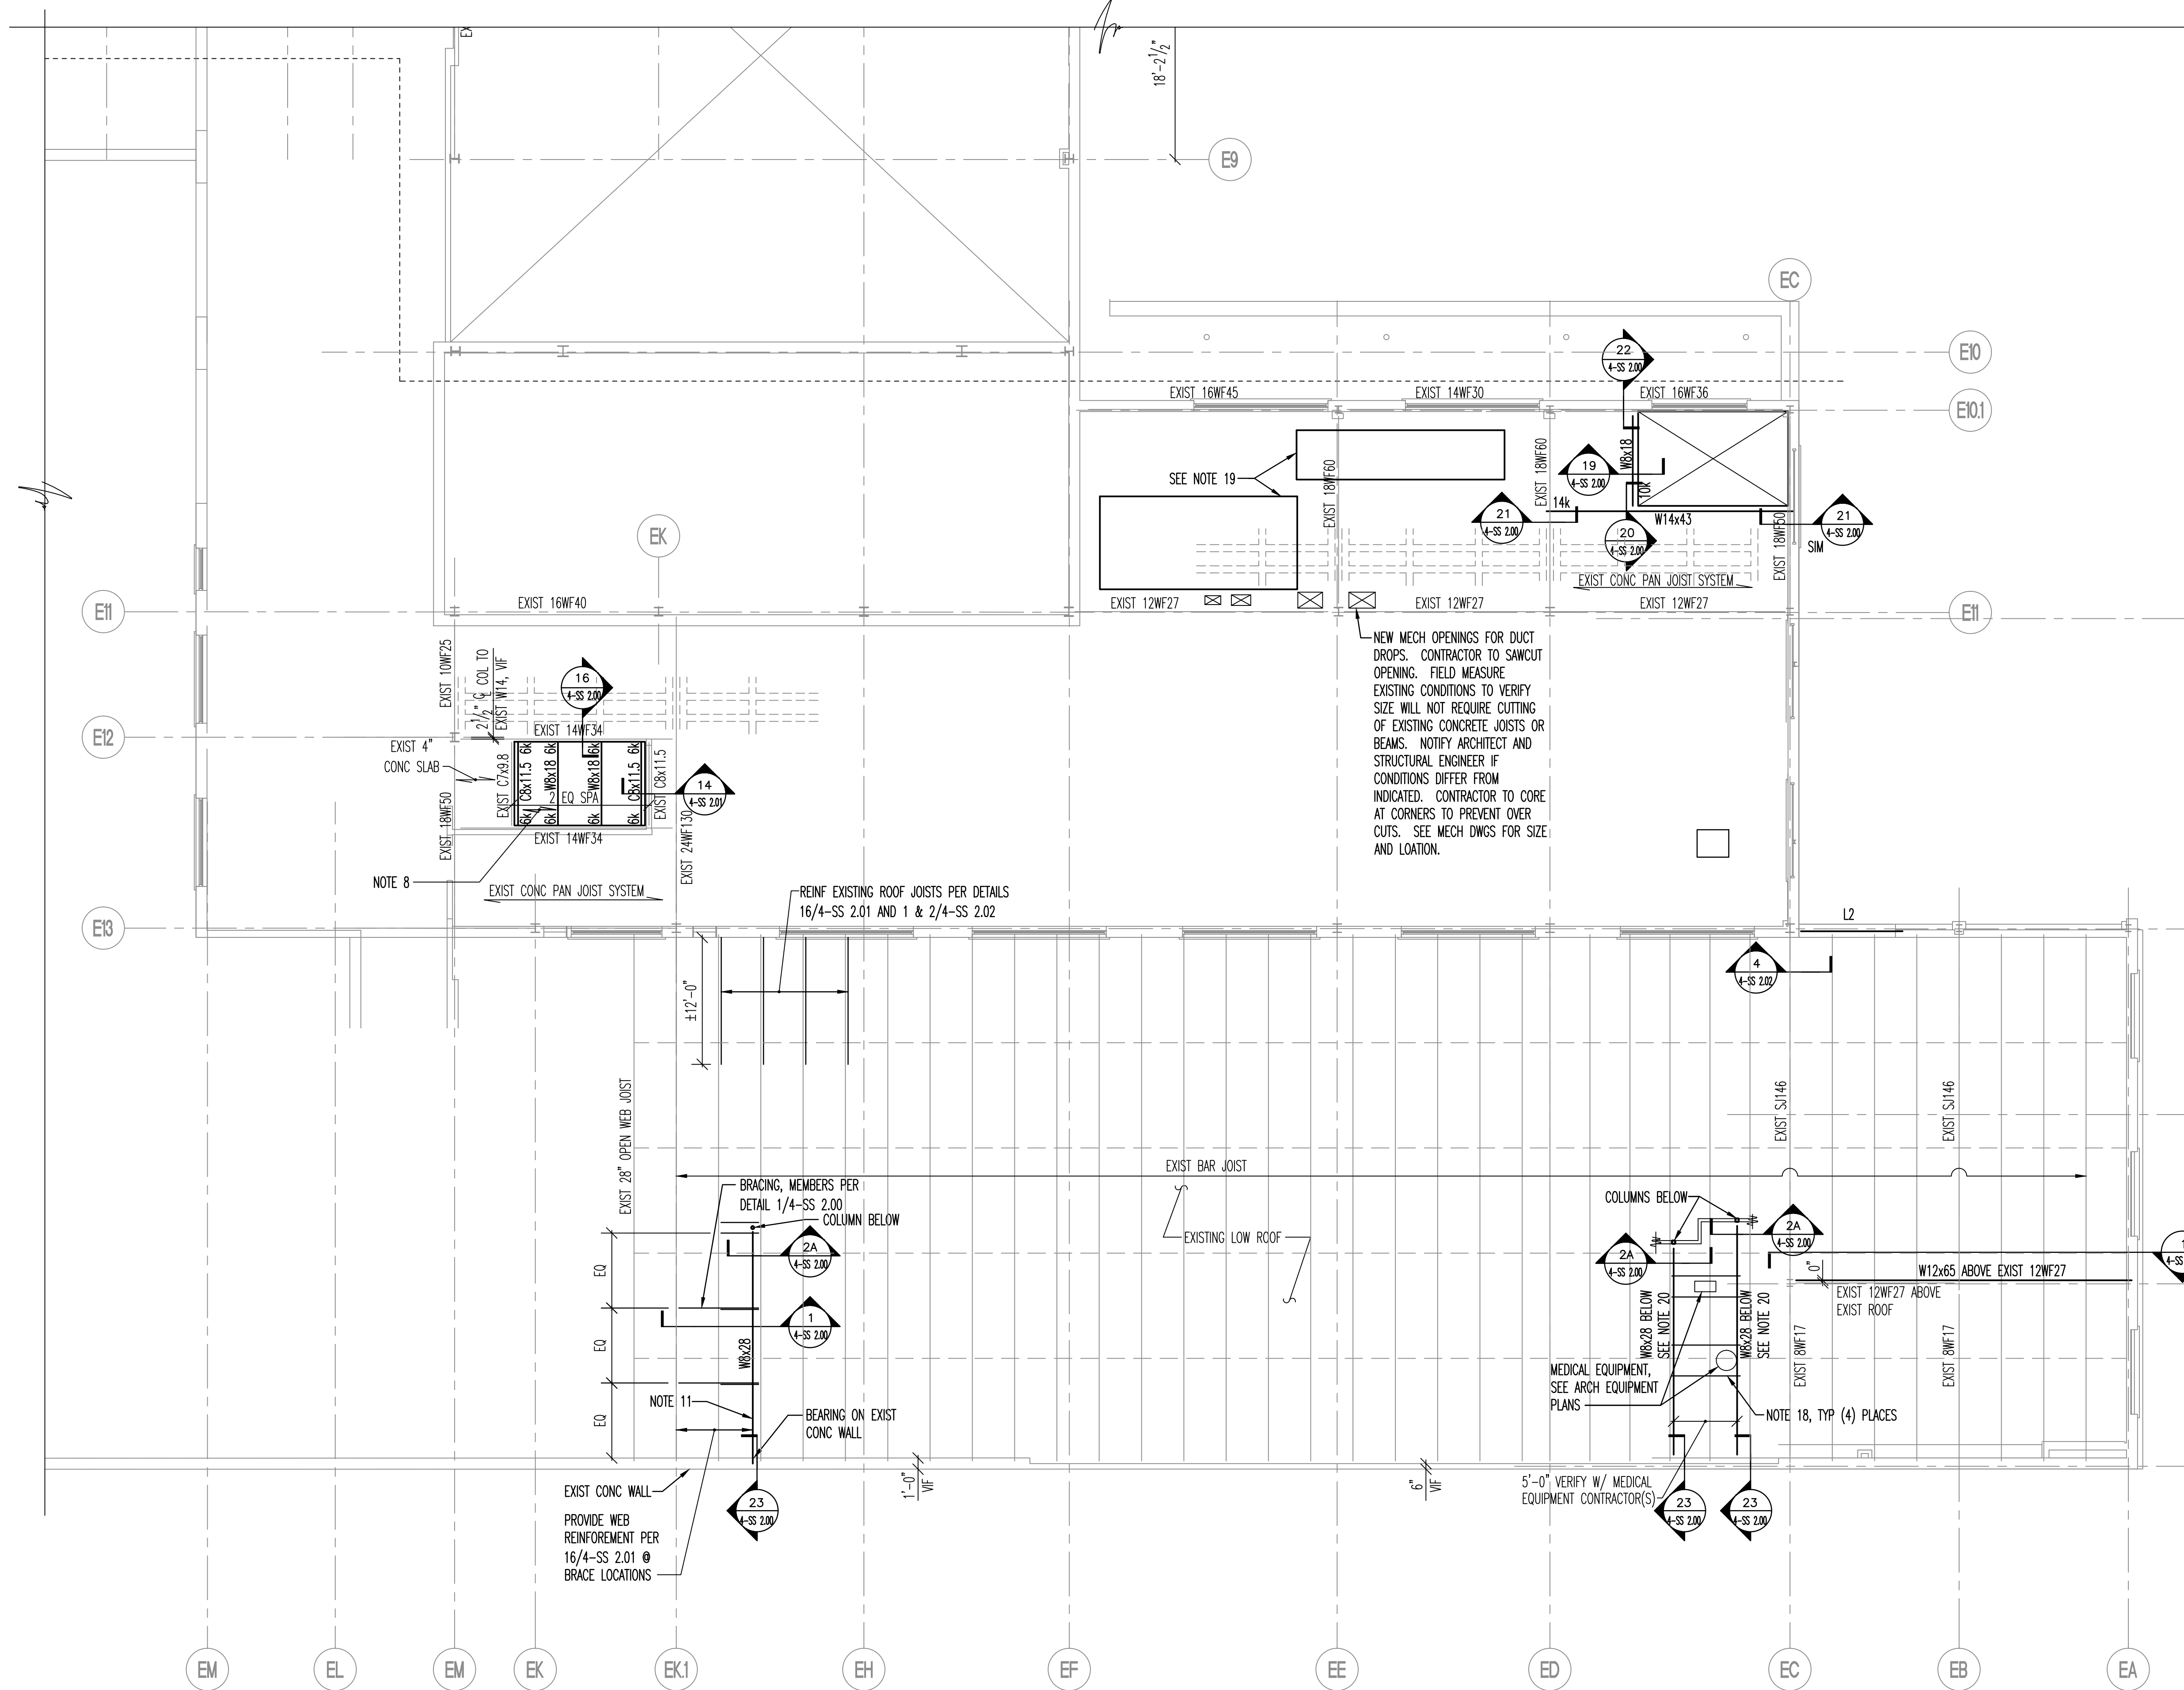

1 FIRST FLOOR FRAMING PLAN - SOUTH MODULE
1/8" = 1'-0"

- SHEET NOTES:**
- SEE SHEET 4-SS 0.00 FOR GENERAL NOTES, ABBREVIATIONS AND SCHEDULES.
 - VERIFY ALL DIMENSIONS AND ELEVATIONS WITH EXISTING CONDITIONS, ARCHITECTURAL, PLUMBING AND MECHANICAL DRAWINGS.
 - SEE SHEET 4-SS 1.01 & 4-SS 1.02 FOR COLUMN DESIGNATIONS.
 - TYPICAL CONSTRUCTION NOTATION:
k = INDICATES VERTICAL BEAM END REACTION
 - GENERAL CONTRACTOR: THIS STRUCTURE RELIES UPON NON-STRUCTURAL STEEL BUILDING COMPONENTS FOR FINAL LATERAL STRENGTH AND STABILITY.
 - 1/STEEL ELEVATION = NOTED THUS (11'-7").
 - JOIST BEARING ELEVATION = 1/STEEL UNLESS NOTED THUS <X'-X">.
 - FLOOR CONSTRUCTION: 3 1/2" NORMAL WEIGHT CONCRETE W/6x6 - W2.9xW2.9 WELDED WIRE REINFORCEMENT ABOVE 1 1/2" 22 GAUGE TYPE C FORM DECK. PROVIDE DECK CONTINUOUS OVER (3) SPANS MINIMUM. TOTAL DEPTH OF SYSTEM = 5". 1/CONCRETE ELEVATION = +12'-0" U.N.O.
 - LASER SCREEDING OF ELEVATED SLABS SHALL NOT BE ALLOWED UNLESS SCREEDING PROCEDURE IS REVIEWED BY ENGINEER.
 - GENERAL CONTRACTOR SHALL COORDINATE ALL LOCATIONS AND SIZES OF FLOOR OPENINGS W/ARCHITECTURAL AND MECHANICAL DRAWINGS. NOT ALL OPENINGS ARE INDICATED ON PLAN. SEE DETAIL 15/4-SS 2.01.
 - COORDINATE 1/STEEL BEAM ELEVATION AND LENGTH W/FOLDING PARTITION MANUFACTURER AND ARCHITECTURAL DRAWINGS.
 - L"x" INDICATES LINTEL. SEE LINTEL SCHEDULE ON SHEET 4-SS 0.00. NON-LOAD BRG LINTELS NOT SPECIFIED ON PLAN ARE PER LINTEL NOTES ON SHEET 4-SS 0.00. SEE ARCHITECTURAL AND MECHANICAL DRAWINGS FOR OPENING SIZES AND LOCATIONS.
 - PROVIDE DETAIL 13/4-SS2.01 AT ALL NON-LOAD BEARING MASONRY PARTITION WALLS. COORDINATE MASONRY PARTITION LOCATIONS W/ARCHITECTURAL DRAWINGS.
 - INDICATES LOAD BEARING MASONRY.
 - COORDINATE FLOOR DRAIN LOCATIONS WITH ARCHITECTURAL AND PLUMBING DRAWINGS. COORDINATE FLOOR SLOPE TO DRAIN WITH ARCHITECTURAL DRAWINGS.
 - GENERAL CONTRACTOR SHALL COORDINATE AND PROVIDE ALL MISCELLANEOUS STEEL PIECES AS INDICATED ON THE STRUCTURAL AND ARCHITECTURAL DRAWINGS.
 - RD INDICATES ROOF DRAIN. SEE ARCH AND PLUMBING DRAWINGS.
 - PROVIDE (4) L5x3 1/2x3/8 LONG LEG VERTICAL. (2) ANGLES TO BE PLACED FOR SUPPORT OF LIGHT BOOM AND (2) ANGLES TO BE PLACED FOR SUPPORT OF MG. - SEE ARCH EQUIPMENT PLANS
 - PROVIDE 4" CONCRETE HOUSEKEEPING PAD WITH #4 @ 18" OC EACH WAY AT ALL MECHANICAL PLUMBING OR ELECTRICAL EQUIPMENT. PAD TO BE 6" LARGER THAN UNIT ON ALL SIDES. COORDINATE WITH ARCHITECT AND MECHANICAL AND ELECTRICAL EQUIPMENT CONTRACTOR.
 - PROVIDE W8 BEAMS BELOW EXIST ROOF FRAMING, JUST ABOVE CEILING. COORDINATE W/EQUIPMENT CONTRACTOR(S).

CONSULTANTS:		ARCHITECT/ENGINEERS: LEGATARCHITECTS sustainability performance design 24 North Chapel Street Waukegan, Illinois 60085-4107 Tel 847.662.3535 Fax 847.249.0398 www.legat.com	Drawing Title FIRST FLOOR FRAMING PLAN - SOUTH MODULE		Project Title FY2012 - BUILDING 4		Project Number 211097.00		Office of Construction and Facilities Management Department of Veterans Affairs
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Revisions:		Approved: Project Director		Location 3001 North Green Bay RD, North Chicago, IL 60084		Date 03-30-2012	Checked CF	Drawn VC	Dwg. of -